

LIBERTY PARKING EXPANSION


OLIVER STREET CAPITAL 15 LIBERTY WAY

FRANKLIN, MASSACHUSETTS

DATE: JANUARY 13, 2023 REVISED: OCTOBER 17, 2023

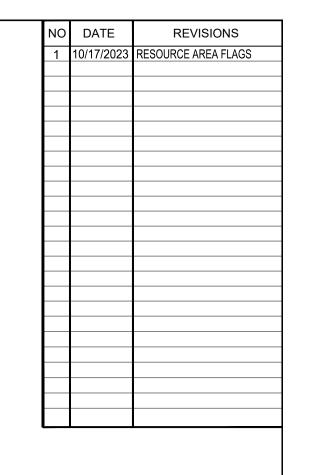

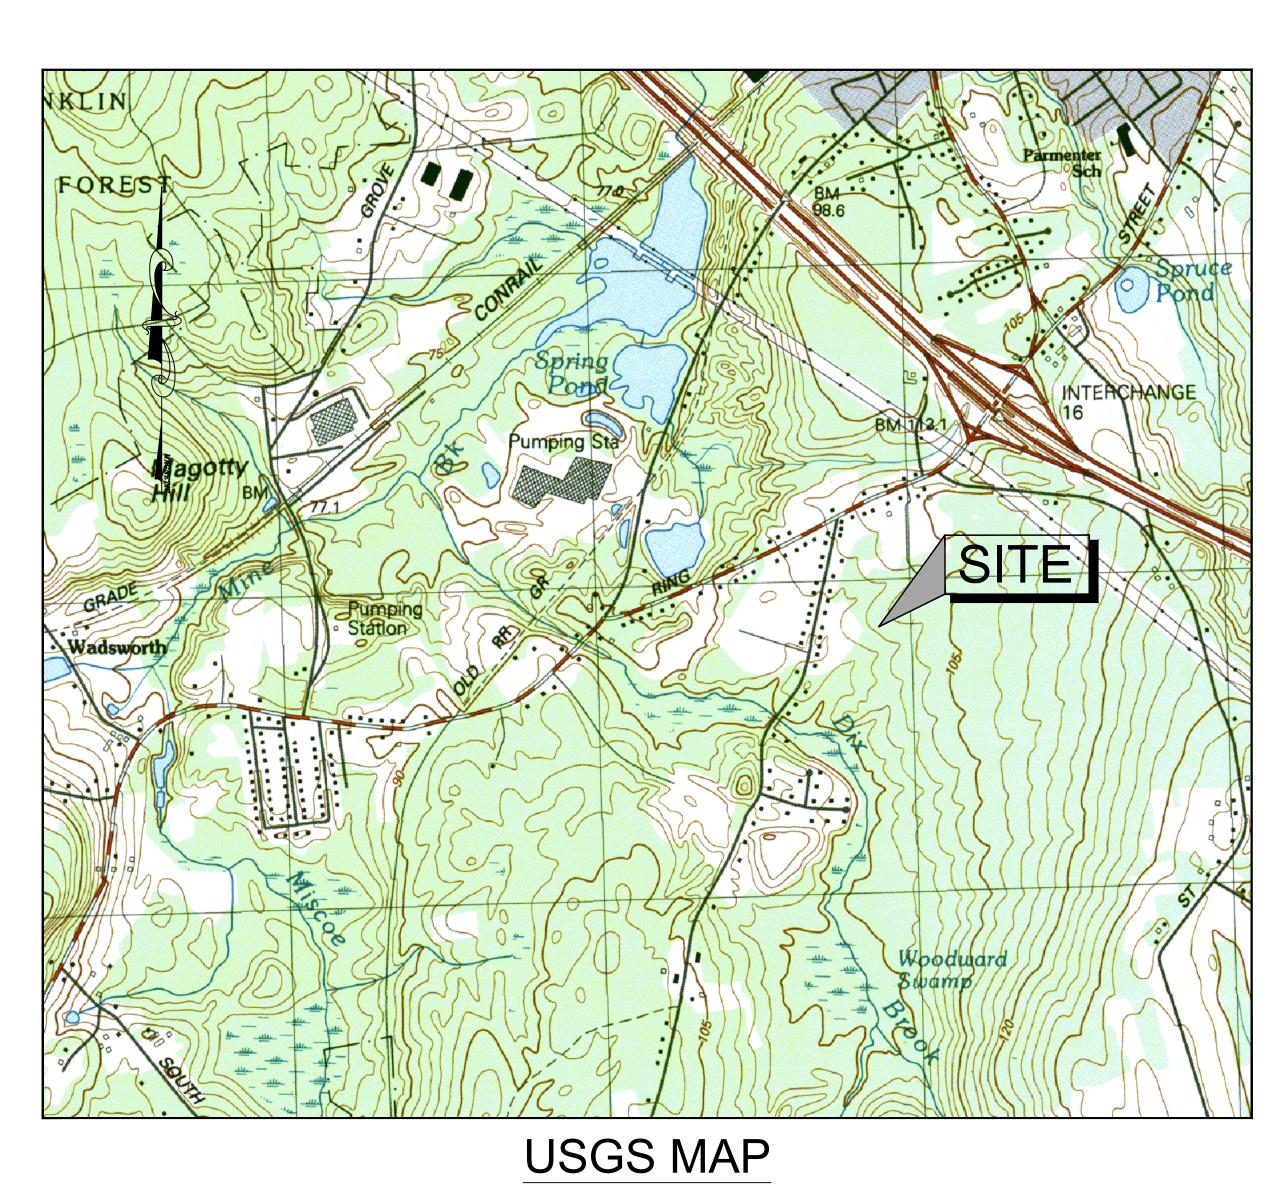

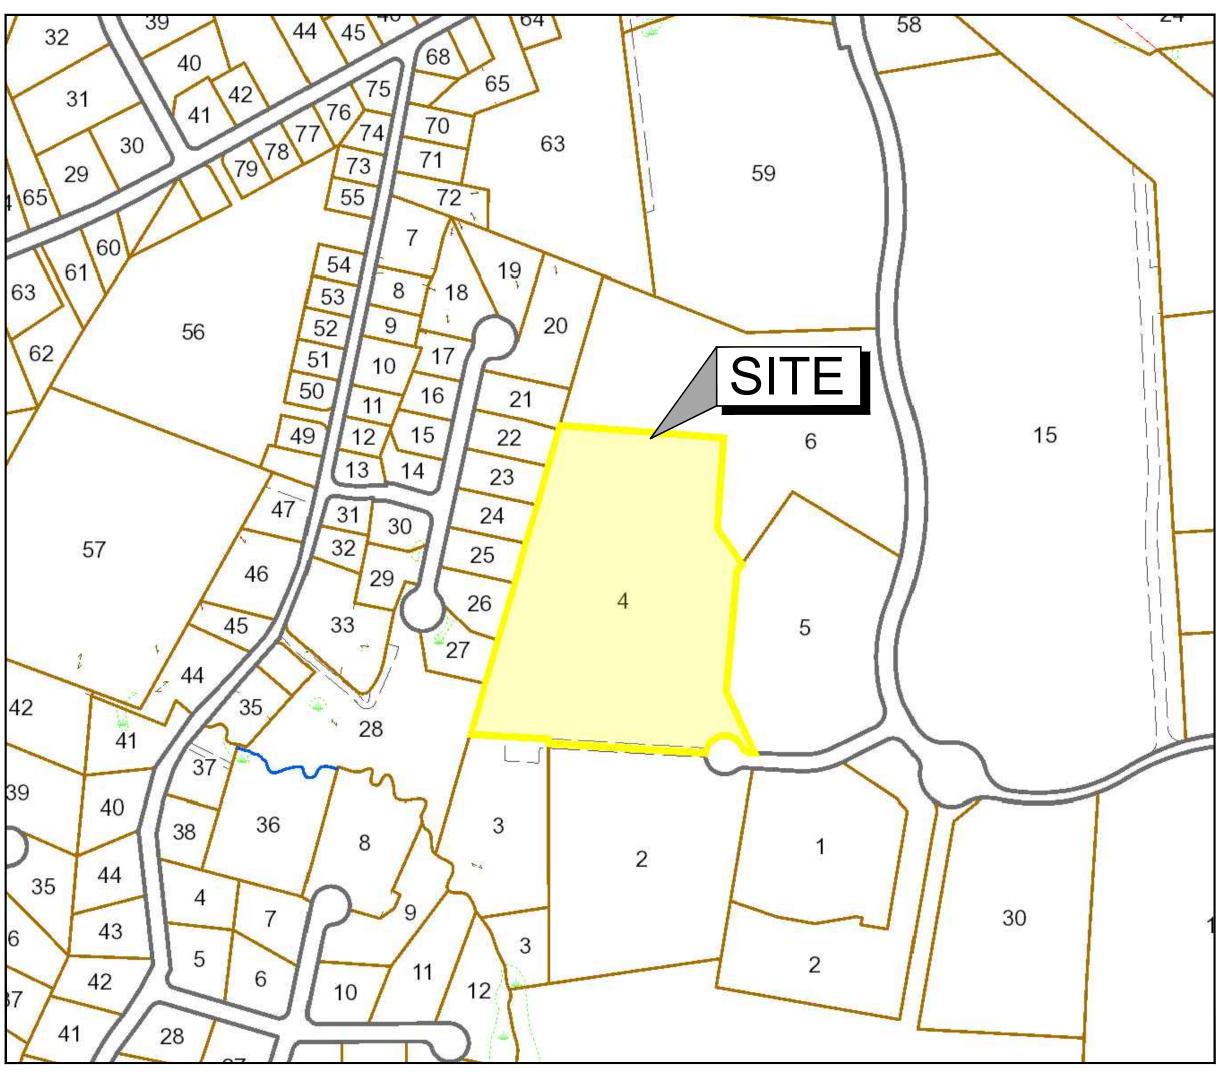

ASSESSORS MAP

SCALE: 1"= 1,000'±

APPLICANT:

OLIVER STREET CAPITAL 125 HIGH STREET, SUITE 220 BOSTON, MA 02110

CIVIL ENGINEER:



PROPERTY ADDRESS: 15 LIBERTY WAY

FRANKLIN, MASSACHUSETTS

ASSESSORS MAP/PARCEL:

MAP 320 , PARCEL 004

ZONING DISTRICT: INDUSTRIAL

DRAWING LIST:

C-1.0

C-2.0	OVERALL SITE PLAN
C-3.0	LAYOUT & MATERIALS
C-4.0	GRADING & DRAINAGE
C-5.0	EROSION CONROL PLAN
C-6.0	TYPICAL DETAILS
C-6 1	TYPICAL DETAILS

TYPICAL DETAILS

EXISTING CONDITIONS

COVER



LEGEND **BITUMINOUS** CHAIN LINK FENCE UNDERGROUND DRAIN LINE DEED BOOK DRAIN MANHOLE ELEVATION EDGE OF PAVEMENT FLARED END SECTION FINISHED FLOOR ELEVATION FIRE HYDRANT NOW OR FORMERLY REBAR FOUND UNDERGROUND SEWER LINE SEWER MANHOLE REINFORCED CONCRETE PIPE UNDERGROUND WATER LINE WATER GATE

ZONING DISTRICT

INDUSTRIAL

MINIMUM BUILDING SETBACKS

FRONT=40 FEET SIDE=30 FEET* REAR=30 FEET*

* INCREASE BY THE COMMON BUILDING HEIGHT OF THE STRUCTURE WHEN ABUTTING A RESIDENTIAL USE.

DEED REFERENCES

ATLANTIC OLIVER 15 LIBERTY WAY, LLC DEED BOOK 39279 PAGE 278

PLAN REFERENCES

PLAN NO. 879 OF 1994 PLAN NO. 878 OF 1994 PLAN NO. 47 OF 1995

- 1. THIS SURVEY AND PLAN ARE BASED UPON AN ACTUAL ON THE GROUND INSTRUMENT SURVEY PERFORMED BETWEEN NOVEMBER 2, 2022 AND AUGUST 2, 2023.
- 2. LEGAL STATUS OF THE STREETS AND/OR WAYS SHOWN HEREON, WHETHER THEY ARE PUBLIC OR PRIVATE, WERE NOT MADE PART OF THIS SURVEY.
- 3. ALL FLOWERING PLANTS, SHRUBS, OR TREES MAY NOT BE SHOWN WITHIN LANDSCAPING AREAS. IT IS MEANT FOR ILLUSTRATIVE PURPOSES ONLY AND NOT MEANT AS A COMPLETE INVENTORY OF ALL VEGETATION THAT MAY EXIST. SIZES REFLECT APPROXIMATE TRUNK DIAMETER AT BREAST HEIGHT OR APPROXIMATE DIAMETER OF SHRUB WIDTH.
- 4. THE LOCATION OF UNDERGROUND UTILITIES ARE APPROXIMATE ONLY, AND ARE NOT WARRANTED TO BE CORRECT. UNDERGROUND UTILITIES ARE SHOWN BASED ON EITHER RECORD DATA PROVIDED BY THE OPERATING AUTHORITIES, VISUAL INSPECTION OF AVAILABLE ABOVEGROUND STRUCTURES, PHYSICAL SURFACE MARKINGS FOUND, OR DATA PROVIDED BY OTHERS. ADDITIONAL UTILITIES MAY EXIST WHICH ARE NOT INDICATED ON THESE PLANS. ALL EXISTING UTILITIES SHALL BE VERIFIED FOR SERVICE, SIZE, INVERT ELEVATION, LOCATIONS, ETC. PRIOR TO NEW CONNECTIONS TO OR RELOCATION OF SAME. CONTRACTOR MUST NOTIFY DIG-SAFE AT 1-888-344-7233 AT LEAST 72 HOURS PRIOR TO ANY CONSTRUCTION. NOTIFY THIS FIRM IN WRITING OF ANY AND ALL DISCREPANCIES PRIOR TO COMMENCING ANY WORK.
- 5. THE SUBJECT PROPERTY DOES NOT FALL IN A SPECIAL FLOOD HAZARD ZONE AS THE SUBJECT PROPERTY IS PLOTTED BY SCALE ONTO THE FLOOD INSURANCE RATE MAP FOUND AS, NORFOLK

TOWN OF FRANKLIN 250240 0317E JULY 17, 2012 "X"


6. THE SUBJECT PROPERTY DOES NOT FALL IN THE TOWN OF FRANKLIN'S WATER RESOURCE

MASSACHUSETTS STATE PLANE - MAINLAND ZONE NAD83 (2011) EPOCH 2010.00 - US FEET

NORTH AMERICAN VERTICAL DATUM OF 1988 (GEOID 12B) - US FEET

ON-THE-GROUND OBSERVATIONS WERE PERFORMED USING A LEICA TS13 (3") ROBOTIC TOTAL STATION AND WITH A SOKKIA GCX3 GPS RECEIVER USING THE MASSACHUSETTS CONTINUOUSLY OPERATING REFERENCE STATION (MaCORS) RTK NETWORK.

I CERTIFY THAT THIS SURVEY AND PLAN WERE PREPARED IN ACCORDANCE WITH THE PROCEDURAL AND TECHNICAL STANDARDS FOR THE PRACTICE OF LAND SURVEYING IN THE COMMONWEALTH OF MASSACHUSETTS, TITLE 250

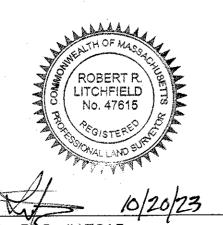

DATE

NO DATE REVISIONS 1 10/17/2023 RESOURCE AREA FLAGS

> JANUARY 13, 2023 AH / DRC

1" = 40' SCALE:

0

DESIGN GROUP

249 SOUTH STREET, UNIT 1 PLAINVILLE, MA 02762 TEL. (508) 695-2221 FAX. (508) 695-2219

EXISTING CONDITIONS

SHEET 2 OF 8 20' 40'

ZONING DISTRICT

ZONED: INDUSTRIAL

USE: 3.10 WAREHOUSE, DISTRIBUTION FACILITY (EXISTING)

MINIMUM BUILDING SETBACKS


FRONT=40
FEET SIDE=30 FEET
REAR=30 FEET

DEED REFERENCES

ATLANTIC OLIVER 15 LIBERTY WAY, LLC DEED BOOK 39279 PAGE 278

PLAN REFERENCES

PLAN NO. 879 OF 1994 PLAN NO. 878 OF 1994 PLAN NO. 47 OF 1995

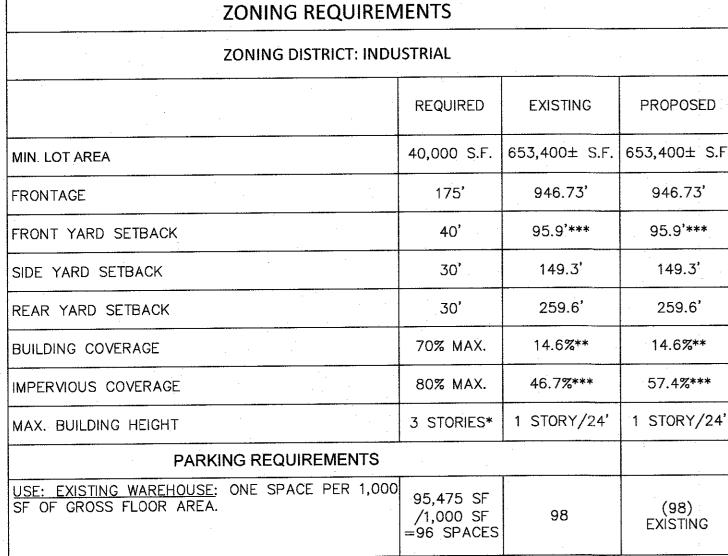

* BUILDINGS UP TO 60' IN HEIGHT MAY BE PERMITTED BY A SPECIAL PERMIT FROM THE PLANNING BOARD.

** BUILDING AREA IS BASED ON FRANKLIN ASSESSORS RECORDS

*** TAKEN FROM THE RECORD SURVEY IN ADDITION TO AERIAL IMAGERY.

PLAN NOTES:

- 1. EXISTING CONDITIONS WERE OBTAINED FROM FIELD SURVEY PREPARED BY LEVEL DESIGN GROUP, LLC BETWEEN NOVEMBER 2, 2022 AND AUGUST 2, 2023. SOIL TESTING COMPLETED BY ADAM P. HUNT ON NOVEMBER 16, 2022 AND OCTOBER 4, 2023.
- 2. THE LOCATION OF EXISTING UTILITIES IS APPROXIMATE, THE CONTRACTOR SHALL VERIFY THE LOCATION OF ALL UTILITIES IN THE FIELD PRIOR TO THE START OF CONSTRUCTION. NOTIFY "DIG-SAFE" AT 1-888-344-7233 AT LEAST 72 HOURS PRIOR TO ANY SITE DEMOLITION OR EXCAVATION.
- 3. CONTRACTOR SHALL NOTIFY ENGINEER OF ANY DISCREPANCIES IN THE DESIGN PLANS PRIOR TO THE START OF CONSTRUCTION.
- 4. ALL DISTURBED AREAS NOT RECEIVING IMPROVEMENTS SHALL BE LOAMED AND SEEDED.
- 5. THE SITE IS NOT LOCATED WITHIN A ZONE II WATER RESOURCE DISTRICT.
- 6. THE SITE IS NOT LOCATED WITHIN A FLOOD PLAIN DISTRICT.

CONSTRUCTION NOTES:

- 1. THE LOCATION OF EXISTING UTILITIES IS APPROXIMATE, THE CONTRACTOR SHALL VERIFY THE LOCATION OF ALL UTILITIES IN THE FIELD PRIOR TO THE START OF CONSTRUCTION. NOTIFY "DIG-SAFE" AT 1-888-344-7233 AT LEAST 72 HOURS PRIOR TO ANY SITE DEMOLITION OR EXCAVATION.
- 2. CONTRACTOR SHALL NOTIFY ENGINEER OF ANY DISCREPANCIES IN THE DESIGN PLANS PRIOR TO THE START OF CONSTRUCTION.
- 3. ALL EXISTING PAVEMENT SHALL BE SAWCUT PRIOR TO REMOVAL.
- 4. ALL EXISTING PAVEMENT, CURB, WALKS, UTILITIES, LIGHT POLES, TREES, SHRUBS, ETC., SHALL BE REMOVED FROM THE AREAS TO BE DEVELOPED. ALL SUCH ITEMS NOT WITHIN THE WORK AREA SHALL BE PROTECTED AND UNDISTURBED.
- 5. ALL DISTURBED AREAS NOT RECEIVING IMPROVEMENTS SHALL BE LOAMED AND SEEDED.
- 6. ALL CONSTRUCTION AND CONSTRUCTION ACTIVITIES SHALL CONFORM TO STATE AND LOCAL REQUIREMENTS. INCLUDING BUT NOT LIMITED TO THE TOWN OF FRANKLIN, THE COMMONWEALTH OF MASSACHUSETTS AND ANY OTHER AGENCIES HAVING JURISDICTION.
- 7. MATERIAL TO BE EXPORTED FROM THE SITE WILL BE LIMITED TO TOPSOIL IN AREAS TO BE PAVED AND ANY DELETERIOUS MATERIAL ENCOUNTERED DURING EXCAVATION.

 MATERIAL TO BE EXPORTED WILL BE LIMITED TO GRAVEL BASE AND SEPTIC AGGREGATE.


SITE PLAN NOTES:

1. THIS PLAN SET HAS BEEN ISSUED FOR PERMITTING ONLY. A FULL CONSTRUCTION PLAN SET SHALL BE ISSUED ONCE ALL LOCAL, STATE, AND FEDERAL PERMIT APPROVALS HAVE BEEN GRANTED.



NO DATE REVISIONS

1 10/17/2023 RESOURCE AREA FLAGS

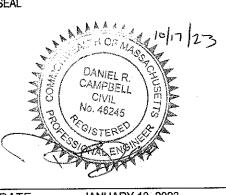

DATE: JANUARY 13, 2023

DRAWN: AH / DRC

SCALE: 1" = 50'

LIBERTY PARKING EXPANSIC

DESIGN GROU

249 SOUTH STREET, UNIT 1 PLAINVILLE, MA 02762 TEL. (508) 695-2221 FAX. (508) 695-2219

OVERALL

SITE PLAN

C-2.0

25' 50'

2081.00

ZONING DISTRICT

ZONED: INDUSTRIAL
USE: 3.10 WAREHOUSE, DISTRIBUTION FACILITY (EXISTING)

MINIMUM BUILDING SETBACKS

FRONT=40
FEET SIDE=30 FEET
REAR=30 FEET

DEED REFERENCES

ATLANTIC OLIVER 15 LIBERTY WAY, LLC
DEED BOOK 39279 PAGE 278

PLAN REFERENCES

PLAN NO. 879 OF 1994 PLAN NO. 878 OF 1994 PLAN NO. 47 OF 1995

PLAN NOTES:

- 1. EXISTING CONDITIONS WERE OBTAINED FROM FIELD SURVEY PREPARED BY LEVEL DESIGN GROUP, LLC BETWEEN NOVEMBER 2, 2022 AND AUGUST 2, 2023. SOIL TESTING COMPLETED BY ADAM P. HUNT ON NOVEMBER 16, 2022 AND OCTOBER 4, 2023.
- 2. THE LOCATION OF EXISTING UTILITIES IS APPROXIMATE, THE CONTRACTOR SHALL VERIFY THE LOCATION OF ALL UTILITIES IN THE FIELD PRIOR TO THE START OF CONSTRUCTION. NOTIFY "DIG-SAFE" AT 1-888-344-7233 AT LEAST 72 HOURS PRIOR TO ANY SITE DEMOLITION OR EXCAVATION.
- 3. CONTRACTOR SHALL NOTIFY ENGINEER OF ANY DISCREPANCIES IN THE DESIGN PLANS PRIOR TO THE START OF CONSTRUCTION.
- 4. ALL DISTURBED AREAS NOT RECEIVING IMPROVEMENTS SHALL BE LOAMED AND SEEDED.
- 5. THE SITE IS NOT LOCATED WITHIN A ZONE II WATER RESOURCE DISTRICT.
- 6. THE SITE IS NOT LOCATED WITHIN A FLOOD PLAIN DISTRICT.


CONSTRUCTION NOTES:

- 1. THE LOCATION OF EXISTING UTILITIES IS APPROXIMATE, THE CONTRACTOR SHALL VERIFY THE LOCATION OF ALL UTILITIES IN THE FIELD PRIOR TO THE START OF CONSTRUCTION. NOTIFY "DIG-SAFE" AT 1-888-344-7233 AT LEAST 72 HOURS PRIOR TO ANY SITE DEMOLITION OR EXCAVATION.
- 2. CONTRACTOR SHALL NOTIFY ENGINEER OF ANY DISCREPANCIES IN THE DESIGN PLANS PRIOR TO THE START OF CONSTRUCTION.
- 3. ALL EXISTING PAVEMENT SHALL BE SAWCUT PRIOR TO REMOVAL.
- 4. ALL EXISTING PAVEMENT, CURB, WALKS, UTILITIES, LIGHT POLES, TREES, SHRUBS, ETC., SHALL BE REMOVED FROM THE AREAS TO BE DEVELOPED. ALL SUCH ITEMS NOT WITHIN THE WORK AREA SHALL BE PROTECTED AND UNDISTURBED.
- 5. ALL DISTURBED AREAS NOT RECEIVING IMPROVEMENTS SHALL BE LOAMED AND SEEDED.
- 6. ALL CONSTRUCTION AND CONSTRUCTION ACTIVITIES SHALL CONFORM TO STATE AND LOCAL REQUIREMENTS. INCLUDING BUT NOT LIMITED TO THE TOWN OF FRANKLIN, THE COMMONWEALTH OF MASSACHUSETTS AND ANY OTHER AGENCIES HAVING JURISDICTION.
- 7. MATERIAL TO BE EXPORTED FROM THE SITE WILL BE LIMITED TO TOPSOIL IN AREAS TO BE PAVED AND ANY DELETERIOUS MATERIAL ENCOUNTERED DURING EXCAVATION.

 MATERIAL TO BE EXPORTED WILL BE LIMITED TO GRAVEL BASE AND SEPTIC AGGREGATE.

SITE PLAN NOTES:

1. THIS PLAN SET HAS BEEN ISSUED FOR PERMITTING ONLY. A FULL CONSTRUCTION PLAN SET SHALL BE ISSUED ONCE ALL LOCAL, STATE, AND FEDERAL PERMIT APPROVALS HAVE BEEN GRANTED.

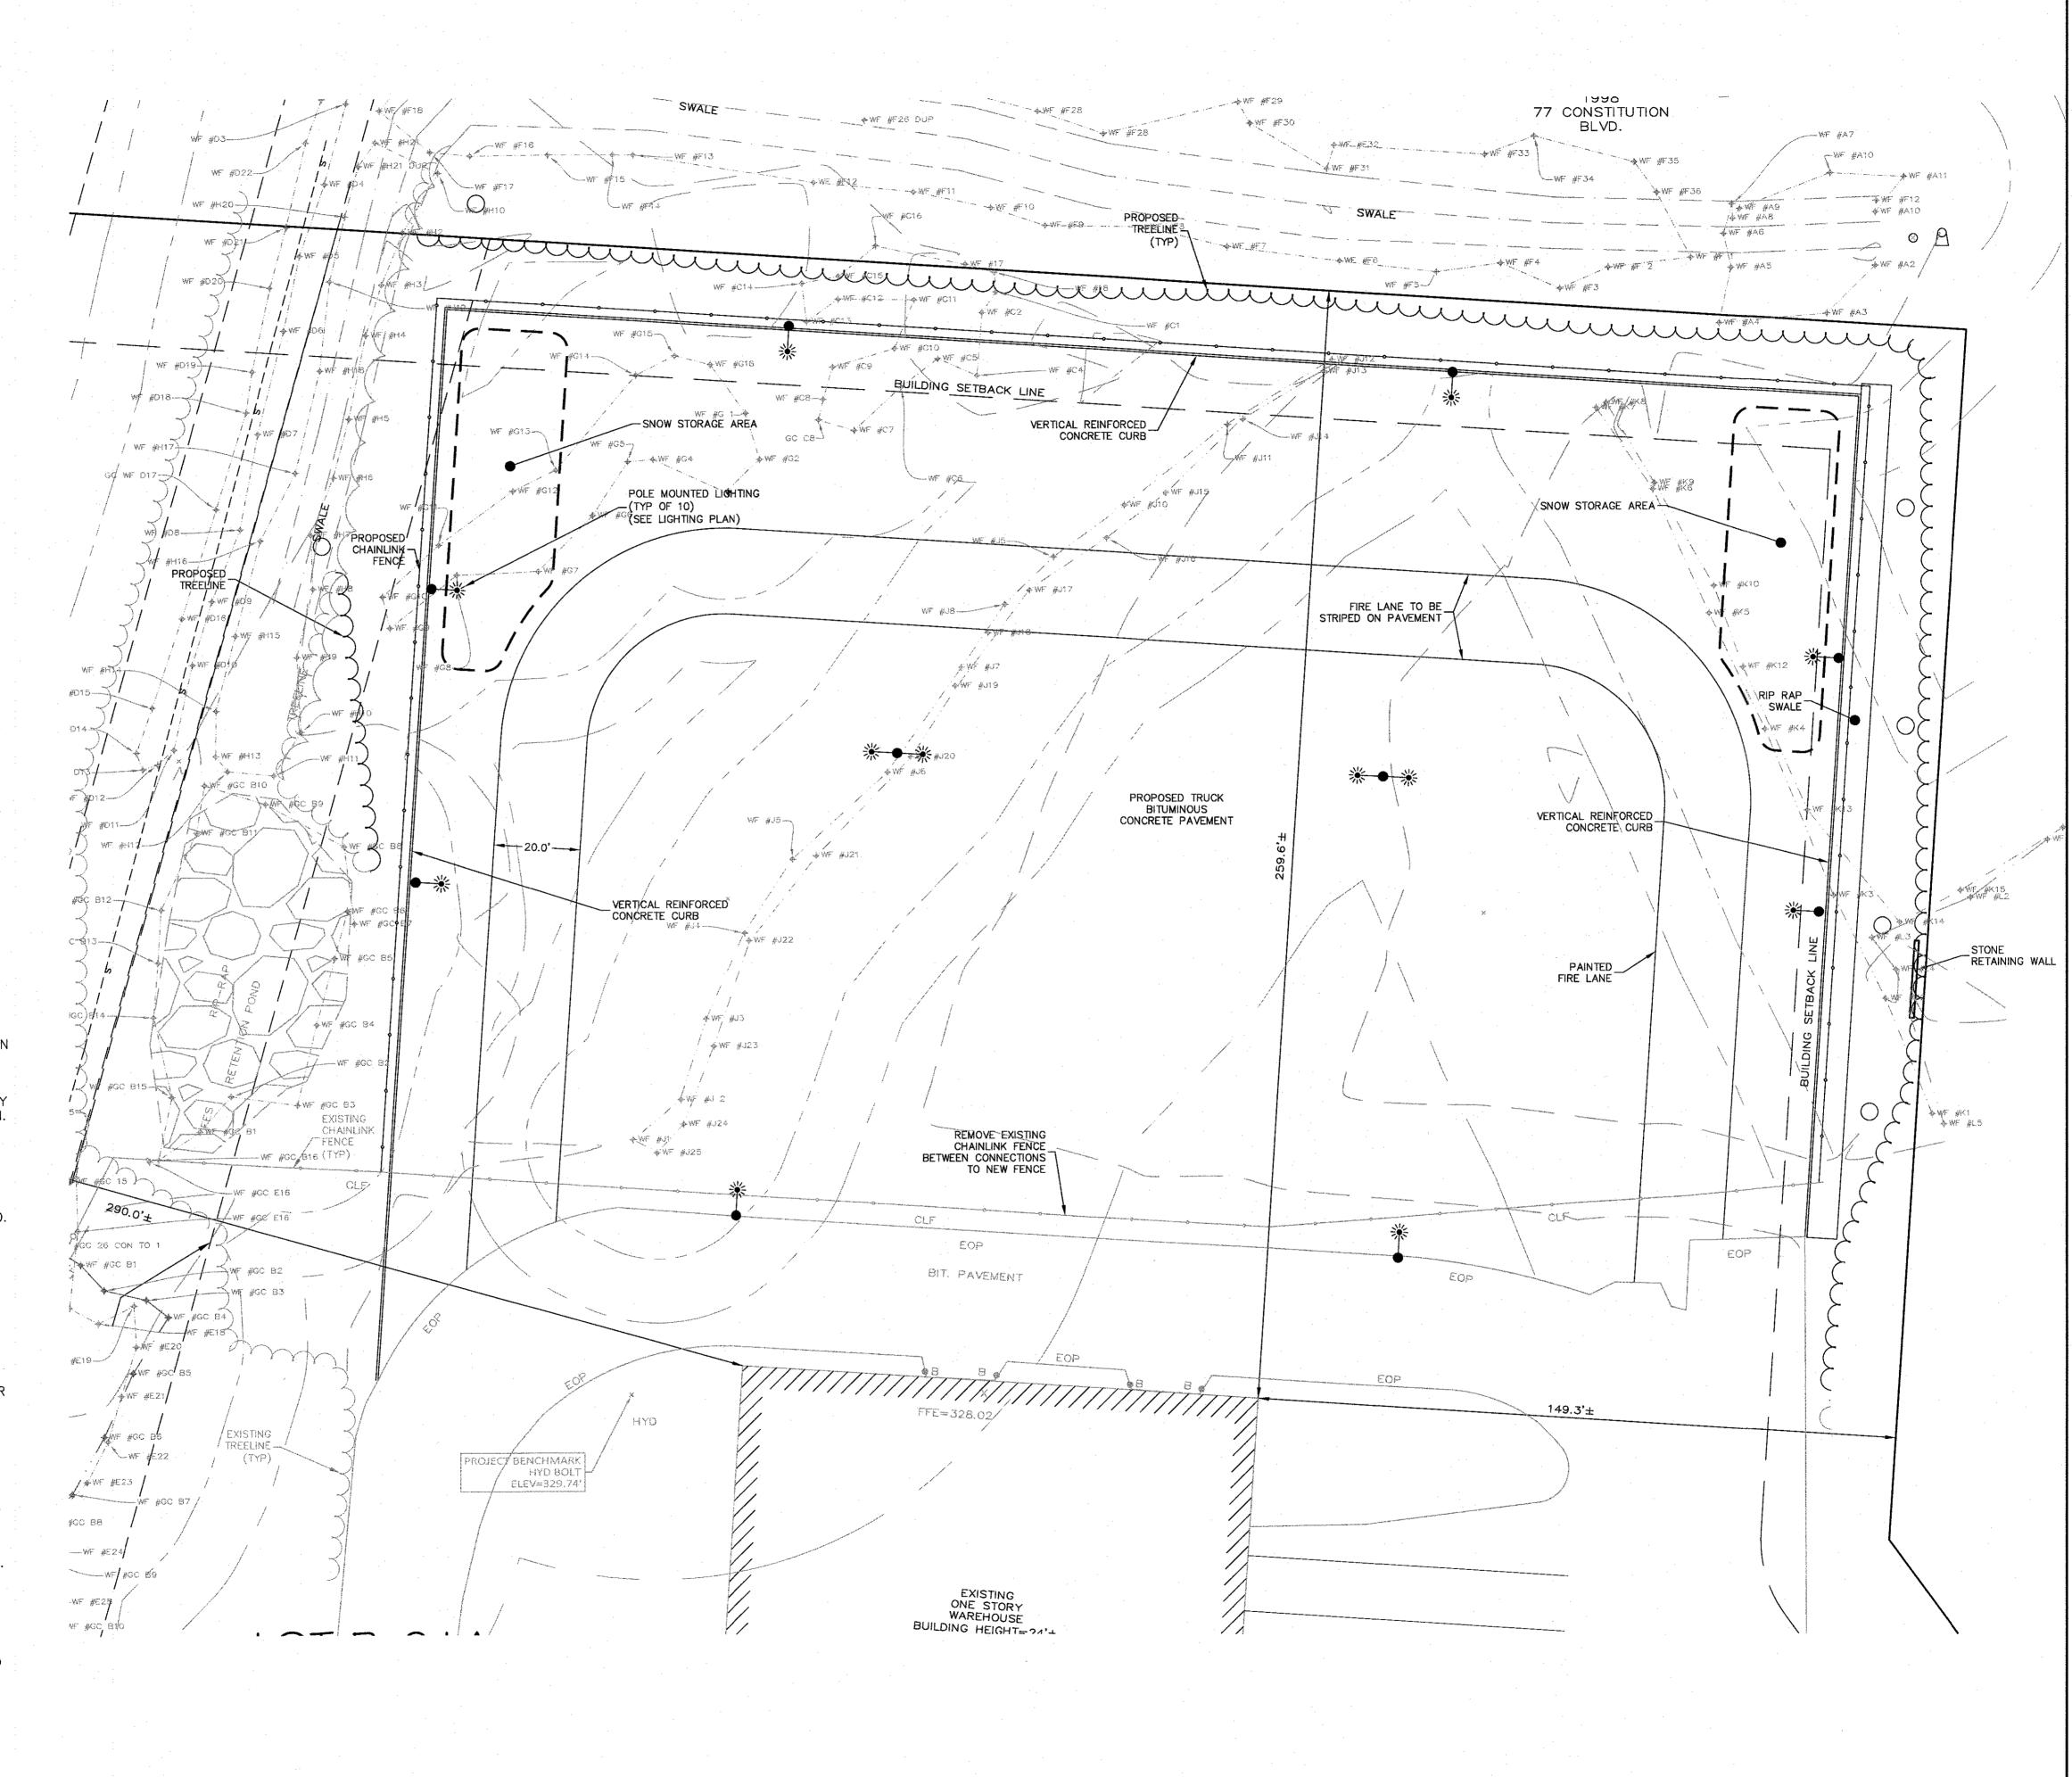

1 10/17/2023 RESOURCE AREA FLAGS

DATE:

DRAWN:

SCALE:

JANUARY 13, 2023

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DESIGN GROUP


249 SOUTH STREET, UNIT 1 PLAINVILLE, MA 02762

TEL. (508) 695-2221 FAX. (508) 695-2219

LAYOUT &

MATERIALS

AH / DRC 1" = 20'

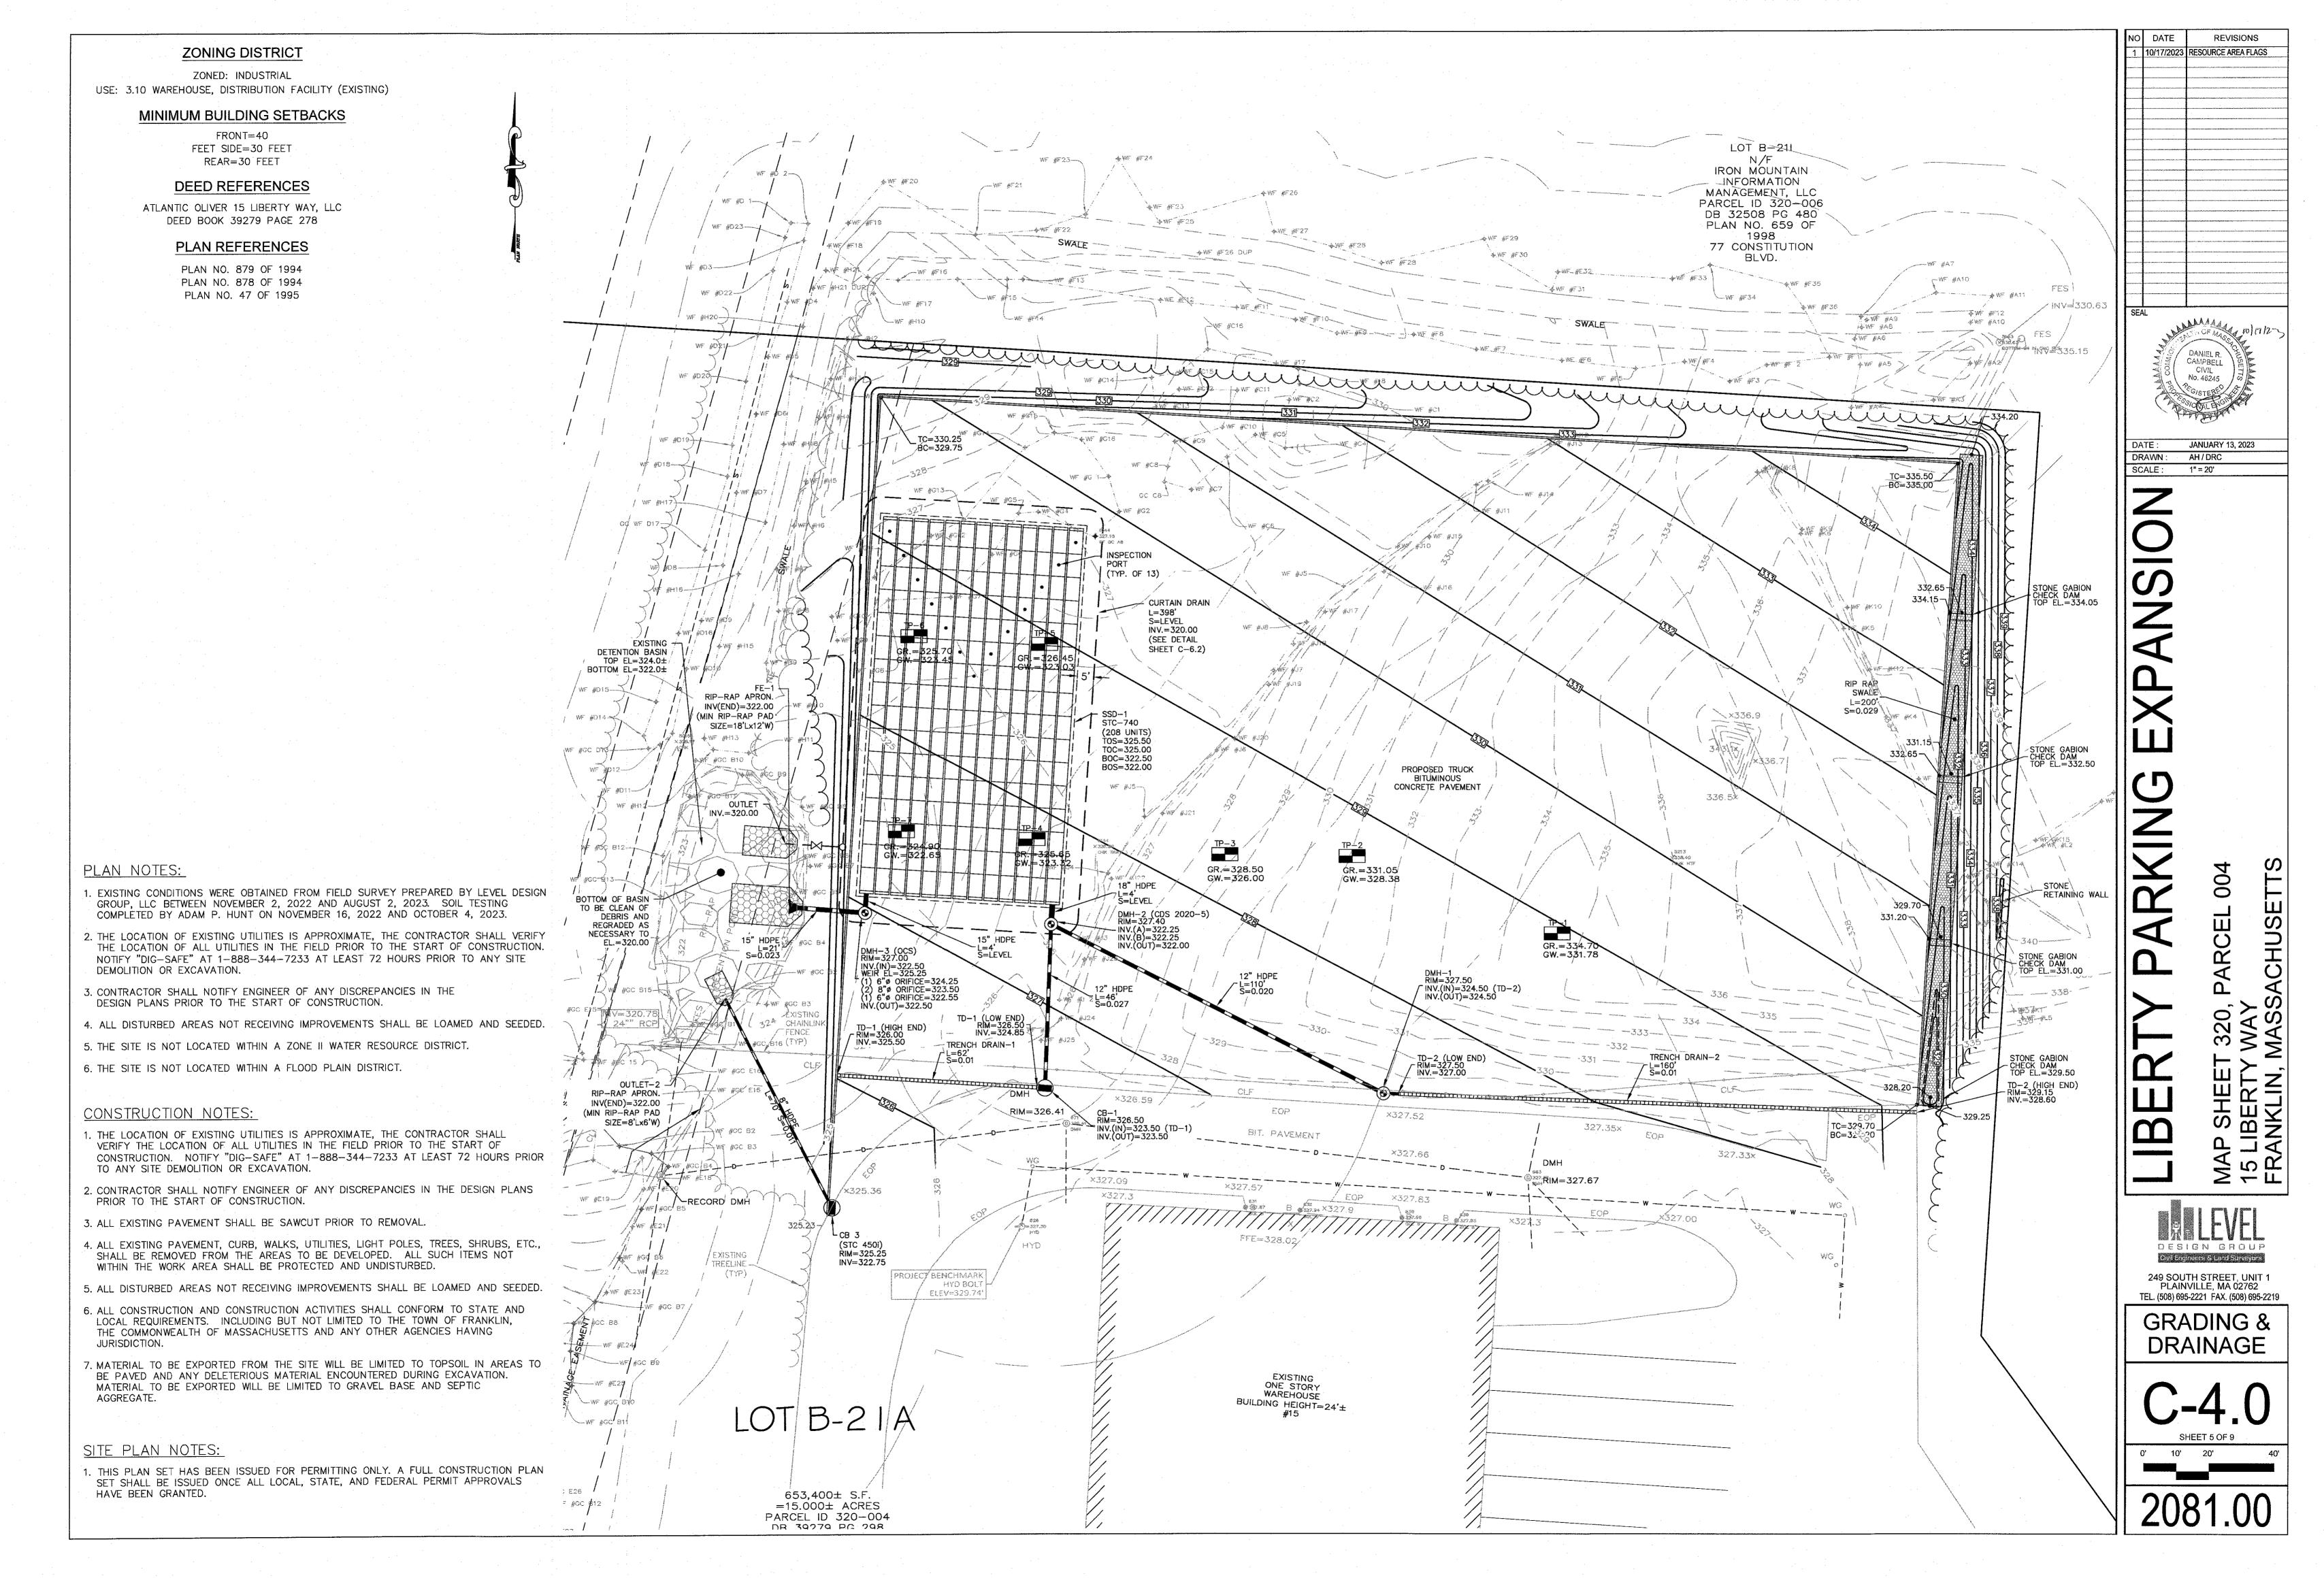

ZONED: INDUSTRIAL

ZONING DISTRICT

USE: 3.10 WAREHOUSE, DISTRIBUTION FACILITY (EXISTING)

MINIMUM BUILDING SETBACKS

FRONT=40
FEET SIDE=30 FEET
REAR=30 FEET

DEED REFERENCES

ATLANTIC OLIVER 15 LIBERTY WAY, LLC DEED BOOK 39279 PAGE 278

PLAN REFERENCES

PLAN NO. 879 OF 1994 PLAN NO. 878 OF 1994 PLAN NO. 47 OF 1995

EROSION CONTROL PLAN NOTES:

SILTATION CONTROL USING EROSION CONTROL FENCE WITH STRAW WATTLE, OR APPROVED EQUAL

SILTSOXX IS TO BE VISUALLY INSPECTED AFTER EVERY RAIN FALL AND REPAIRS MADE AS REQUIRED TO THE SILTATION CONTROL FENCE AND STRAW WATTLE AFTER EACH RAIN FALL. CLEANOUT OF ACCUMULATED SEDIMENT BEHIND THE WATTLE IS NECESSARY IF ½ OF THE ORIGINAL HEIGHT OF THE WATTLE APPEARS TO HAVE BEEN INUNDATED WITH SEDIMENT.

PRESERVE TOPSOIL

SITE OWNERS AND OPERATORS MUST PRESERVE EXISTING TOPSOIL ON THE CONSTRUCTION SITE TO THE MAXIMUM EXTENT FEASIBLE AND AS NECESSARY TO SUPPORT HEALTHY VEGETATION, PROMOTE SOIL STABILIZATION, AND INCREASE STORMWATER INFILTRATION RATES IN THE POST-CONSTRUCTION PHASE OF THE PROJECT.

STABILIZATION OF SOILS

UPON COMPLETION AND ACCEPTANCE OF SITE PREPARATION AND INITIAL INSTALLATION OF EROSION, RUNOFF, AND SEDIMENT CONTROLS AND TEMPORARY POLLUTION PREVENTION MEASURES, THE OPERATOR SHALL INITIATE APPROPRIATE TEMPORARY OR PERMANENT STABILIZATION PRACTICES DURING ALL PHASES OF CONSTRUCTION ON ALL DISTURBED AREAS AS SOON AS POSSIBLE BUT NOT MORE THAN FOURTEEN (14) DAYS AFTER THE CONSTRUCTION ACTIVITY IN THAT AREA HAS TEMPORARILY OR PERMANENTLY CEASED UNLESS THE ACTIVITY IS TO RESUME WITHIN TWENTY—ONE (21) DAYS.

ALL TEMPORARY EROSION AND SEDIMENT CONTROL MEASURES SHALL BE REMOVED AFTER FINAL SITE STABILIZATION. DISTURBED SOIL AREAS RESULTING FROM THE REMOVAL OF TEMPORARY MEASURES SHALL BE PERMANENTLY STABILIZED WITHIN 30 DAYS OF REMOVAL.

ONLY AREAS THAT CAN BE REASONABLY EXPECTED TO HAVE ACTIVE CONSTRUCTION WORK BEING PERFORMED WITHIN 14 DAYS OF DISTURBANCE WILL BE CLEARED/GRUBBED AT ANY ONE TIME. IT IS NOT ACCEPTABLE TO GRUB AND STRIP TOP SOIL THE ENTIRE CONSTRUCTION SITE IF PORTIONS WILL NOT BE ACTIVE WITHIN THE 14-DAY TIME FRAME. PROPER PHASING OF CLEARING AND GRUBBING ACTIVITIES SHALL INCLUDE TEMPORARY STABILIZATION TECHNIQUES FOR AREAS CLEARED AND GRUBBED THAT WILL NOT BE ACTIVE WITHIN THE 14-DAY TIME FRAME.

ONLY AREAS THAT CAN BE REASONABLY EXPECTED TO HAVE ACTIVE CONSTRUCTION WORK BEING PERFORMED WITHIN 14 DAYS OF DISTURBANCE WILL BE CLEARED/GRUBBED AT ANY ONE TIME. IT IS NOT ACCEPTABLE TO GRUB AND STRIP TOP SOIL THE ENTIRE CONSTRUCTION SITE IF PORTIONS WILL NOT BE ACTIVE WITHIN THE 14-DAY TIME FRAME. PROPER PHASING OF CLEARING AND GRUBBING ACTIVITIES SHALL INCLUDE TEMPORARY STABILIZATION TECHNIQUES FOR AREAS CLEARED AND GRUBBED THAT WILL NOT BE ACTIVE WITHIN THE 14-DAY TIME FRAME.

STEEP SLOPES SHALL NOT BE LEFT UNATTENDED OR EXPOSED FOR EXCESSIVE PERIODS OF TIME SUCH AS THE INACTIVE WINTER SEASON. THE CONTRACTOR SHALL INITIATE APPROPRIATE VEGETATIVE PRACTICES ON ALL DISTURBED AREAS IN AREAS OF STEEP SLOPES AS SOON AS POSSIBLE BUT NOT MORE THAN FOURTEEN (14) DAYS AFTER THE CONSTRUCTION ACTIVITY IN THAT AREA HAS TEMPORARILY OR PERMANENTLY CEASED, UNLESS THE ACTIVITY IS TO RESUME WITHIN TWENTY—ONE (21) DAYS. ONCE AN STEEP SLOPE AREA HAS BEEN TEMPORARY AND/OR FINAL SEEDED IT SHALL BE PROTECTED WITH 4' HIGH ORANGE CONSTRUCTION TO PREVENT FURTHER DISTURBANCE OF THE AREA.

THE TEMPORARY SEEDING DESIGN MIX SHALL BE COMPRISED OF THE FOLLOWING:

TYPE % BY WEIGHT
ANNUAL RYE GRASS 40
PERENNIAL RYE GRASS 60

STORMWATER INLET PROTECTION

INLET PROTECTION — WILL BE UTILIZED TO PREVENT SOIL AND DEBRIS FROM ENTERING STORM DRAIN INLETS. THESE MEASURES ARE USUALLY TEMPORARY AND ARE IMPLEMENTED BEFORE A SITE IS DISTURBED. ALL STORMWATER INLETS &/OR CATCH BASINS THAT ARE OPERATIONAL DURING CONSTRUCTION AND HAVE THE POTENTIAL TO RECEIVE SEDIMENT—LADEN STORMWATER FLOW FROM THE CONSTRUCTION SITE MUST BE PROTECTED USING CONTROL MEASURES OUTLINED IN THE STORMWATER POLLUTION PREVENTION PLAN. EROSION CONTROL FENCE WITH STRAW WATTLES ARE TO BE PLACED AT TO OPENING OF ALL ROUGH GRADED SEDIMENT FOREBAYS UNTIL THE FOREBAY AND BASIN HAS BEEN STABILIZED AND BROUGHT ON—LINE.

MAINTENANCE - THE OPERATOR MUST CLEAN, OR REMOVE AND REPLACE THE INLET PROTECTION MEASURES AS SEDIMENT ACCUMULATES, THE FILTER BECOMES CLOGGED, AND/OR AS PERFORMANCE IS COMPROMISED. ACCUMULATED SEDIMENT ADJACENT TO THE INLET PROTECTION MEASURES SHOULD BE REMOVED BY THE END OF THE SAME WORK DAY IN WHICH IT IS FOUND OR BY THE END OF THE FOLLOWING WORK DAY IF REMOVAL BY THE SAME WORK DAY IS NOT FEASIBLE.

INFILTRATION BASINS — ALL AREAS CONTAINING INFILTRATION BASINS (ABOVE OR BELOW GROUND) SHALL BE PROTECTED THROUGHOUT CONSTRUCTION. THESE AREAS ARE NOT BE USED FOR MATERIAL STOCKPILES OR FOR PARKING EQUIPMENT. SURFACE BASINS ARE TO BE ROUGH GRADED AND PROTECTED UNTIL STABILIZED AND BROUGHT ON—LINE FOR STORMWATER MANAGEMENT OF THE STABILIZED SITE.

CONSTRUCTION ENTRANCES

CONSTRUCTION ENTRANCES SHALL BE ESTABLISHED PRIOR TO REMOVAL OF EXISTING DRIVEWAY PAVEMENT TO BE USED IN CONJUNCTION WITH THE STABILIZATION OF CONSTRUCTION ROADS TO REDUCE THE AMOUNT OF SEDIMENT TRACKING OFF THE PROJECT. ANY CONSTRUCTION SITE ACCESS POINT MUST EMPLOY THE CONTROL MEASURES ON THE APPROVED SITE PLANS AND IN ACCORDANCE WITH THE STORMWATER POLLUTION PREVENTION PLAN. CONSTRUCTION ENTRANCES SHALL BE USED IN CONJUNCTION WITH THE STABILIZATION OF CONSTRUCTION ROADS TO REDUCE THE AMOUNT OF MUD PICKED UP BY CONSTRUCTION VEHICLES. ALL CONSTRUCTION ACCESS ROADS SHALL BE CONSTRUCTED PRIOR TO ANY ROADWAY ACCEPTING CONSTRUCTION TRAFFIC.

THE SITE OWNER AND OPERATOR MUST WILL RESTRICT VEHICLE USE TO PROPERLY DESIGNATED EXIT POINTS, USE PROPERLY DESIGNED AND CONSTRUCTED CONSTRUCTION ENTRANCES AT ALL POINTS THAT EXIT ONTO PAVED ROADS SO THAT SEDIMENT REMOVAL OCCURS PRIOR TO VEHICLE EXIT. WHEN AND WHERE NECESSARY, USE ADDITIONAL CONTROLS TO REMOVE SEDIMENT FROM VEHICLE TIRES PRIOR TO EXIT (I.E. WHEEL WASHING RACKS, RUMBLE STRIPS, AND RATTLE PLATES). WHERE SEDIMENT HAS BEEN TRACKED OUT FROM THE CONSTRUCTION SITE ONTO THE SURFACE OF OFFSET STREETS, OTHER PAVED AREAS, AND SIDEWALKS, THE DEPOSITED SEDIMENT MUST BE REMOVED BY THE END OF THE SAME WORK DAY IN WHICH THE TRACK OUT OCCURS. TRACK—OUT MUST BE REMOVED BY SWEEPING, SHOVELING, OR VACUUMING THESE SURFACES, OR BY USING OTHER SIMILARLY EFFECTIVE MEANS OF SEDIMENT REMOVAL.



STOCKPILE CONTAINMENT

SHALL BE USED ON—SITE TO MINIMIZE OR ELIMINATE THE DISCHARGE OF SOIL, TOPSOIL, BASE MATERIAL OR RUBBLE, FROM ENTERING DRAINAGE SYSTEMS OR SURFACE WATERS. ALL STOCKPILES MUST BE LOCATED WITHIN THE LIMIT OF DISTURBANCE, PROTECTED FROM RUN—ON WITH THE USE OF TEMPORARY SEDIMENT BARRIERS AND PROVIDED WITH COVER OR STABILIZATION TO AVOID CONTACT WITH PRECIPITATION AND WIND WHERE AND WHEN PRACTICAL. STOCK PILE MANAGEMENT CONSISTS OF PROCEDURES AND PRACTICES DESIGNED TO MINIMIZE OR ELIMINATE THE DISCHARGE OF STOCKPILED MATERIAL (SOIL, TOPSOIL, BASE MATERIAL, RUBBLE) FROM ENTERING DRAINAGE SYSTEMS OR SURFACE WATERS.
FOR ANY STOCKPILES OR LAND CLEARING DEBRIS COMPOSED, IN WHOLE OR IN PART, OF SEDIMENT OR SOIL, YOU MUST COMPLY

WITH THE FOLLOWING REQUIREMENTS — LOCATE PILES WITHIN THE DESIGNATED LIMITS OF DISTURBANCE OUTSIDE OF THE 100-FOOT BUFFER ZONE, PROTECT FROM CONTACT WITH STORMWATER (INCLUDING RUN—ON) USING A TEMPORARY PERIMETER SEDIMENT BARRIER; WHERE PRACTICABLE, PROVIDE COVER OR APPROPRIATE TEMPORARY VEGETATIVE OR STRUCTURAL STABILIZATION TO AVOID DIRECT CONTACT WITH PRECIPITATION OR TO MINIMIZE SEDIMENT DISCHARGE; NEVER HOSE DOWN OR SWEEP SOIL OR SEDIMENT ACCUMULATED ON PAVEMENT OR OTHER IMPERVIOUS SURFACES INTO ANY STORMWATER CONVEYANCE, STORM DRAIN INLET, OR SURFACE WATER; TO THE MAXIMUM EXTENT PRACTICABLE, CONTAIN AND SECURELY PROTECT FROM WIND.

GENERAL CONSTRUCTION SEQUENCING

- 1. INSTALL EROSION AND SEDIMENT CONTROLS;
- CLEAR, GRUB AND ROUGH GRADE AREAS SHOWN TO BE REGRADED;
- DEMO EXISTING FEATURES IN WORK AREA NOT SHOWN TO BE SAVED AND CUT AND CAP UTILITIES AS NEEDED;
- 4. INSTALL STORMWATER MANAGEMENT SYSTEM AND SITE UTILITIES;
- 5. INSTALL BINDER COAT PAVING;6. INSTALL LANDSCAPING;7. FINE GRADE SITE AND LOAM AND SEED ALL DISTURBED
- AREAS;
 8. INSTALL TOP COAT PAVEMENT;
- INSTALL TOP COAT PAVEMENT
 PROJECT CLOSE OUT.

PLAN NOTES:

- EXISTING CONDITIONS WERE OBTAINED FROM FIELD SURVEY PREPARED BY LEVEL DESIGN GROUP, LLC BETWEEN NOVEMBER 2, 2022 AND NOVEMBER 16, 2022. THERE ARE NO RESOURCE AREAS, IN ACCORDANCE WITH 310 CMR 10.00 WITHIN 100' OF PROPOSED SYSTEM.
- 2. THE LOCATION OF EXISTING UTILITIES IS APPROXIMATE, THE CONTRACTOR SHALL VERIFY THE LOCATION OF ALL UTILITIES IN THE FIELD PRIOR TO THE START OF CONSTRUCTION. NOTIFY "DIG-SAFE" AT 1-888-344-7233 AT LEAST 72 HOURS PRIOR TO ANY SITE DEMOLITION OR EXCAVATION.
- SEE STORMWATER POLLUTION PREVENTION PLAN PREPARED FOR CONSTRUCTION ACTIVITIES AT 15 LIBERTY WAY FRANKLIN, MA 02038, FOR ADDITIONAL EROSION AND SEDIMENT CONTROL PRACTICES AND PROCEDURES.

LIBERTY PARKING EXPAINMAP SHEET 320, PARCEL 004

REVISIONS

10/17/2023 RESOURCE AREA FLAGS

CAMPBELL

CIVIL No. 46245

AH / DRC

1" = 20'

SCALE:

JANUARY 13, 2023

DESIGN GROUP


249 SOUTH STREET, UNIT 1 PLAINVILLE, MA 02762 TEL. (508) 695-2221 FAX. (508) 695-2219


EROSION CONTROL

C-5.0

SHEET 6 OF 9

2081.00

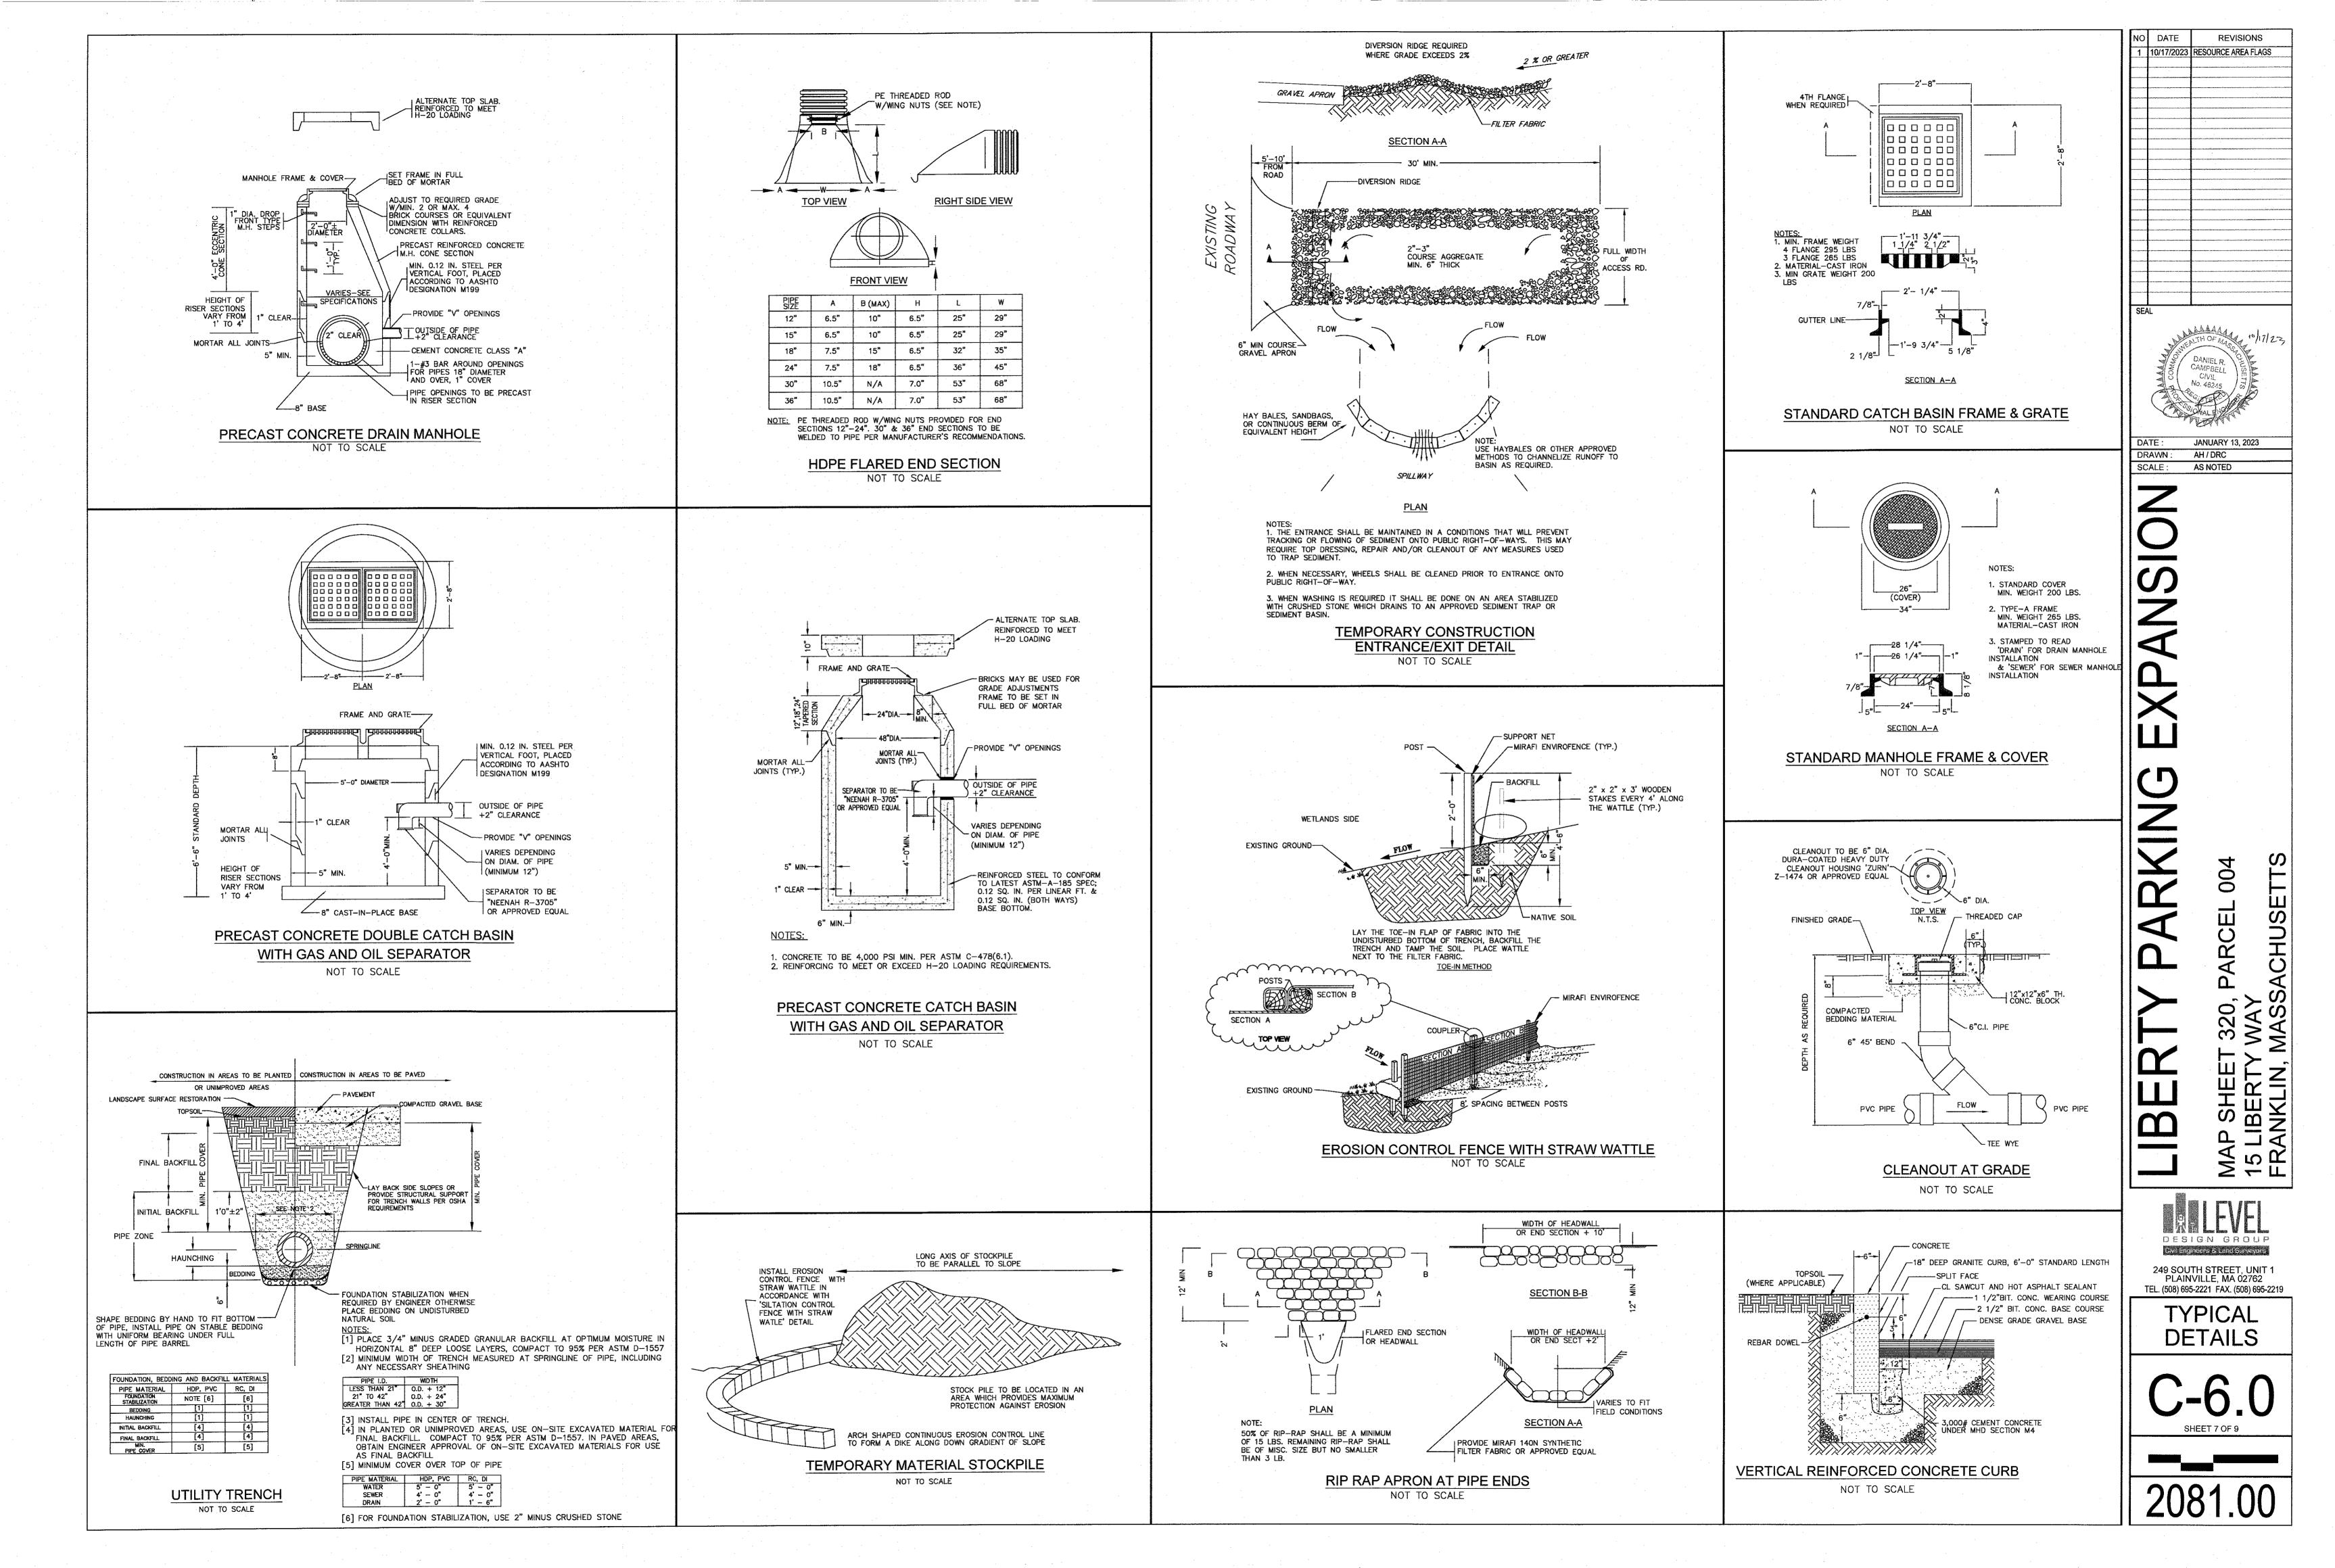

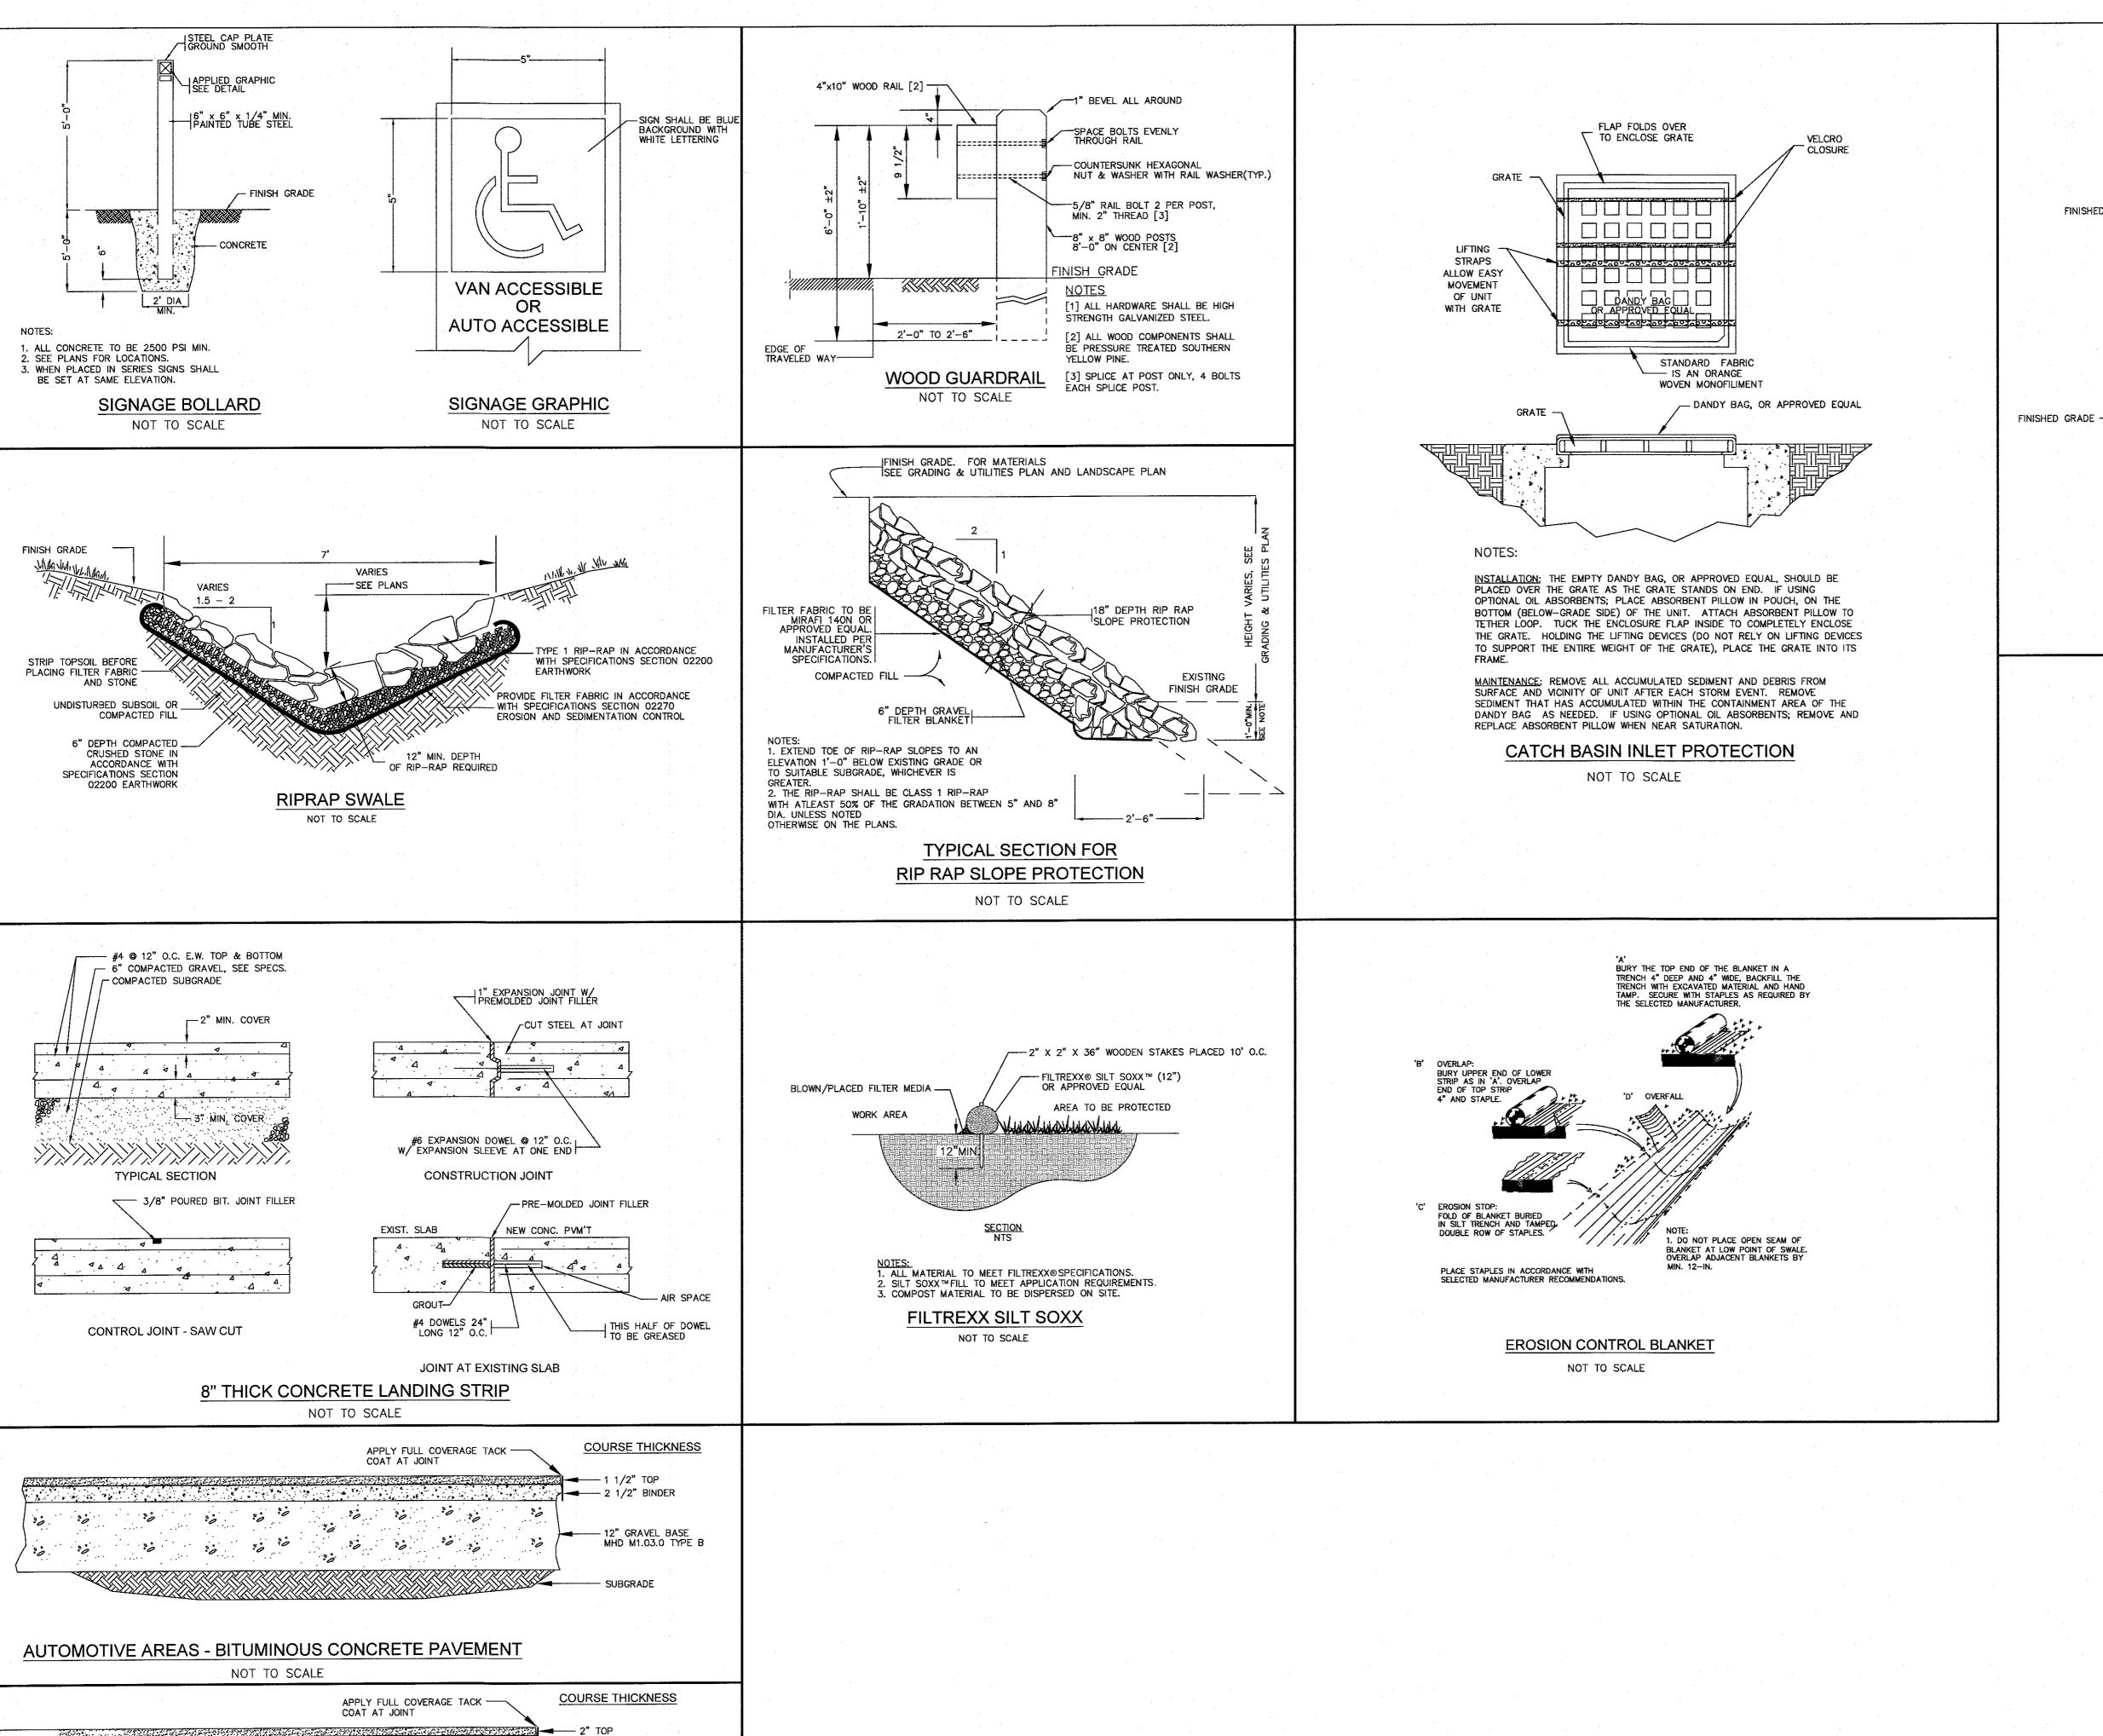



3" BINDER - 4" GRAVEL BASE MHD M1.03.0 TYPE B


TRUCK AREAS - BITUMINOUS CONCRETE PAVEMENT

NOT TO SCALE

--- 8" GRAVEL SUB-BASE MHD M1.03.0 TYPE A

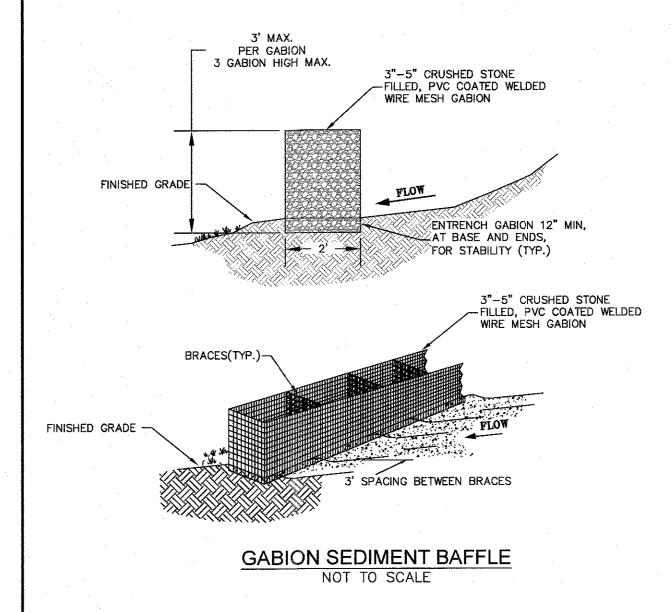

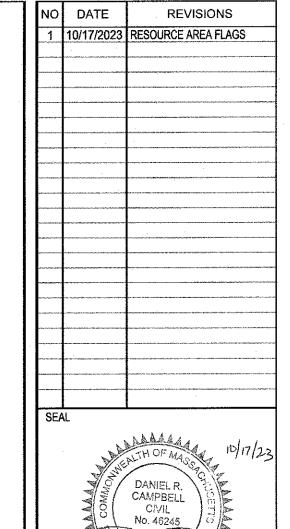

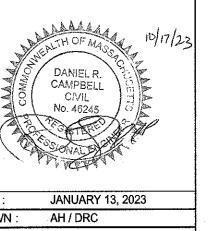

DRAWN: SCALE: AS NOTED

00

249 SOUTH STREET, UNIT 1 PLAINVILLE, MA 02762 TEL. (508) 695-2221 FAX. (508) 695-2219

> **TYPICAL DETAILS**

GENERAL NOTES


- 1. CONTECH TO PROVIDE ALL MATERIALS UNLESS NOTED OTHERWISE. 2. CONTRACTOR SHALL REQUEST SHOP DRAWINGS OF EACH INDIVIDUAL CDS STORMWATER
- TREATMENT UNIT AND SHALL SUBMIT THEM FOR REVIEW AND APPROVAL TO THE DESIGN ENGINEER PRIOR TO UNITS BEING ORDERED OR ENTERING PRODUCTION. DIMENSIONS MARKED WITH () ARE REFERENCE DIMENSIONS. ACTUAL DIMENSIONS MAY VARY.
- 4. FOR FABRICATION DRAWINGS WITH DETAILED STRUCTURE DIMENSIONS AND WEIGHTS. PLEASE CONTACT YOUR CONTECH CONSTRUCTION PRODUCTS REPRESENTATIVE. www.contech-cpi.com 5. CDS WATER QUALITY STRUCTURE SHALL BE IN ACCORDANCE WITH ALL DESIGN DATA AND
- INFORMATION CONTAINED IN THIS DRAWING. 6. STRUCTURE SHALL MEET AASHTO HS20 AND CASTINGS SHALL MEET AASHTO M306 LOAD RATING, ASSUMING GROUNDWATER ELEVATION AT, OR BELOW, THE OUTLET PIPE INVERT ELEVATION.
- ENGINEER OF RECORD TO CONFIRM ACTUAL GROUNDWATER ELEVATION.
 7. PVC HYDRAULIC SHEAR PLATE IS PLACED ON SHELF AT BOTTOM OF SCREEN CYLINDER. REMOVE


AND REPLACE AS NECESSARY DURING MAINTENANCE CLEANING.

- INSTALLATION NOTES

 1. ANY SUB-BASE, BACKFILL DEPTH, AND/OR ANTI-FLOTATION PROVISIONS ARE SITE-SPECIFIC DESIGN


 1. ANY SUB-BASE, BACKFILL DEPTH, AND/OR ANTI-FLOTATION PROVISIONS ARE SITE-SPECIFIC DESIGN CONSIDERATIONS AND SHALL BE SPECIFIED BY ENGINEER OF RECORD. 2. CONTRACTOR TO PROVIDE EQUIPMENT WITH SUFFICIENT LIFTING AND REACH CAPACITY TO LIFT AND
- SET THE CDS MANHOLE STRUCTURE (LIFTING CLUTCHES PROVIDED). 3. CONTRACTOR TO ADD JOINT SEALANT BETWEEN ALL STRUCTURE SECTIONS, AND ASSEMBLE
- 4. CONTRACTOR TO PROVIDE, INSTALL, AND GROUT PIPES. MATCH PIPE INVERTS WITH ELEVATIONS
- 5. CONTRACTOR TO TAKE APPROPRIATE MEASURES TO ASSURE UNIT IS WATER TIGHT. HOLDING
- WATER TO FLOWLINE INVERT MINIMUM. IT IS SUGGESTED THAT ALL JOINTS BELOW PIPE INVERTS ARE GROUTED.

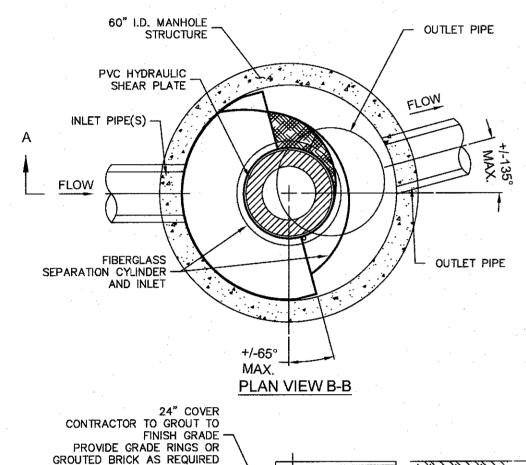


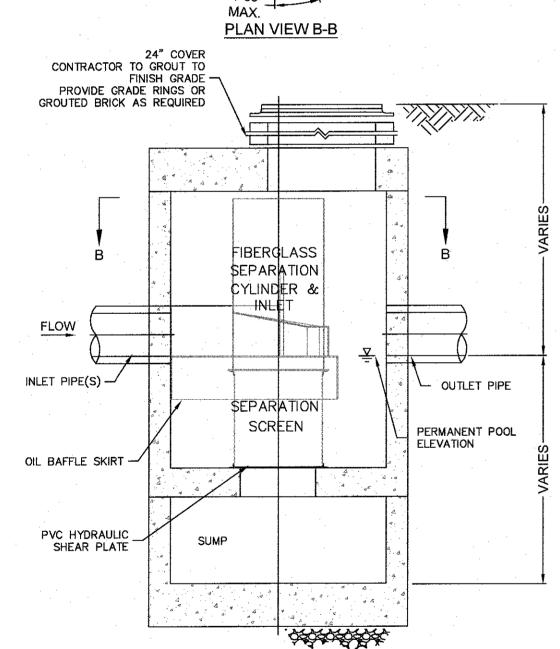

ELEVATION VIEW


STORM WATER TREATMENT UNIT

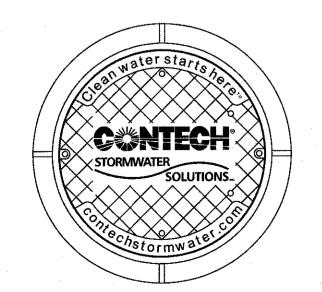

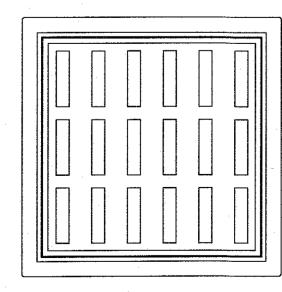

FRAME AND COVER (DIAMETER VARIES) N.T.S.


FRAME AND GRATE (24" SQUARE) N.T.S.

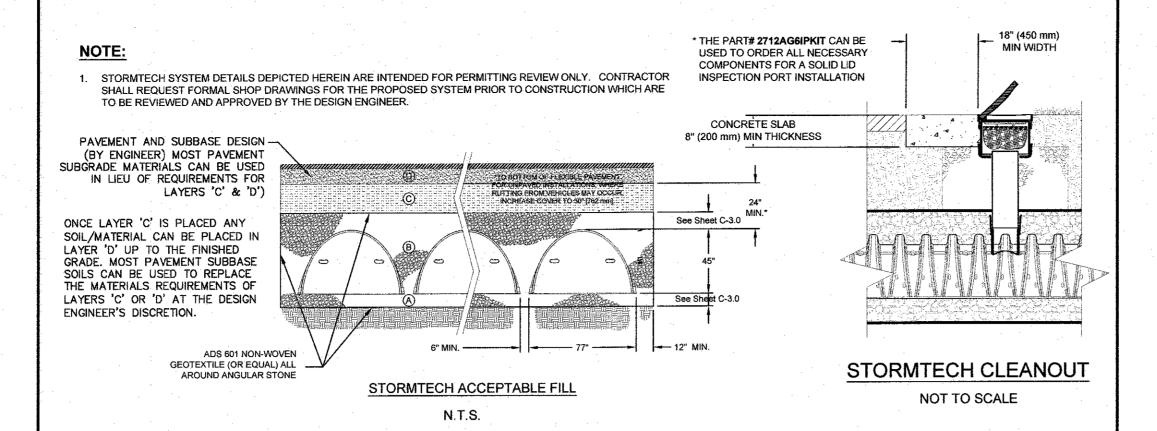


MATERIAL LOCATION	DESCRIPTION	AASHTO M43 DESIGNATION ¹	COMPACTION/DENSITY REQUIREMENT
FILL MATERIAL FOR LAYER 'D' STARTS FROM THE TOP OF THE 'C' LAYER TO THE BOTTOM OF FLEXIBLE PAVEMENT OR UNPAVED FINISHED GRADE ABOVE. NOTE THAT PAVEMENT SUBBASE MAY BE PART OF THE 'D' LAYER.	ANY SOIL/ROCK MATERIALS, NATIVE SOILS, OR PER ENGINEER'S PLANS. CHECK PLANS FOR PAVEMENT SUBGRADE REQUIREMENTS.	N/A	PREPARE PER ENGINEER'S PLANS. PAVED INSTALLATIONS MAY HAVE STRINGENT MATERIAL AND PREPARATION REQUIREMENTS.
FILL MATERIAL FOR LAYER 'C' STARTS FROM THE TOP OF THE EMBEDMENT STONE ('B' LAYER) TO 24" [610 mm] ABOVE THE TOP OF THE CHAMBER. NOTE THAT PAVEMENT SUBBASE MAY BE A PART OF THIS LAYER.	GRANULAR WELL-GRADED SOIL/AGGREGATE MIXTURES, < 35% FINES. MOST PAVEMENT SUBBASE MATERIALS CAN BE USED IN LIEU OF THIS LAYER.	3, 357, 4, 467, 5, 56, 57, 6, 67, 68, 7, 78, 8, 89, 9, 10	BEGIN COMPACTION AFTER 24" [610 mm] OF MATERIAL OVER THE CHAMBERS IS REACHED. COMPACT ADD— ITIONAL LAYERS IN 6" [152 mm] MAX LIFTS TO A MIN. 95% STANDARD PROCTOR DENSITY.
B EMBEDMENT STONE SURROUNDING THE CHAMBERS FROM THE FOUNDATION STONE TO THE 'C' LAYER ABOVE.	CLEAN, CRUSHED, ANGULAR STONE, NOMINAL SIZE DISTRIBUTION BETWEEN 3/4 - 2 INCH [19 - 51 mm]	3, 357, 4, 467, 5, 56, 57	NO COMPACTION REQUIRED.
FOUNDATION STONE BELOW CHAMBERS FROM THE SUBGRADE UP TO THE FOOT (BOTTOM) OF THE CHAMBER.	CLEAN, CRUSHED, ANGULAR STONE, NOMINAL SIZE DISTRIBUTION BETWEEN 3/4 - 2 INCH [19 - 51 mm]	3, 35, 4, 467, 5, 56, 57	PLATE COMPACT OR ROLL TO ACHIEVE A 95% STANDARD PROCTOR DENSITY 2.


PLEASE NOTE:
1. THE LISTED AASHTO DESIGNATIONS ARE FOR GRADATIONS ONLY. THE STONE MUST ALSO BE CLEAN, CRUSHED, ANGULAR. FOR EXAMPLE, A SPECIFICATION FOR #4 STONE WOULD STATE: 'CLEAN, CRUSHED, ANGULAR NO. 4 (AASHTO M43) STONE".


2. AS AN ALTERNATE TO PROCTOR TESTING AND FIELD DENSITY MEASUREMENTS ON OPEN GRADED STONE, STORMTECH COMPACTION REQUIREMENTS ARE MET FOR 'A' LOCATION MATERIALS WHEN PLACED AND COMPACTED IN 9"[229 mm] (MAX) LIFTS USING TWO FULL COVERAGES WITH AN APPROPRIATE COMPACTOR.

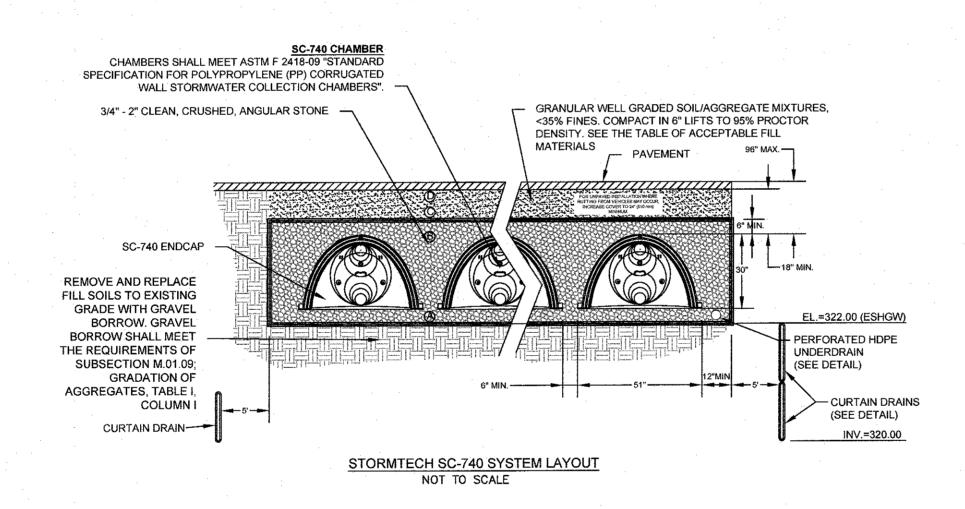


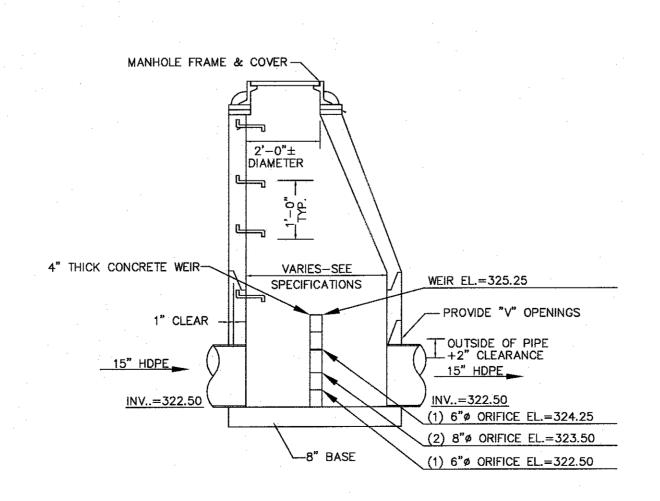

DRAIN MANHOLE-3 W/OUTLET STRUCTURE NOT TO SCALE

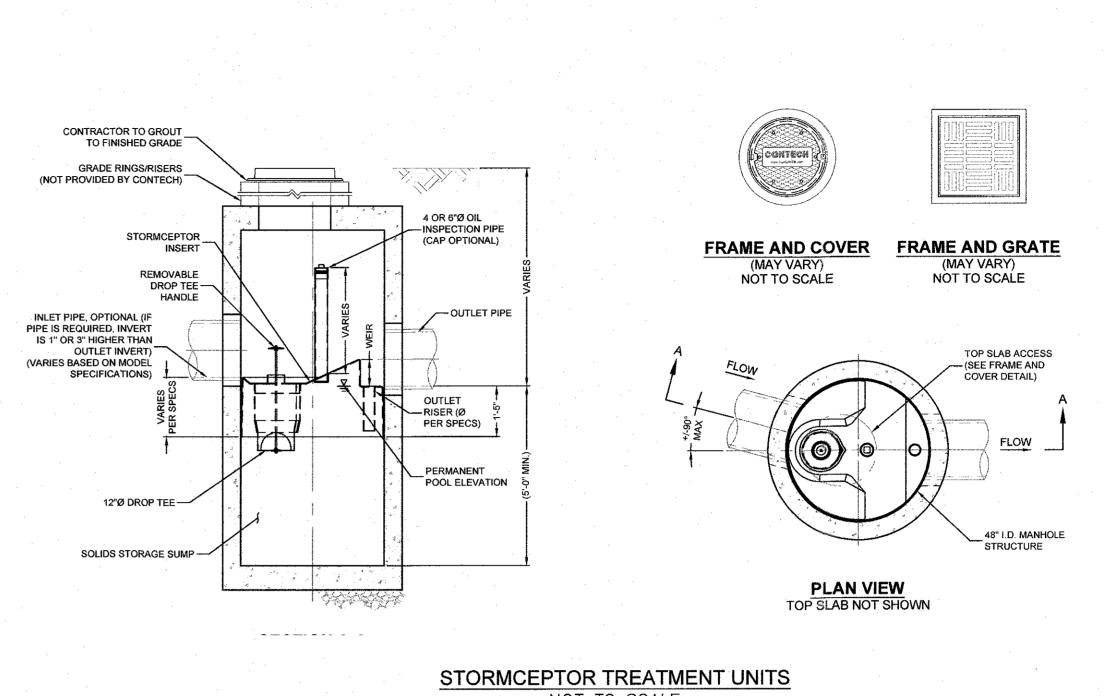

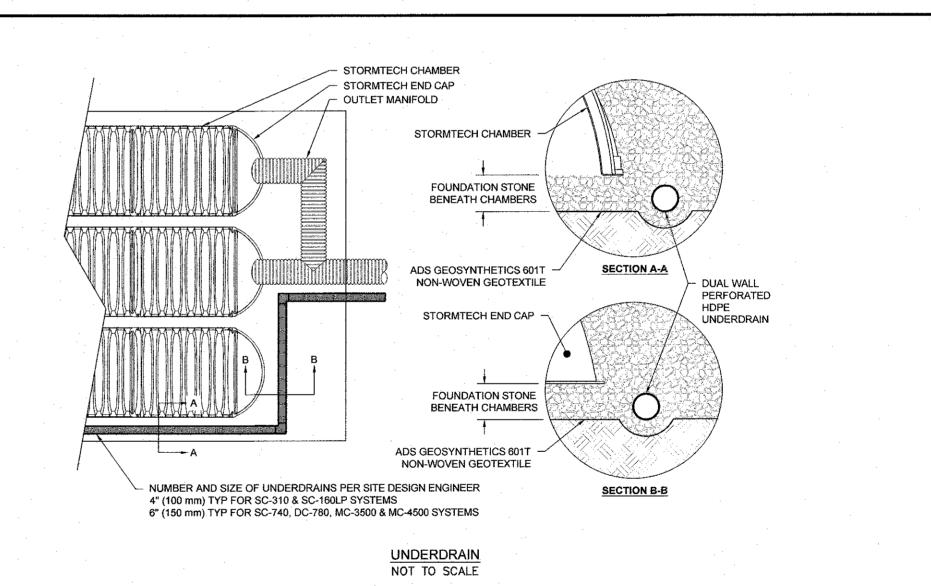

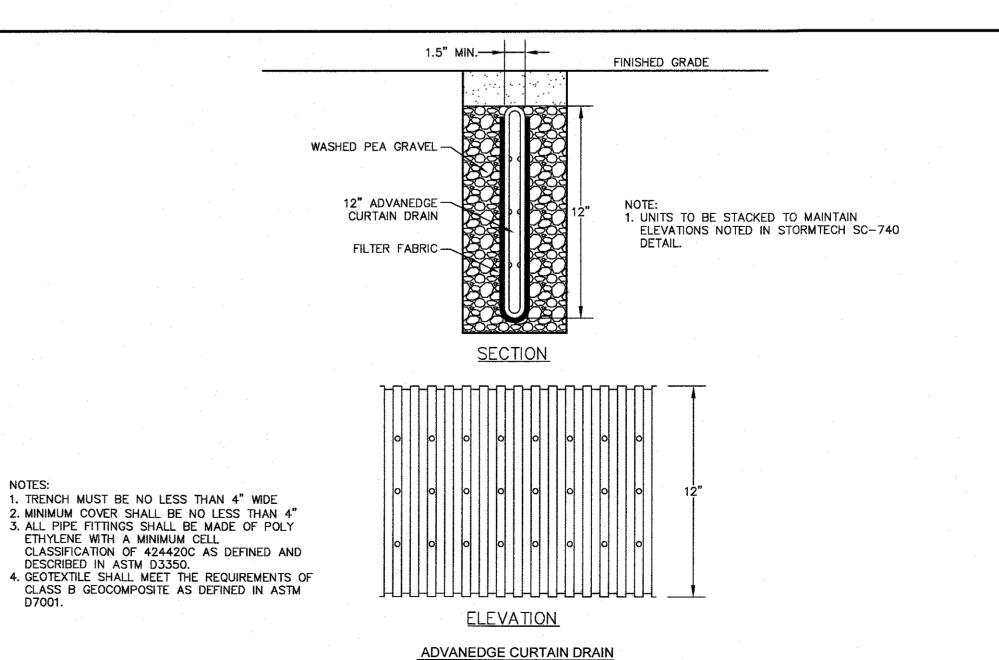

NOT TO SCALE



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CHUS

NO DATE

SEAL

REVISIONS

10/17/2023 RESOURCE AREA FLAGS

JANUARY 13, 2023

DESIGN GROUP Civil Engineers & Land Surveyor

249 SOUTH STREET, UNIT 1 PLAINVILLE, MA 02762 TEL. (508) 695-2221 FAX. (508) 695-2219

TYPICAL DETAILS

SHEET 9 OF 9