


NOT TO SCALE

APPLICANT/OWNER: TMC HOLDINGS & DEVELOPMENT 2, LLC 25 FORGE PARKWAY FRANKLIN, MA 02038


CIVIL ENGINEER:
ALLEN & MAJOR ASSOCIATES, INC.
400 HARVEY ROAD
MANCHESTER, NH 03103

SURVEYOR:
ALLEN & MAJOR ASSOCIATES, INC.
100 COMMERCE WAY
WOBURN, MA 01801

25 FORGE PARKWAY FRANKLIN, MA 02038 TAX MAP 275, LOT 14

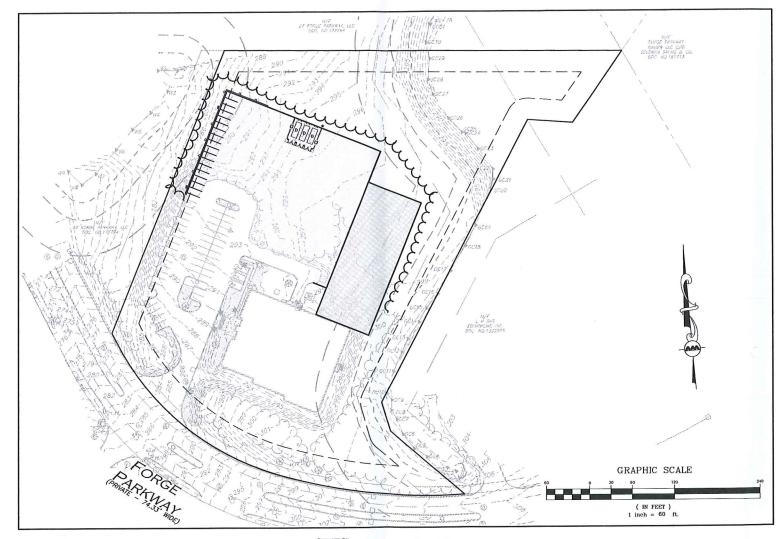

LIST OF	DRAWINGS		
DRAWING TITLE	SHEET NO.	ISSUED	REVISION 1
EXISTING CONDITIONS	V-101	02-21-23	-
SITE PREPARATION PLAN	C-101	02-21-23	
LAYOUT & MATERIALS PLAN	C-102	02-21-23	-
GRADING & DRAINAGE PLAN	C-103	02-21-23	-
LIGHTING PLAN	C-104	02-21-23	
DETAILS	C-501	02-21-23	
DETAILS	C-502	02-21-23	-
DETAILS	C-503	02-21-23	

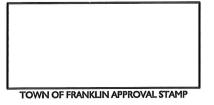






WOBURN, MA • LAKEVILLE, MA • MANCHESTER, NII

Copyright © 2023 Allim & Major Associates, Inc.

All Rights Reserved

ISSUED FOR INITIAL REVIEW: FEBRUARY 21, 2023

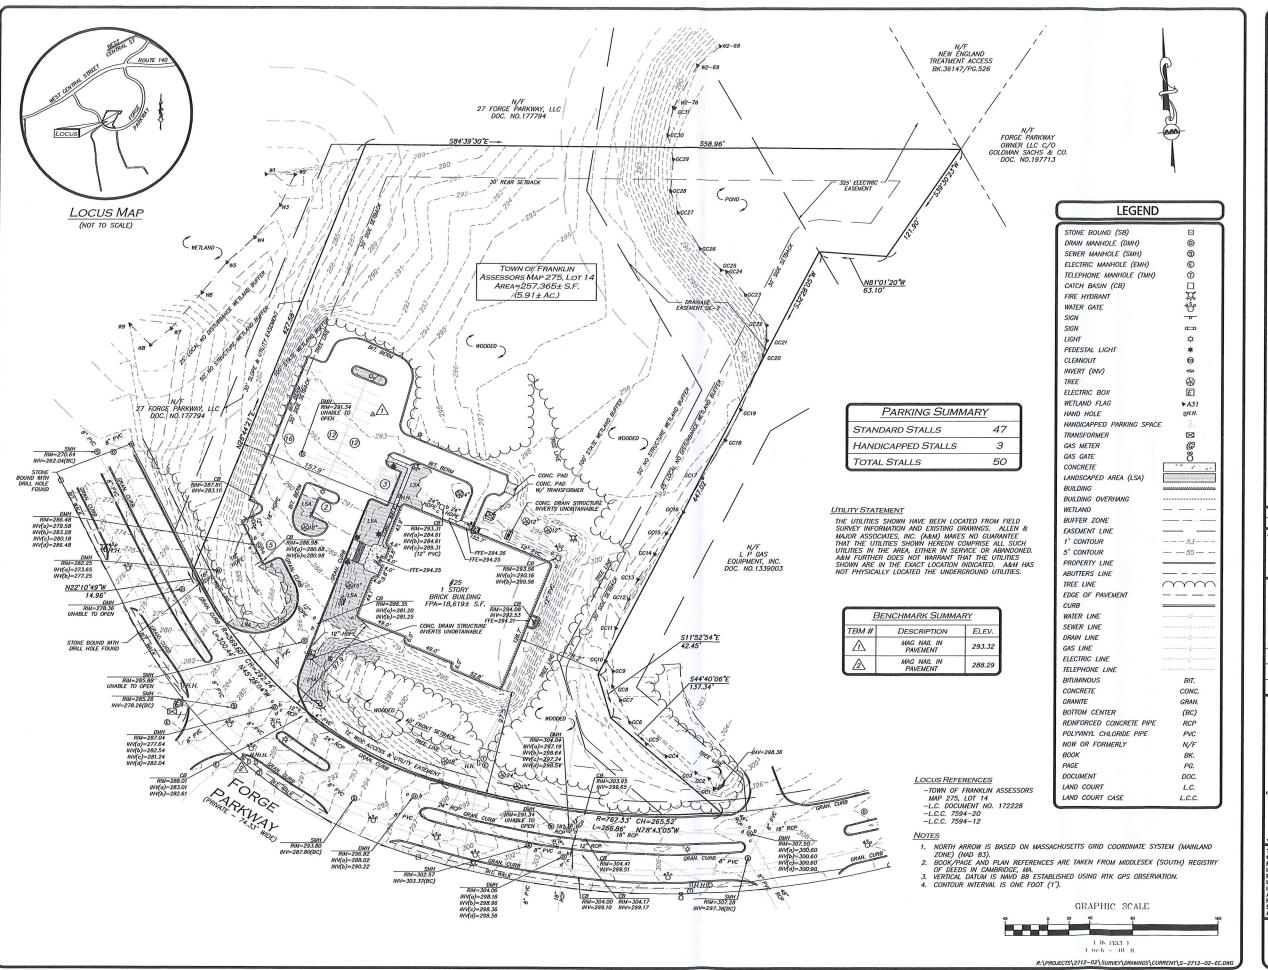

WE HEREBY CERTIFY THAT THIS PLAN IS THE RESULT OF AN ACTUAL ON THE GROUND SURVEY PERFORMED ON OR BETWEEN APRIL 1, 2021 AND FEBRUARY 15, 2023.

PROFESSIONAL LAND SURVEYOR FOR ALLEN & MAJOR ASSOCIATES, INC.



REV DATE DESCRIPTION

GREEN SITE SERVICES GROUP 24 WILLIAM WAY BELLINGHAM, MA 02019

PROJECT

25 FORGE PARKWAY FRANKLIN, MA

PROJECT NO. 2712-02 DATE: 2/15/22

SCALE: 1*-40' DWG, NAME: S-2712-02-EC

DRAFTED BY: AJR CHECKED BY: NIII



civil engineering + land surveying ronmental consulting + landscape architectur www.allenmajor.com 100 COMMERCE WAY WOBURN MA 01801-8501


OBURN, MA + LAKEVILLE, MA + MANCHESTER, NH

THIS DRAWNING HAS BEEN PREPARED IN DIGITAL FORMAT CULTRIT/CLIBRY REPRESENTATIVE OR CONSULTATION MAY BE PROVIDED COPIES OF DRAWNINGS AND SPECIFICATIONS FOR HIS/HEI MINFORMATION AND/OR SPECIAL USE ON THIS PROUDET. DUE TO THE POTENTIAL THAT THE PROVIDED INFORMATION MAY BE MODIFIED UNINFERTIONALLY OR OTHERWISE, ALLEN B ALMOR ASSOCIATES INC. MAY REMOVE ALL RIDICATION OF THE DOCUMENT SHALL PROVIDED REPRESENTATIONS OF PORTABLE DOCUMENT FORMAT OF THE DRAWNINGS AND PORTABLE DOCUMENT FORMAT OF THE DRAWNINGS AND SPECIFICATIONS ISSUED SHALL BE THE ONLY RECORD COPIES OF ALLEN B MAJOR ASSOCIATES, INC'S WORK PRODUCT.

DRAWING TITLE:

EXISTING CONDITIONS V-101

Copyright © 2023 Allen & Major Associa

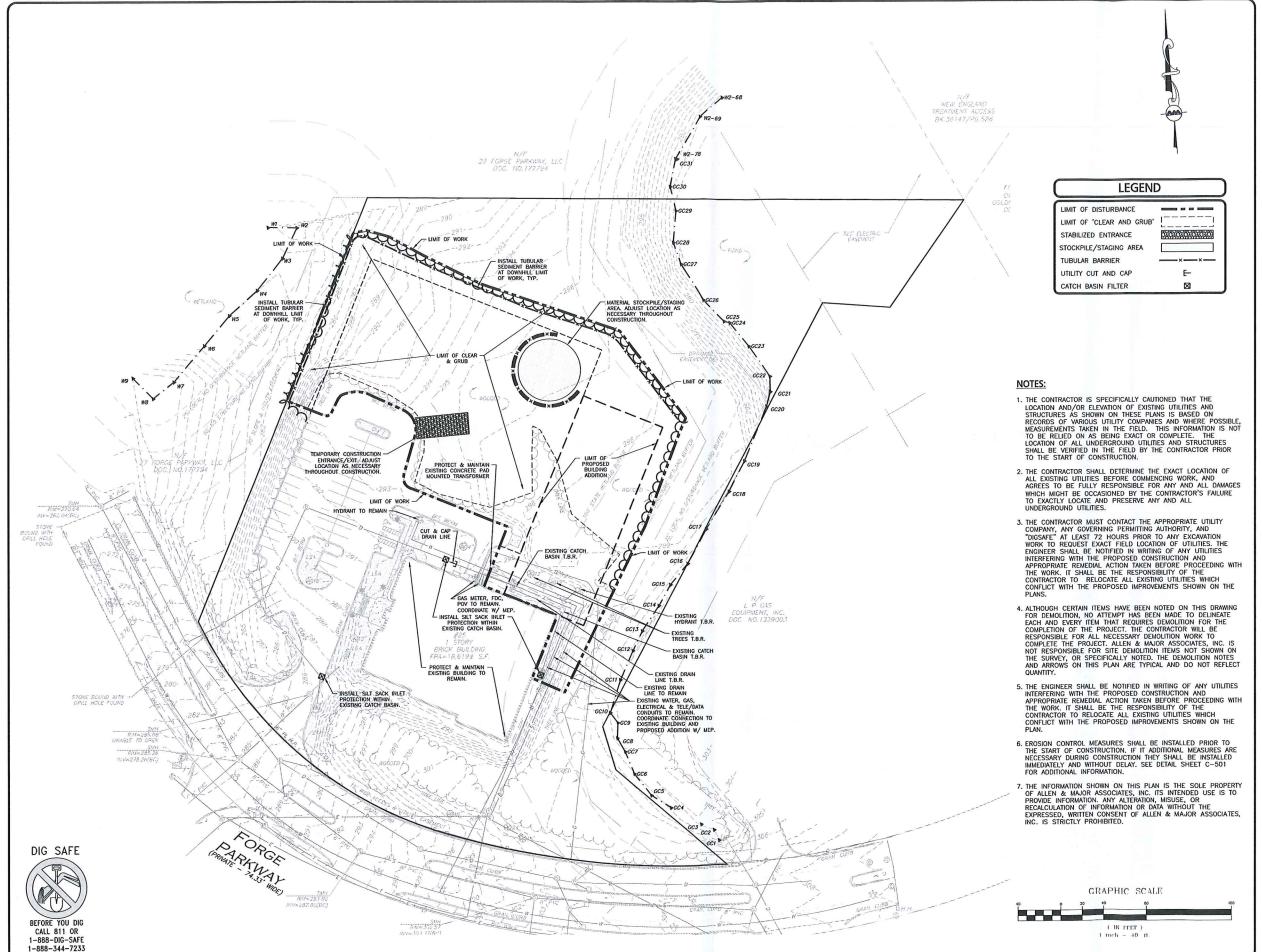



PROFESSIONAL ENGINEER FOR ALLEN & MAJOR ASSOCIATES, INC.

REV	DATE	DESCRIPTION	
APPLICAN	IT\OWNER.	·	

TMC HOLDINGS & DEVELOPMENT 2, LLC 24 WILLIAM WAY BELLINGHAM, MA 02019

25 FORGE PARKWAY FRANKLIN, MA

2712-02A DATE: PROJECT NO. 02-21-2 1" = 40' DWG, NAME: C-2712-02 SM/JRG | CHECKED BY: DESIGNED BY:




DBURN, MA . LAKEVILLE, MA . MANCHESTER, N THIS DRAWING HAS BEEN PREPARED IN DIGITAL FORMAT. CLIENT/CLIENT'S ERFESTINTATIVE ON CONSULTANTS MAY BE PROVIDED COPIES OF DRAWINGS AND SPECIFICATIONS FOR HIS/HER INFORMATION AND/OR SPECIFIC USE ON THIS PROJECT. DUE TO THE OTENTIAL THAT THE PROVIDED INFORMATION MAY BE MODIFIED. OTENTIAL THAT THE PROVIDED INFORMATION MAY BE MODIFIED INFORMATION MAY BE MODIFIED INFORMATION MAY BE MODIFIED INFORMATION OF THE DOCUMENT VALUTIONSHIP ON THE DIGITAL MEDIA PRIVINED PRESENTATIONS OF OTHE DRAWNINGS AND STREAM DOCUMENT FORMAT OF THE DRAWNINGS AND STREAM OF THE STREAM OF THE DRAWNINGS AND STREAM OF THE STREAM

C-101

SITE PREPARATION PLAN



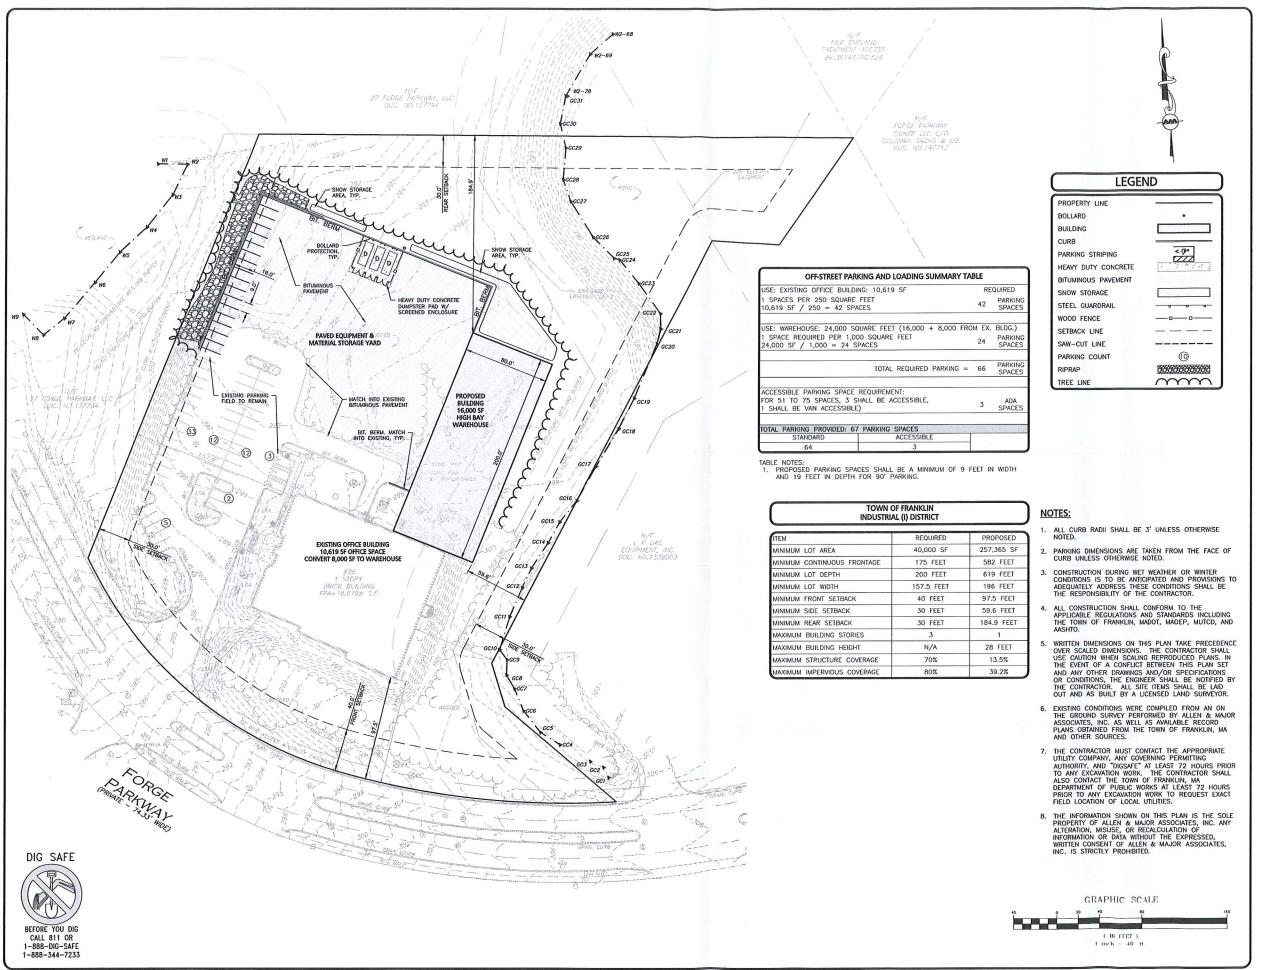



TMC HOLDINGS & DEVELOPMENT 2, LLC 24 WILLIAM WAY BELLINGHAM, MA 02019

25 FORGE PARKWAY FRANKLIN, MA

PROJECT NO.	2712-02A	DATE:	02-21-23
SCALE:	1" = 40'	DWG. NAME:	C-2712-02A
DESIGNED BY:	SM/JRG	CHECKED BY:	BDJ



civil engineering + land surveying onmental consulting + landscape architect w w w . a 1 l e n m a j o r . c o m 100 COMMERCE WAY, SUITE 5

WOBURN MA 01801 TEL: (781) 935-6889 FAX: (781) 935-2896


OBURN, MA . LAKEVILLE, MA . MANCHESTER, N THIS DRAWING HAS BEEN PREPARED IN DIGITAL FORMAT CLIENT/CLIENT'S REPRESENTATIVE OR CONSULTANTS MAY B PROVIDED COPIES OF DRAWINGS AND SPECIFICATIONS FOR HIS/HEI PROVIDED COPIES OF DRAWINGS AND SPECIFICATIONS FOR HIS/HER INFORMATION AND/OR SPECIAL USE ON THIS PROJECT. DUE TO THE POTENTIAL THAT THE PROVIDED INFORMATION MAY BE MODIFIED UNINTERTIONALLY OR OTHERWISE, ELLIEN B MAJOR ASSOCIATES, INC. MAY BEMOVE ALL INDICATION OF THE DOCUMENTS AUTHORSHIP ON THE OSITIAL MEDIA PRIMITED PRESENTATIONS OF PORTABLE DOCUMENT FORMAT OF THE DRAWINGS AND SPECIFICATIONS ISSUED SHALL BE THE ONLY RECORD COPIES OF ALLIEN B MAJOR ASSOCIATES, INC'S WOOK PRODUCT.

DRAWING '	TITLE:
-----------	--------

LAYOUT & MATERIALS PLAN | C-102

Copyright ©2023 Allen & Major Associates, Inc. All Rights Reserved



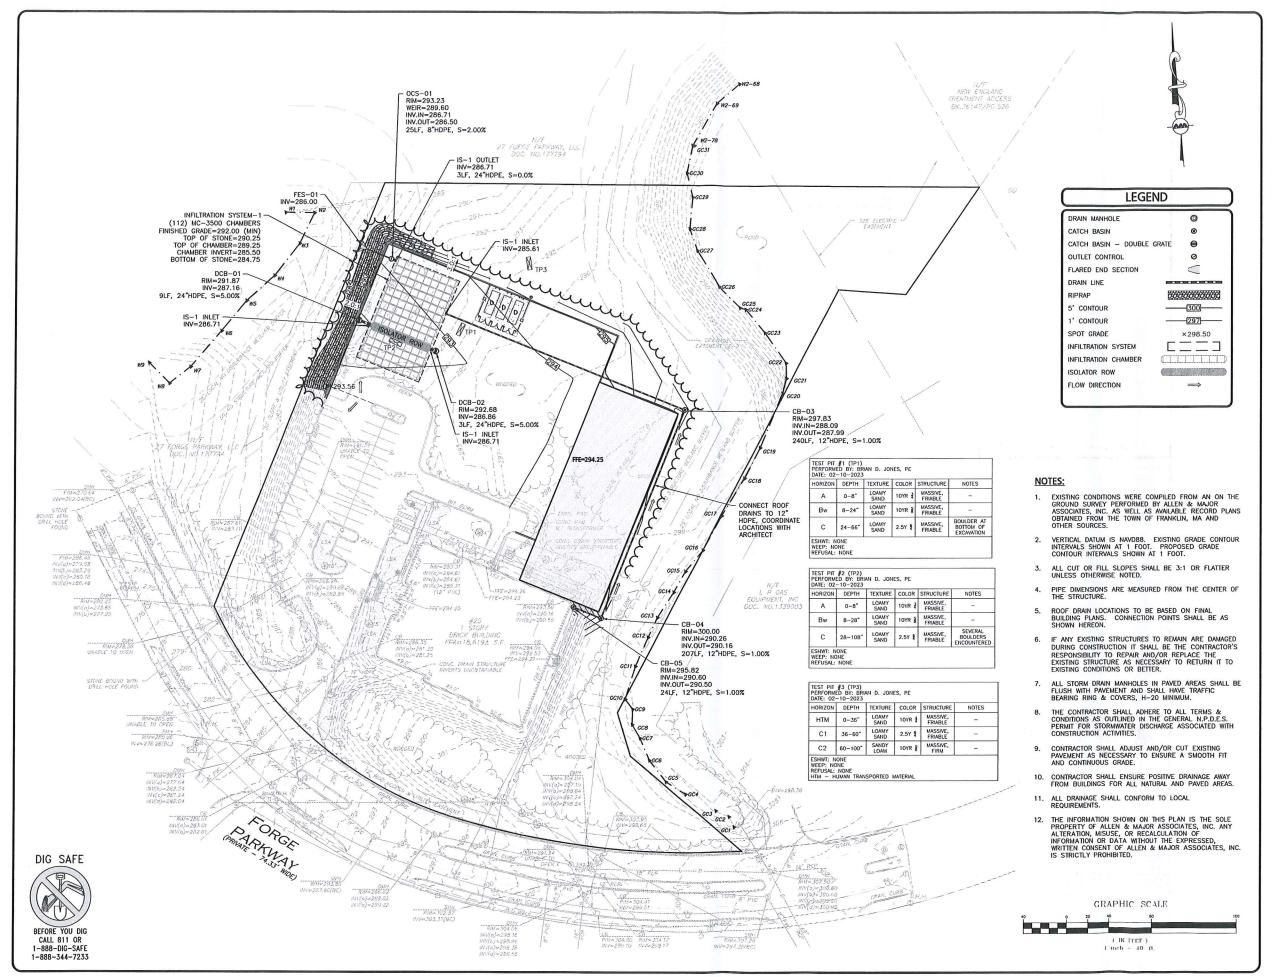



REV DATE DESCRIPTION

TMC HOLDINGS & DEVELOPMENT 2, LLC 24 WILLIAM WAY BELLINGHAM, MA 02019

25 FORGE PARKWAY FRANKLIN, MA

ROJECT NO. 2712-02A DATE: 1" = 40' DWG. NAME: C-2712-024 ESIGNED BY: SM/JRG CHECKED BY:



civil engineering • land surveying onmental consulting • landscape archite www.allenmajor.com

100 COMMERCE WAY, SUITE 5 WOBURN MA 01801 TEL: (781) 935-6889 FAX: (781) 935-2896


WOBURN, MA & LAKEVILLE, MA & MANCHESTER, NII THIS DRAWING HAS BERN PREPARED IN DIGITAL FORMAT. CLIENT/CLIENT'S REPRESENTATIVE OR CONSULTANTS MAY BE PROVIDED COPIES OF DRAWINGS AND SPECIFICATIONS FOR HIS/HER INFORMATION AND/OR SPECIFIC USE ON THIS PROJECT, DUE TO THE POTENTIAL THAT THE PROVIDED INFORMATION MAY BE MODIFIED UNINITENTIONALLY OR OTHERWISE, ALLEN & MAJOR ASSOCIATES, NIC. MAY REMOVE ALL INDICATION OF THE DOCUMENTS ADTRIBUTED FRESHMATIONS OR SPECIFICATION IS SUBED SHALL BE THE ONLY RECORD COMES OF ALLEN & MAJOR ASSOCIATES, INC.'S WORK PRODUCT.

C-103

BURN, MA . LAKEVILLE, MA . MANCHESTER, NI

GRADING & DRAINAGE PLAN

Copyright ©2023 Allen & Major Associates, Inc. All Rights Reserved

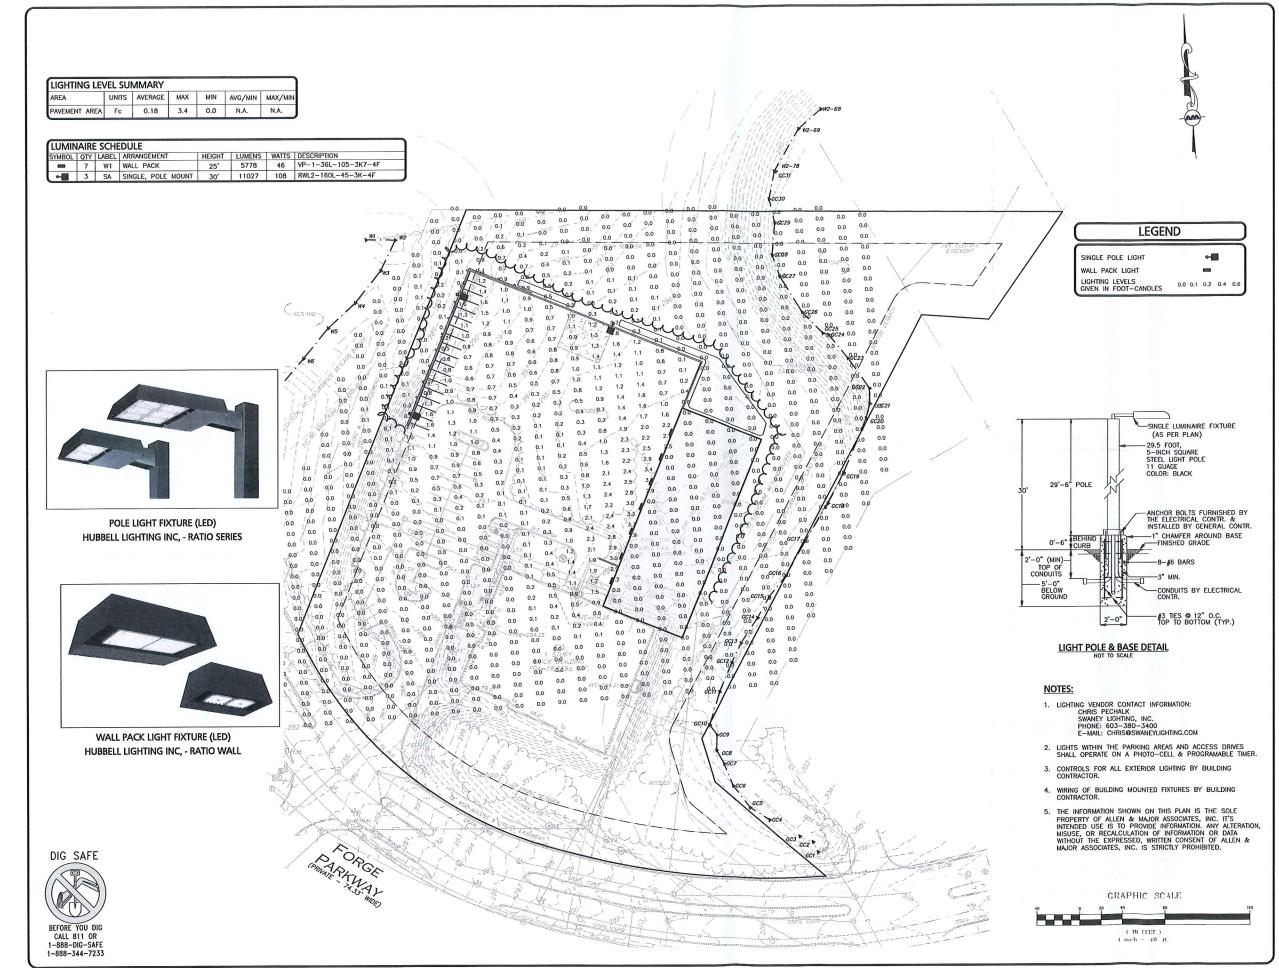



PROFESSIONAL ENGINEER FOR ALLEN & MAJOR ASSOCIATES, INC.

REV DATE DESCRIPTION

TMC HOLDINGS & DEVELOPMENT 2, LLC 24 WILLIAM WAY BELLINGHAM, MA 02019

25 FORGE PARKWAY FRANKLIN, MA

ROJECT NO. 2712-02A DATE: 02-21-2 1" = 40' DWG. NAME: C-2712-02A SM/JRG CHECKED BY: DESIGNED BY:




civil engineering • land surveying ommental consulting • landscape archite www.allenmajor.com
100 COMMERCE WAY, SUITE 5
WOBUEN MA 01801
TEL: (781) 935-6889
FAX: (781) 935-2896

C-104

THIS DRAWING HAS BEEN PREPARED IN DIGITAL FORMAT. CLIENT/CLIENT'S ERESENTATIVE OR CONSULTANTS MAY BE PROVIDED COPIES OF DRAWINGS AND SFECIFICATIONS FOR HIS/HER INFORMATION AND/OR SFECIFIC USE ON THIS PROJECT. DUE TO THE POTENTIAL THAT THE PROVIDED INFORMATION MAY DE MODIFIED UNINTERTIONALLY OR OTHERWISE, ALLEN & MAJOR ASSOCIATES, NIC. MAY REMOVE ALL INDICATION OF THE DOCUMENT AUTHORSHIP ON THE DIGITAL MEDIA, PRINTED REPRESENTATIONS OR SPECIFICATIONS IS SIZE SHALL BE HE ONLY RECORD COPIES OF ALLEN & MOOR ASSOCIATES, ALLEN & MAJOR ASSOCIATES, ALLEN & MOOR CONTROLLED SHALL BE HE ONLY RECORD COPIES OF ALLEN & MOOR SECOND COPIES OF ALLEN & MAJOR ASSOCIATES, INC'S WORK PRODUCT.


LIGHTING PLAN

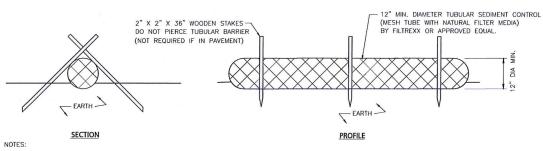


1. ALL MATERIALS TO MEET MANUFACTURERS SPECIFICATIONS.

- 2. INSTALL WOODEN STAKES IN A CRISS-CROSS PATTERN EVERY 8' ON CENTER.
- 2. OVERLAP TUBULAR BARRIER SEGMENTS A MINIMUM OF 12".
- THE CONTRACTOR SHALL MAINTAIN THE TUBULAR BARRIERS IN A FUNCTIONAL CONDITION AT ALL TIMES. THE CONTROLS SHALL BE ROUTINELY INSPECTED BY THE CONTRACTOR.
- 4. WHERE THE TUBULAR BARRIERS REQUIRE REPAIR OR SEDIMENT REMOVAL, IT WILL BE COMPLETED BY THE CONTRACTOR AT NO ADDITIONAL COST.
- 5. AT A MINIMUM, THE CONTRACTOR SHALL REMOVE SEDIMENTS COLLECTED AT THE BASE WHEN THEY REACH 1/3 THE EXPOSED HEIGHT OF THE BARRIER.

TUBULAR SEDIMENT BARRIER NOT TO SCALE

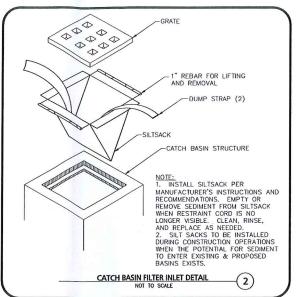

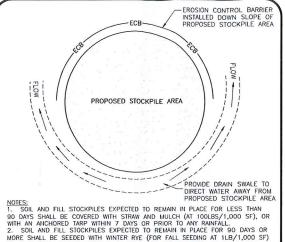

NOTES:

1. SOIL AND FILL STOCKPILES EXPECTED TO REMAIN IN PLACE, FOR LESS THAN 90 DAYS SHALL BE COVERED WITH STRAW AND MULCH (AT 1001BS/1,000 SF), OR WITH AN ANCHORED TARP WITHIN 7 DAYS OR PRIOR TO ANY RAINFALL.

2. SOIL AND FILL STOCKPILES EXPECTED TO REMAIN IN PLACE FOR 90 DAYS OR MORE SHALL BE SEEDED WITH WINTER RYE (FOR FALL SEEDING AT 1LB/1,000 SF) OR OATS (FOR SUMMER SEEDING AT 2LB/1,000 SF) AND THEN COVERED WITH STRAW MULCH (AT 1001B/1,000 SF) OR AN ANCHORED TARP WITHIN 7 DAYS OR PRIOR TO ANY RAINFALL.


STOCKPILE PROTECTION DETAIL


NOT TO SCALE

-(3)

DIVERSION RIDGE REQUIRED WHERE GRADE EXCEEDS 2% -2% OR GREATER ROADWAY NOTES:

1. THE ENTRANCE SHALL BE MAINTAINED IN A CONDITION THAT WILL PREVENT TRACKING OR FLOWING OF SEDIMENT ONTO PUBLIC RIGHT-OF-WAYS. THIS MAY REQUIRE TOP SECTION A STRAWBALE OR SAND BAGS. SPILLWAY OR CONTINUOUS BERM OF EQUIVALENT HEIGHT DRESSING, REPAIR AND/OR CLEANOUT OF ANY MEASURES USED TO TRAP SEDIMENT. WHEELS (IF NECESSARY 2. WHEN NECESSARY, WHEELS SHALL BE CLEANED PRIOR TO ENTERING THE PUBLIC RIGHT-OF-WAY 3. WHEN WASHING IS REQUIRED, IT SHALL BE DONE ON AN AREA STABILIZED WITH CRUSHED STONE THAT DRAINS INTO AN APPROVED SEDIMENT TRAP OR SEDIMENT BASIN. 2"-3" COURSE AGGREGATE MIN OF 6" THICK 12' (MIN.) 4. USE SANDBAGS, STRAW BALES, OR OTHER APPROVED METHODS TO CHANNELIZE RUNOFF TO BASIN AS REQUIRED. DIVERSION RIDGE TEMPORARY CONSTRUCTION ENTRANCE
NOT TO SCALE -(4)

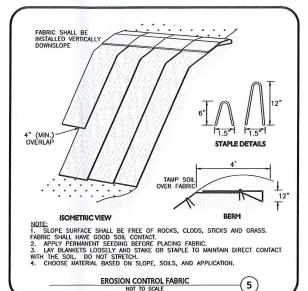


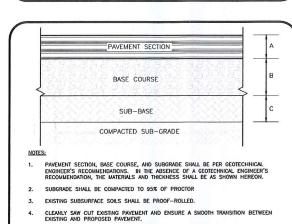



MATERIALS AND THICKNESSES:


B = 6" PROCESSED GRAVEL BASE (MHD M2.01.7)

ASPHALT PAVEMENT SECTION
NOT TO SCALE (6)

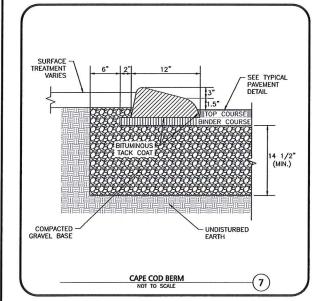

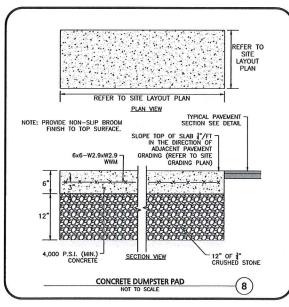

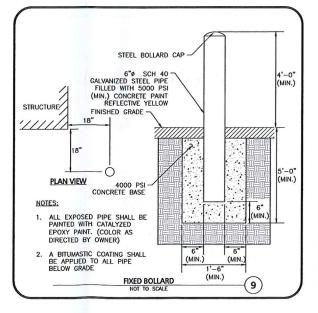

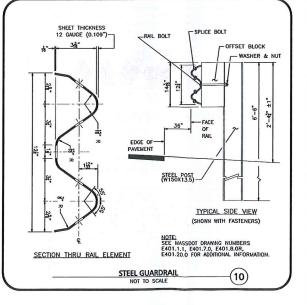



REV DATE DESCRIPTION PPLICANT\OWNER

TMC HOLDINGS & DEVELOPMENT 2, LLC 24 WILLIAM WAY BELLINGHAM, MA 02019

25 FORGE PARKWAY FRANKLIN, MA

PROJECT NO. 2712-02A DATE: AS SHOWN DWG. NAME: C-2712-024 DESIGNED BY SM/JRG CHECKED BY:



civil engineering + land surveying
.nmental consulting + landscape architec
www.allenmajor.com

100 COMMERCE WAY, SUITE 5 WOBURN MA 01801 TEL: (781) 935-6889 FAX: (781) 935-2896

DBURN, MA . LAKEVILLE, MA . MANCHESTER, NI HIS DRAWING HAS BEEN PREPARED IN DIGITAL FORMAT. LIENT/CLIENT'S REPRESENTATIVE OR CONSULTANTS MAY BE ROVIDED COPIES OF DRAWINGS AND SPECIFICATIONS FOR HIS/HER NOVIDED COPIES OF DRAWNIGS AND SPECIFICATIONS FOR HIS/HER FIGWALATION AND/OR SECIRIC USE ON THIS PROJECT, DUE TO THE TIENTIAL THAT THE PROVIDED INFORMATION MAY BE MODIFIED MINITERITIONALLY OR OTHERWISE, ALIEN & MAJOR ASSOCIATES, IC. MAY REMOVE ALL INDICATION OF THE DOCUMENT'S UNITHOSHIP OF THE DIGITAL MEDIA PRINTED REPRESENTATIONS OF DOTRIABLE DOCUMENT FORMAT OF THE DRAWNIKS AND PECIFICATIONS ISSUED SHALL BE THE ONLY RECORD COPIES OF LIEN & MAJOR ASSOCIATES, INC.'S WORK PRODUCT.

Copyright ©2023 Allen & Major Associates, Inc.
All Rights Reserved

DETAILS

C-501

	MATERIAL LOCATION	DESCRIPTION	AASHTO MATERIAL CLASSIFICATIONS	COMPACTION / DENSITY REQUIREMENT
D	FINAL FILL: FILL MATERIAL FOR LAYER 'D' STARTS RROM THE TOP OF THE 'C' LAYER TO THE BOTTOM OF FLEXIBLE PAVEMENT OR UNPAVED FINISHED GRADE ABOVE. NOTE THAT PAVEMENT SUBBASE MAY BE PART OF THE 'D' LAYER	ANY SOIL/ROCK MATERIALS, NATIVE SOILS, OR PER ENGINEER'S PLANS. CHECK PLANS FOR PAVEMENT SUBGRADE REQUIREMENTS.	N/A	PREPARE PER SITE DESIGN ENGINEER'S PLANS.
С	INITIAL FILL: FILL MATERIAL FOR LAYER 'C' STARTS FROM THE TOP OF THE EMBEDMENT STONE ('B' LAYER) TO 24" (600 mm) ABOVE THE TOP OF THE CHAMBER. NOTE THAT PAVEMENT SUBBASE MAY BE A PART OF THE 'C' LAYER.	GRANULAR WELL-GRADED SOIL/AGGREGATE MIXTURES, <35% FINES OR PROCESSED AGGREGATE. MOST PAVEMENT SUBBASE MATERIALS CAN BE USED IN LIEU OF THIS LAYER.	AASHTO M145¹ A-1, A-2-4, A-3 OR AASHTO M43¹ 3, 357, 4, 467, 5, 56, 57, 6, 67, 68, 7, 78, 8, 89, 9, 10	BEGIN COMPACTIONS AFTER 24" (600 mm) OF MATERIAL OVER THE CHAMBERS IS REACHED. COMPACT ADDITIONAL LAYERS IN 12" (300 mm) MAX LIFTS TO A MIN. 95% PROCTOR DENSITY FOR WELL GRADET MATERIAL AND 95% RELATIVE DENSITY DENSITY OF PROCESSED AGGREGATE MATERIALS.
В	EMBEDMENT STONE: FILL SURROUNDING THE CHAMBERS FROM THE FOUNDATION STONE ('A' LAYER) TO THE 'C' LAYER ABOVE.	CLEAN, CRUSHED, ANGULAR STONE	AASHTO M431 3, 4	= -
А	FOUNDATION STONE: FILL BELOW CHAMBERS FROM THE SUBGRADE UP TO THE FOOT (BOTTOM) OF THE CHAMBER.	CLEAN, CRUSHED, ANGULAR STONE	AASHTO M43' 3, 4	PLATE COMPACT OR ROLL TO ACHIEVE A FLAT SURFACE. ^{2,3}

- PLEASE NOTE:

 1. THE LISTED ASHTO DESIGNATIONS ARE FOR GRADATIONS ONLY. THE STONE MUST ALSO BE CLEAN, CRUSHED, ANGULAR, FOR EXAMPLE, A SPECIFICATION FOR \$4
 STONE WOULD STATE: "CLEAN, CRUSHED, ANGULAR NO. 4 (AASHTO MAS) STONE".

 2. STONETCH COMPACTION REQUIREMENTS ARE MET FOR "A LOCATION MATERIALS WHEN PLACED AND COMPACTED IN 9" (230 mm) (MAX) LIFTS USING TWO FULL


 3. STONETCH COMPACTION REQUIREMENTS ARE MET FOR "A LOCATION MATERIALS WHEN PLACED AND COMPACTED IN 9" (230 mm) (MAX) LIFTS USING TWO FULL

 3. WHERE INFILITATION SURFACES MAY BE COMPROMISED BY COMPACTION, FOR STRANDARD DESIGN LOAD CONDITIONS, A FLAT SURFACE MAY BE ACHIEVED BY RAKING

 3. WHERE INFILITATION SURFACES MAY BE COMPROMISED BY COMPACTION, FOR STRANDARD DESIGN, CONTACT STORMISCH FOR COMPACTION REQUIREMENTS.

 4. ONCE LIVER "C' IS FLACED, ANY SOIL/MATERIAL CAN BE PLACED IN LAYER "O' UP TO THE FINISHED GRADE, MOST PAYEMENT SUBBASE SOILS CAN BE USED TO

 4. REPLACE THE MATERIAL REQUIREMENTS OF LAYER "C' OR "D' AT THE SITE DESIGN ENGINEERS"S DISCRETION.

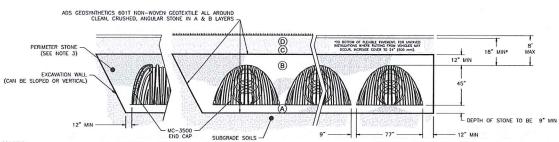

- 1. CHAMBERS SHALL MEET THE REQUIREMENTS OF ASTM F2418, "STANDARD SPECIFICATION FOR POLYPROPYLENE (PP) CORRUGATED WALL STORMWATER COLLECTION CHAMBERS" CHAMBER CLASSIFICATION 45x76 DESIGNATION SS.
- 2. MC-3500 CHAMBERS SHALL BE DESIGNED IN ACCORDANCE WITH ASTM F2787 "STANDARD PRACTICE FOR STRUCTURAL DESIGN OF THERMOPLASTIC CORRUGATED WALL STORMWATER COLLECTION CHAMBERS".
- 3. PERIMETER STONE MUST BE EXTENDED HORIZONTALLY TO THE EXCAVATION WALL FOR BOTH VERTICAL AND SLOPED EXCAVATION WALLS
 4. REQUIREMENTS FOR HANDLING AND INSTALLATION:
- TO MAINTAIN THE WIDTH OF CHAMBERS DURING SHIPPING AND HANDLING, CHAMBERS SHALL HAVE INTEGRAL, INTERLOCKING STACKING LIGS.
 TO ENSURE A SECURE JOINT DURING INSTALLATION AND BACKFILL, THE HEIGHT OF THE CHAMBER JOINT SHALL NOT BE LESS THAN 3D.
 TO ENSURE THE INTEGRITY OF THE ARCH SHAPE DURING INSTALLATION, o) THE ARCH STIFFNESS CONSTANT AS DEFINED IN SECTION 6.2.8 OF ASTM F2418 SHALL BE
- GREATER THAN OR EQUAL TO 500 LBS/FT/%. AND b) TO RESIST CHAMBER DEFORMATION DURING INSTALLATION AT ELEVATED TEMPERATURES (ABOVE 73' F / 23' C), CHAMBERS SHALL BE PRODUCED FROM REFLECTIVE GOLD OR YELLOW COLORS.

MC-3500 - CROSS SECTION DETAIL NOT TO SCALE

MC-3500 STORMTECH CHAMBER SPECIFICATIONS

- 1. CHAMBERS SHALL BE STORMTECH MC-3500.
- 2. CHAMBERS SHALL BE ARCH-SHAPED AND SHALL BE MANUFACTURED FROM VIRGIN, IMPACT-MODIFIED POLYPROPYLENE COPOLYMERS.
- CHAMBERS SHALL MEET THE REQUIREMENTS OF ASTM F2418, "STANDARD SPECIFICATION FOR POLYPROPYLENE (PP) CORRUGATED WALL STORMWATER COLLECTION CHAMBERS" CHAMBER CLASSIFICATION 45x76 DESIGNATION SS.
- THE STRUCTURAL DESIGN OF THE CHAMBERS, THE STRUCTURAL BACKFILL, AND THE INSTALLATION REQUIREMENTS SHALL ENSURE THAT THE LOAD FACTORS SPECIFIED IN THE AMSHTO LERO HE BRIDGE DESIGN SPECIFICATIONS, SECTION 12.12, ARE MET FOR: 1) LONG-DURATION DEAD LOADS AND 2) SHORT-DURATION LIVE LOADS, BASED ON THE AMSHTO DESIGN TRUCK WITH CONSIDERATION FOR IMPACT AND MULTIPLE VEHICLE PRESENCES.
- CHAMBERS SHALL BE DESIGNED, TESTED AND ALLOWABLE LOAD CONFIGURATIONS DETERMINED IN ACCORDANCE WITH ASTM F2787, "STANDARD PRACTICE FOR STRUCTURAL DESIGN TO "THERMOPLASTIC CORRUGATED WALL STORMWATER COLLECTION CHAMBERS". LOAD CONFIGURATIONS SHALL INCLUDE: 1) INSTANTANEOUS (<1 MIN) ASSHTO DESIGN TRUCK LYE LOAD ON MINIMUM COVER 2) MAXIMUM PERMANENT (75—YR) COVER LOAD AND 3) ALLOWABLE COVER WITH PARKED (1—WEEK) ASSHTO DESIGN TRUCK.

- REQUIREMENTS FOR HANDLING AND INSTALLATION:

 TO MAINTAIN THE WIDTH OF CHAMBERS DURING SHIPPING AND HANDLING, CHAMBERS SHALL HAVE INTEGRAL, INTERLOCKING STACKING LUGS.

 TO ENSURE A SECURE JOINT DURING INSTALLATION AND BACKFILL, THE HEIGHT OF THE CHAMBER JOINT SHALL NOT BE LESS THAN 33.

 TO ENSURE THE INTEGRITY OF THE ARCH SHAPE DURING INSTALLATION, a) THE ARCH SHIPPINESS CONSTANT SHALL BE GREATER THAN OR EQUAL TO 450
 LBS/FT/Z. THE ASC IS DEFINED IN SECTION 6.28 OF ASTIN F218. AND b) TO RESIST CHAMBER DEFORMATION DURING INSTALLATION AT ELEVATED
 TEMPERATURES (ABOVE 73' F / 23' C), CHAMBERS SHALL BE PRODUCED FROM REFLICTIVE GOLD OR YELLOW COLORS.
- ONLY CHAMBERS THAT ARE APPROVED BY THE SITE DESIGN ENGINEER WILL BE ALLOWED. UPON REQUEST BY THE SITE DESIGN ENGINEER OR OWNER, THE CHAMBER MANUFACTURIER SHALL SUBMIT A STRUCTURAL EVALUATION FOR APPROVAL BEFORE DELIVERING CHAMBERS TO THE PROJECT SITE AS FOLLOWS:

 1 THE STRUCTURAL EVALUATION SHALL BE SEALED BY A REGISTERED PROFESSIONAL ENGINEER.

 1 THE STRUCTURAL EVALUATION SHALL DE SEALED BY A REGISTERED PROFESSIONAL FORNIER.


 1 THE STRUCTURAL EVALUATION SHALL DE MONISTRATE THAT THE SAFETY FACTORS ARE GREATER THAN OR EQUAL TO 1.95 FOR DEAD LOAD AND 1.75 FOR LIVE LOAD, THE MINISTRUM REQUIRED BY ASTM F2787 AND BY SECTIONS 3 AND 12.12 OF THE ASSHTO LIFT BRIDGE DESIGN SPECIFICATIONS FOR THERMOPILASTIC PIPE.


 1 THE TEST DERIVED CREEP MODULUS AS SPECIFIED IN ASTM F2418 SHALL BE USED FOR PERMANENT DEAD LOAD DESIGN EXCEPT THAT IT SHALL BE THE 75—YEAR MODULUS USED FOR DESIGN.
- 9. CHAMBERS AND END CAPS SHALL BE PRODUCED AT AN ISO 9001 CERTIFIED MANUFACTURING FACILITY.



STORMTECH MC-3500 CHAMBER SYSTEM




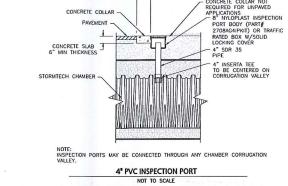

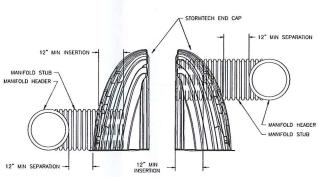


NOTE: MANIFOLD STUB MUST BE LAID HORIZONTAL FOR A PROPER FIT IN END CAP OPENING.

END CAP INSERTION DETAIL NOT TO SCALE

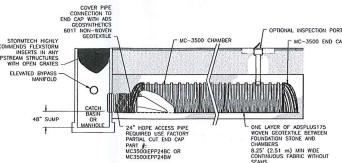

MC-3500 - ISOLATOR ROW PLUS DETAIL

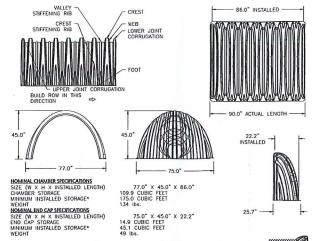

*ASSUMES 12" STONE ABOVE, 9" STONE FOUNDATION, 6" STONE BETWEEN CHAMBERS, 6" STONE PERIMETER IN FRONT OF END CAPS AND 40% STONE

PARTIAL CUT HOLES AT BOTTOM OF END CAP FOR PART NUMBERS ENDING WITH "B" PARTIAL CUT HOLES AT TOP OF END CAP FOR PART NUMBERS ENDING WITH "I" END CAPS WITH A PREFABRICATED WELDED STUB END WITH "W" END CAPS WITH A WELDED CROWN PLATE END WITH "C"

I PARTIAL CUT INVERTIS
MALABLE UPON
TI, INVENTORIED
.DS INICLUDE 12-24"
00 mm) SIZE ON SIZI
-148" (375-1200 mm
RIC MANIFOLO
FINERT LOCATIONS O
-5500 END CAP CUT
FIELD ARE NOT
FIELD ARE NOT
my THE INVERT
N IN COLUMN 'B' ARE
SHEST POSSIBLE FOR
FIEL SIZE.

1

PART#	STUB	В	C
MC3500IEPP06T	6" (150 mm)	33.21" (844 mm)	
MC3500IEPP06B	0 (100 11111)		0.66" (17 mm)
MC3500IEPP08T	8" (200 mm)	31.16" (791 mm)	
MC3500IEPP08B			0.81" (21 mm)
MC3500IEPP10T	10" (250 mm)	29.04" (738 mm)	
MC3500IEPP10B	10 (230 11111)		0.93" (24 mm)
MC3500IEPP12T	12" (300 mm)	26.36" (670 mm)	A CONTRACTOR OF THE PARTY OF TH
MC3500IEPP12B	, , , , , , , , , , , , , , , , , , , ,		1.35" (34 mm)
MC3500IEPP15T	15" (375 mm)	23.39" (594 mm)	
MC3500IEPP15B			1.50" (38 mm)
MC3500IEPP18TC		20.03" (509	
MC3500IEPP18TW	18" (450)	mm)	
MC3500IEPP18BC	18" (450 mm)		1.77" (45 mm)
MC3500IEPP18BW		-	(10 11111)
MC3500IEPP24TC	24" (600 mm) -	14.48" (368	
MC3500IEPP24TW		mm)	
MC3500IEPP24BC			2.06" (52 mm)
MC3500IEPP24BW			2.00 (32 11111)
MC3500IEPP30BC	30" (750 mm)		2.75" (70 mm)

TECHNICAL SPECIFICATIONS NOT TO SCALE

INSPECTION & MAINTENANCE

NOTE: ALL DIMENSIONS ARE NOMINAL

- STEP 1) INSPECT ISOLATOR ROW PLUS FOR SEDIMENT
 A. INSPECTION PORTS (IF PRESENT)
 A.1. REMOVE/OPEN LID ON INTLOPIAST INLINE DRAIN
 A.2. REMOVE AND CLEAN FLEXSTORM FILER IF INSTALLED
 A.3. USING A FLEXFLIGHT AND STADUR ROD, WESSURE DEPTH OF SEDIMENT AND RECORD ON
 MAINTENANCE LOG
 A.1. LOYER A CAMBERN INTO ISOLATOR ROW PLUS FOR VISUAL INSPECTION OF SEDIMENT

 - A.4. LOWER A CAMERA INTO ISOLATOR ROW PLUS FOR VISUAL INSPECTION OF SEDIMENT
 LEVELS (OPPIONAL)

 A.5. IF SEDIMENT IS AT, OR ABOVE, 3" (80 mm) PROCEED TO STEP 2. IF NOT, PROCEED TO
 STEP 3.

 B. ALL ISOLATOR PLUS ROWS

 B.1. REMOVE COVER FROM SIRUCTURE AT UPSTREAM END OF ISOLATOR ROW PLUS
 B.2. USING A FLASHILDENT, INSPECT DOWN THE ISOLATOR ROW PLUS THROUGH OUTLET PIPE
 1) MIRRORS ON POLES OR CAMERAS IMAY BE USED TO AWORD A CONFINED SPACE ENTRY
 1) FOLLOW OSHA REGULATIONS FOR COMFINED SPACE ENTRY IF ENTERNING MANHOLE

 B.3. IF SEDIMENT IS AT, OR ABOVE, 3" (80 mm) PROCEED TO STEP 2. IF NOT, PROCEED TO
 STEP 3.
- STEP 2) CLEAN OUT ISOLATOR ROW PLUS USING THE JETVAC PROCESS

 A. A FIXED CLIVERT CLEANING NOZZLE WITH REAR FACING SPREAD OF 45° (1.1 m) OR MORE IS PREFERRED

 B. APPLY MULTIPLE PASSES OF JETVAC UNTIL BACKFLUSH WATER IS CLEAN
 C. VACUUM STRUCTURE SUMP AS REQUIRED

- STEP 3) REPLACE ALL COVERS, GRATES, FILTERS, AND LIDS; RECORD OBSERVATIONS AND ACTIONS.
- STEP 4) INSPECT AND CLEAN BASINS AND MANHOLES UPSTREAM OF THE STORMTECH SYSTEM.

- INSPECT EVERY 6 MONTHS DURING THE FIRST YEAR OF OPERATION. ADJUST THE INSPECTION INTERVAL BASED ON PREVIOUS OBSERVATIONS OF SEDIMENT ACCUMULATION AND HIGH WATER ELEVATIONS.
- CONDUCT JETTING AND VACTORING ANNUALLY OR WHEN INSPECTION SHOWS THAT MAINTENANCE IS NECESSARY.

PROFESSIONAL ENGINEER FOR ALLEN & MAJOR ASSOCIATES, INC.

REV DATE DESCRIPTION APPLICANT\OWNER:

TMC HOLDINGS & DEVELOPMENT 2, LLC 24 WILLIAM WAY BELLINGHAM, MA 02019

25 FORGE PARKWAY FRANKLIN, MA

2712-02A DATE: 02-21-2 PROJECT NO. AS SHOWN DWG, NAME: C-2712-02/ SM/JRG | CHECKED BY:



civil engineering + land surveying ronmental consulting + landscape architet w w w . a l l e n m a j o r . c o m 100 COMMERGE WAY, SUITE 5 WOBURN MA 01801 TEL: (781) 935-6889 FAX: (781) 935-2896


VOBURN, MA . LAKEVILLE, MA . MANCHESTER, N THIS DRAWING HAS BEEN PREPARED IN DIGITAL FORMAT.
CLIENT/CLIENT'S REPESENTATIVE OR CONSULTANTS MAY BE
PROVIDED COPIES OF DRAWINGS AND SPECIFICATIONS FOR HIS/HER
INFORMATION AND/OR SPECIFIC USE ON THIS PROJECT. DUE TO THE
POTENTIAL THAT THE PROVIDED INFORMATION MAY BE MODIFIED
UNINTERTIONALLY OR OTHERWISE, ALLEN & MAJOR ASSOCIATES,
INC. MAY REMOVE ALL INDICATION OF THE DOCUMENT'S
AUTHORSHIP ON THE DIGITAL MEDIA PRINTED REPRESENTATIONS OR
PORTIALE DOCUMENT FORMATION OF THE DIGITAL MEDIA PROVINCES AND
STAGEL OF THE DIGITAL MEDIA PRINTED REPRESENTATIONS OR
ALLEN & MAJOR ASSOCIATES, INC.'S WORK PRODUCT,


DRAWING TITLE

DETAILS

C-502




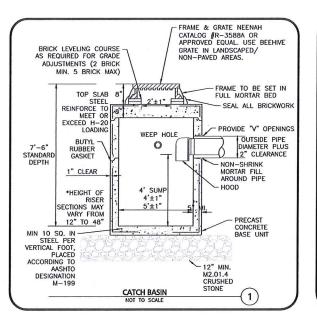


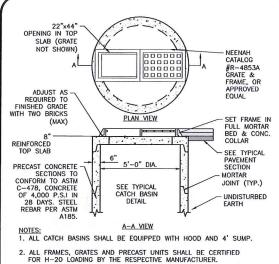


DOUBLE GRATE CATCH BASIN

(2)

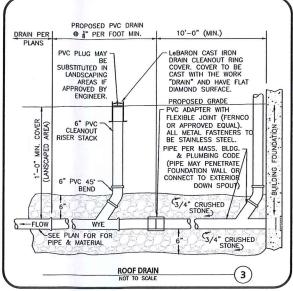

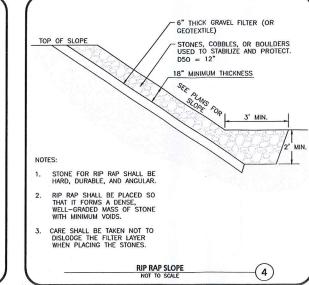

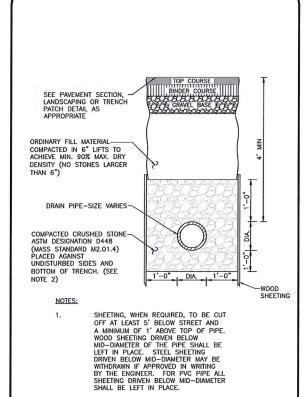

WHEN APPROVED BY THE ENGINEER FOR PIPES OTHER THAN PVC, SELECTED GRAVEL FILL MATERIAL MAY BE USED FROM MID-DIAMETER OF PIPE


BE USED FROM MID-DIAMETER OF PIPE TO 12" ABOVE TOP OF PIPE. NO STONES LARGER THAN 2" IN ANY DIMENSION WILL BE PERMITTED IN THIS AREA — MASSDOT MATERIAL STANDARD M1.03.0 TYPE C.


PROVIDE AT LEAST ONE IMPERVIOUS DAM IN GRAVEL BEDDING BETWEEN EACH MANHOLE WHERE DIRECTED, OR EVERY 300 FT, WHICHEVER IS LESS.


BEDDING MATERIAL FOR PVC PIPE SHALL MEET THE REQUIREMENTS OF ASTM D2321 CLASS I OR CLASS II EMBEDMENT MATERIALS.


DRAINAGE TRENCH

(5)

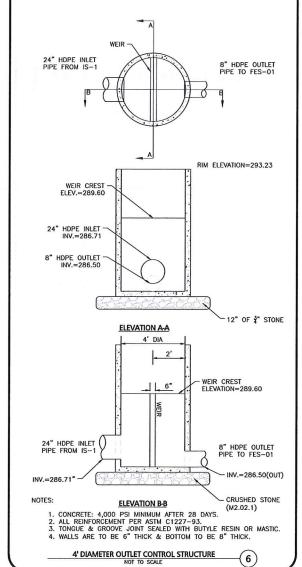

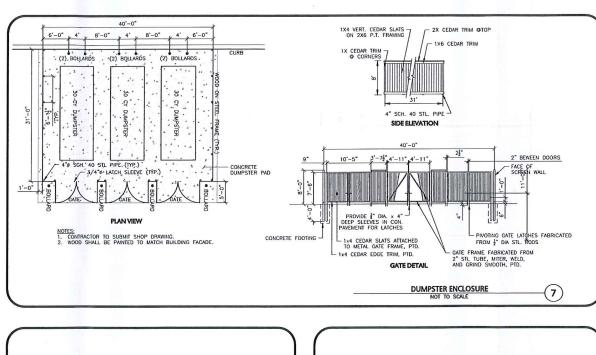

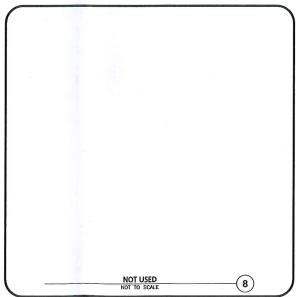

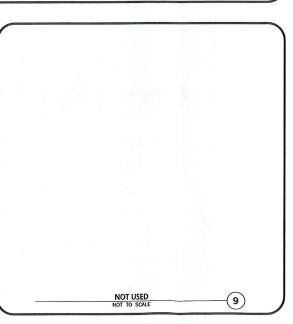



REV DATE DESCRIPTION

TMC HOLDINGS & DEVELOPMENT 2, LLC 24 WILLIAM WAY BELLINGHAM, MA 02019

25 FORGE PARKWAY FRANKLIN, MA

PROJECT NO. 2712-02A DATE: 02-21-23 DWG. NAME: C-2712-02A DESIGNED BY: SM/JRG | CHECKED BY:



civil engineering + land surveying
onmental consulting + landscape architect
www.allenmajor.com
100 COMMERCE WAY, SUITE 5
WOBURN MA 01801
TEL: (781) 935-8889
FAX: (781) 935-8896

BURN, MA . LAKEVILLE, MA . MANCHESTER, NI

THIS DRAWING HAS BEEN PREPARED IN DIGITAL FORMAT. LUENT/CLIENT'S REPRESENTATIVE OR CONSULTANTS MAY BE CLIENT/CLIENT'S REPRESENTATIVE OR CONSULTANTS MAY BE REPROVIDED CORIS OF PRANINGS AND SECCIFICATIONS FOR HIS/HER INFORMATION AND/OR SPECIFIC USE ON THIS PROJECT. DUE TO THE POTENTIAL THAT THE PROVIDED INFORMATION MAY BE MODIFIED UNINTENTIONALLY OR OTHERWISE, ALLEN & MAJOR ASSOCIATES, NC. MAY REMOVE ALL INDICATION OF THE DOCUMENT'S AUTHORSHIP ON THE DIGITAL MEDIA, PRINTED REPRESENTATIONS OR PORTABLE DOCUMENT FORMAT OF THE DRAWNINGS AND PORTABLE DOCUMENT FORMAT OF THE DRAWNINGS AND PALLEN AND/OR ASSOCIATES, INCS WORK PRODUCT.

RAWING TITLE

C-503

DETAILS