PROPOSED SITE PLAN DOCUMENTS

_____ FOR _____


NEXTGRID MESCALBEAN LLC


PROPOSED SOLAR FARM


LOCATION OF SITE:

237-36-37, 237-36, E 239-010, PORTION OF D 239-010

160 MAPLE STREET, TOWN OF BELLINGHAM & FRANKLIN
NORFOLK COUNTY, MASSACHUSETTS
LOTS INCLUDED (PARCEL #): 239-009, F 239-010, G 239-010, H 239-010, I 239-010, 239-012,

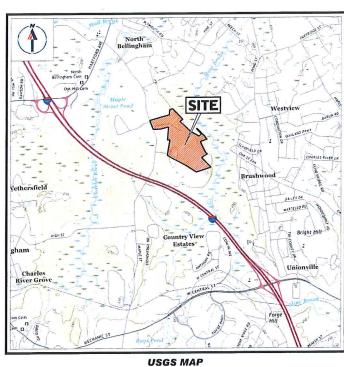

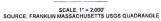

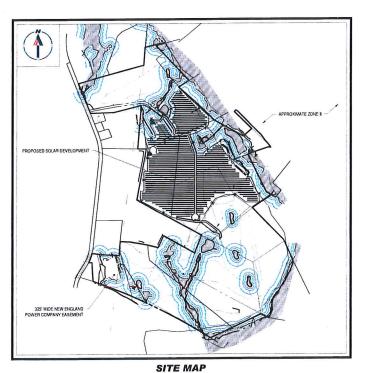

SCALE: 1" = 600' SOURCE: GOOGLE AERIAL

PREPARED BY

REFERENCES

EXISTING CONDITIONS SURVEY: FELDMAN GEOSPATAL 152 HAMPDEN STREET, BOSTON, MA DATE: 05/09/2022

ANR SURVEY: FELDMAN GEOSPATIAL 152 HAMPDEN STREET, BOSTON. DATE: 08/05/2022

 THE ABOVE REFERENCED DOCUMENTS ARE INCORPORATED BY REFERENCE AS PART OF THES PLANS, HOWEVER, BOHLER ENGINEERING DOES IN CERTIFY THE ACCURACY OF THE WORK REFERENCE OR DESIRED EROW THESE DOCUMENTS BY OTHER

DRAWING SHEET INDEX

OVERALL EROSION & SEDIMENT CONTROL PLAN C-601

EROSION & SEDIMENT CONTROL PLAN (A - F)
EROSION & SEDIMENT CONTROL NOTES &
DETAILS

C-101

C-102

C-201 C-202 - C-207

C-301

C-401 C-402 - C-407

C-302 - C-307

C-602 - C-607

C-608 - C-609

C-901 - C-907

SHEET TITLE

COVER SHEET

GENERAL NOTES SHEET

DEMOLITION PLAN (A-F)

SITE LAYOUT PLAN (A - F)

GRADING PLAN (A - F)

DETAIL SHEETS

SITE CIVIL AND CONSULTING ENGINERRING LAND SURVEYING PROGRAM MANAGEMENT SUSTANDARD E DESIGN FEMILIA SERVICES FRANSPORTES IN TRANSPORTATION SERVICES

REVISIONS						
REV	DATE	COMMENT	DECIE			
			-			
			-			
			-			
			-			
			-			
			-			
-			_			



ISSUED FOR MUNICIPAL & AGENCY REVIEW & APPROVAL

REMEWAND APPROVAL. IT IS	FOR MUNICIPAL AND OR AGENCY NOT INTENDED AS A CONSTRUCTION IS NOICATED OTHERWISE.
PROJECT No.:	W201257
DRAWN BY:	EVD / CMC / OCR
CHECKED BY:	GD
DATE:	04/13/2023
CAD LD.:	W201257-SPPD-0A

PROJECT:

PROPOSED SITE PLAN DOCUMENTS

NEXTGRID MESCALBEAN LLC

PROPOSED

LOTS INCLUDED (PARCEL #):239-009, F 239-010, G 239-010, H 239-010, I 239-010 239-012, 237-36-37, 237-36, E 239-010, PORTION OF D 239-010160 MAPLE

STREET,
TOWN OF BELLINGHAM & FRANKLIN,
NORFOLK COUNTY, MASSACHUSETTS



ww RohlerFnaineerina com



SHEET TITLE

COVER SHEET

C-101

GENERAL NOTES

GENERAL DEMOLITION NOTES

- ADUITION (AND/OR REMOVALS) PLANTS INTENDED TO PROVIDE GENERAL INFORMATION AND TO IDENTIFY ONLY CONDITIONS REGARDING ITEMS TO BE SHED REMOVED, AND/OR TO REMAN CONTRACTOR WUST ALSO REVIEW ALL CONSTRUCTION DOCUMENTS AND INCLUDE WITHIN THE DEMOLITION ACTIVITIES ALL INCIDENTAL WORK SEARMY FOR THE CONSTRUCTION OF THE NEW SHE WIRKNOWEWINS

- THE CONTRACTOR IS RESPONSIBLE FOR JOB STE SAFETY WHICH MAST INCLUDE BY TEACH LINETED TO THE INSTALLA FEX.TAXL OTHER APPROPRIATE ANONE RECESSARY SAFETY FOR THE SAFETY BY THE SAFETY OF RECESSARY TO REPORT THE DESCRIPTION OF THE THE THE SAFETY OF THE SAFETY

- TO COMMENCING ANY DENOLITION THE CONTRACTOR MUST.

 TO COMMENCING ANY DENOLITION THE CONTRACTOR MUST.

 THAN ALK REQUIRED PERMITS AND MUNITARY THE SMALED IS STEED FOR REVIEW BY THE ENGINEER AND ALK PURBLE AGENCIES WITH JARISDICTION

 THAN ALK REQUIRED THE WAS ARRESTED AS THE SMALED AND DENOLITION MORK.

 THE COMMENCEMENT OF MORK.

 THE COMMENCEMENT OF MORK.

 THAN ALK REQUIRED SOCIETION FOR SEEDING TO CONTROL WAS URBESTRION TO SITE DISTURBANCE. AND MUNITARY SAD CONTROLS UNTIL SITE IS

- CONTRACTOR SHALL LOCATE ANY EXISTING UTILITY SERVICES THAT ARE TO BE TERMINATED AT THE EXISTING MAIN AND/OR PROPERTY LINE. THESE SERVICES
 ARE TO BE TERMINATED IN ACCORDANCE WITH MUNICIPAL I STATE TRANSPORTATION DEPARTMENT REQUIREMENTS.

GENERAL SITE NOTES

- 2. CONTRACTOR IS CAUTIONED OF EXISTING UTILITY SERVICES TO REMAIN IN PROXIMITY TO PROPOSED BOLLARDS AND SIGNS. CONTRACTOR SWALL PROVIDE FIELD 21. GAS WETERS MUST BE PROTECTED AS REDURED BY THE JURISDICTIONAL GAS PROVIDER. MODIFICATION LOCATIONS OF BOLLARDS MUST BOLLARDS MITH SIGNACE AS RECEIVED TO AVOID CONFLICTS WITH EXISTING UTILITY SERVICES TO REMAIN.

GENERAL GRADING NOTES

- PROPOSED TOP OF CURB ELEVATIONS ARE GENERALLY 6" ABOVE PAVENENT GRADE UNLESS OTHE

- CONTRACTOR SHALL INSTALL CONCRETE CURB ALONG FACE OF BUILDING / WALL AS SHOWN TO PROVIDE CONSISTENT WIDTH ALON ACCESSBILE RAMP AND RAWP LANDING TO MEET ADVAAB REQUIREVENTS.
- CONTRACTOR SHALL REVIEW RETAINING WALL LOCATIONS VERSUS APPLICABLE STATE AND LOCAL CODES AND PROVIDE FALL PROTECTION (E.G. FENCING O RAILING) IN ACCORDANCE WITH SAID CODE
- EEFORE COMMINISTING GRADING WORK, CONTRACTOR SHALL SUBWIT SAMPLES OF ALL NATIVE AND IMPORTED MATERIALS WITH THEIR INTENDED FOR STRUCTURAL USES TO THE GEOTECHNICAL ENGINEER OF RECORD.

GENERAL DRAINAGE & UTILITY NOTES

- LICOPTIONS OF MEDITIES AND PROPOSESS SERVICES ARE APPRODUCED. AND THE CONTRACTOR WITT RODERSORTLY YERRY AND CONFIRM TROSE LOCATIONS AND SERVICES AND FROM LITER OF COMPANIES FROM TO CONVENCION ANY CONSTRUCTION OF SECAMION IN THE CONTRACTOR MEDITIES RODERSORTLY YERRY AND CONFIRM ALL SMATRAY CONNECTION FROM TAND ALL OTHER WITHIN'S SERVICE CONNECTION FROM TS IN THE FIELD, PRICE TO COMPRICING ANY CONSTRUCTION. THE CONTRACTOR MUST REPORT ALL DICERPORACES SERVICES SERVICES AND OWNSSIONS IN WIRMS OF THE PRICE FROM TS.

- FINAL LOCATIONS OF PROPOSED UTILITY POLES, AND/ OR POLES TO BE RELOCATED ARE AT THE SOLE DISCRETION OF THE RES REGIARDLESS OF WHAT THIS PLAY DEPICTS.

- OF ANY BOALDS, GUT MADE, VICTORIES WIRES (I.C. AS WILL BE SEPARATED FROM WATER MANS BY A DISTANCE OF AT LEAST 10 FEET HORIZ SUCH LATERAL SEPARATIONS IN OT POSSIBLE. THE PPES MUST, AT A MANUAL BEHI SEPARATE TRIBOCHES WITH THE AT LEAST 18 NOWES OF VERTI SEPARATION FROM THE EOTTOM OF THE WATER MUNT OF THE OF OF THE SERVER LINE, WHERE PROPORTIALE SEPARATION FROM A WATER TO POSSIBLE. THE SERVER MUST BE ENLASED IN CONCRETE, OR CONSTRUCTED OF DUTTLE BODY PIPE USING MECHANICAL OR SULPOUL ADMITS FOR A D AT LEAST 10 FEET ON BITHER SIDE OF THE CORSISSION IN ADMITS OF THE OFFICE OF SERVER PIPE SHOULD BE LOCATED SO BOTH ON SITH OF FROM THE WATER LINE AS POSSIBLE WHERE A WITER MAIN CROSSES MADER A SAMITANT SERVER AUGUST OF STRUCTURE AND THE OFFI SEVERAL MUST BE FROMOTION.

ABBREVIATIONS

KEY	DESCRIPTION	PROPERTY LINE
ARCH	ARCHITECT	ADJACENT PROPER
BC	BACK OF CURB	LINE
BM	BENCHMARK	RIGHT-OF-WAY LINE
BOC	BOTTOM OF CURB	Month of this colo
BW	BOTTOM OF WALL	SETBACK OR BUFFE
BLDG	BUILDING	GET IN CONTROL TO
CONC.	CONCRETE	EASEMENT LINE
DEC.	DECORATIVE	Discussive and
DEC.	DEGREE	WETLAND BOUNDAR
DEP	DEPRESSED	TIE TO THE COURT
	DIAMETER	WETLAND BUFFER
Ø / DIA DMH	DRAIN MANHOLE	WEILANDBOFFER
	DUCTILE IRON PIPE	WATER WAY BOUND
DIP EOP	EDGE OF PAVEMENT	TIATER TIAT BOOKS
		WATERWAY BUFFER
ELEV	ELEVATION	VIATERVIAT BOTT DE
EXIST.	EXISTING	WETLAND OR
FF	FINISH FLOOR	WATERWAY FLAG
FFE	FINISH FLOOR ELEVATION	RIGHT-OF-WAY CEN
GC	GENERAL CONTRACTOR	OR BASE LINE
GRT	GRATE	APPROX. LIMIT OF V
HDPE	HIGH DENSITY POLYETHYLENE PIPE	OR DISTURBANCE
HP	HIGH POINT	
INT	INTERSECTION	APPROX. SAWCUT L
INV	INVERT	and the same of the same of
LS.A.	LANDSCAPE AREA	TREE LINE
LOD	LIMIT OF DISTURBANCE	SURFACE OR
LOW	LIMIT OF WORK	SUBSURFACE BASIN
LF	LINEAR FOOT / FEET	
LP	LOW POINT	OVERHEAD WIRES
MAX	MAXIMUM	
MEP	MECHANICAL, ELECTRICAL,	CURBING
	PLUMBING	
ME	MEET OR MATCH EXISTING	FENCE OR RAILING
MIN	MINIMUM	FEIRCE ON RALLING
No. / #	NUMBER	
±	PLUS OR MINUS	RETAINING WALL
PC	POINT OF CURVATURE	
PI	POINT OF INTERSECTION	CONTOURS
PT	POINT OF TANGENCY	
PVI	POINT OF VERTICAL INTERSECTION	SWALE
PVC	POLYVINYL CHLORIDE PIPE	
PROP.	PROPOSED	BERM
R	RADIUS OR RADII	
RCP	REINFORCED CONCRETE PIPE	RIDGE
R.O.W.	RIGHT-OF-WAY	
SAN	SANITARY	DRAIN PIPE
SMH	SEWER MANHOLE	
5	SLOPE	SEWER PIPE
SF	SQUARE FOOT	_
STA	STATION	SEWER FORCE MAJ
STM	STORM	
TBR	TO BE REMOVED	ELECTRIC
TBR/R	TO BE REMOVED AND REPLACED	
TC	TOP OF CURB	TELECOMMUNICAT
TW	TOP OF WALL	S
TPF	TREE PROTECTION FENCE	CABLE TV
TYP.	TYPICAL	

TYPICAL LINE TYPE LEGEND

	EXISTING	
PROPERTY LINE	PROPOSED	
ADJACENT PROPERTY	EXISTING	
INE	PROPOSED	
	EXISTING	
RIGHT-OF-WAY LINE	PROPOSED	
	EXISTING	
SETBACK OR BUFFER	PROPOSED	
	EXISTING	
EASEMENT LINE		
	PROPOSED	
WETLAND BOUNDARY	EXISTING	
IL ID TO COO IN THE	PROPOSED	
WETLAND BUFFER	EXISTING	
WE I LAND BUFFER	PROPOSED	
	EXISTING	
WATER WAY BOUNDARY	PROPOSED	
	EXISTING	
WATERWAY BUFFER	PROPOSED	
	EXISTING	
WETLAND OR WATERWAY FLAG	PROPOSED	
RIGHT-OF-WAY CENTER	EXISTING	
OR BASE LINE	PROPOSED	
APPROX. LIMIT OF WORK	EXISTING	
OR DISTURBANCE	PROPOSED	
	EXISTING	
APPROX. SAWCUT LINE	PROPOSED	
	EXISTING	1 1 2 12 21 17 18 XXXXX
TREE LINE	PROPOSED	
SURFACE OR	EXISTING	
SUBSURFACE BASIN	PROPOSED	
SUBSURFACE BASIN		
OVERHEAD WIRES	EXISTING	—— OH—— OH—— OH—
	PROPOSED	— OH OH
CURBING	EXISTING	
CONBINO	PROPOSED	CONCERT WONDLITHE SLOPED IVERTIGIAN TRANSPON CAPI
	EXISTING	
FENCE OR RAILING	PROPOSED	andrew statement markets
		DUMANK STOCKES MENU
	EXISTING	
RETAINING WALL		THE RESIDENCE OF THE PERSON NAMED IN COLUMN 1
RETAINING WALL	PROPOSED	THE RESERVE TO A SECOND
**************************************	EXISTING	

CONTOURS	EXISTING PROPOSED EXISTING	
CONTOURS	EXISTING PROPOSED EXISTING	
CONTOURS	EXISTING PROPOSED	
CONTOURS	EXISTING PROPOSED EXISTING PROPOSED EXISTING	
CONTOURS SWALE BERM	EXISTING PROPOSED EXISTING PROPOSED EXISTING PROPOSED	<u>a</u> <u>a</u> <u>a</u>
CONTOURS SWALE BERM	EXISTING PROPOSED EXISTING PROPOSED EXISTING PROPOSED EXISTING EXISTING	<u>a</u> <u>a</u> <u>a</u>
CONTOURS SWALE BERM	EXISTING PROPOSED EXISTING PROPOSED EXISTING PROPOSED EXISTING PROPOSED	<u>a</u> <u>a</u> <u>a</u>
CONTOURS SWALE BERM RIDGE	EXISTING PROPOSED EXISTING PROPOSED EXISTING PROPOSED EXISTING PROPOSED EXISTING PROPOSED EXISTING	<u>u</u> <u>u</u> <u>u</u> <u>u</u>
CONTOURS SWALE BERM RIDGE DRAIN FIPE	EXISTING PROPOSED EXISTING PROPOSED EXISTING PROPOSED EXISTING PROPOSED EXISTING PROPOSED EXISTING PROPOSED	<u>u</u> <u>u</u> <u>u</u> <u>u</u>
CONTOURS SWALE BERM RIDGE DRAIN FIPE	EXISTING PROPOSED EXISTING PROPOSED EXISTING PROPOSED EXISTING PROPOSED EXISTING PROPOSED EXISTING PROPOSED EXISTING EXISTING EXISTING EXISTING EXISTING EXISTING	
CONTOURS SWALE BERM RIDGE DRAIN FIPE	EXISTING PROPOSED	<u>u</u> <u>u</u> <u>u</u> <u>u</u>
CONTOURS SWALE BERM RICGE DRAIN FIPE SEWER PIPE	EXISTING PROPOSED EXISTING	
CONTOURS SWALE BERM RICGE DRAIN FIPE SEWER PIPE	EXISTING PROPOSED	
CONTOURS SWALE BERM RIDGE DRAIN PIPE SEWER PIPE SEWER FORCE MAIN	EXISTING PROPOSED EXISTING	
CONTOURS SWALE BERM RIDGE DRAIN PIPE SEWER PIPE SEWER FORCE MAIN	EXISTING PROPOSED	
CONTOURS SWALE BERM RIDGE DRAIN PIPE SEWER PIPE SEWER FORCE MAIN ELECTRIC	EXISTING PROPOSED EXISTING	5 - SL - FM - FM - FM
CONTOURS SWALE BERM RIDGE ORAIN FIPE SEWER PIPE SEWER FORCE MAIN ELECTRIC	EXISTING PROPOSED EXISTING	5 - 5L - FM - FM
CONTOURS SWALE BERM RIDGE ORAIN FIPE SEWER PIPE SEWER FORCE MAIN ELECTRIC	EXISTING PROPOSED	
CONTOURS SWALE BERM BIDGE DRAIN FIPE SEWER PIPE SEWER FORCE MAIN ELECTRIC	EXISTING PROPOSED EXISTING	5 - SL - FM - FM
CONTOURS SWALE BERM BIDGE DRAIN FIPE SEWER PIPE SEWER FORCE MAIN ELECTRIC	EXISTING PROPOSED EXIST	S - SL - FU - FU - E - E - E - E - E - E - E - E - E -
CONTOURS SWALE BERM PRIDGE DRAIN FIPE SEWER PIPE SEWER FORCE MAIN ELECTRIC TELECOMPUNICATION SCASLE IV	EXISTING PROPOSED EXISTING EXI	S SL FU FU FU C C C C
CONTOURS SWALE BERM PRIDGE DRAIN FIPE SEWER PIPE SEWER FORCE MAIN ELECTRIC TELECOMPUNICATION SCASLE IV	EXISTING PROPOSED	5 - SL - FM - FM
CONTOURS SWALE BERM RIDGE ORAN FIPE SEWER PIPE SEWER PORCE MAIN ELECTRIC TELECOMMUNICATION CASLE TV GAS	EXISTING PROPOSED EXISTING EXISTING PROPOSED EXISTING	S SL FU FU FU C C C C C
CONTOURS SWALE BERM RIDGE DRAIN PIPE SEWER PIPE SEWER FORCE MAIN ELECTRIC	EXISTING PROPOSED	S SL FU FU FU C C C C
CONTOURS SWALE BERM RIDGE ORAN FIPE SEWER PIPE SEWER PORCE MAIN ELECTRIC TELECOMMUNICATION CASLE TV GAS	EXISTING PROPOSED EXISTING EXISTING PROPOSED EXISTING	S SL FU FU FU C C C C C

REVISIONS COMMENT



ISSUED FOR MUNICIPAL & AGENCY REVIEW & APPROVAL

04/13/20 W201257-SPPD

PROPOSED SITE PLAN DOCUMENTS

NEXTGRID

MESCALBEAN LLC

OTS INCLUDED (PARCEL #):239-009, 239-010, G 239-010, H 239-010, I 239-01 239-012, 237-36-37, 237-36, E 239-010 PORTION OF D 239-010160 MAPLE STREET.




w.BohlerEngineering.com



REFER TO SITE LAYOUT PLAN FOR **GENERAL** ZONING ANALYSIS TABLE AND LAND **NOTES SHEET USE | ZONING INFORMATION & NOTES**

REFER TO EROSION AND SEDIMENT **CONTROL NOTES & DETAILS SHEET** FOR TYPICAL EROSION NOTES AND DETAILS

C-102

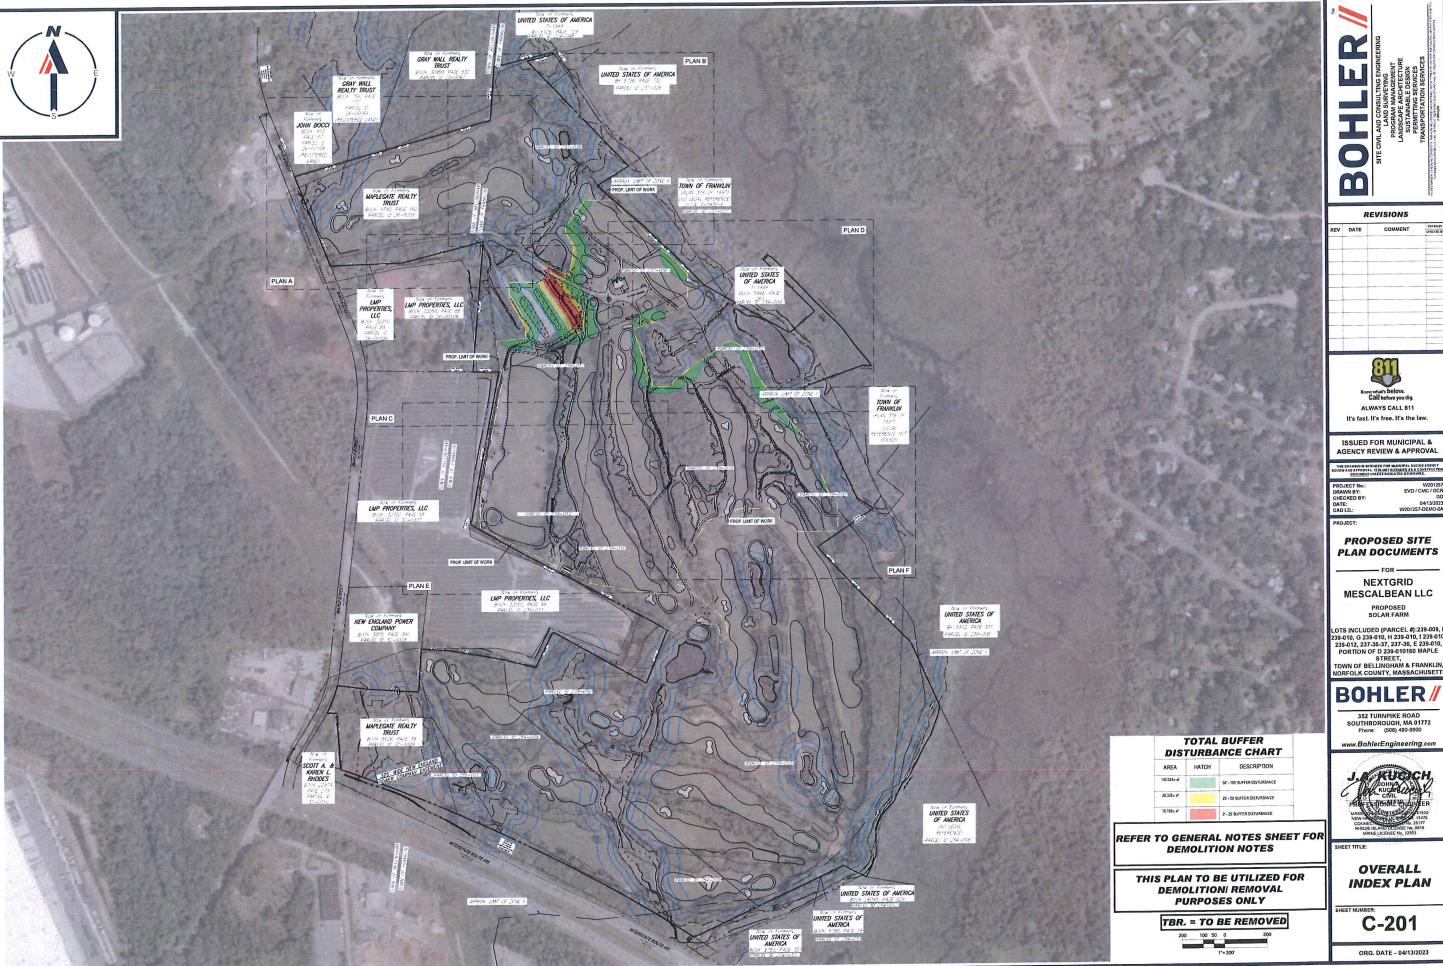

	REVISIONS					
REV	DATE	COMMENT	CHECKED BY			
			-			
-						
			-			



ALWAYS CALL 811

ISSUED FOR MUNICIPAL & AGENCY REVIEW & APPROVAL

PROPOSED SITE

NEXTGRID MESCALBEAN LLC

BOHLER/





OVERALL INDEX PLAN








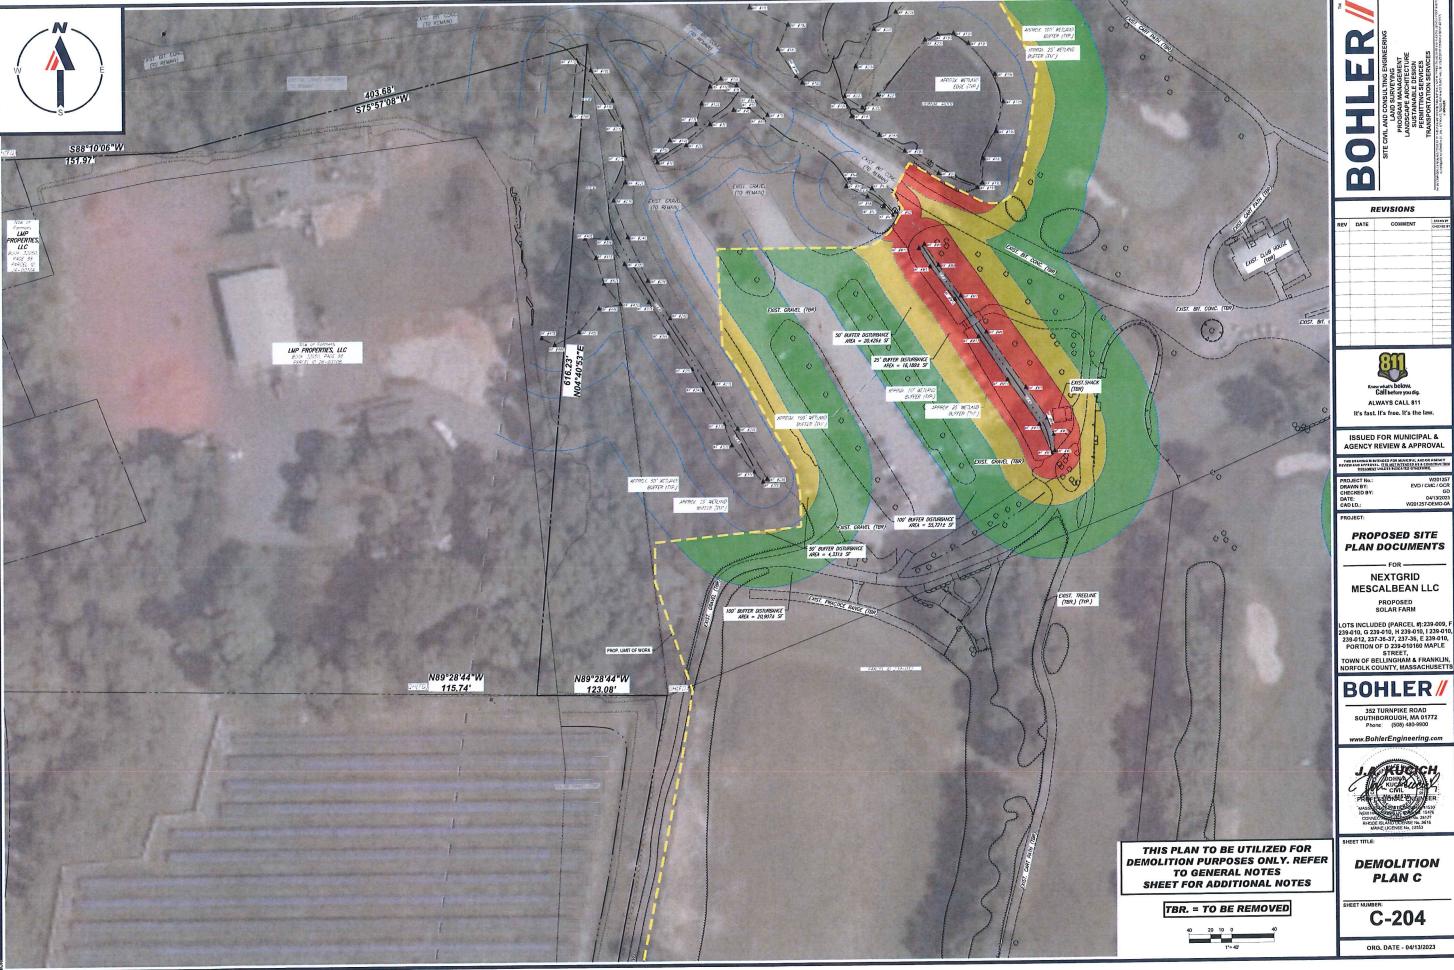


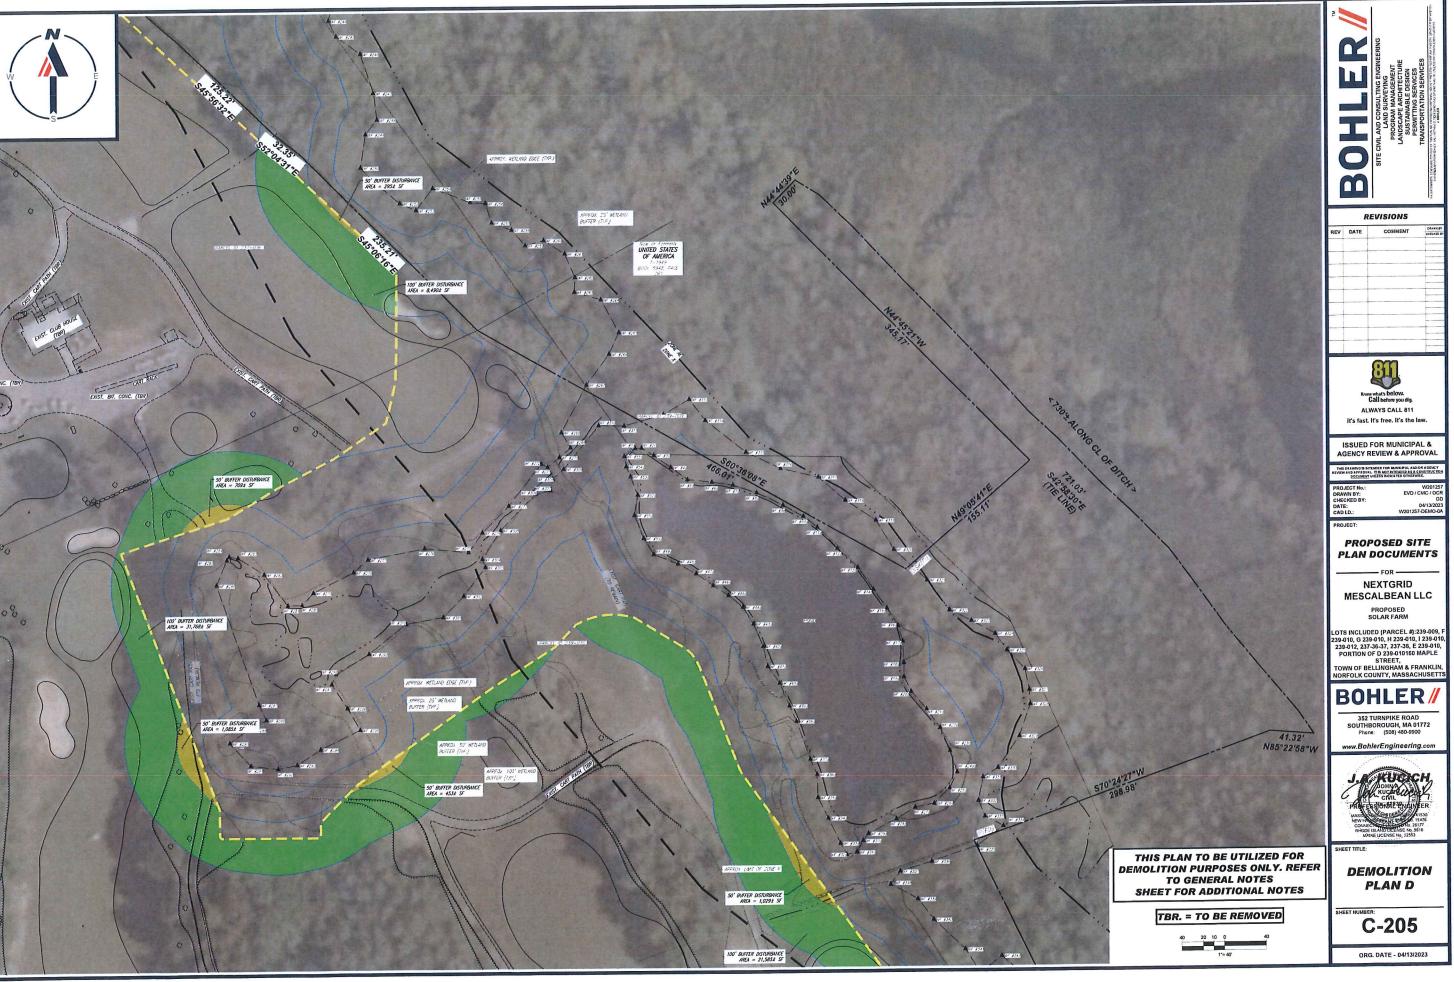






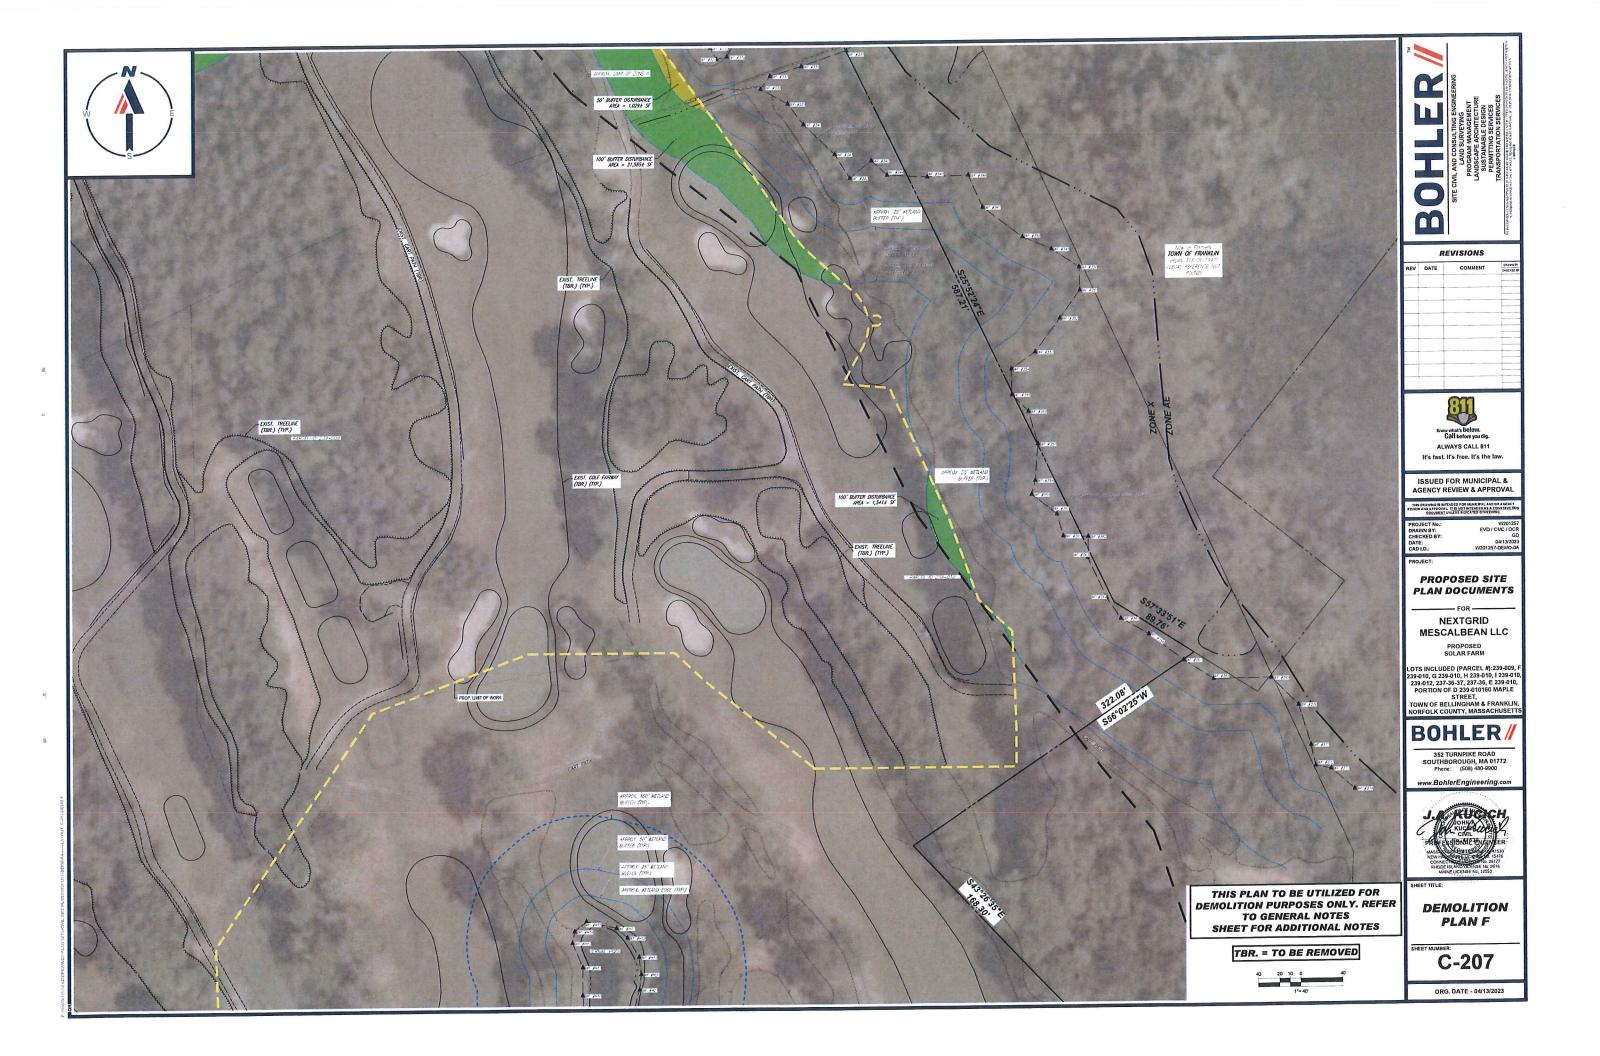

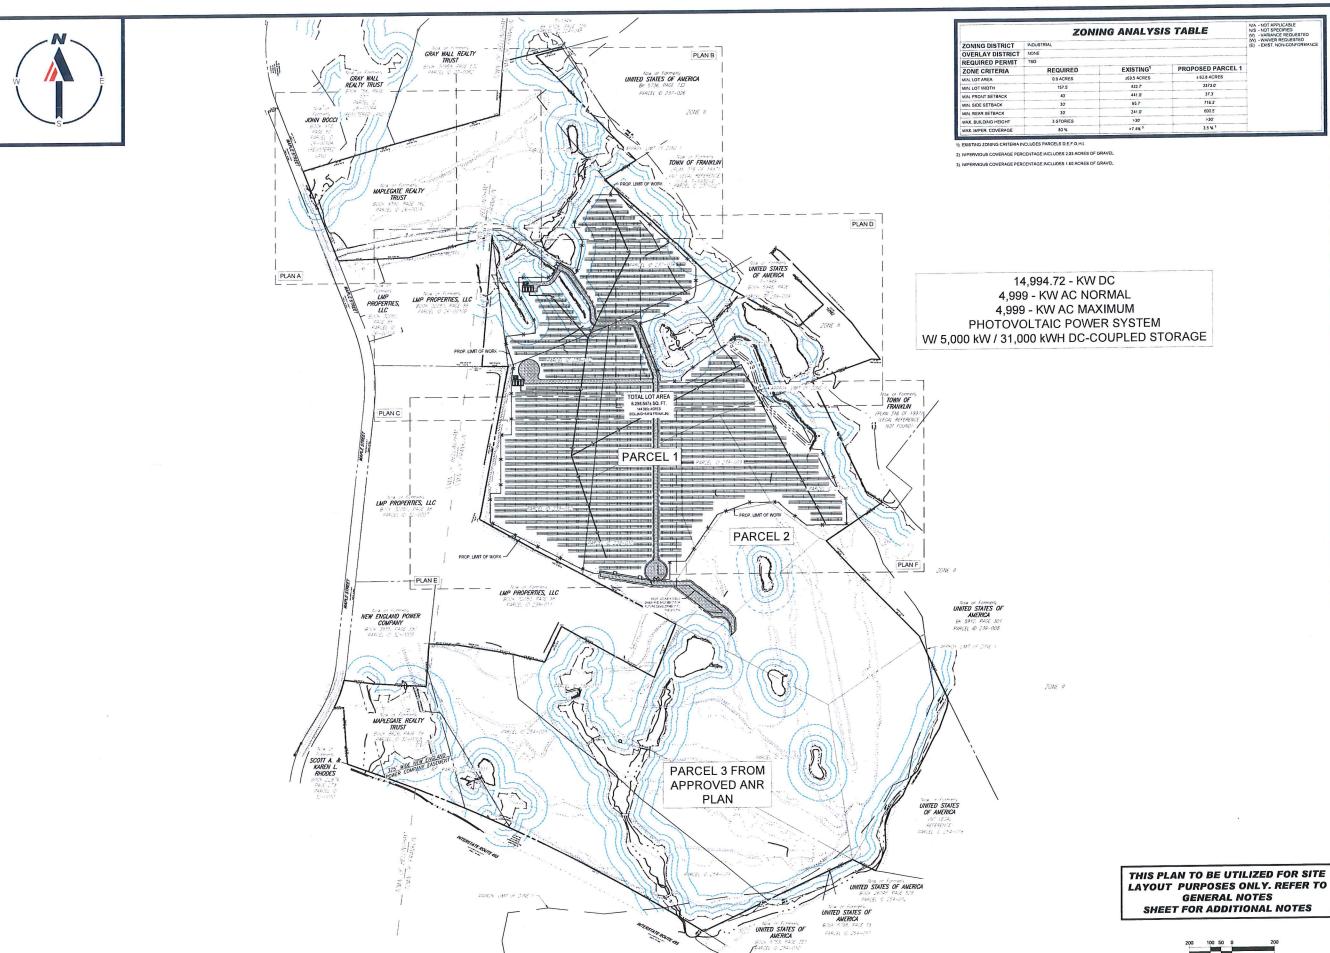

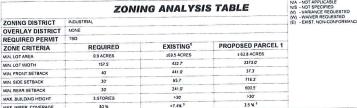

REVISIONS REV DATE COMMENT



ISSUED FOR MUNICIPAL &
AGENCY REVIEW & APPROVAL

PROPOSED SITE **PLAN DOCUMENTS**

NEXTGRID MESCALBEAN LLC

LOTS INCLUDED (PARCEL #):239-009, F 239-010, G 239-010, H 239-010, I 239-010 239-012, 237-36-37, 237-36, E 239-010, PORTION OF D 239-011060 MAPLE STREET, TOWN OF BELLINGHAM & FRANKLIN, NORFOLK COUNTY, MASSACHUSETTS

BOHLER


352 TURNPIKE ROAD SOUTHBOROUGH, MA 01772 Phone: (508) 480-9900


www.BohlerEngineering.com





OVERALL SITE LAYOUT **PLAN**


C-301

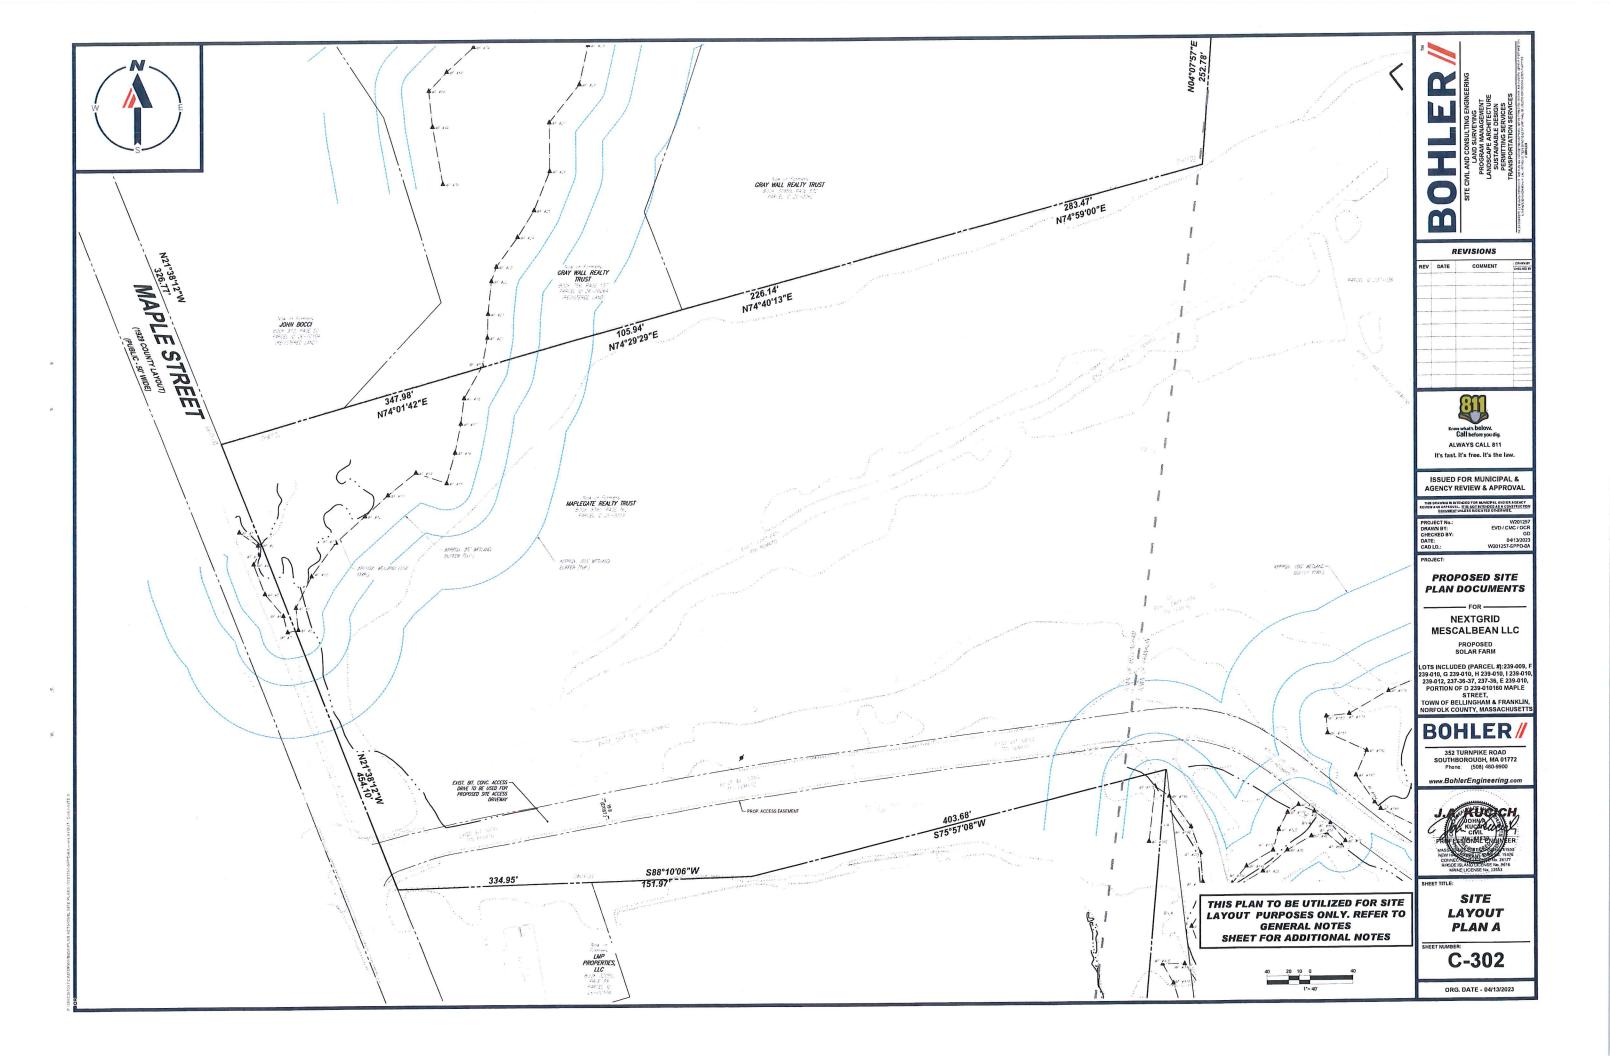


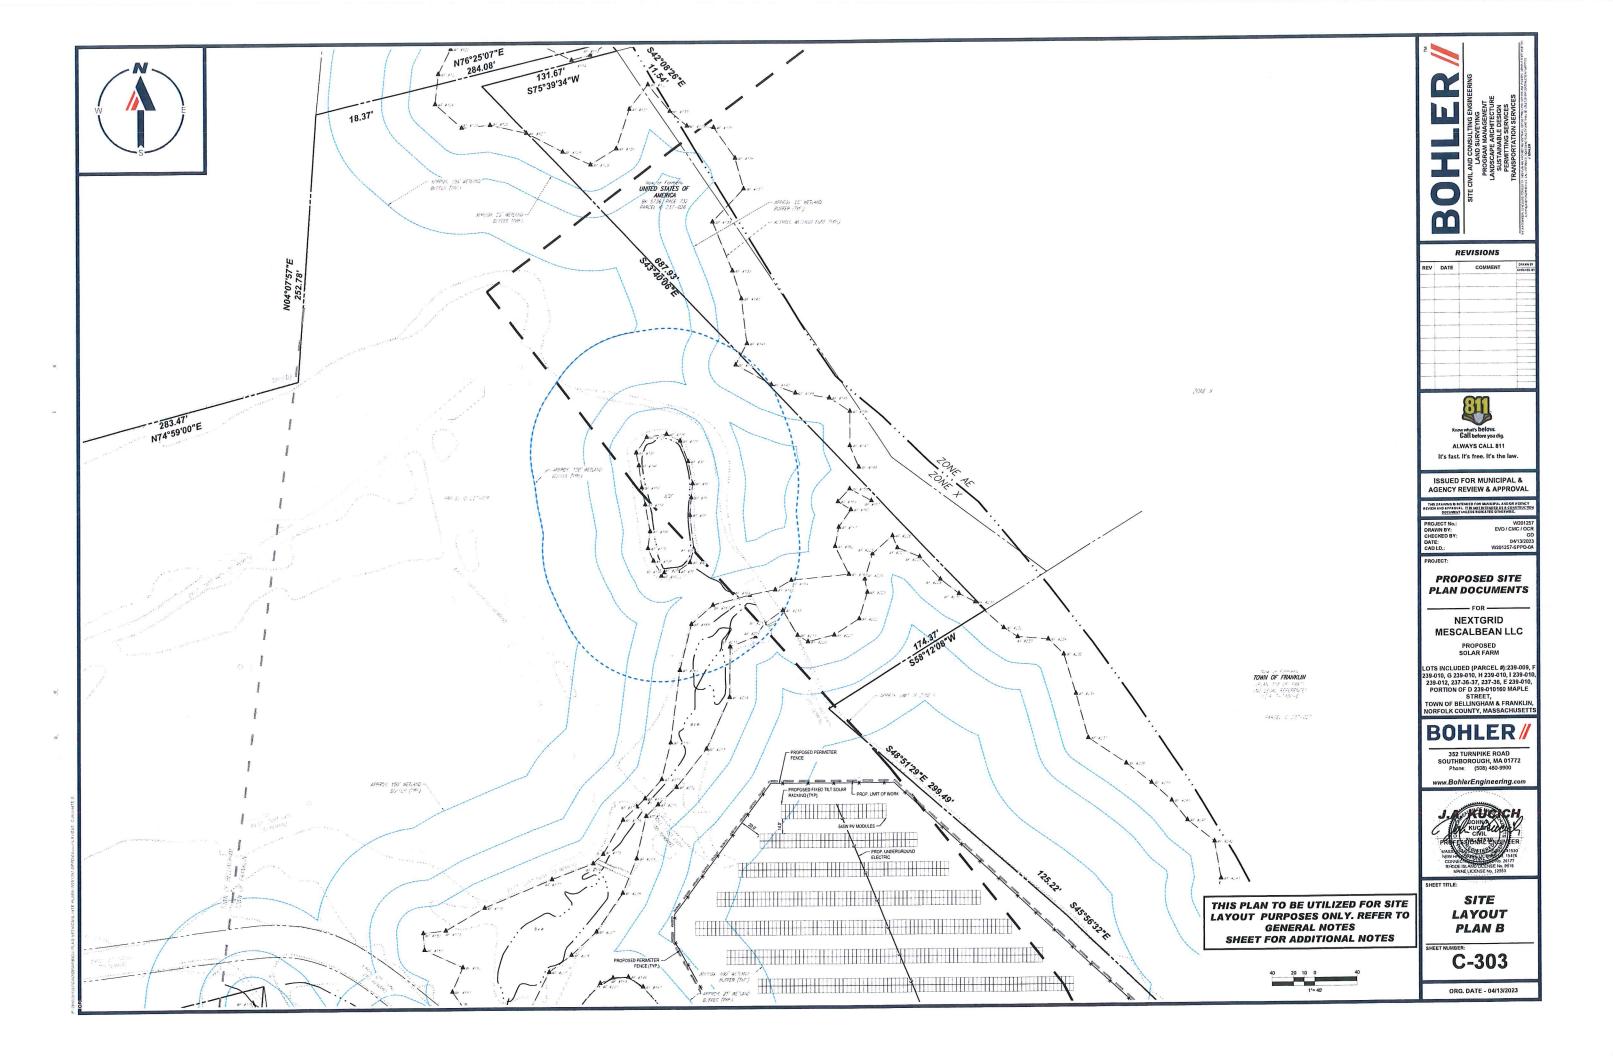

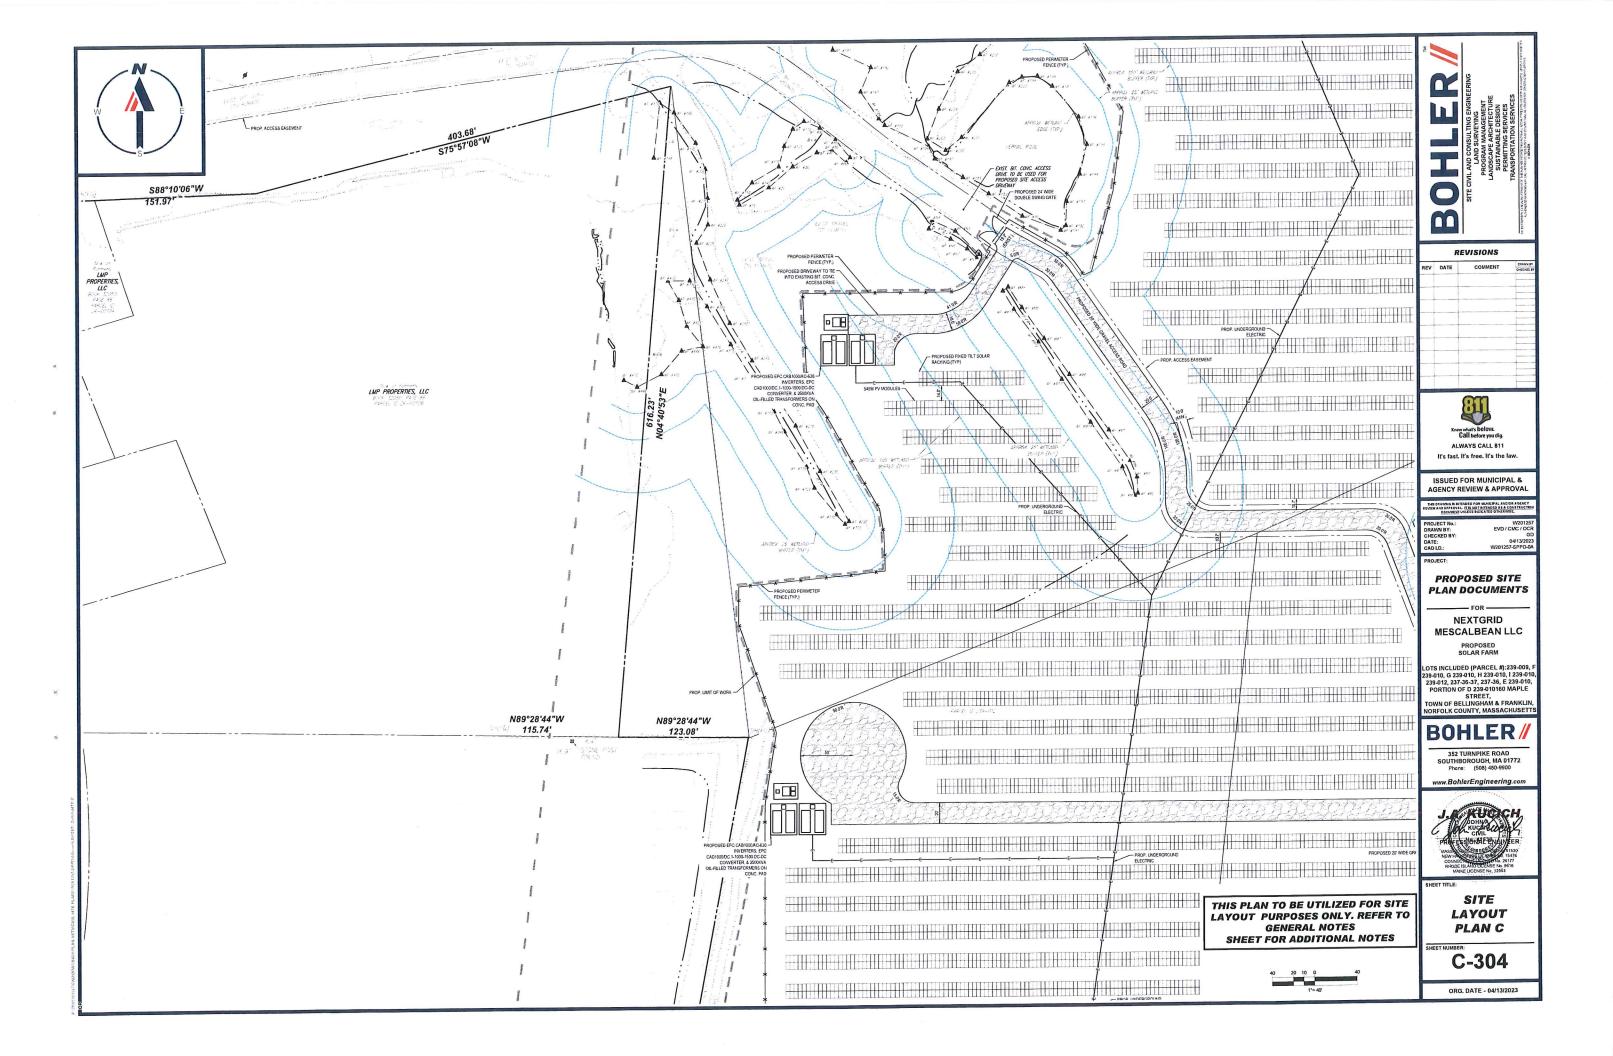


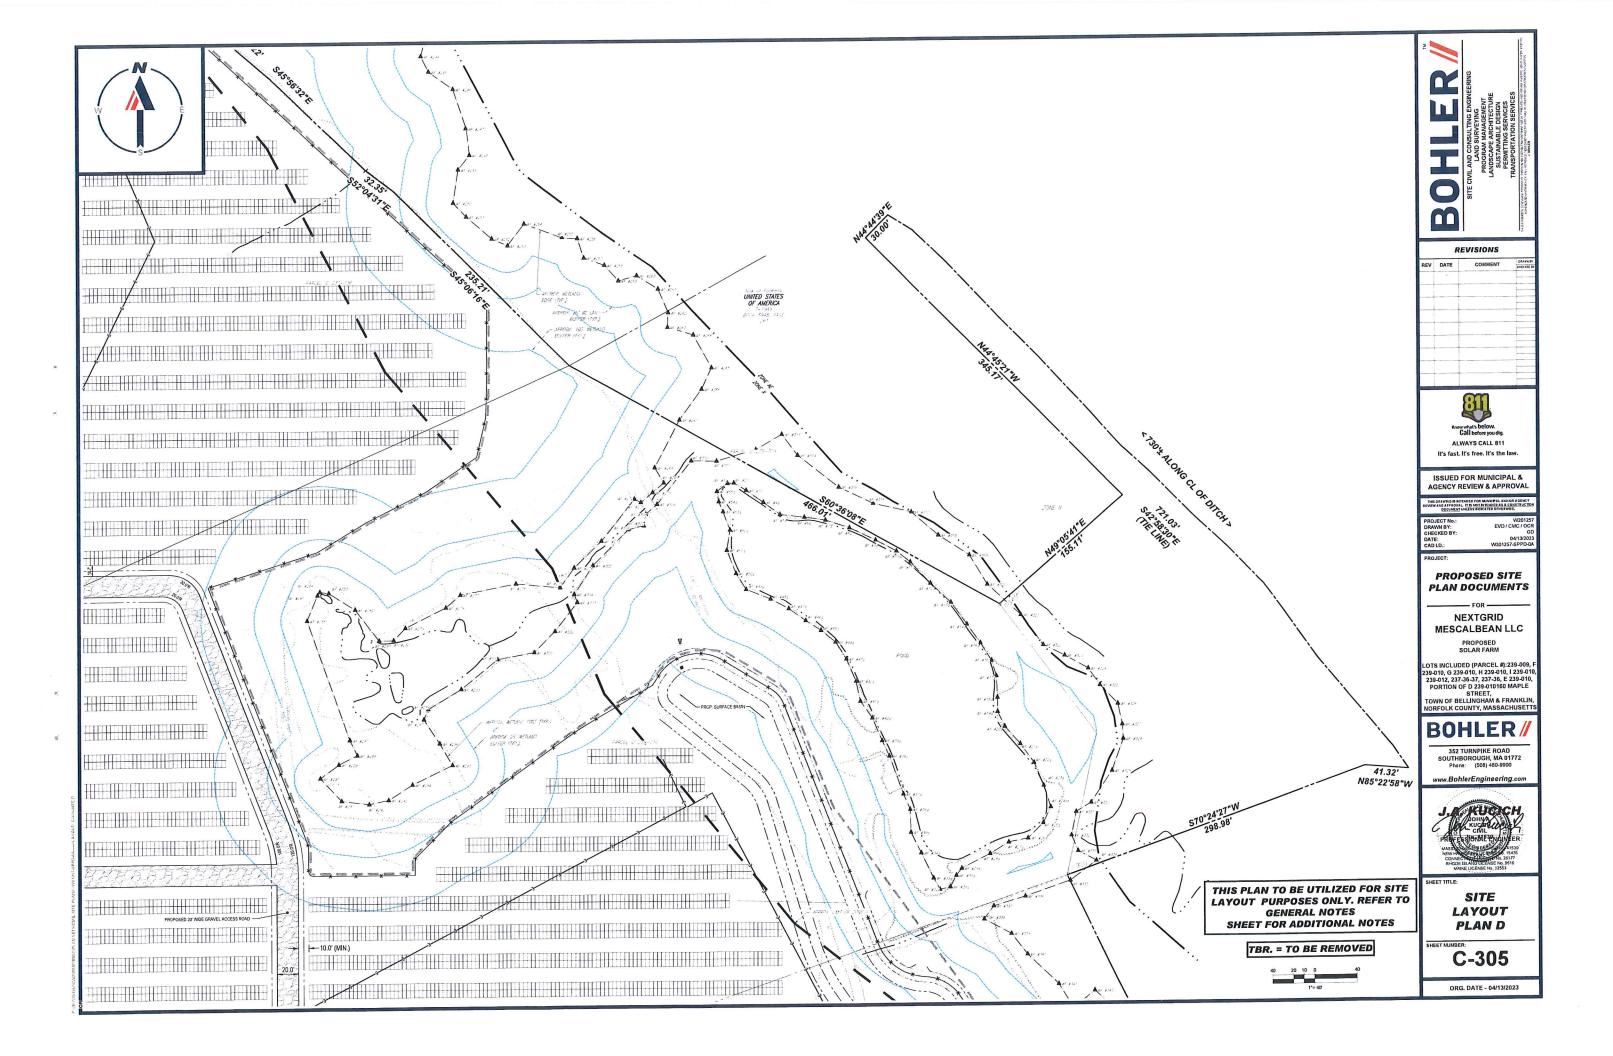

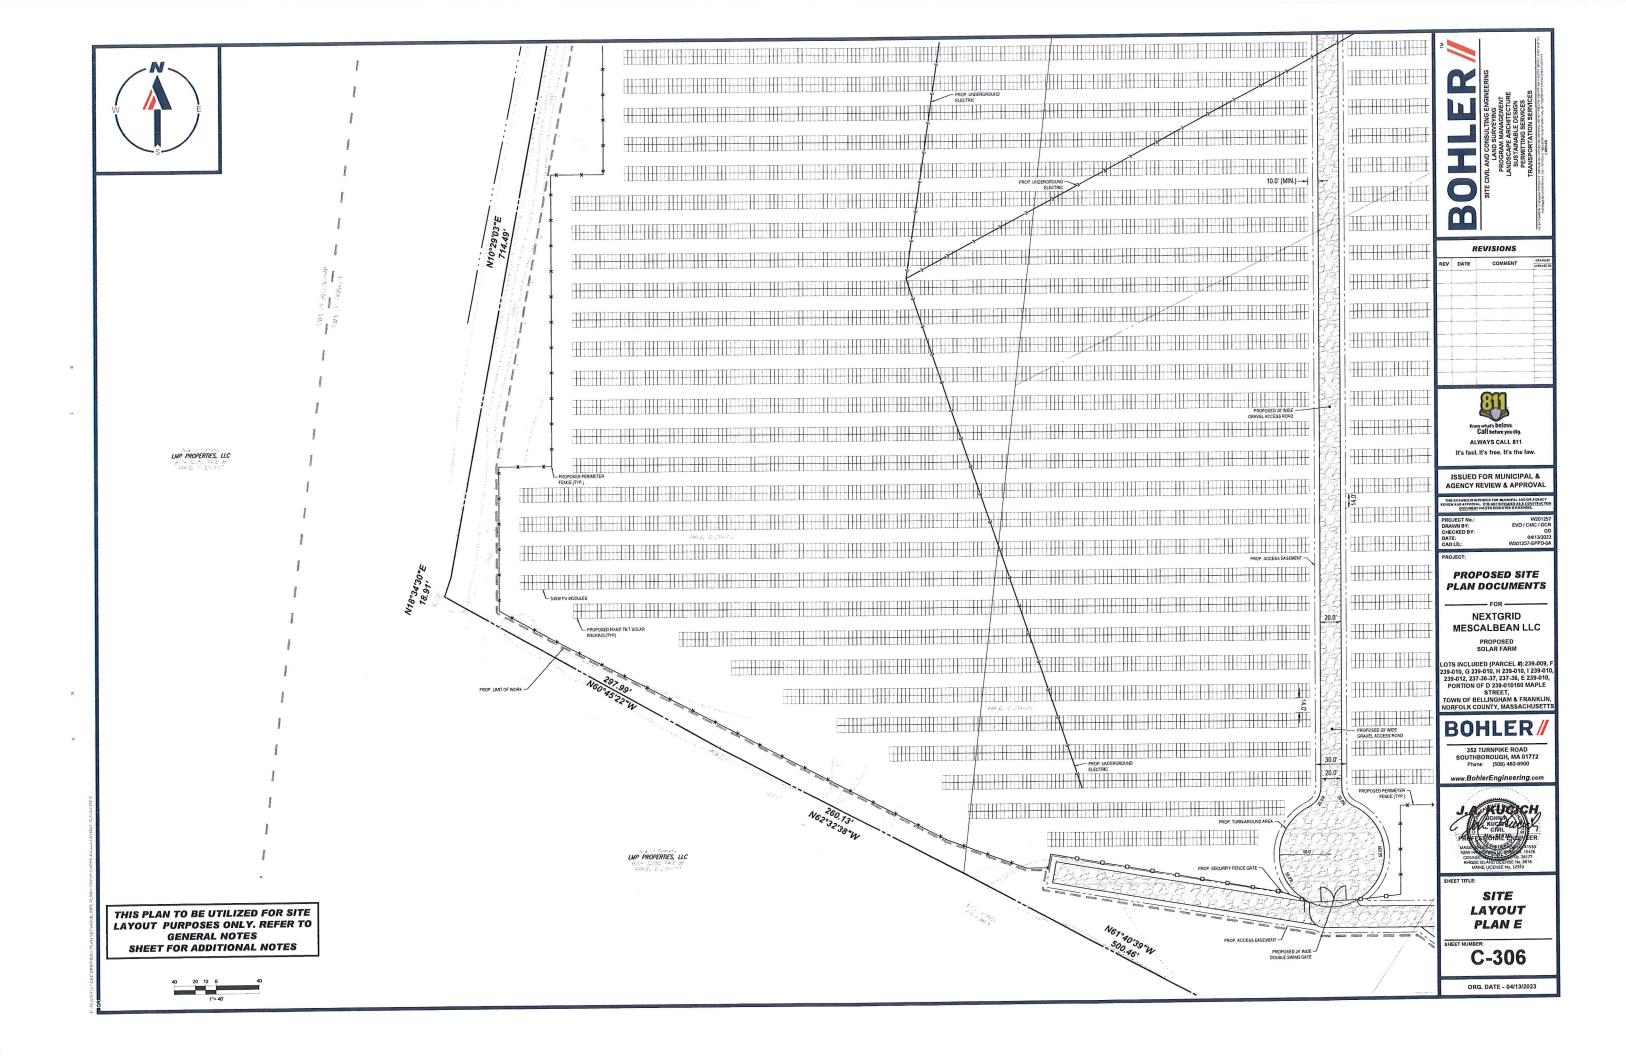

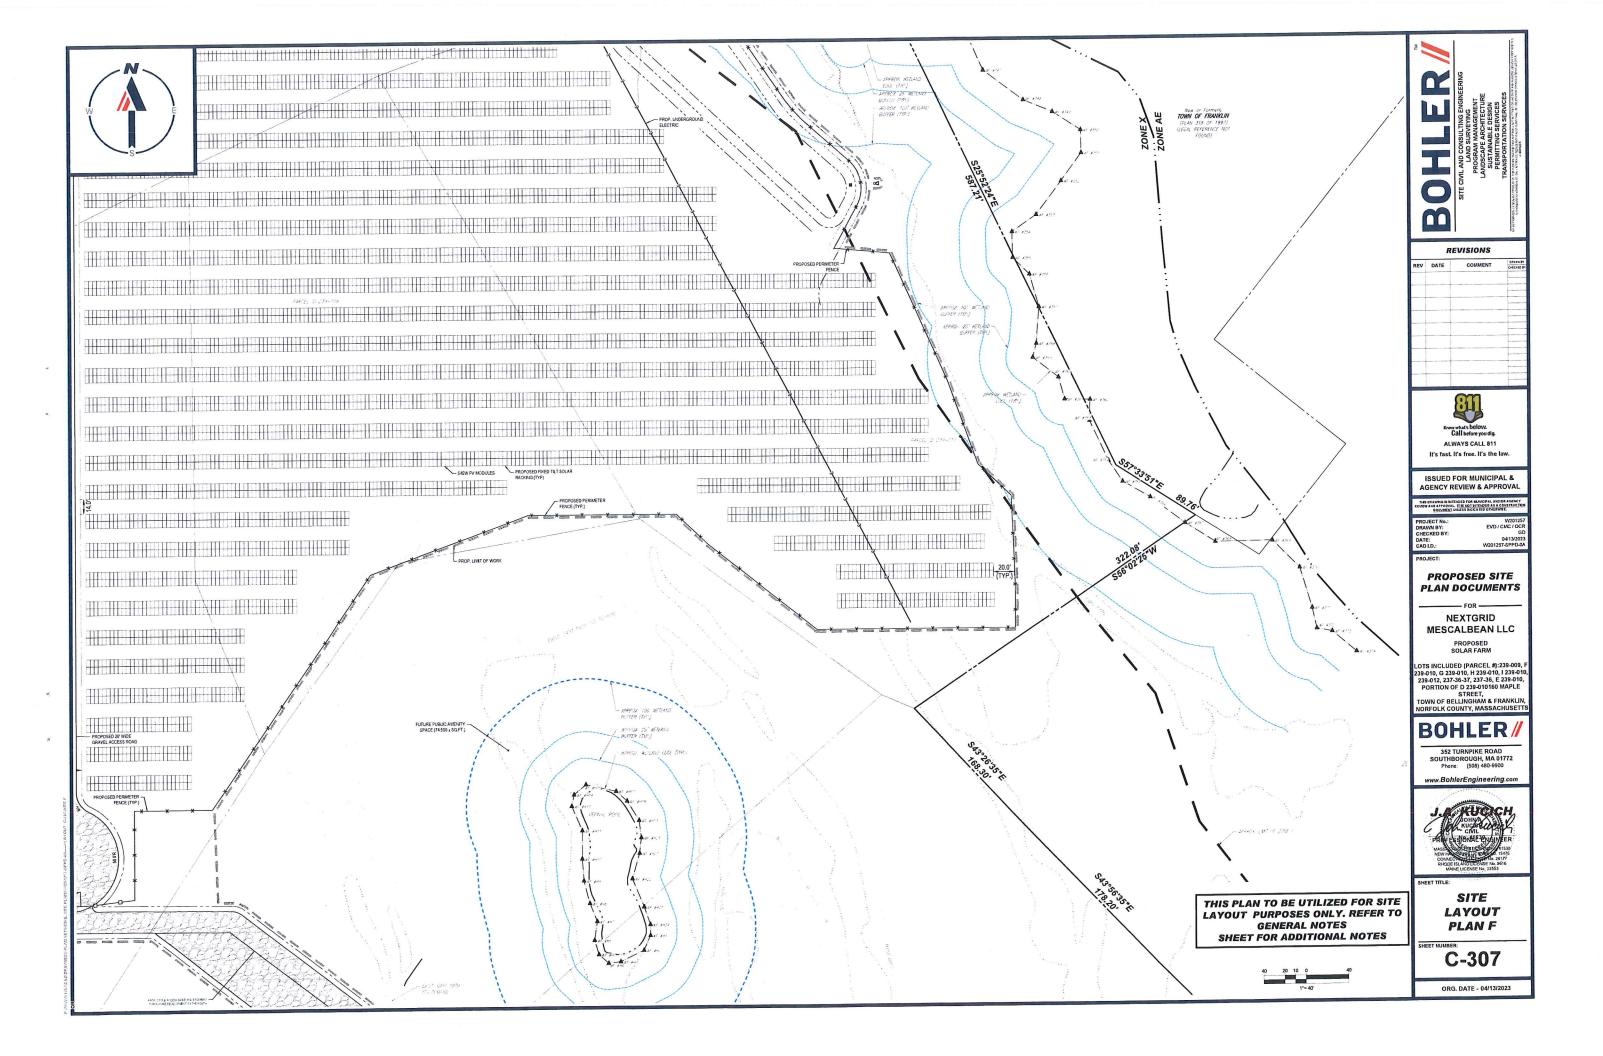



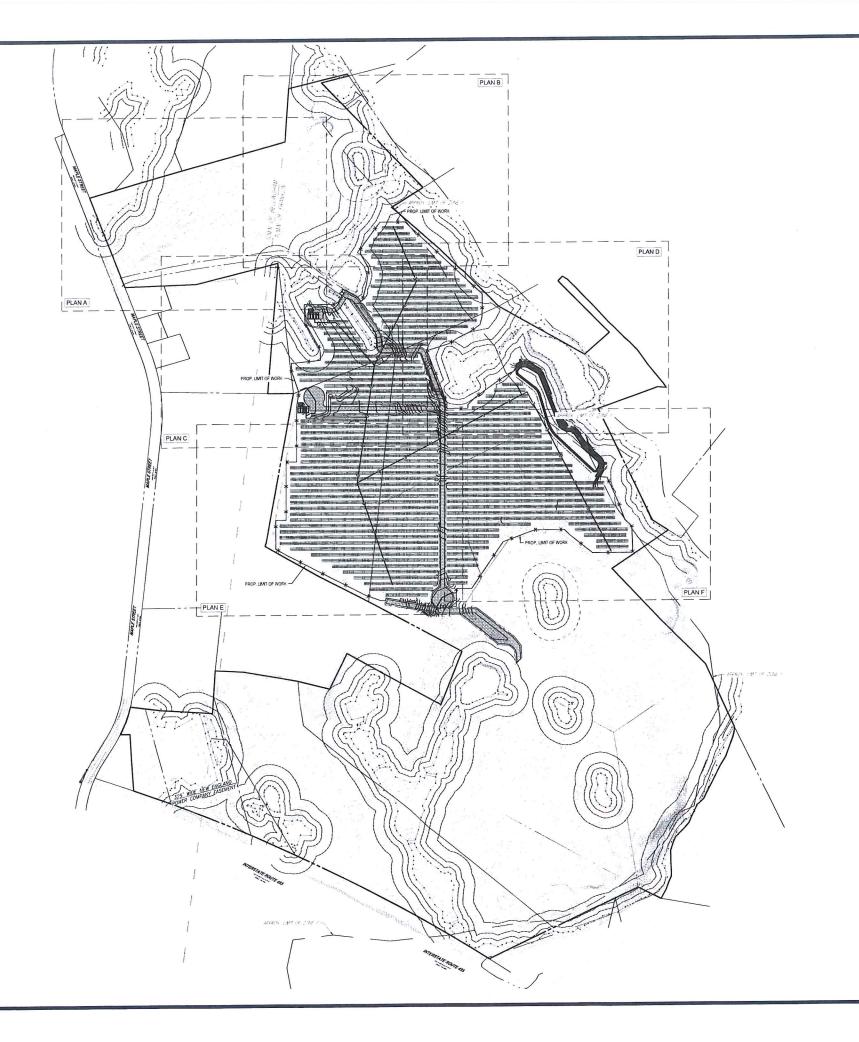



	The second lives and the second		e distribution		
REVISIONS					
REV	DATE	COMMENT	CHECKER BY		



ISSUED FOR MUNICIPAL & AGENCY REVIEW & APPROVAL

PROPOSED SITE PLAN DOCUMENTS

NEXTGRID

MESCALBEAN LLC PROPOSED SOLAR FARM

LOTS INCLUDED (PARCEL #):239-009, I 239-010, G 239-010, H 239-010, I 239-010 239-012, 237-36-37, 237-36, E 339-010, PORTION OF D 239-010160 MAPLE STREET, TOWN OF BELLINGHAM & FRANKLIN, NORFOLK COUNTY, MASSACHUSETTS

BOHLER

352 TURNPIKE ROAD SOUTHBOROUGH, MA 01772 Phone: (508) 480-9900





OVERALL GRADING PLAN


C-401


ORG. DATE - 04/13/2023

THIS PLAN TO BE UTILIZED FOR SITE GRADING PURPOSES ONLY. REFER TO GENERAL NOTES SHEET
FOR ADDITIONAL GRADING & UTILITY NOTES

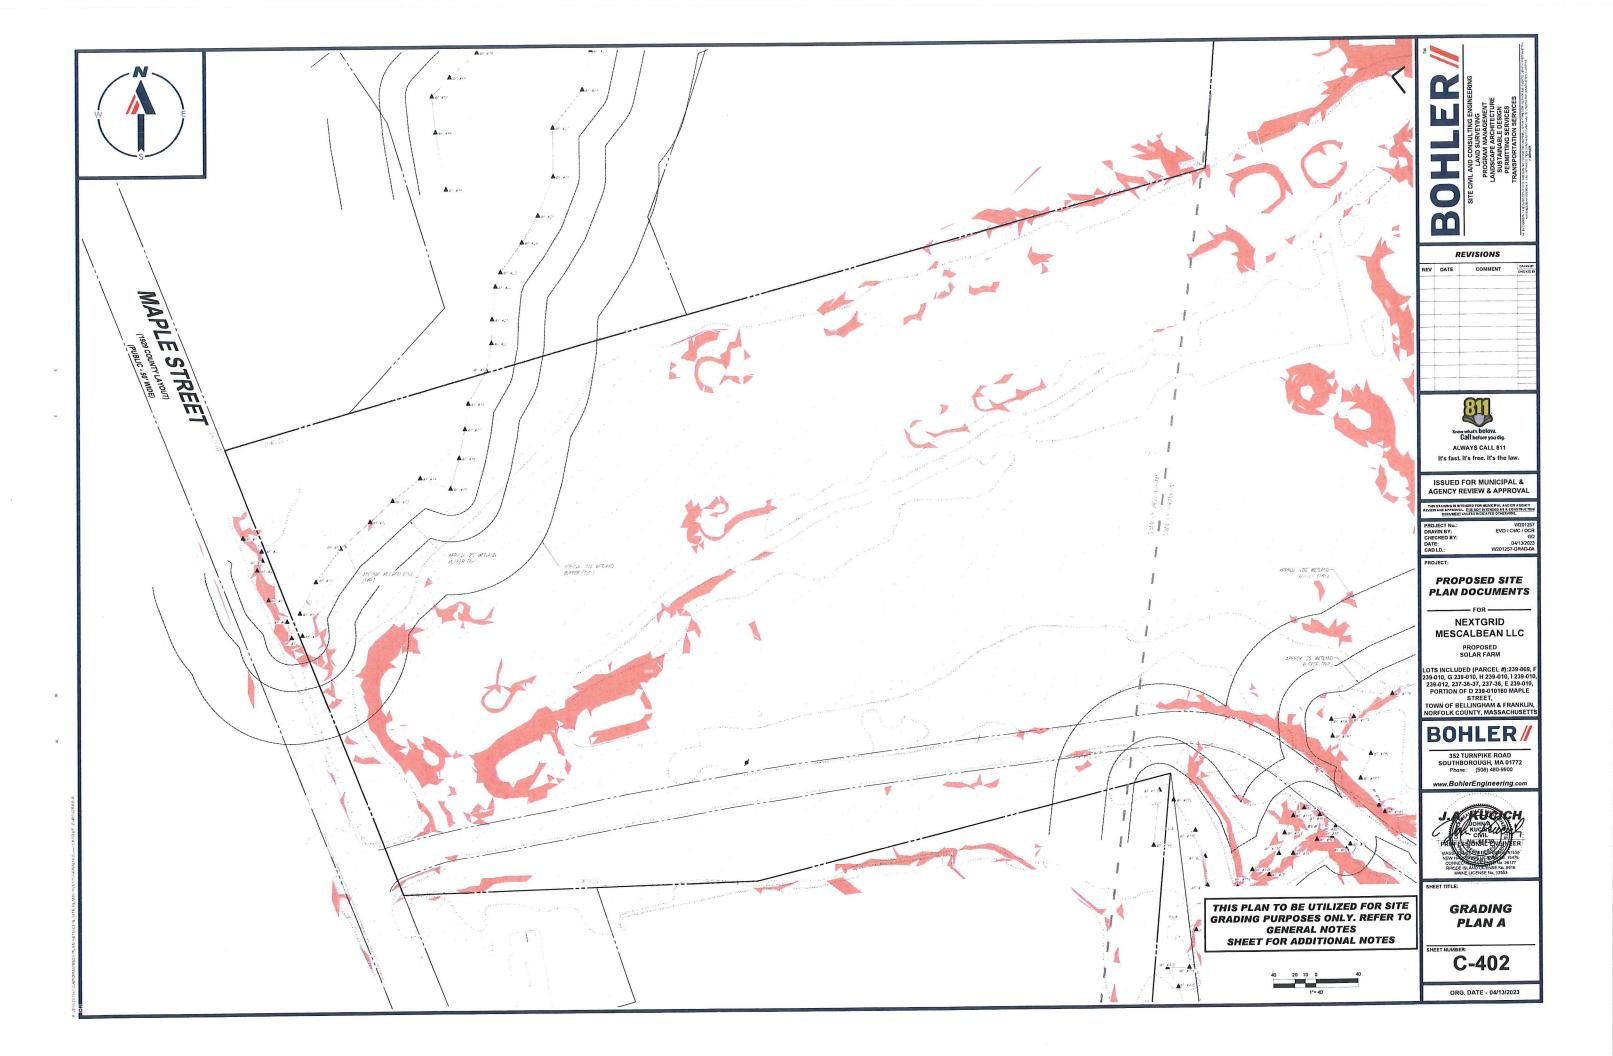

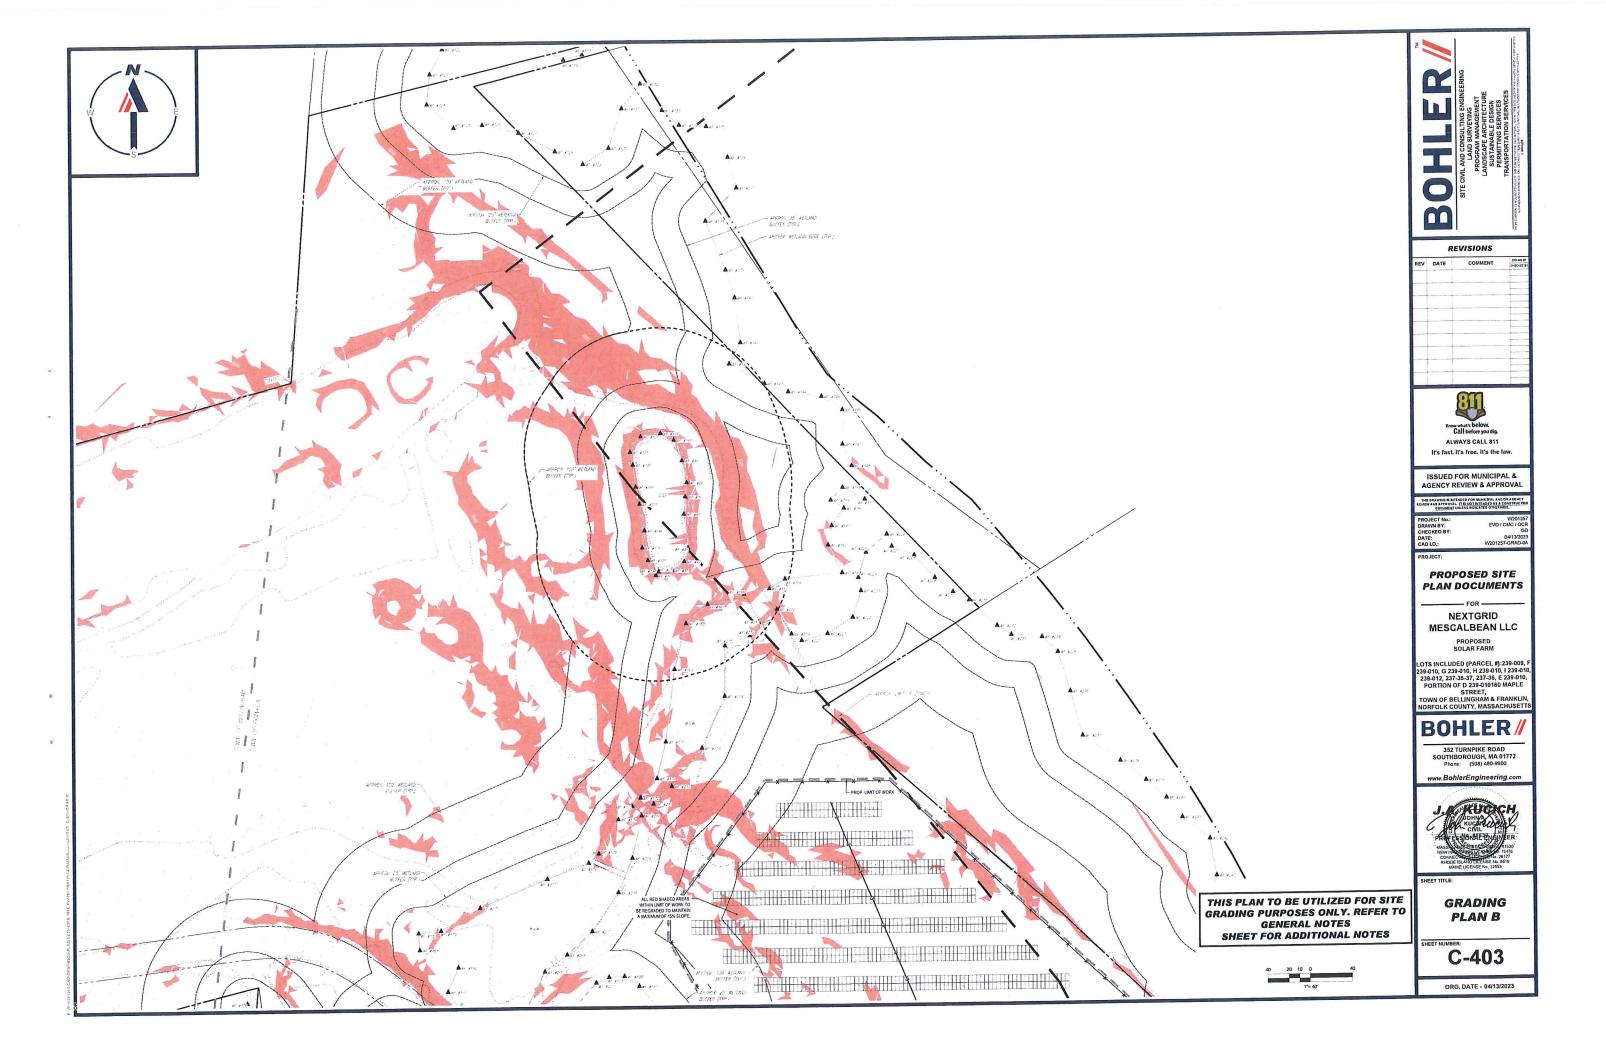

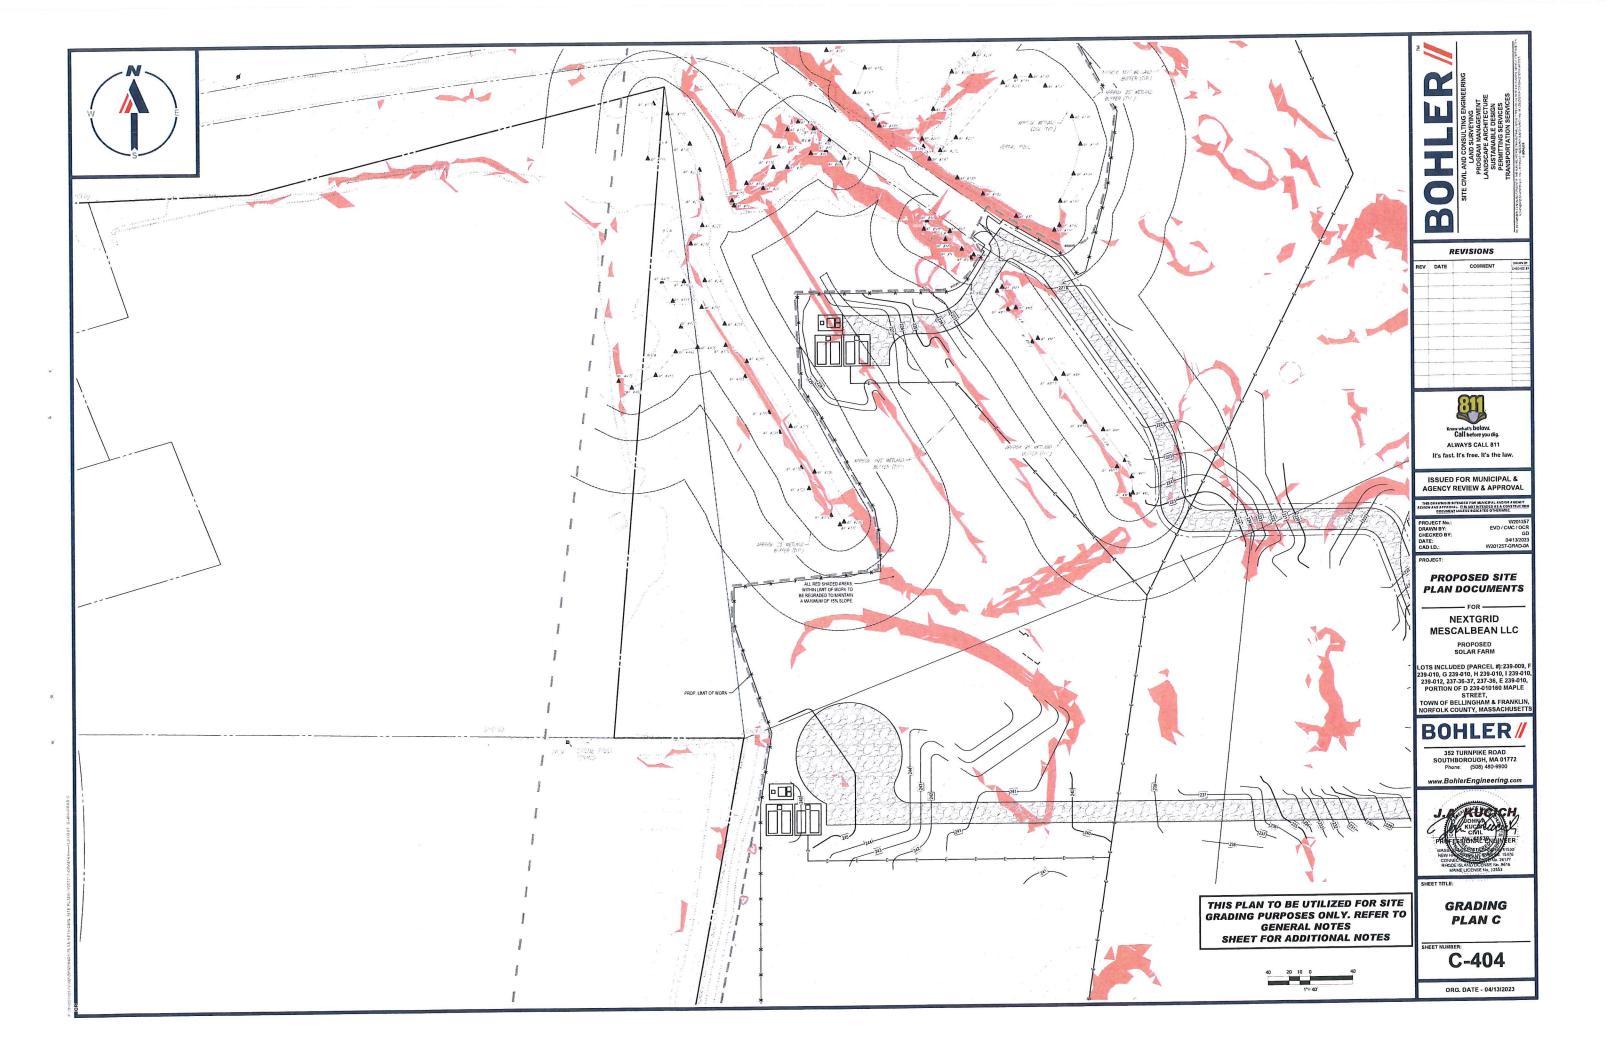

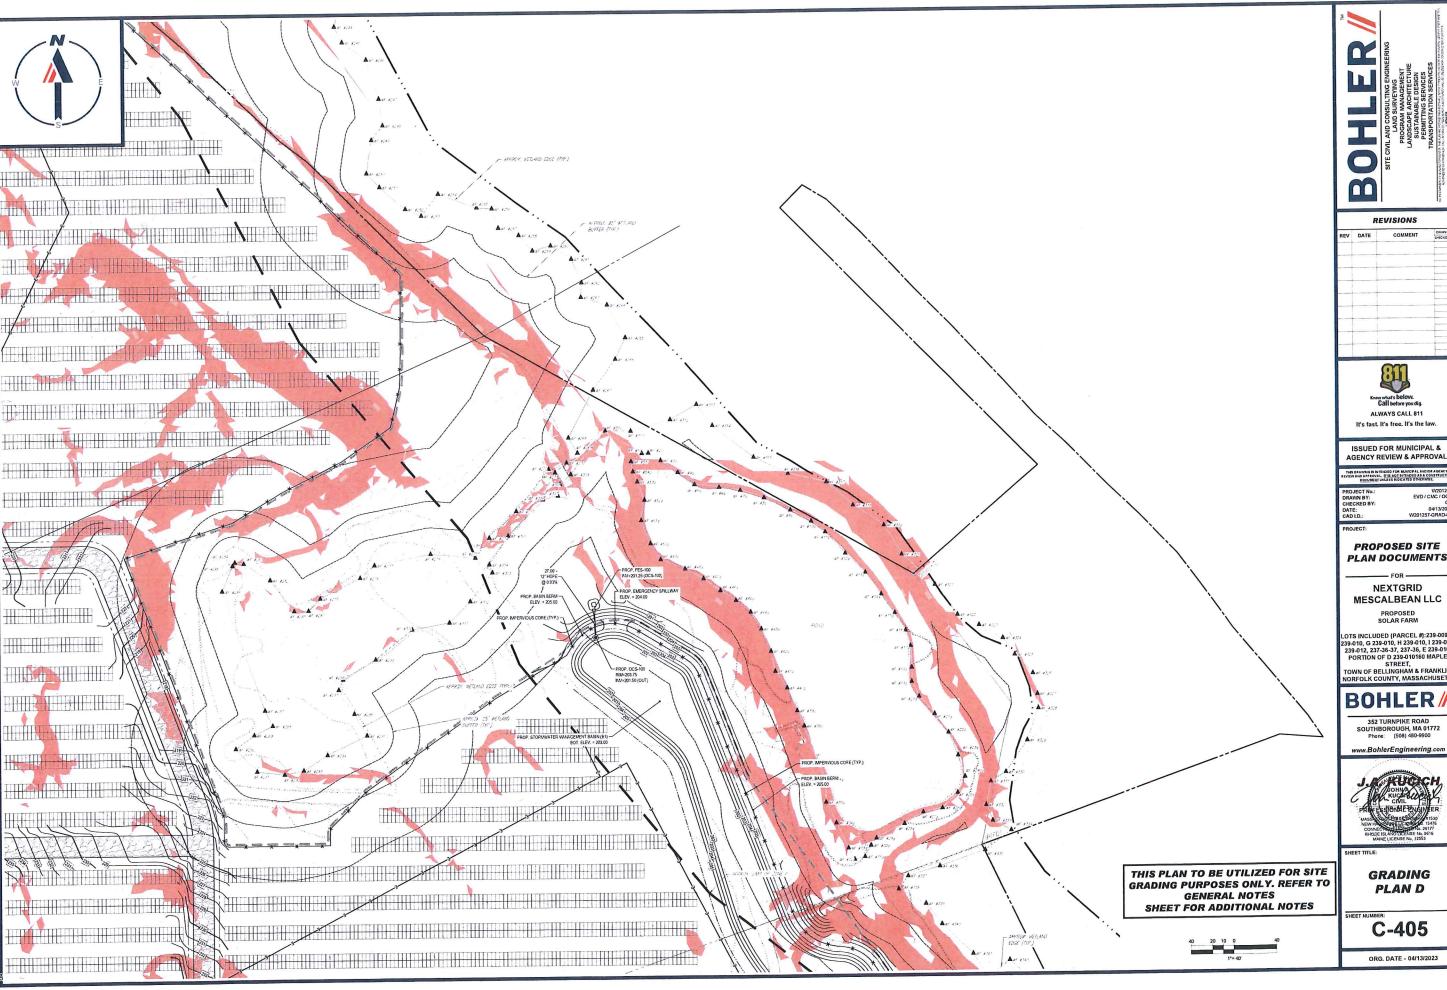



REVISIONS COMMENT



ISSUED FOR MUNICIPAL &
AGENCY REVIEW & APPROVAL

PROJECT No.:	W2012
DRAWN BY:	EVD / CMC / O
CHECKED BY:	
DATE:	04/13/20
CAD LD.:	W201257-GRAD-
CAD LU	11101101

PROPOSED SITE **PLAN DOCUMENTS**

NEXTGRID

MESCALBEAN LLC

LOTS INCLUDED (PARCEL #):239-009, F 239-010, G 239-010, H 239-010, I 239-010 239-012, 237-36-37, 237-36, E 239-010, PORTION OF D 239-010160 MAPLE

STREET,
TOWN OF BELLINGHAM & FRANKLIN,
NORFOLK COUNTY, MASSACHUSETT


352 TURNPIKE ROAD SOUTHBOROUGH, MA 01772 Phone: (508) 480-9900

www.BohlerEngineering.com



GRADING PLAN D

C-405

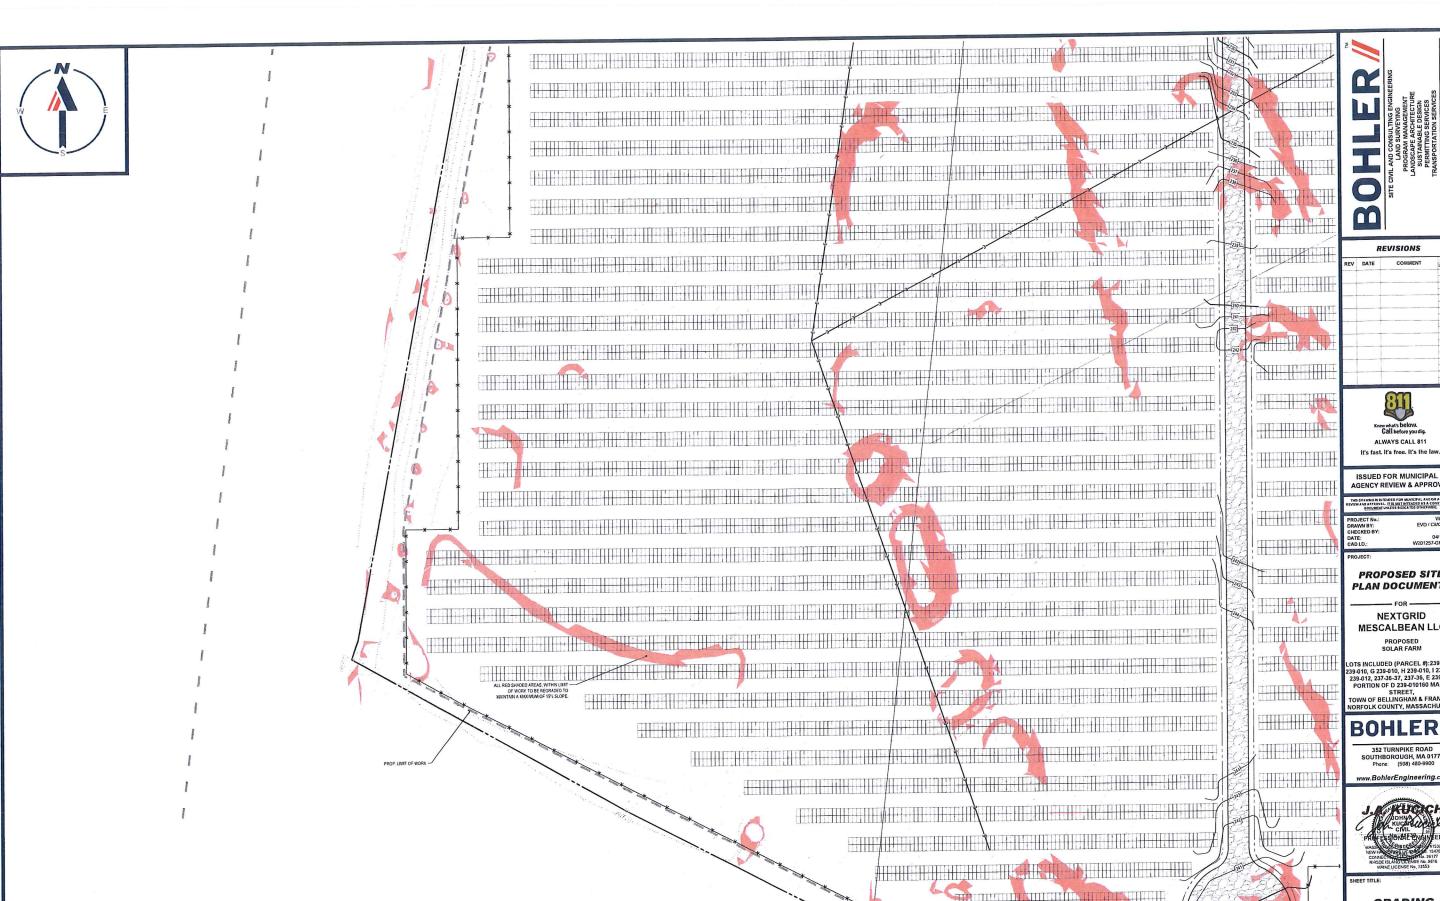

THIS PLAN TO BE UTILIZED FOR SITE **GRADING PURPOSES ONLY. REFER TO GENERAL NOTES** SHEET FOR ADDITIONAL NOTES



REVISIONS

Knew what's below. Call before you dig. ALWAYS CALL 811

ISSUED FOR MUNICIPAL & **AGENCY REVIEW & APPROVAL**

PROPOSED SITE **PLAN DOCUMENTS**

NEXTGRID MESCALBEAN LLC

LOTS INCLUDED (PARCEL #):239-009, F 239-010, G 239-010, H 239-010, I 239-010 239-012, 237-36-37, 237-36, E 239-010, PORTION OF D 239-010160 MAPLE

STREET, TOWN OF BELLINGHAM & FRANKLI ORFOLK COUNTY, MASSACHUSETT


BOHLER

ww.BohlerEngineering.com



GRADING PLAN E

C-406

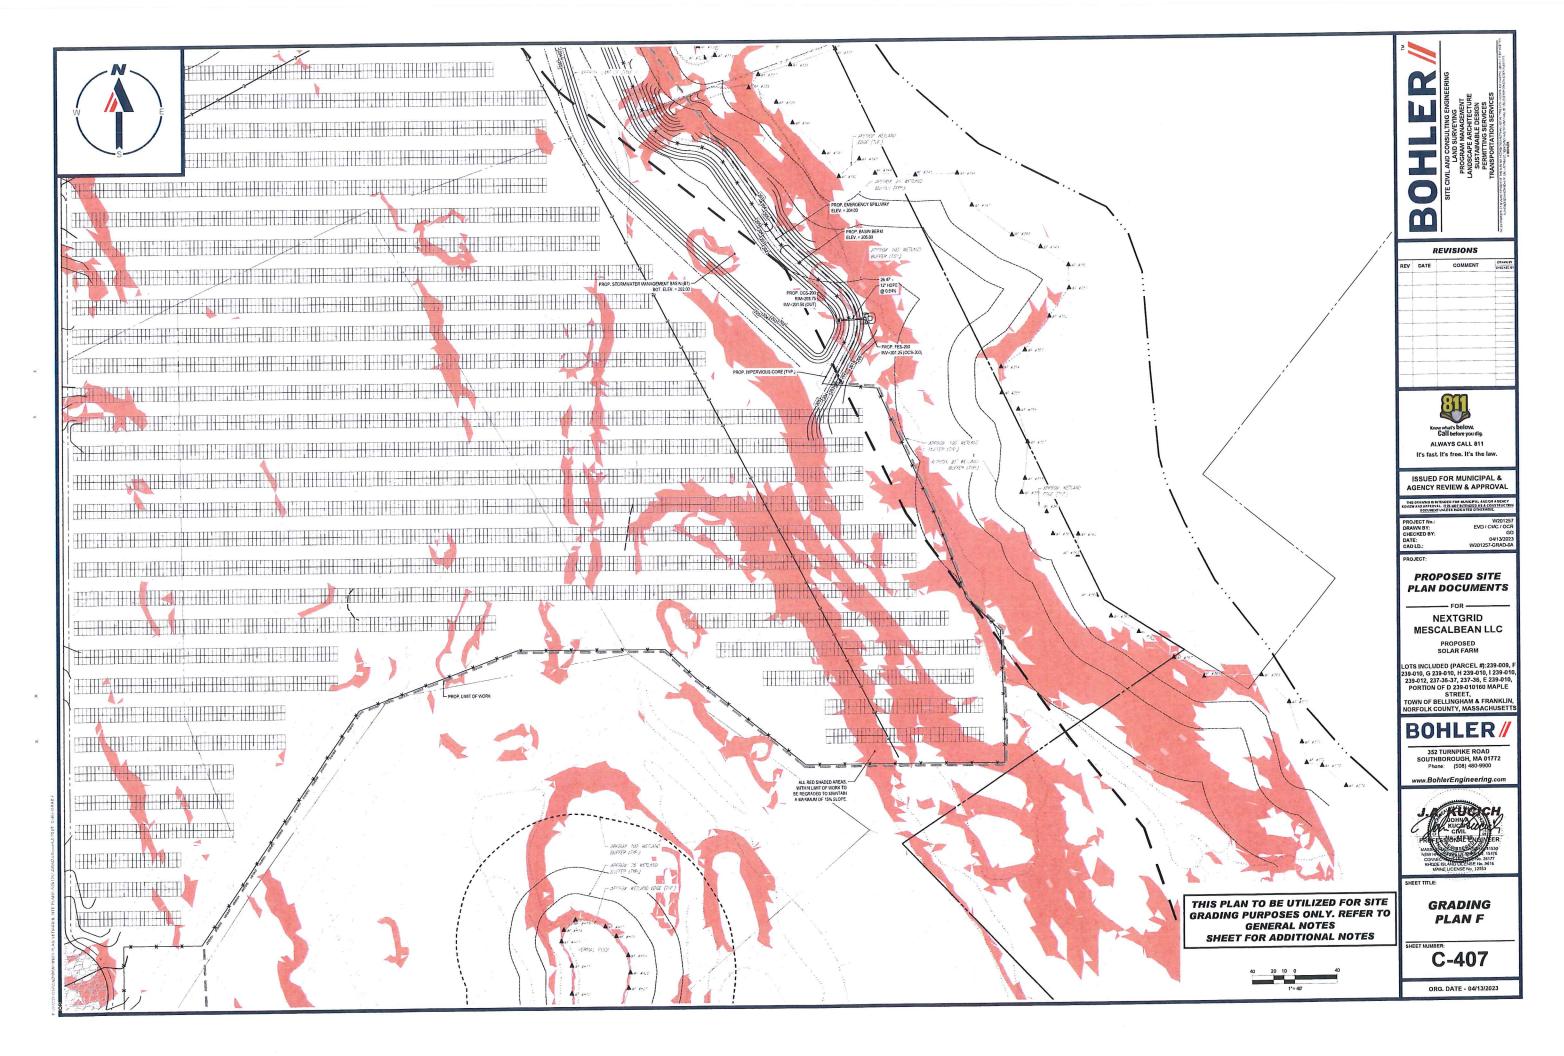





REVISIONS					
REV	DATE	COMMENT	DELEVE BY		

Know what's below. Call before you dig. **ALWAYS CALL 811** It's fast. It's free. It's the law.

ISSUED FOR MUNICIPAL & AGENCY REVIEW & APPROVAL

THIS PLAN TO BE UTILIZED FOR SITE SOIL AND EROSION CONTROL **PURPOSES ONLY**

MEADOW SEED MIX SHALL BE INSTALLED WITHIN ALL LANDSCAPE AREAS DELINEATED BY THE LIMIT OF WORK

REFER TO SOIL EROSION CONTROL NOTES & DETAIL SHEET FOR EROSION

NOTES AND DETAILS

EROSION CONTROL BARRIER SHALL CONSIST OF BOTH COMPOST SOCK

AND SIT FENCE UNLESS OTHERWISE

NOTED. SEE DETAILS FOR MORE INFORMATION.

PROPOSED SITE PLAN DOCUMENTS

NEXTGRID MESCALBEAN LLC

PROPOSED SOLAR FARM

LOTS INCLUDED (PARCEL #):239-009, F 239-010, G 239-010, H 239-010, I 239-010, 239-012, 237-36-37, 237-36, E 239-010, PORTION OF D 239-010160 MAPLE STREET, TOWN OF BELLINGHAM & FRANKLIN, NORFOLK COUNTY, MASSACHUSETTS


BOHLER


352 TURNPIKE ROAD SOUTHBOROUGH, MA 01772 Phone: (508) 480-9900





OVERALL SOIL **EROSION &** SEDIMENT **CONTROL PLAN**


C-601

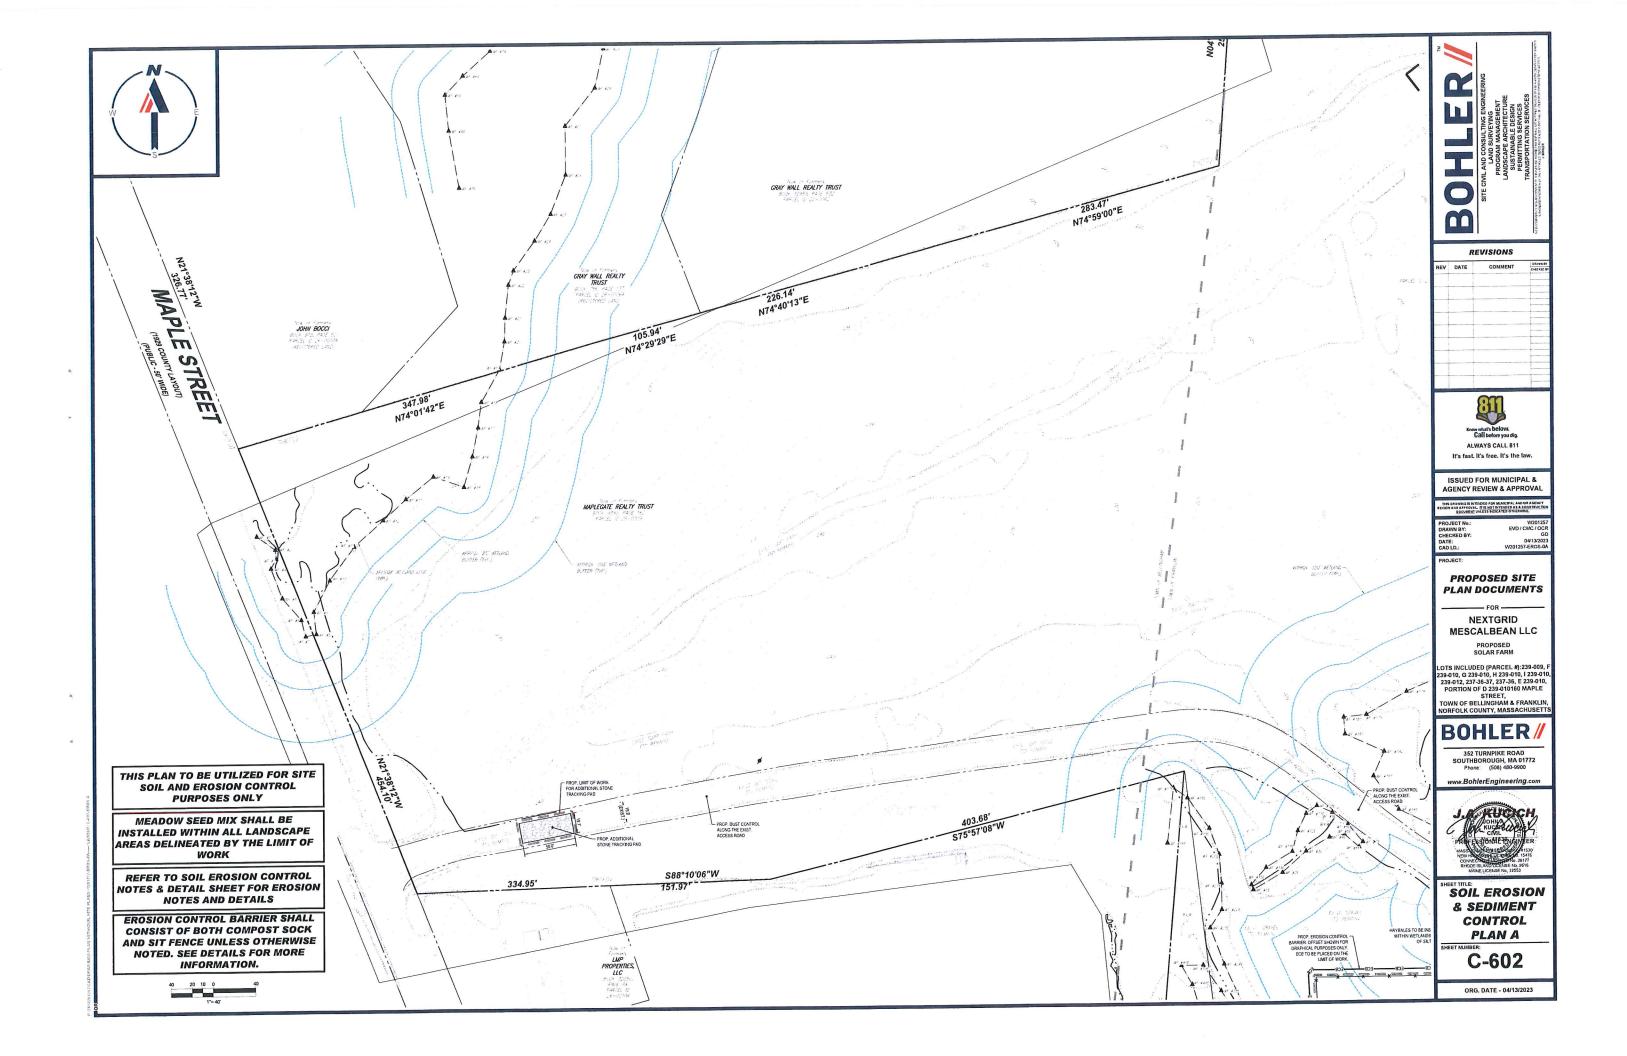


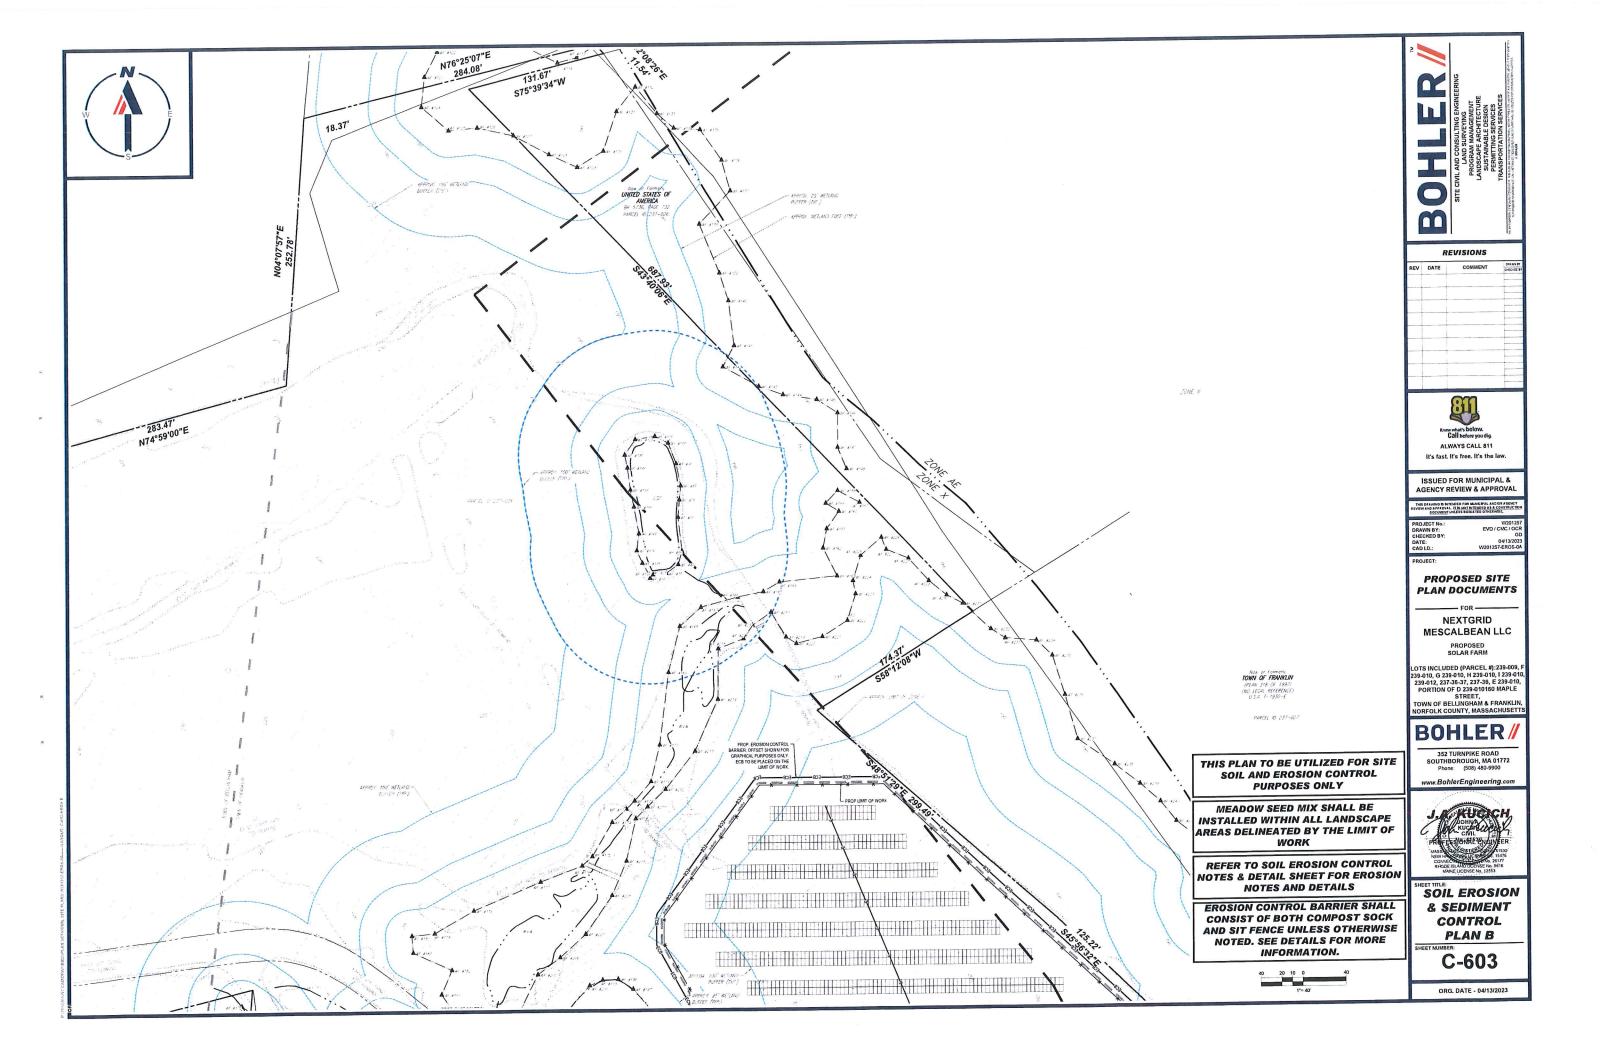


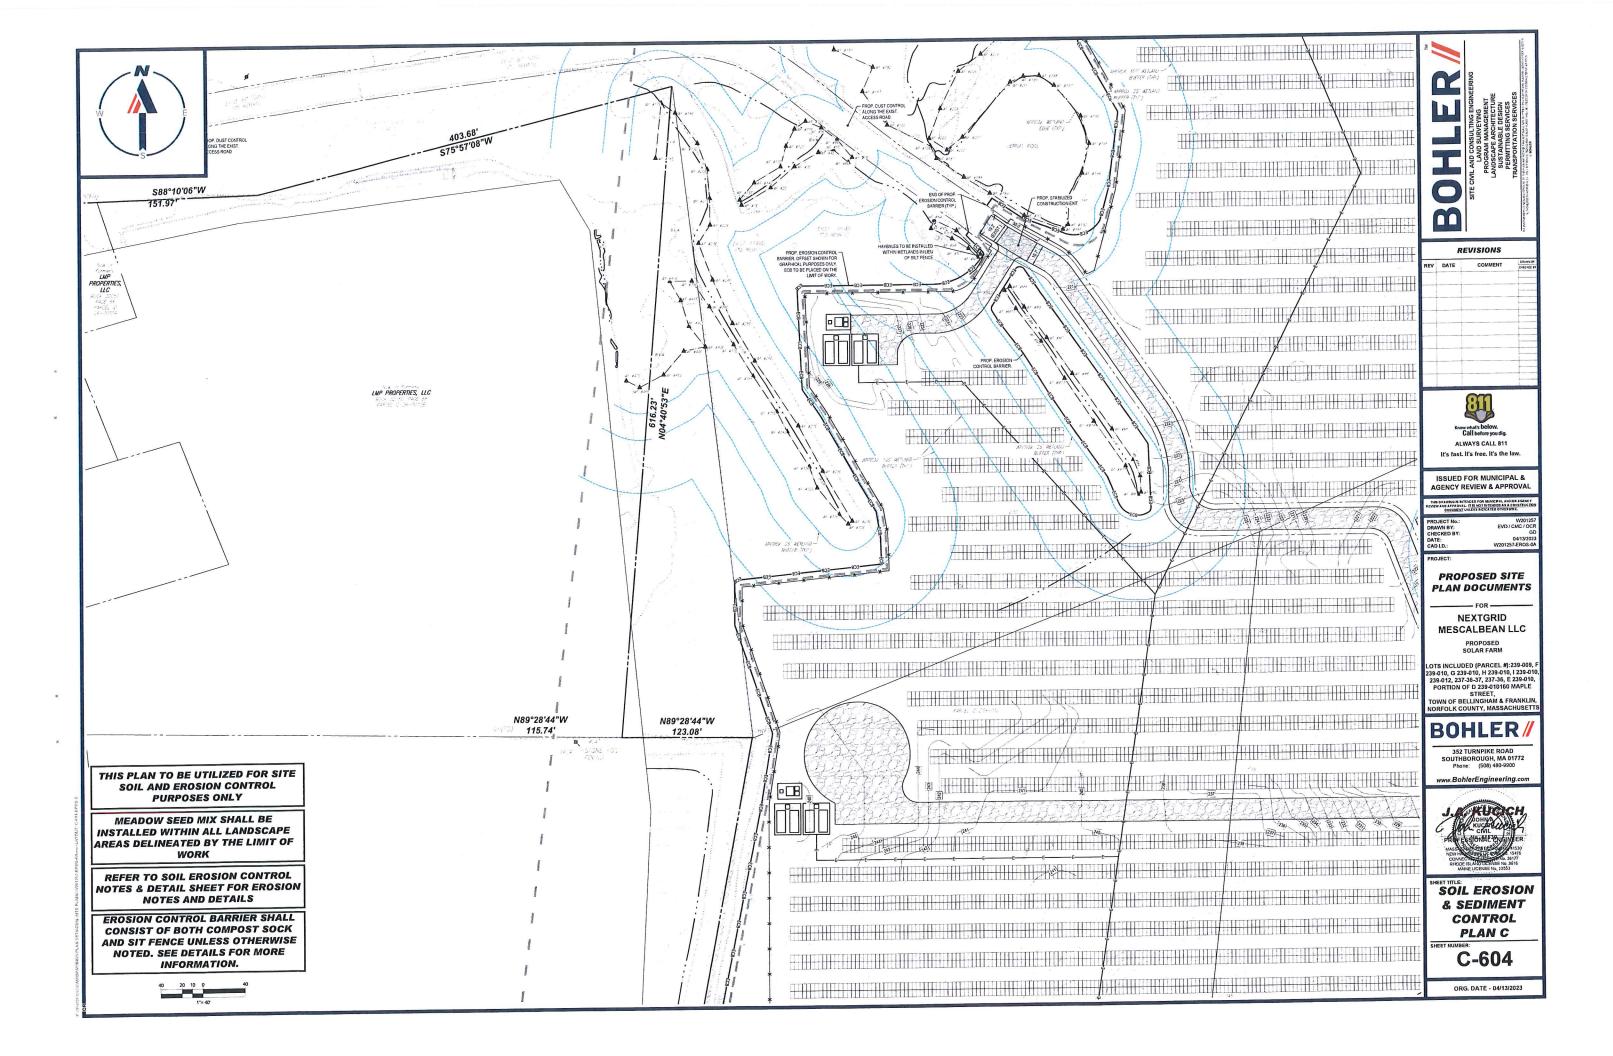


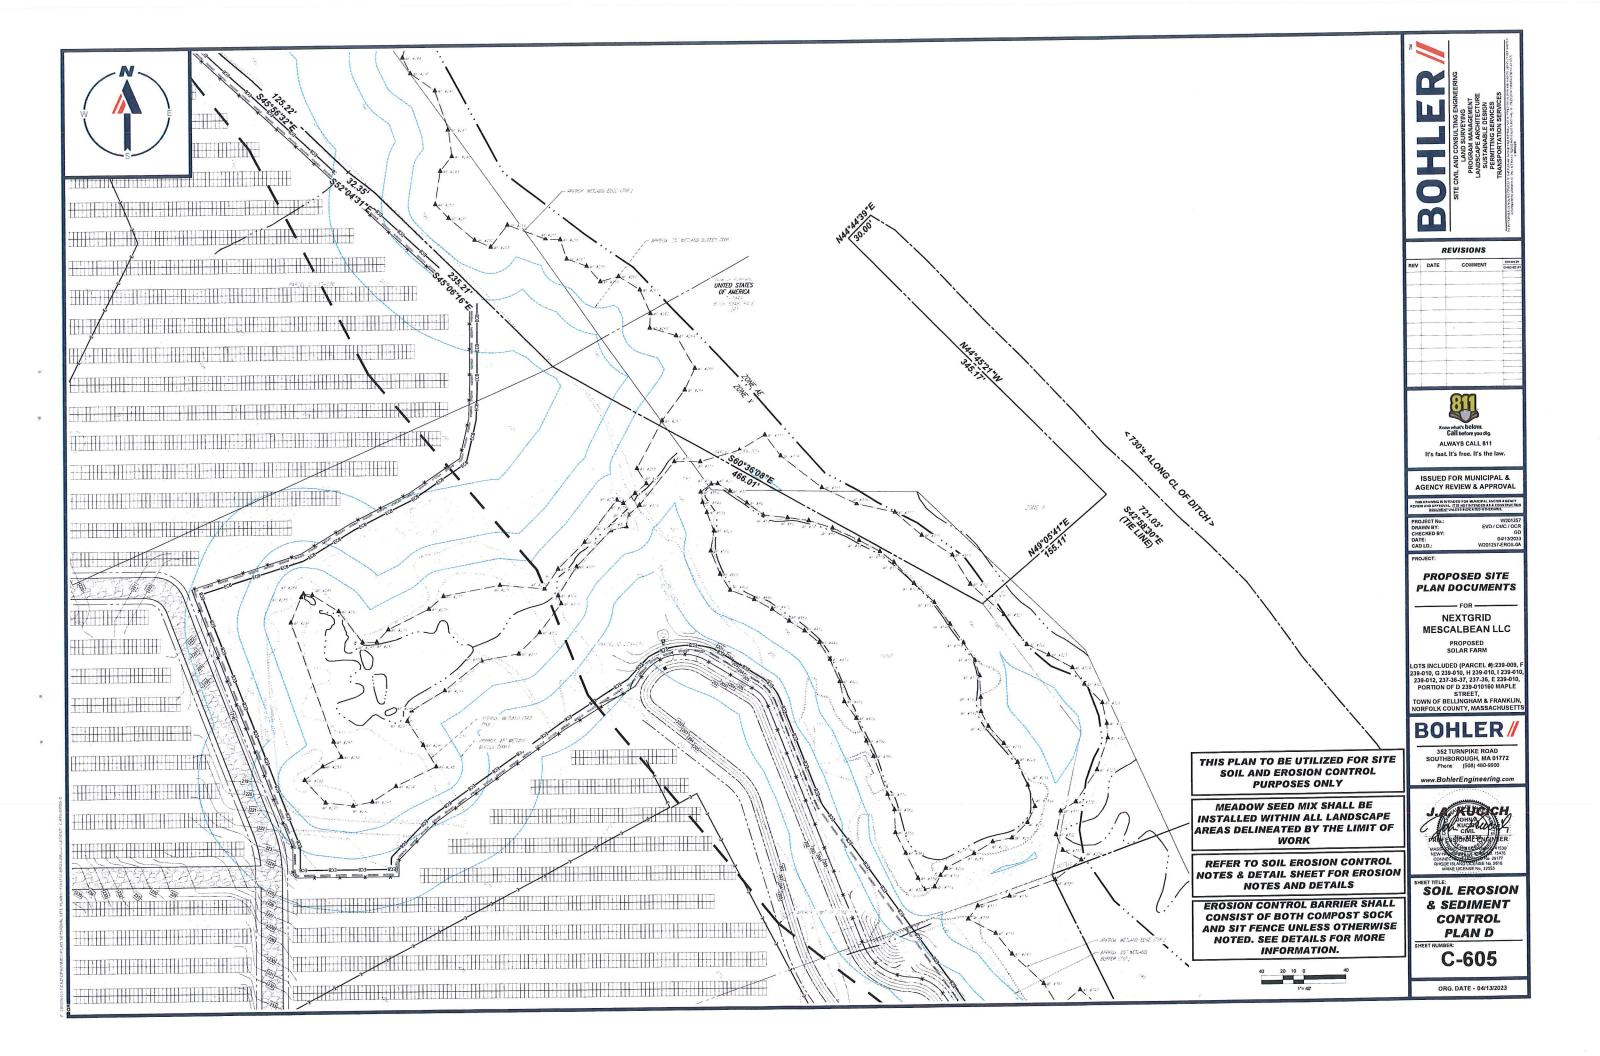

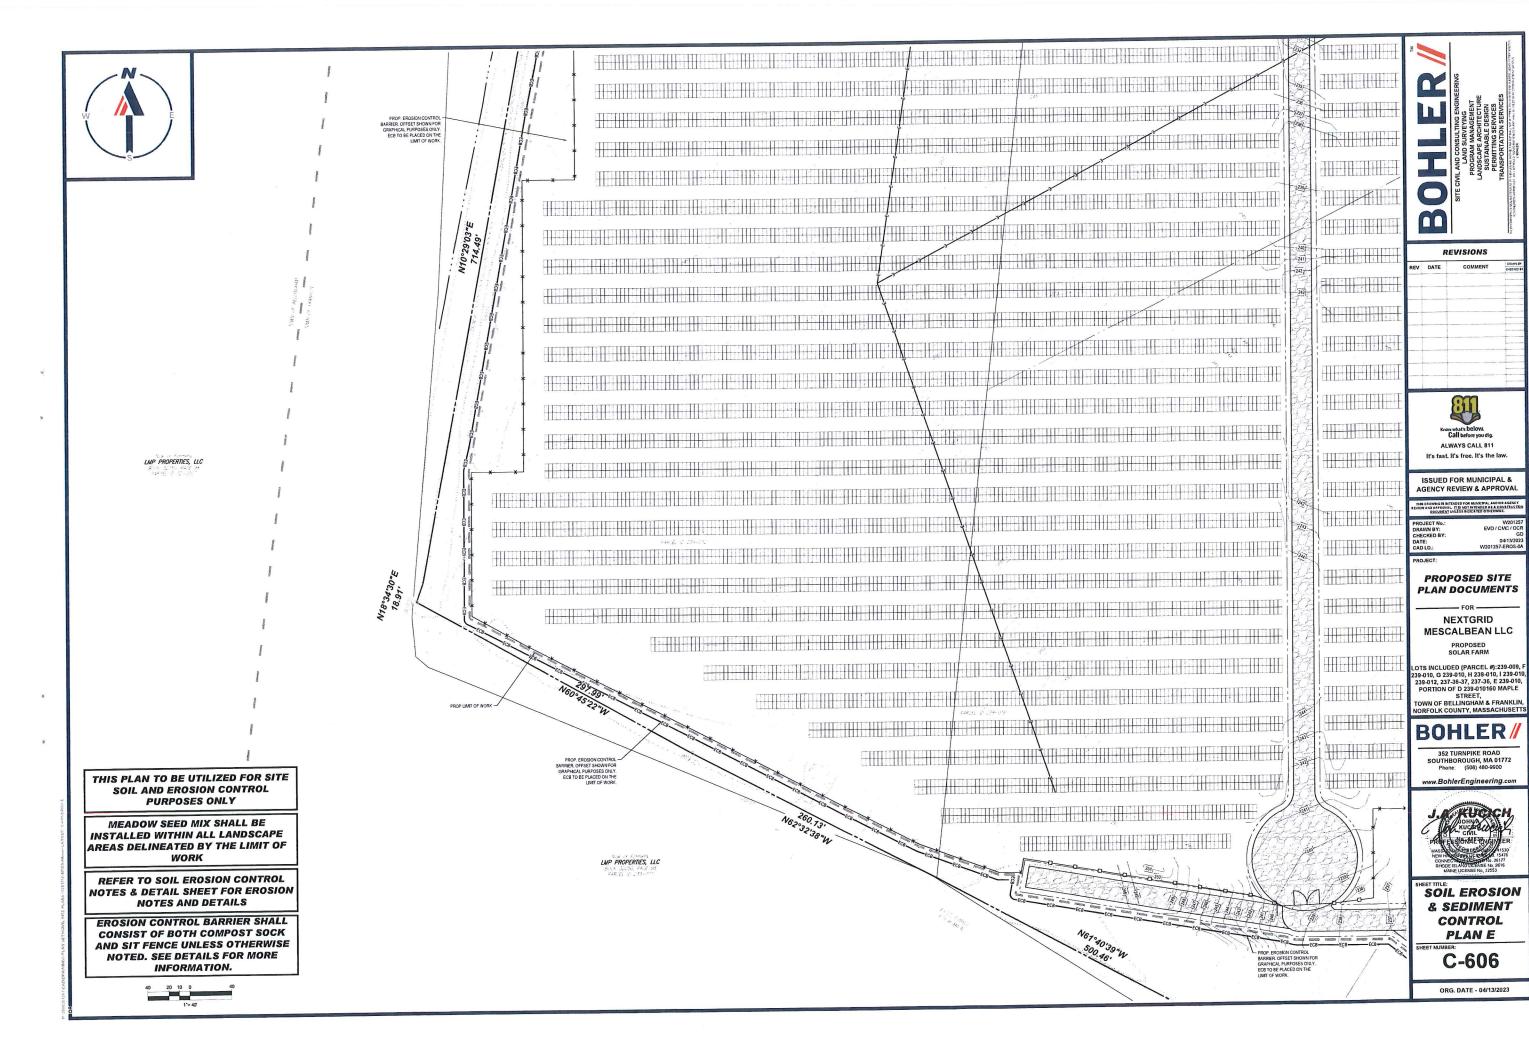

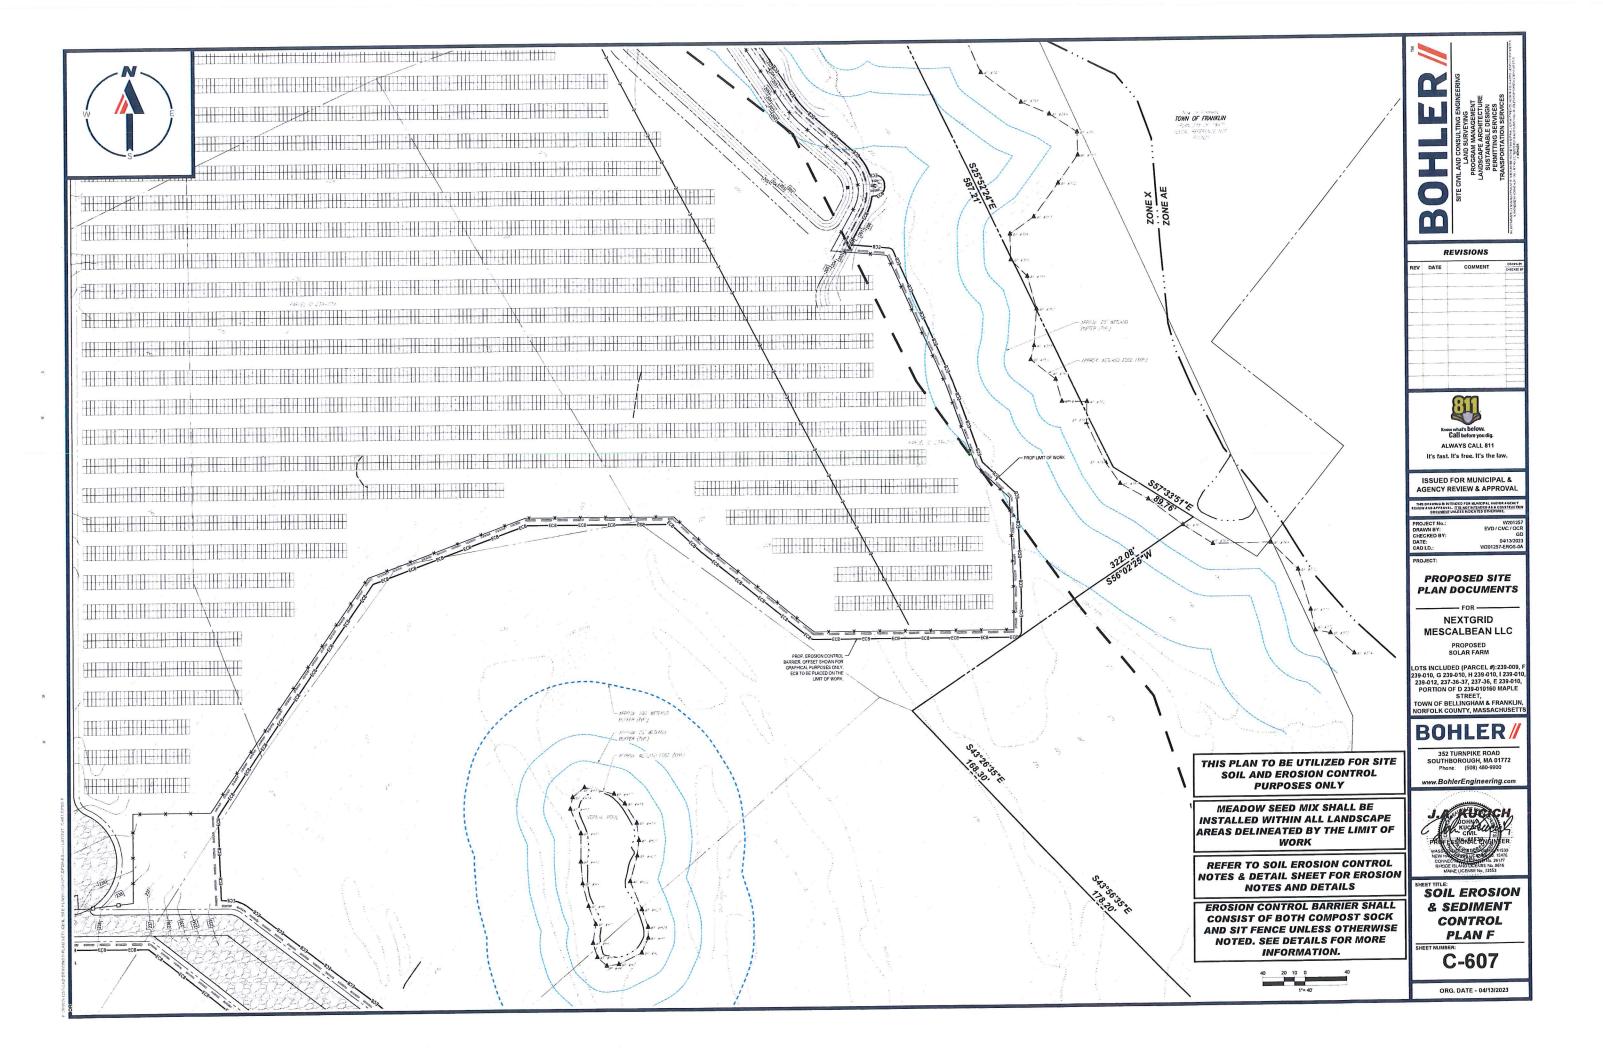

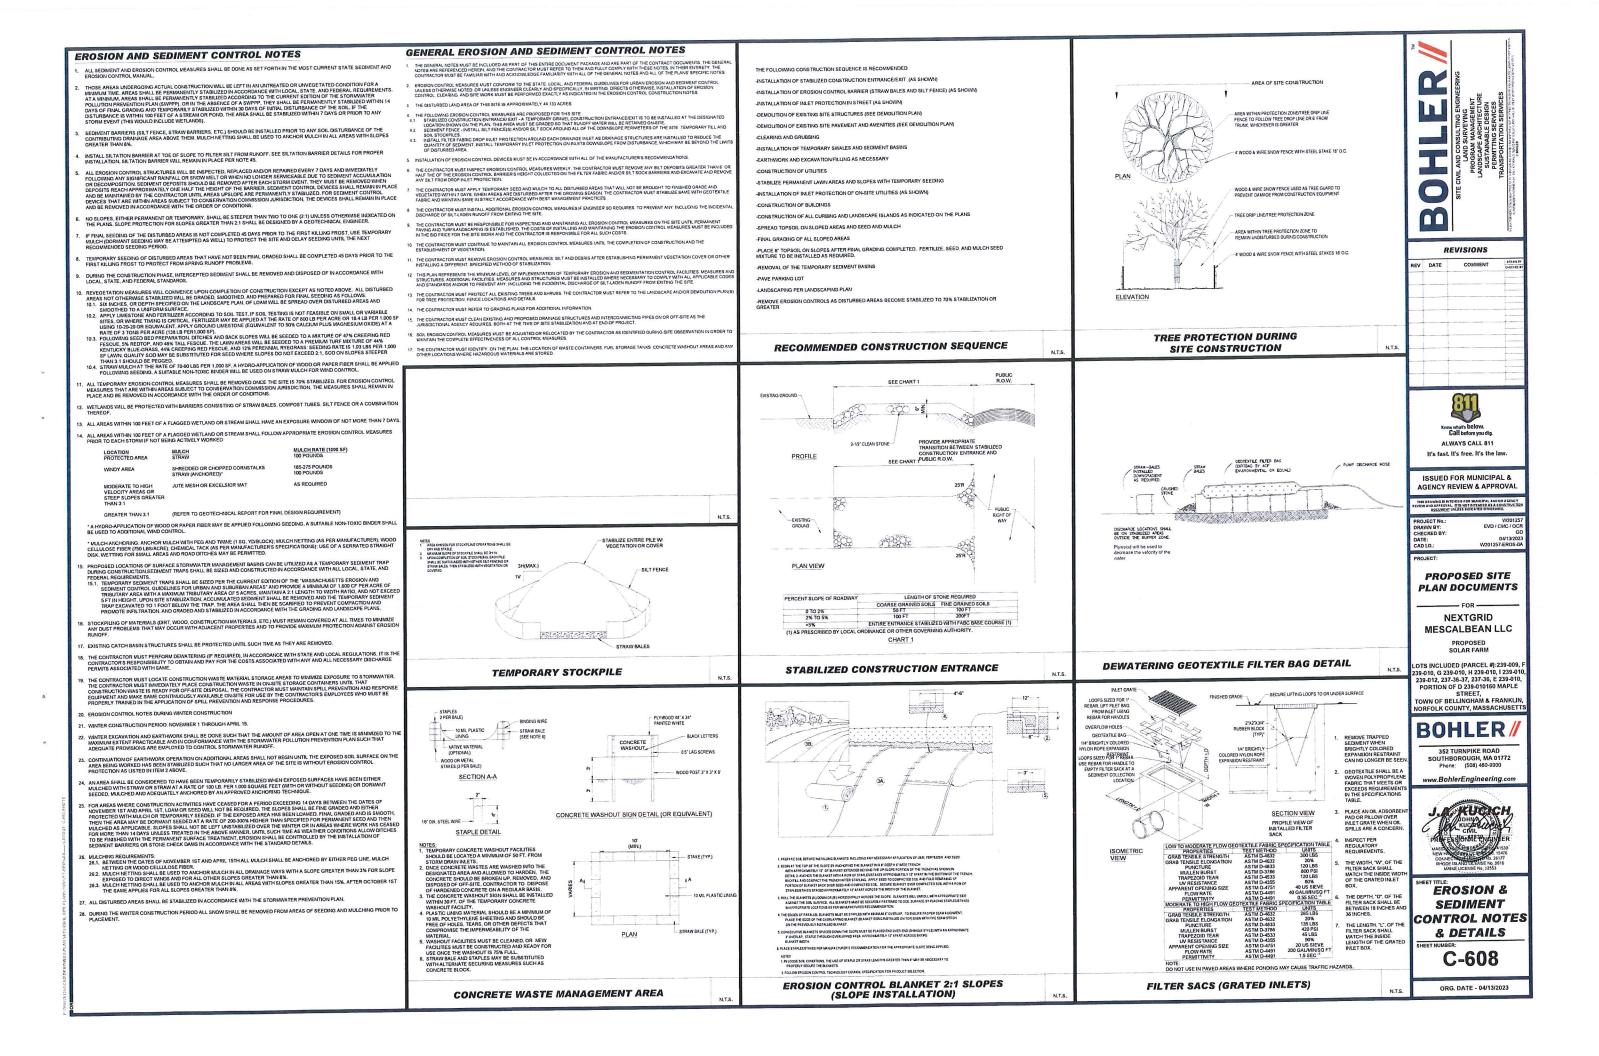

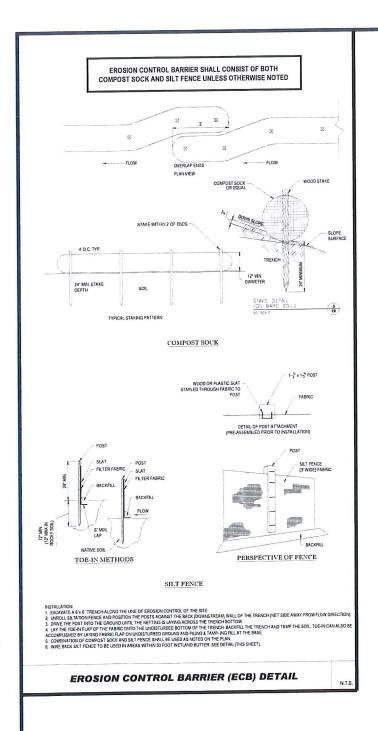



REVISIONS REV DATE COMMENT



ISSUED FOR MUNICIPAL & AGENCY REVIEW & APPROVAL

PROPOSED SITE PLAN DOCUMENTS

NEXTGRID

MESCALBEAN LLC

LOTS INCLUDED (PARCEL #):239-009, F 239-010, G 239-010, H 239-010, I 239-010, 239-012, 237-36-37, 237-36, E 239-010, PORTION OF D 239-010160 MAPLE STREET, TOWN OF BELLINGHAM & FRANKLIN, NORFOLK COUNTY, MASSACHUSETTS




352 TURNPIKE ROAD SOUTHBOROUGH, MA 01772 Phone: (508) 480-9900


www.BohlerEngineering.com





EROSION & SEDIMENT **CONTROL NOTES** & DETAILS

C-609

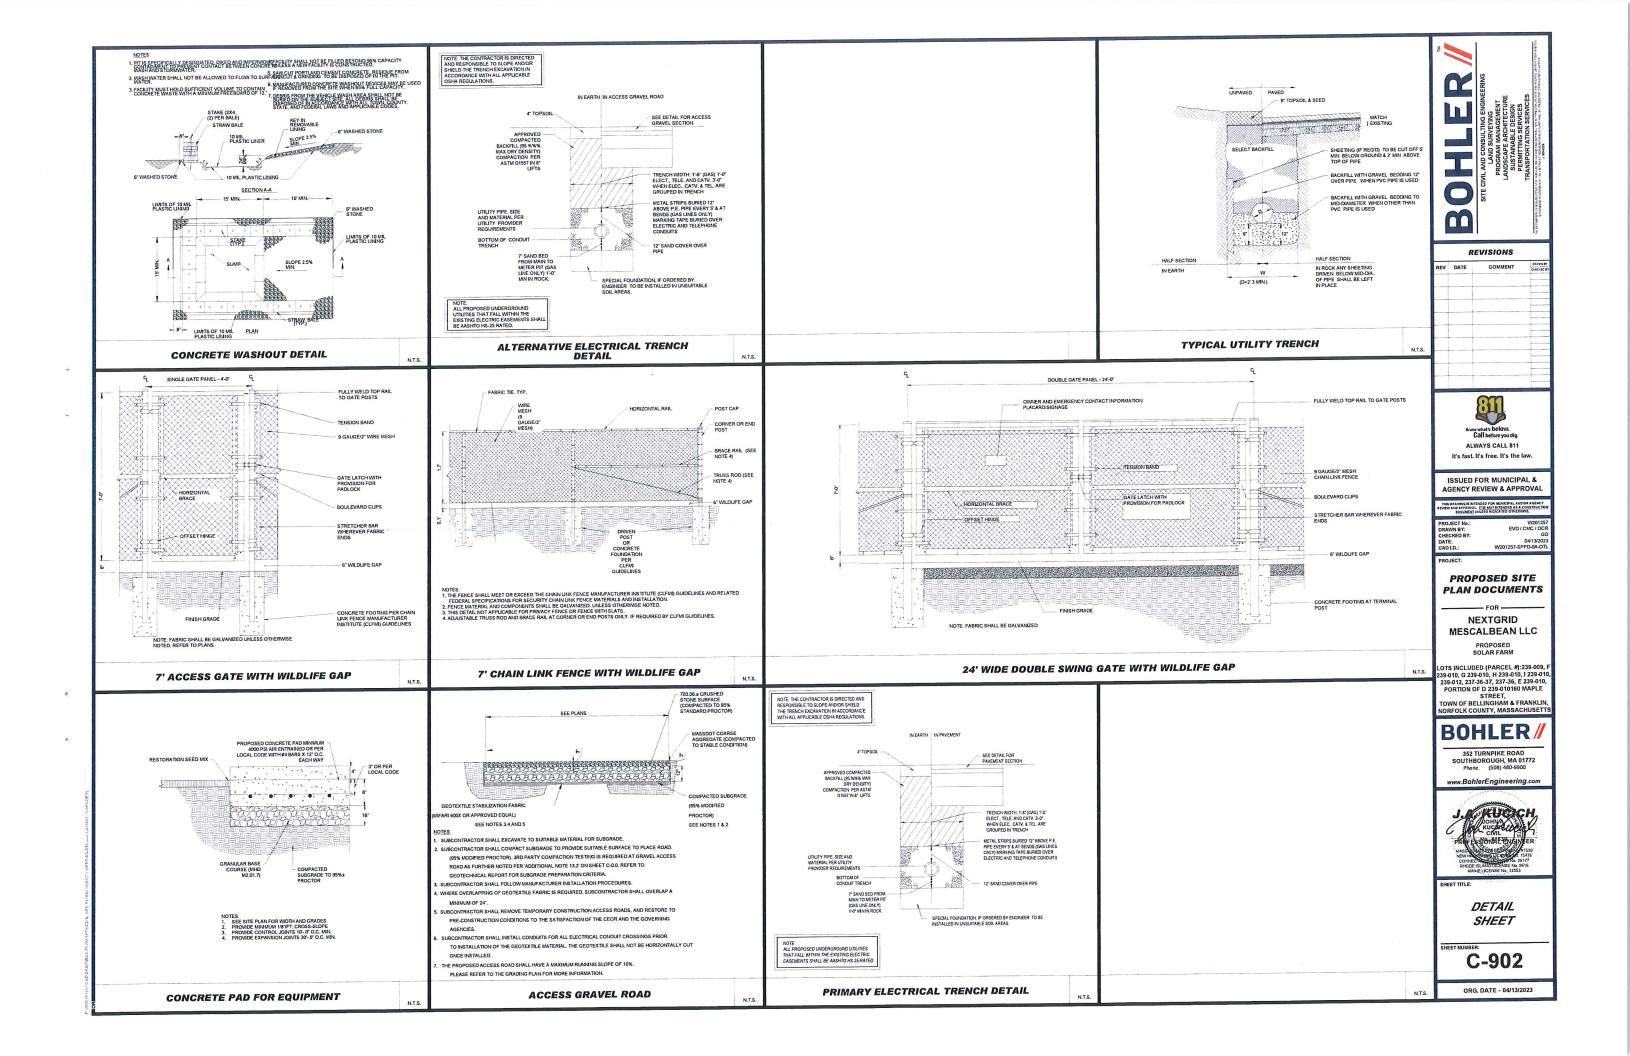

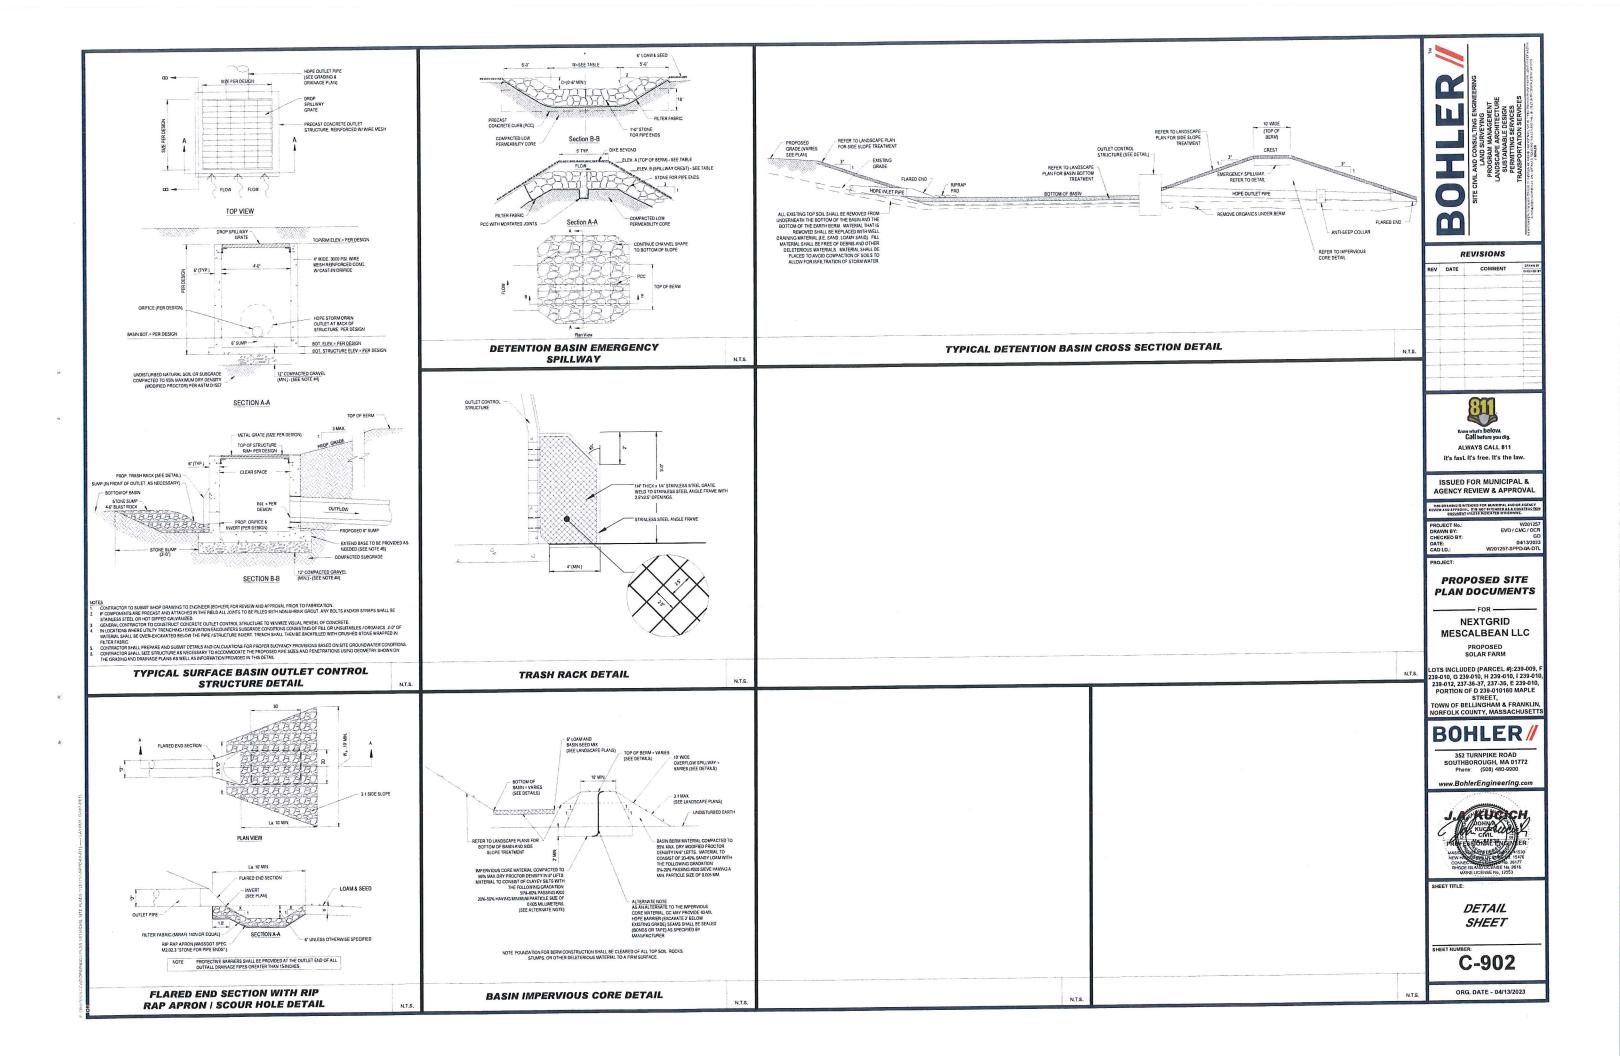

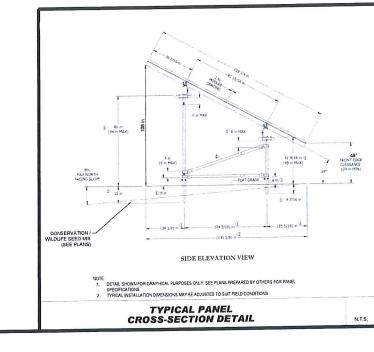

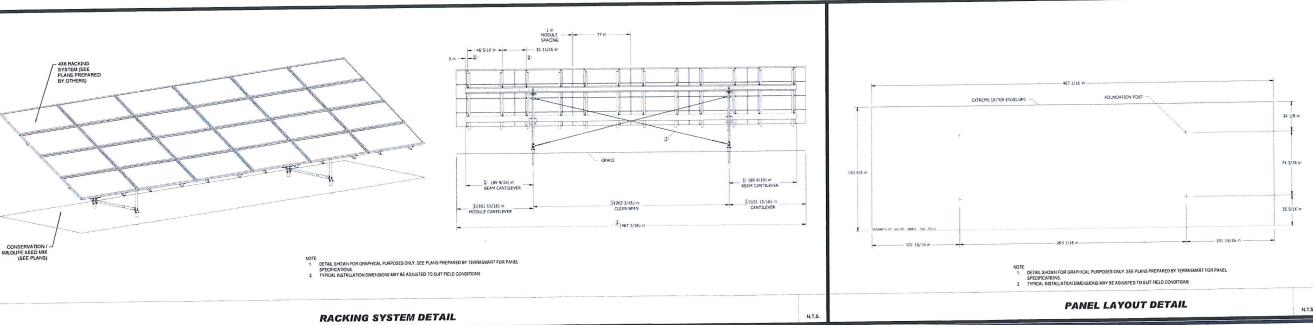



	RE	VISIONS	
REV	DATE	COMMENT	DECISE SI
			-
			1
-			-
			-
	Know	what's below.	

ALWAYS CALL 811 It's fast. It's free. It's the law.

ISSUED FOR MUNICIPAL & AGENCY REVIEW & APPROVAL

04/13/20 W201257-SPPD-0A-D

PROPOSED SITE **PLAN DOCUMENTS**

NEXTGRID MESCALBEAN LLC

LOTS INCLUDED (PARCEL #):239-009, F 239-010, G 239-010, H 239-010, I 239-010, 239-012, 237-36-37, 237-36, E 239-010, PORTION OF D 239-010160 MAPLE STREET, TOWN OF BELLINGHAM & FRANKLIN, NORFOLK COUNTY, MASSACHUSETTS

BOHLER


352 TURNPIKE ROAD SOUTHBOROUGH, MA 01772 Phone: (508) 480-9900

www.BohlerEngineering.com



DETAIL SHEET

C-903

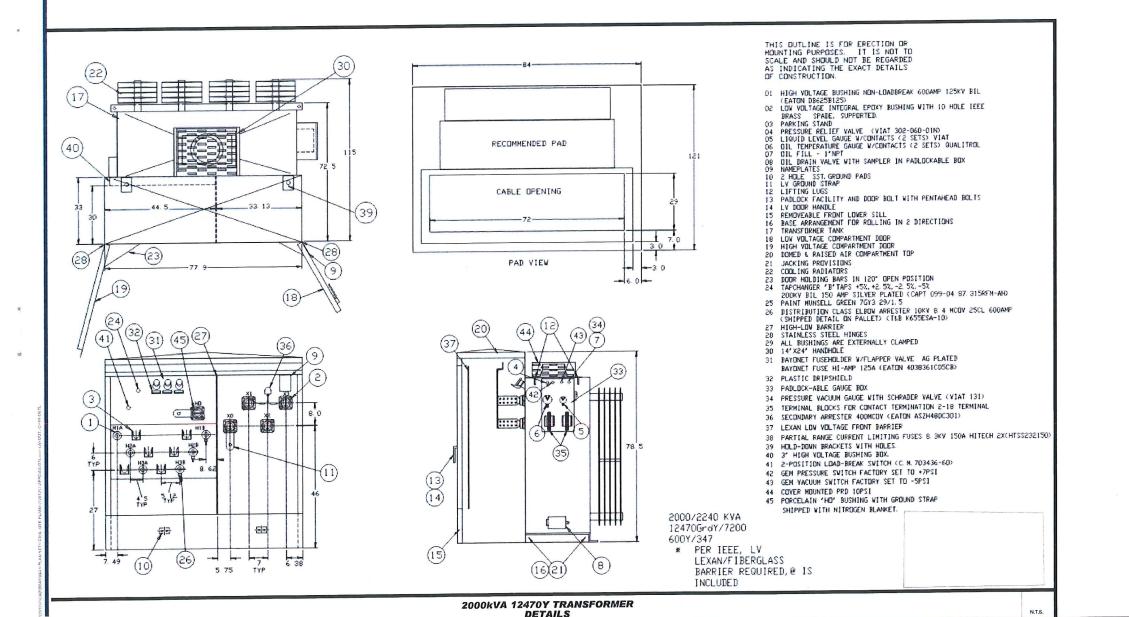



REV DATE COMMENT EMPLOYEES



Call before you dig.

ALWAYS CALL 811

It's fast, It's free, It's the law.

ISSUED FOR MUNICIPAL & AGENCY REVIEW & APPROVAL

THE DRAWING IS INTENDED FOR MUNICIPAL AND OR AGENCY

PROJECT No.: WZO
DRAWN BY: EVD / CMC /
CHECKED BY:

PROJECT

PROPOSED SITE PLAN DOCUMENTS

NEXTGRID MESCALBEAN LLC

PROPOSED

LOTS INCLUDED (PARCEL #):239-009, 239-010, G 239-010, H 239-010, I 239-011 239-012, 237-36-37, 237-36, E 239-010, PORTION OF D 239-010160 MAPLE

STREET,
TOWN OF BELLINGHAM & FRANKLIN,
NORFOLK COUNTY, MASSACHUSETT

BOHLER //

352 TURNPIKE ROAL SOUTHBOROUGH, MA 0 Phone: (508) 480-990

www.BohlerEngineering.com



SHEET TITLE

DETAIL SHEET

SHEET NUMBER:

C-904

Three-phase pad-mounted compartmental type transformer





Three-phase pad-mounted compartmental type transformer

Catalog Data CA202003EN Effective April 2016

Three-Phase 50 or I	O HZ			
KVA Available* 45, 75, 112 5, 150, 22	5, 300, 505, 75	50 1000 1500 2	2000	2509 3900 3750 5000 7509 10000
		The second second		and a set of a set of the set of the control test to meet strength to

	Low-voltage r	ating		
Rating (kVA)	≤ 600 V	2400 & through 4800 &	6900 & through 13500GY/7970 or 13800 I	
45.75	2.70-5.75	2 79-5 75	2 70-5 75	
112.5-300	3 10-5 75	3.10.5.75	310575	
500	435-575	4 35-5 75	435-575	
750-2500	5 75	5.75	575	
3750	5.75	5.75	6 20	
5000		6 00	6.50	

Table 4. Addition booms are	NEMA TR-1 Average	
Self-Cooled, Two Winding kVA Rating	Decibels (d8)	
45-500	46	
501-700	57	
701-1930	56	
1001-1500	60	
1501-2000	61	
2001-2500	62	
7501-3000	€	
2001-4000	64	
\$201-\$600	55	
5001-9200	66	
6001-7500	67	
7501-16050	68	
7501-19000	07	

Table 5. Insulation Test Levels


KV Class	Induced Test 180 or 400 Hz 7200 Cycle	kV Bit Distribution	Applied Test 60 Hz (kV)
12		31	10
2.5		15	15
5		50	19
87	Twice Rated Virtige	75	26
15		35	34
25		125	40
34.5		150	50

Table 6. Temperature Rise Ratings 0-3300 Feet (0-1000 meters)

	Standard	Optional	
Unit Rating (Temperature Rise Winding)	55 C	55 C 55 E5 C 75 C	
Ambient Temperature Max	40 C	50 C	
Ambient Temperature 24 Hour Average	30 C	49 C	
	a) C	65.6	

Catalog Data CA202003EN Effective April 2016

Three-phase pad-mounted compartmental type transformer

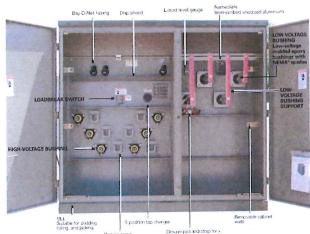

Type	Time Place, 50 or 60 Hz. 65. C. Fise Usb. C. 55:65: D. 65:75 °C. A5 °C			
Fluid Type	Mineral oil or Environamp ^{ass} (ROPM hord			
Coil Cooligoration	2-winding or 4-winding or 3-winding (Love-High-Love), 3-winding (Love-Love-High-			
Size	45 - 10,000 IVA			
Primary Voltage	2.400 - 45,900 V			
Secondary Voltage	7(81)/126 V to 14,400 V			
	Inverter/Best Far Bridge			
	K Factor jop to K-19s			
	Vacuum Facit Interruptor (VF1)			
	UE* Lotted & Labelled and Characters			
Specialty Designs	Factory Michael FrMtj Approved*			
1 2 2	Setar/Wind Designs			
	Differential Protection			
	Service Applications (calading 05HPD)			
	Hardword Data Compr			

Catalog Data CA202003EN Effective April 2016

Three-phase pad-mounted compartmental type transformer



65° Rise		RONT-LOC								Gallens of	Approx. Total
kVA Rating	A*	8	C	D	E	F	G	н		Fluid	
15	50	- 68	39	42	26	63	72	43	20	110	2,100
75	50	F8	19	27	75	65	72	43	No	115	7.750
117.5	50	68	19	27	26	69	72	51	70	170	7.350
150	30	66	49	47	25	-17. 63	72	53	26	125	2.700
725	70	72	51	42	30	77	75	55	25	149	3.150
	50	72	E1	6.7	30	72	76	55	20	150	3.650
300	50	- 12	53	42	30	72	93	57	70	1(3)	4,650
50)		89	5/	47	30	77	53	- 51	70	770	6.500
150	64		50	47	30	72	61	53	200	250	8,700
1000	54	89	25	12	20	72	93	30	74	4.0	10.300
1500	73	. 23			30	- 77	76	31	26	130	12.500
2000	13	n	31	12		72	76	103	78	5200	14.500
2500	72	72	99	47	30	84	163	103	74	626	16,700
3000	73	84	99	45	27			112	24	660	19.300
3750	84	65	108	47	39	85	RS /		74	531	75.00
5000	St	36	108	49	48	9.	100	112		1500	41,900
7500	91	102	122	54	48	107	100	176	24	130	41,330

Table 8 Fluid-Filled - Copper Windings 55/65 °C Rise

65" Rise				AL FEED-B	AYO NET FL	JSING OIL F	ILED-COP	PER WINDIA	GS		
	OUTLIN	E DIMENSI								— Gallons of	Approx. Total
kVA Rating	A.	8	С	D	E	-	g	43	20	110	2.100
15	90	64	39	34	3)	61	69			115	7.350
75	50	- 51	39	34	20	61	66	43	70		7500
1125	50	64	14	34	70	64	.69	53	29	115	
150	50	64	49	34	30	64	69	53	70	120	2.700
725	50	64	51	34	30	64	73	- 55	79	140	3.790
300	50	64	5)	34	30	64	75	55	70	160	3,500
500	50	31	53	34	30	64	85	57	29:	200	4.800
150	54	89	57	17	31	72	92	- 61	70	255	6.500
		99	59	12	30	72	93	63	20	300	790
1000	73	29	96	47	30	12	93.	9)	74	410	19.306
1503		77	N.	12	30	72	76	91	24	470	11,600
2000)	73			47	30	77	76	103	24	500	14 (80)
2500	73	772	33		37	22	23	100	74	720	15,700
3003	73	81	99	46			60	117	74	830	29.500
3750	31	35	108	47	38	85			74	850	25.600
5000	84	95	108	28	15	96	100	112		1,620	45 900
75(0)	94	102	121	54	49	107	100	128	14	1 Keli	49.900

REVISIONS



ISSUED FOR MUNICIPAL & AGENCY REVIEW & APPROVAL

REMEWAND APPROVAL. I	DED FOR MUNICIPAL AND/OR AGENC IS NOT INTENDED AS A CONSTRUC LESS INDICATED OTHERWISE.
PROJECT No.:	W201
DRAWN BY:	EVD / CMC / C
CHECKED BY:	
DATE:	04/13/2
CAD I.D.:	W201257-SPPD-0A-

PROPOSED SITE **PLAN DOCUMENTS**

NEXTGRID MESCALBEAN LLC

PROPOSED SOLAR FARM LOTS INCLUDED (PARGEL #):239-009, F 239-010, G 239-010, H 239-010, I 239-010, 239-012, 237-36-37, 237-36, E 239-010, PORTION OF D 239-010160 MAPLE STREET, TOWN OF BELLINGHAM & FRANKLIN, NORFOLK COUNTY, MASSACHUSETTS

BOHLER

352 TURNPIKE ROAD SOUTHBOROUGH, MA 01772 Phone: (508) 480-9900



DETAIL SHEET

C-905



For Child States


9


eocopouer:

CABIOGO/AC

0

AUTHORNOOM

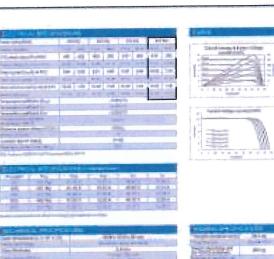

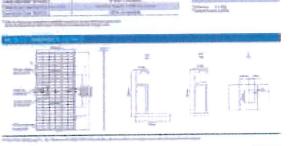

There are not set of

epc**power**



- pick, plos, per-littly lender coming the or Stormer wheel transmitted in his garment has - E.S. Filled Treasure, at \$4,400-1000 files fromity Florida Balle Autoritoritiero

water or the law is sensited the stops in the day but but Assessmentation (IV), Carlot Mediument or Compression loggi vienamai inime developes all lies transposeme

- Americanical Lags franciscos en emperatura súgo moneros

tion of a fairment to billion for each on belonded

- Learnest production for Larger Yougan me in



1500V Disconnect Combiners

ervend'y thurs must Comit har print as any legach on a consignation of the community of the community of a community of a community of the complex of the co

maniki wili ganimini yenen. - mpatini ni partini ni ganimini viti tutai ni ma mpi mini mingi ma Mulana, ki ni ginimini tutu patina pali tutu mbati sataji kum mpiatini



ConnectPV reduces electrical BOS project costs by simplifying:

Regulation - Opposition - Oppos

Sprint	gutten	necession .		december	Total Control	Manne	dynamic
Appet Inspets	(Interested (Interested on proposable)	Special Splice : Special	(fisher) Ages	destrict d (food) portract	estenie Horolos polos	protein d'éland parteng	Sizen-Ell Placipleso Stationi
59	200		kerits	Smire4	Albumork	destion:	Assetsá
All:	100	674.00	Stork	26068	JANUARY.	NUMBER	3510000
100	100	MINI		Madel	Books	201020	Brems.
29	800	Copper	100	Total	Station	Northead	Steman
100	69		-	Bissins	SECTION 2	Bholmid	Statement .

W	Tipology	JOSEP Discovered Marry	Strong Cases	And State Serving	tor distribute Eyes
Fire Transact	O-Gracies Furbules	\$1854.328/L0 4065	1400	55-28 16/Cuptor	in - Campa Nen Mr-Abegien*

ABOUT CONNECTBY INC.

Man Cape III



- Particular Laborator Street - James for processor per self-Lauring or miner teld, Responsement

Predict Disfers

-(haz) e)bi lurga Pharachia Santro

Married Road on London Petrological Warrants



CABIDGG/DC

Midlrectional DC-DC

0

REVISIONS COMMENT

811

PROPOSED SITE **PLAN DOCUMENTS**

- FOR -NEXTGRID

MESCALBEAN LLC

OTS INCLUDED (PARCEL #):239-009 19-010, G 239-010, H 239-010, I 239-0 239-012, 237-36-37, 237-36, E 239-010 PORTION OF D 239-010160 MAPLE

BOHLER/

352 TURNPIKE ROAD OUTHBOROUGH, MA 01772

www.BohlerEngineering.com



DETAIL SHEET

C-906


ORG. DATE - 04/13/2023

PHOTOVOLTAIC PANEL SPECIFICATIONS

N.T.S.

Know what's below. Call before you dig. ALWAYS CALL 811 It's fast It's free. It's the law. ISSUED FOR MUNICIPAL & **AGENCY REVIEW & APPROVAL** TOWN OF BELLINGHAM & FRANKLIN NORFOLK COUNTY, MASSACHUSETT

Mary Call

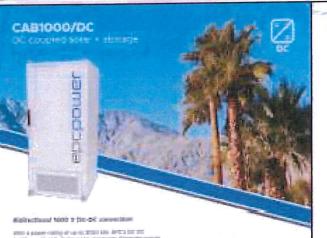

emit 4 plane-rating at an or Minist limit from the Com-traction rating in declarated by processing from the com-lete growth for the Community Systems.

that 2.0 The authoritation are principalities with a write toward of 2.5 measures. Infliending pain force (IIIIa) of above the order painting and according to the according toward according to the according towards and according towards according to the according towards and according towards according towards and according towards and according towards according towards according towards according to the according towards according towards according to the according towards according towards according to the according to the according towards according to the according to the

- A special Symmetric for a detail
 Introduct for a special state of polaries
 respect for a special structure reasoning of polaries
 they for town
 Inger special for present decrease

ebcbomer |

BOD Y DO OC Ann OC March

Preven products. Limitain programmes epopawar :

1005 Tilestone in... 5,46 (0) (Provincia 2006 (1306 PHI 2001) representative



M-Force™ three-phase switch



discount to

Solid Elielectric, Independent Pale Option Recions

Providing electronic insertament production for single or three phase operation on systems rated through 380%.

6004 continuous current, 12-St-Acor 16k/Linterropting

Depresent or artist faith street ... and postered

Mandagating Estimates in 1968 (from agri ETRE).
 Openhaud, solicitation and described?

of valid and an experience of the following

Name and Post Address of the Owner, Williams

Marriesson for their stockur. lick increased Assessment without present

· do that lettered orbigo receive

NUMBER OF STREET, STRE

antonial dedon




Danson From Character 874

State or design



These 12 forces from the months describe

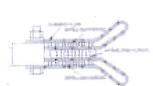


Great first motors.

included by the control of the regulator in the first of the control of the regulator in the control of the regulator in the control of the c

into account for the side productions will be about the second of the se

Jacobson Sciences et application recommender for communication (application) and analysis deliberation and a forest communication for communication (application) and total long speech (application) and a forest communication (application) and

Midnagations please such it

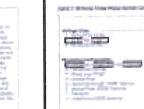



Commission (Salas (Contribution State)



MIN HI HI T HI 2



Ministermen phase exists

REVISIONS DEV DATE COMMENT

0





It's fast, It's free, It's the law. ISSUED FOR MUNICIPAL &

AGENCY REVIEW & APPROVAL

PROPOSED SITE **PLAN DOCUMENTS**

NEXTGRID MESCALBEAN LLC

LOTS INCLUDED (PARCEL #):239-009, 239-010, G 239-010, H 239-010, I 239-010, 239-010, 239-010, 237-36, E 239-010, PORTION OF D 239-010160 MAPLE STREET. TOWN OF BELLINGHAM & FRANKLIN

NORFOLK COUNTY, MASSACHUSETT **BOHLER**/


352 TURNPIKE ROAD OUTHBOROUGH, MA 01772 Phone: (508) 480-9900

www.BohlerEngineering.com



DETAIL SHEET

C-907

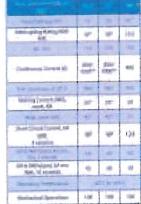

	Charles of the Control of the Contro
ine.	national day or high from
	THE RESERVE OF THE PARTY OF

-	Charles and Sandal Print
DE .	notwork to an infinite
	STREET, STREET

Management and the material or receive the best of contract the best of contract the best of the contract the contract the best of the contract the contract the best of the contract the contract

SEL-651R


Advanced Recloser Control




The industry's gold standard for reclaser control

- Advanced reclaims promother promothers assessed constraints high-special fixed mutation must remove been
- and increases referrible methods. has been a belowing transport a discreping and recommen
- too address depend to morney newbotters. had sapiding depotitor, pression surviventionion, and BIE 1547 (1506 Indigates left your publicy interconnect distributed manage transportation (CCI) in
- Secure has more blacking payored promorroid obstants

SEL

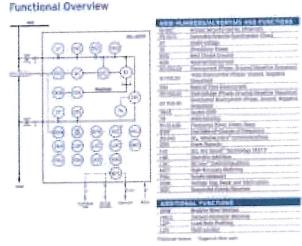

Emmers to the Wilds
Fig. 1. If the Section of the S

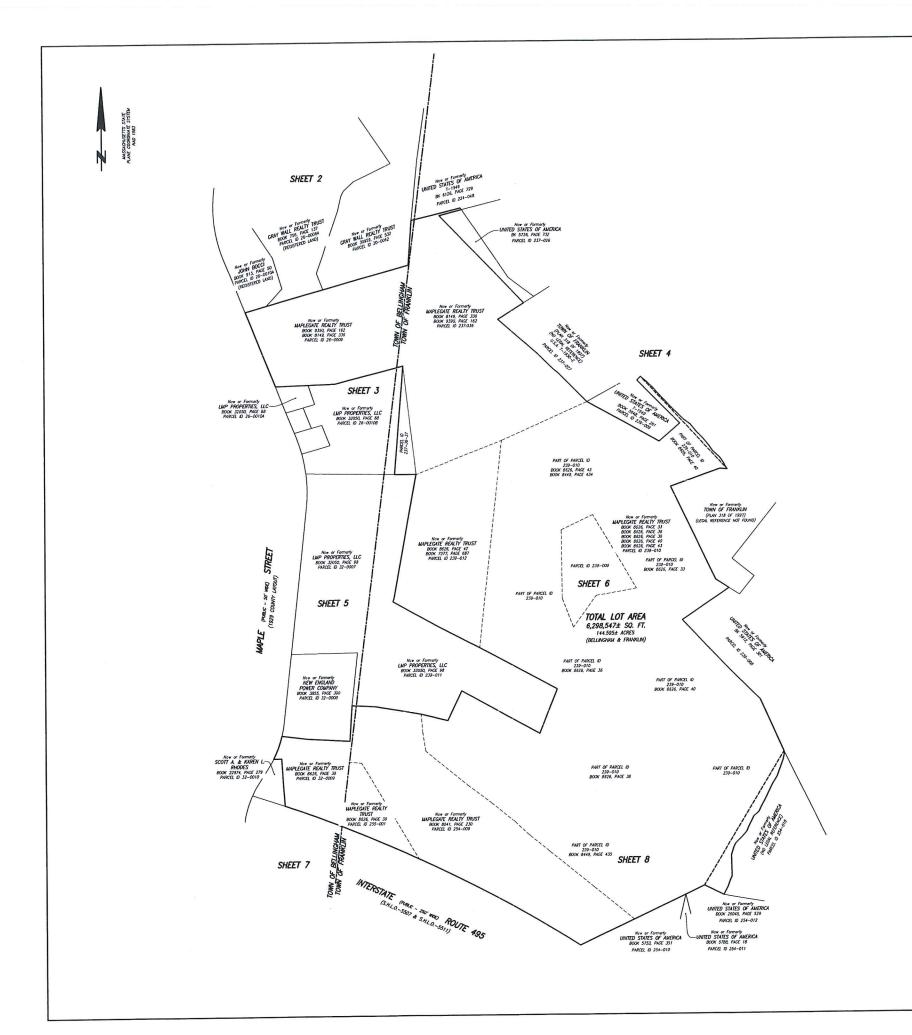

MOTES:

1) BENCH WER INFORMATION:

ELEVATIONS ESTABLISHED FROM CPS OBSERVATIONS TEMPORARY BENO-MARKS SET

TRU-ECT: TOP OF MIC NAL SET IN ASPHULI CAPI PAIM AS SHOW MEREON (SEE SMEET 4 REPARCH-218.32

IBM-ECTI: TOP OF MAG NAR SET IN ASPHULT CART PATH AS SHOW MEREON (SEE SMEET 4 ELEVATION-241 05

2) ELEVATIONS REFER TO NORTH AMERICAN VERTICAL DATUM OF 1988 (NAVOSS)

2) ELEMBOS RETE TO MORTH AMERICA VARIOU, MIND OF 1982 (MINDS)

3) COMING RETEX (DALE ON C) (1) COMMINING MORTH (LE RITHM & 10°C X*

1) COMING RETEX (DALE ON C) (10°C DE ANNUL ROUTE (TOO MOR) 10°C

1) AN AREA WHOM THE IT COMPLE ANNUL ROUTE (TOO MOR) 10°C

1) AN AREA WHOM THE IT COMPLE ANNUL ROUTE WITH MORT (TOO DALE)

1) COMPLETE ANNUL ROUTE (IT IN IN) (10°C MORTE COMPT.

MISCONSTITE (MIL ARROTTONS) WE MANEET 25271(CODDIL, MINTOL MITCH OF ANY IT TO AN

OFFICIAL ONL OF ACT IN AND.

3 PER SOCIALISTS OF A MISTINGARY OF SERVICE OF FILDMIN LING SERVICES (SERVICE OFFICIAL SERVICE) OFFICIAL SERVICE OFFICIAL OFFICIAL SERVICE OFFICIAL OFFICIAL SERVICE OFFICIAL OFFI CAN FILINGARY OFFI CONTROL SERVICE OFFI CONTROL SERVI

THE WETLAND AREAS SHOWN HEREON WERE DELINEATED BY LEC ENVIRONMENTAL DURING FEBRUARY AND MARCH OF 2022.

UTODO

UTUTY POLE
LOUT POLE
MITTALE
MI TO DE STATE OF STATE

FELDMAN

BOSTON HEADQUARTERS 152 HAMPDEN STREET BOSTON, MA 02119

WORCESTER OFFICE 27 MECHANIC STREET WORCESTER, MA 01608 (617)357-9740 www.feldmangeo.com



I CERTIFY THAT THIS PLAN IS BASED ON AN ACTUAL FIELD SURVEY AND THE LATEST PLANS AND DEEDS OF RECORD.



TWOTH' R ACURKS, PLS DATE (MJ 52782)
MOURKS OFFLOUNNEED COU




MAPLEGATE COUNTRY CLUB BELLINGHAM, MASS. FRANKLIN, MASS.


ESEARCH: SPP	FIELD CHIEF: EC
ROU MOR: TRA	APPROVED: TRA
ALC: SPP	CADO: SPP
ELD CHK:	CRD FILE: 220001
REVISIONS:	

DRAFT 5/09/2022

EXISTING CONDITIONS PLAN

DATE: APRIL 11, 2022

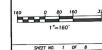

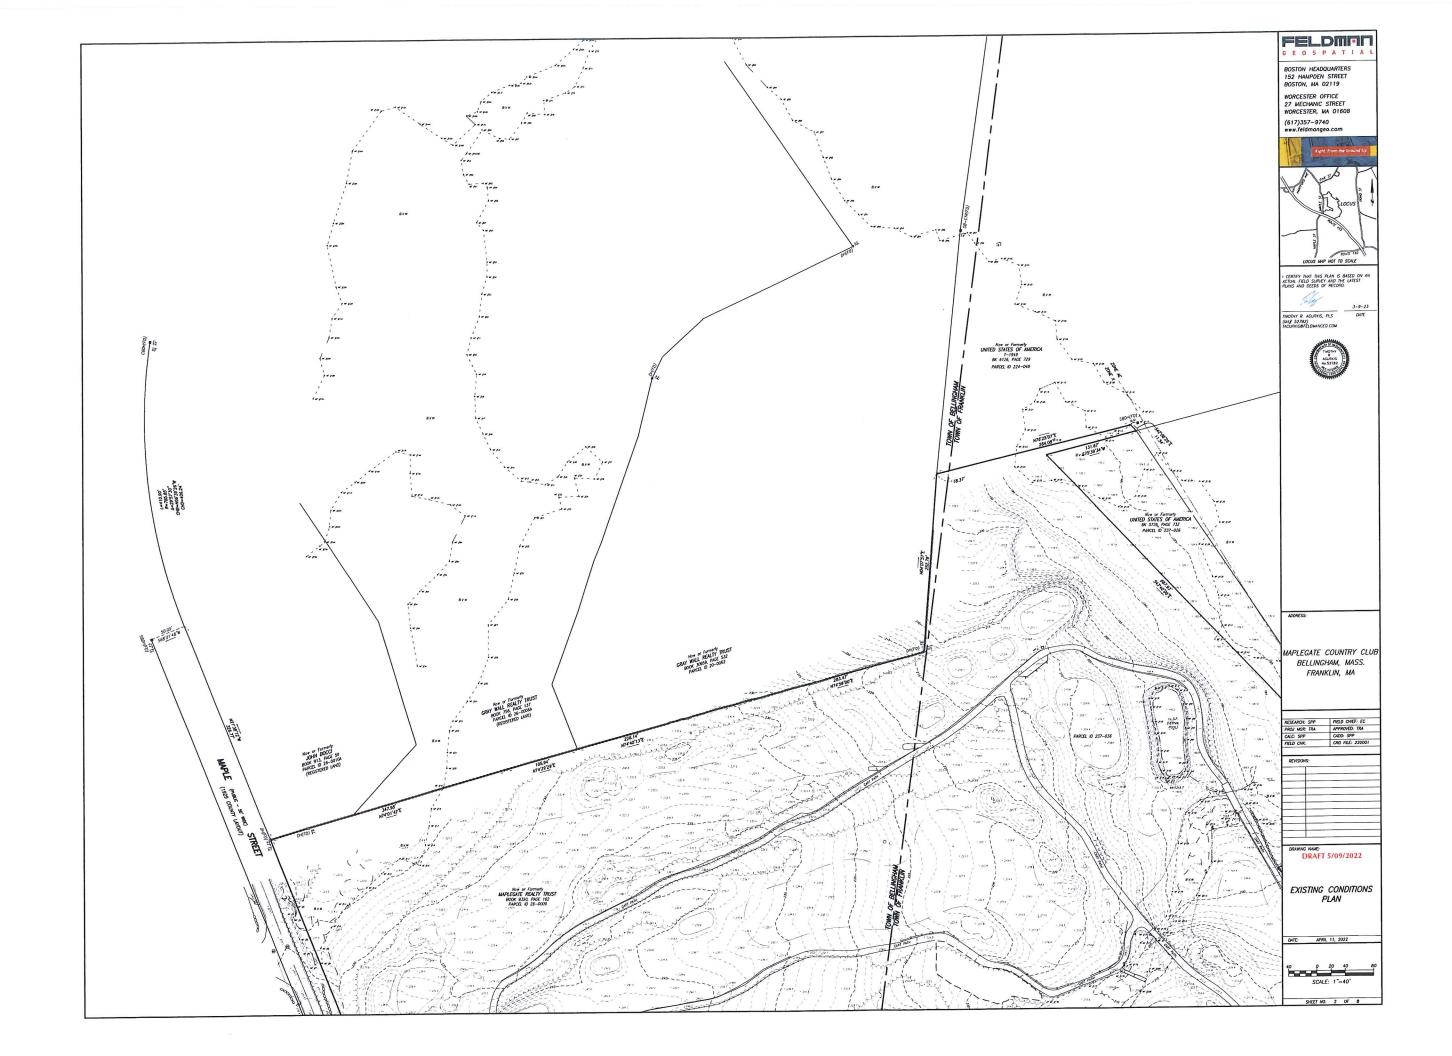


9

P




B 17 14

71

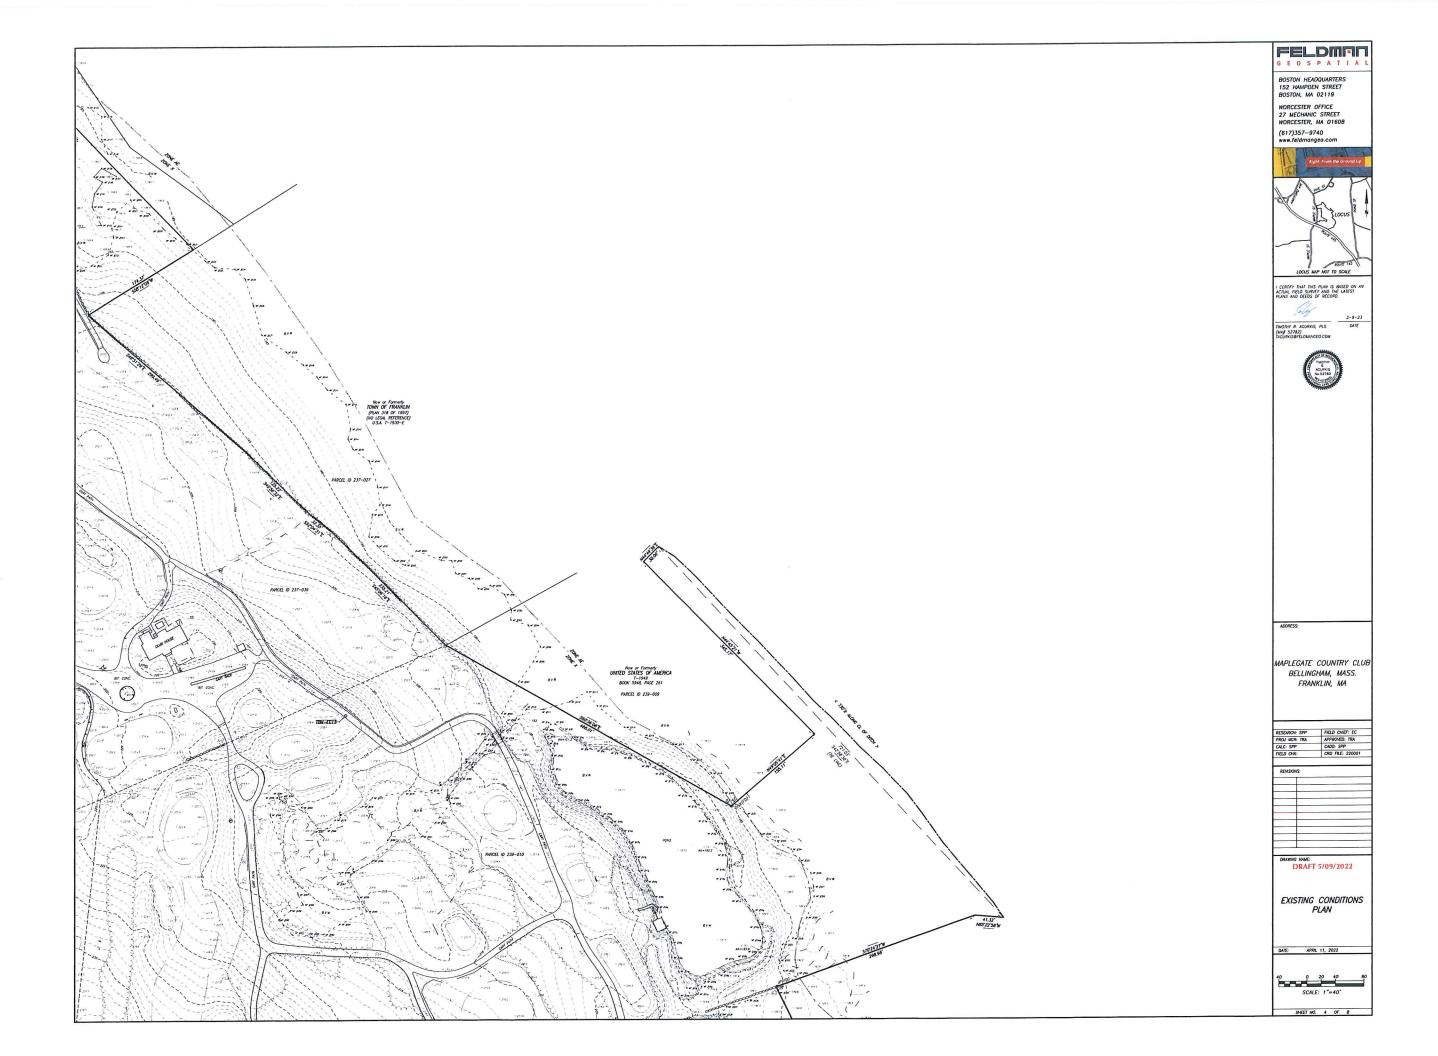



· ·

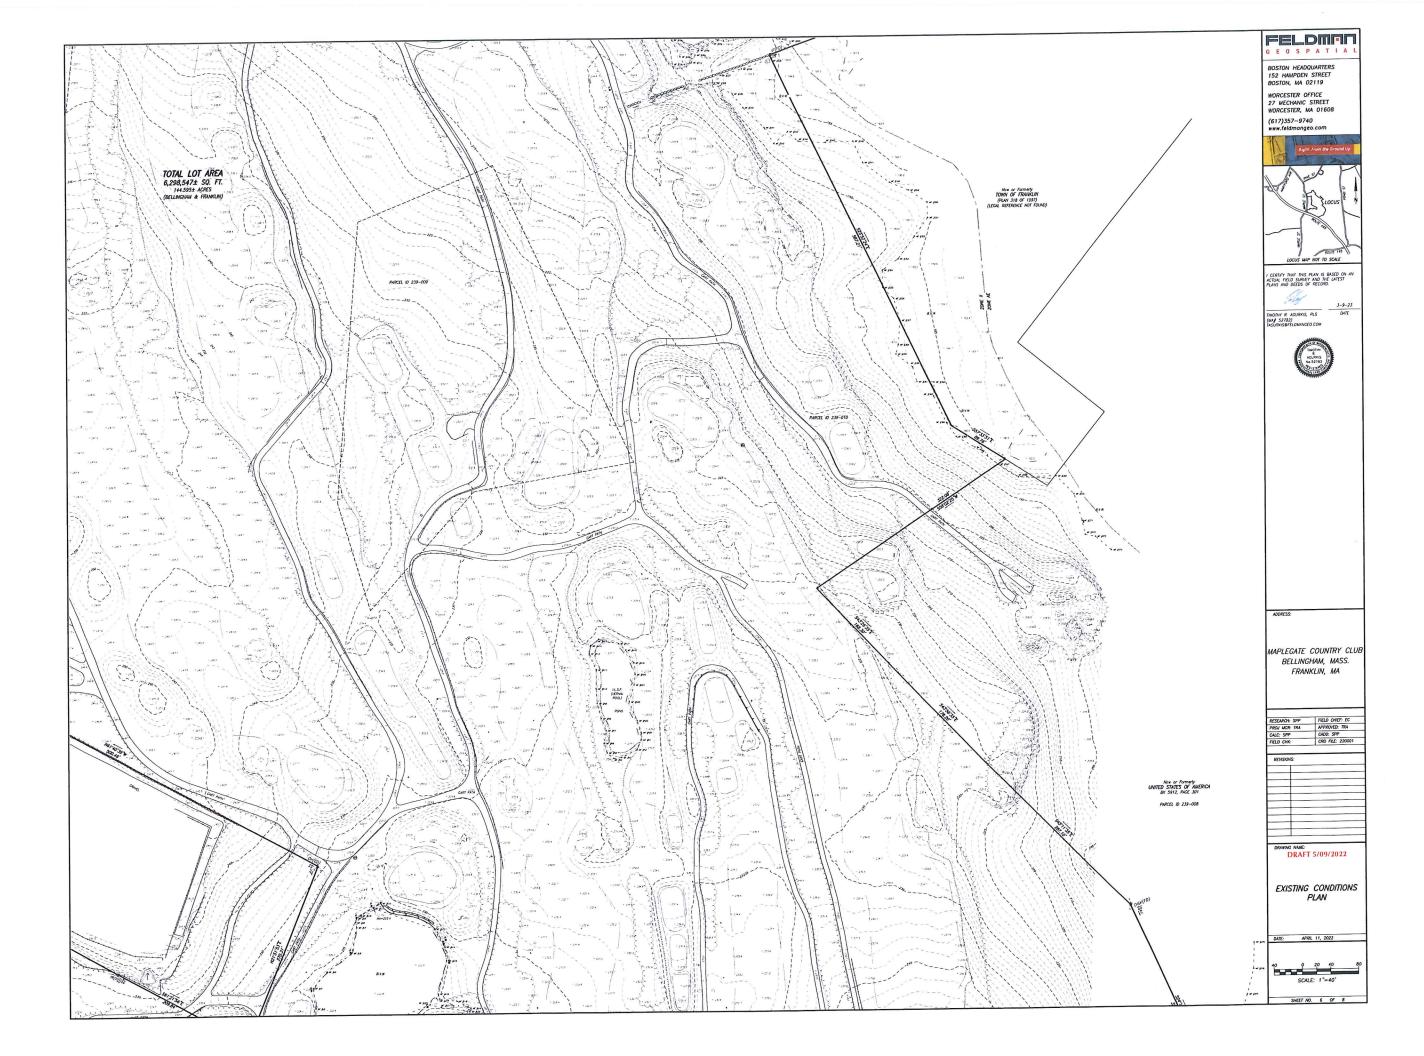

W 150



0 0