
SITE PLAN 70, 72 AND 94 EAST CENTRAL STREET

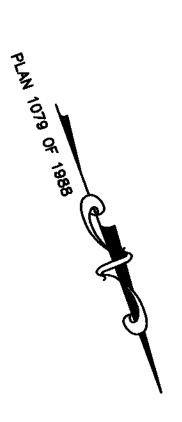



- ALL EROSION CONTROL MITIGATION MEASURES SHALL BE IN PLACE PRIOR TO MAJOR CONSTRUCTION OR SOIL DISTURBANCE COMMENCING ON THE SITE.

WAIVER REQUESTS: 1. TO ALLOW LESS THAN 42" OF COVER OVER THE RCP DRAIN PIPE. PROPOSED CLASS V RCP. 2. TO ALLOW THE USE OF HPDE PIPE FROM CATCH BASIN 92 TO THE POND, FROM THE POND TO DRAIN MANHOLE 93, FROM THE TRENCH DRAIN TO DRAIN MANHOLE 91 AND THE ROOF LEADER COLLECTION SYSTEM TO THE POND.

CARLOS A. QUINTAL P.E. #30812

SITE PLAN APPROVAL REQUIRED FRANKLIN PLANNING BOARD

DATE

GRAPHIC SCALE 1 inch = 100 ft.

NO.	DATE	DESCRIPTION	_	BY	
			_		
			_		
			_		

ZONING:

DATE

1/20

1/20

FIELD BY:

CALCS BY:

DESIGNED BY:

DRAWN BY:

CHECKED BY:

FIELD BOOK PG#

INT.

RRG

RRG

COMP

94 EAST CENTRAL STREET PROPERTY IS LOCATED WITHIN A COMMERCIAL I ZONE.

	REQUIREMENTS:	EXISTING	PROPOSED
DOWNTOWN CO	•		
AREA:	5,000 S.F.	66,535± S.F.	66,535± S.F.
FRONTAGE:	50'	186.07' & 49.02'	186.07' & 49.02'
DEPTH:	50*	268'	268'
HEIGHT:	3 STORIES - 40' *15	2 STORIES	4 STORIES - 49.5'
WIDTH:	45'	>45'	>45'
COVERAGE -			
STRUCTURES:	80%	9.1%	25.2%
STRUC. & PAV	ING: 90%	42.7%	64.8%
SETBACKS-			
FRONT:	20' *1	161.2'	148.8'
SIDE:	10' * 14	24.6'	14' & 14.5'
REAR:	15'	35.5'	16'

*1 - BUT NO NEW STRUCTURE SHALL BE REQUIRED TO PROVIDE A DEEPER YARD THAN EXISTED ON THAT PARCEL UPON ADOPTION OF THIS AMENDMENT. *14 - THE 10-FOOT SIDE SETBACK IS ONLY REQUIRED ON ONE SIDE OF THE LOT; IF LOT ABUTS A RESIDENTIAL DISTRICT, A 20-FOOT SETBACK IS REQUIRED ON THE ABUTTING SIDE. *15 - BUILDINGS UP TO 50 FEET IN HEIGHT, REGARDLESS OF THE NUMBER OF STORIES, MAY BE PERMITTED BY A SPECIAL PERMIT FROM THE PLANNING BOARD.

REQUIREMENTS FOR 94 EAST CENTRAL STREET ZONE COMMERCIAL 1
EXISTING AND PROPOSED LOT AREA, FRONTAGE, DEPTH, WIDTH AND COVERAGE BASED ON THE LOTS BEING COMBINED.
BUILDING HEIGHT, AND SETBACKS BASED ON PROPOSED BUILDING LOCATED ON 94 EAST CENTRAL STREET.
THE PROPERTY IS NOT LOCATED WITHIN A FRANKLIN WATER RESOURCE DISTRICT.
THE PROPERTY IS LOCATED IN A ZONE C BASED ON FEMA FIRM MAP 25021C0309E DATED JULY 17, 2012.

94 EAST CENTRAL STREET: EXISTING BUILDING USE RESIDENTIAL. PROPOSED BUILDING USE MIXED WITH RESIDENTIAL.

DRAWING INDEX:

- 1. COVER SHEET
- 2. EXISTING CONDITIONS PLAN
- 3. SITE LAYOUT PLAN
- 4. SITE GRADING AND UTILITY PLAN
- 5. SITE PLANTING PLAN
- 6. EROSION CONTROL PLAN
- 7. CONSTRUCTION DETAILS
- 8. CONSTRUCTION DETAILS
- 9. CONSTRUCTION DETAILS
- SITE LIGHTING-LIGHTING PLAN.
- PHOTOMETRICS AND SCHEDULES
- BY SK & ASSOCIATES

MAP 286 PARCELS 32 AND 34 ARE TO BE COMBINED. MAP 286 PARCEL 33 HAS A PROPOSED EASEMENT FOR ACCESS AND UTILITIES.

REFERENCES: ASSESSORS MAP 286 PARCEL 32 DEED BOOK 36860 PAGE 516 **DEED BOOK 35983 PAGE 116 DEED BOOK 24648 PAGE 492** PLAN 108 OF 1908 PLAN 576 OF 1900 OWNERS PLAN OF LAND BY GUERRIERE AND HALNON, INC. DATED OCTOBER 22, 2018 PLAN 3334 OF 1913 PLAN 853 OF 1928

> MAP 286 PARCELS 32 AND 34 70 EAST CENTRAL STREET, LLC 37 EAST CENTRAL STREET FRANKLIN, MASSACHUSETTS

OWNER MAP 286 PARCEL 33 JOHN AND CARMEL SHERRY 88 EAST CENTRAL STREET

APPLICANT: 70 EAST CENTRAL STREET, LLC 37 EAST CENTRAL STREET FRANKLIN, MASSACHUSETTS

COVER SHEET 70, 72 AND 94 EAST CENTRAL STREET FRANKLIN, MASSACHUSETTS


PREPARED FOR 70 EAST CENTRAL STREET, LLC 37 EAST CENTRAL STREET FRANKLIN, MASSACHUSETTS JANUARY 10, 2020 SCALE: 1" = 100'


·NITED ONSULTANTS 850 FRANKLIN STREET SUITE 11D


SHEET WRENTHAM, MASSACHUSETTS 02093 508-384-6560 FAX 508-384-6566


1" = 100'PROJECT UC1334 1 of 9

JAN. 10, 2020

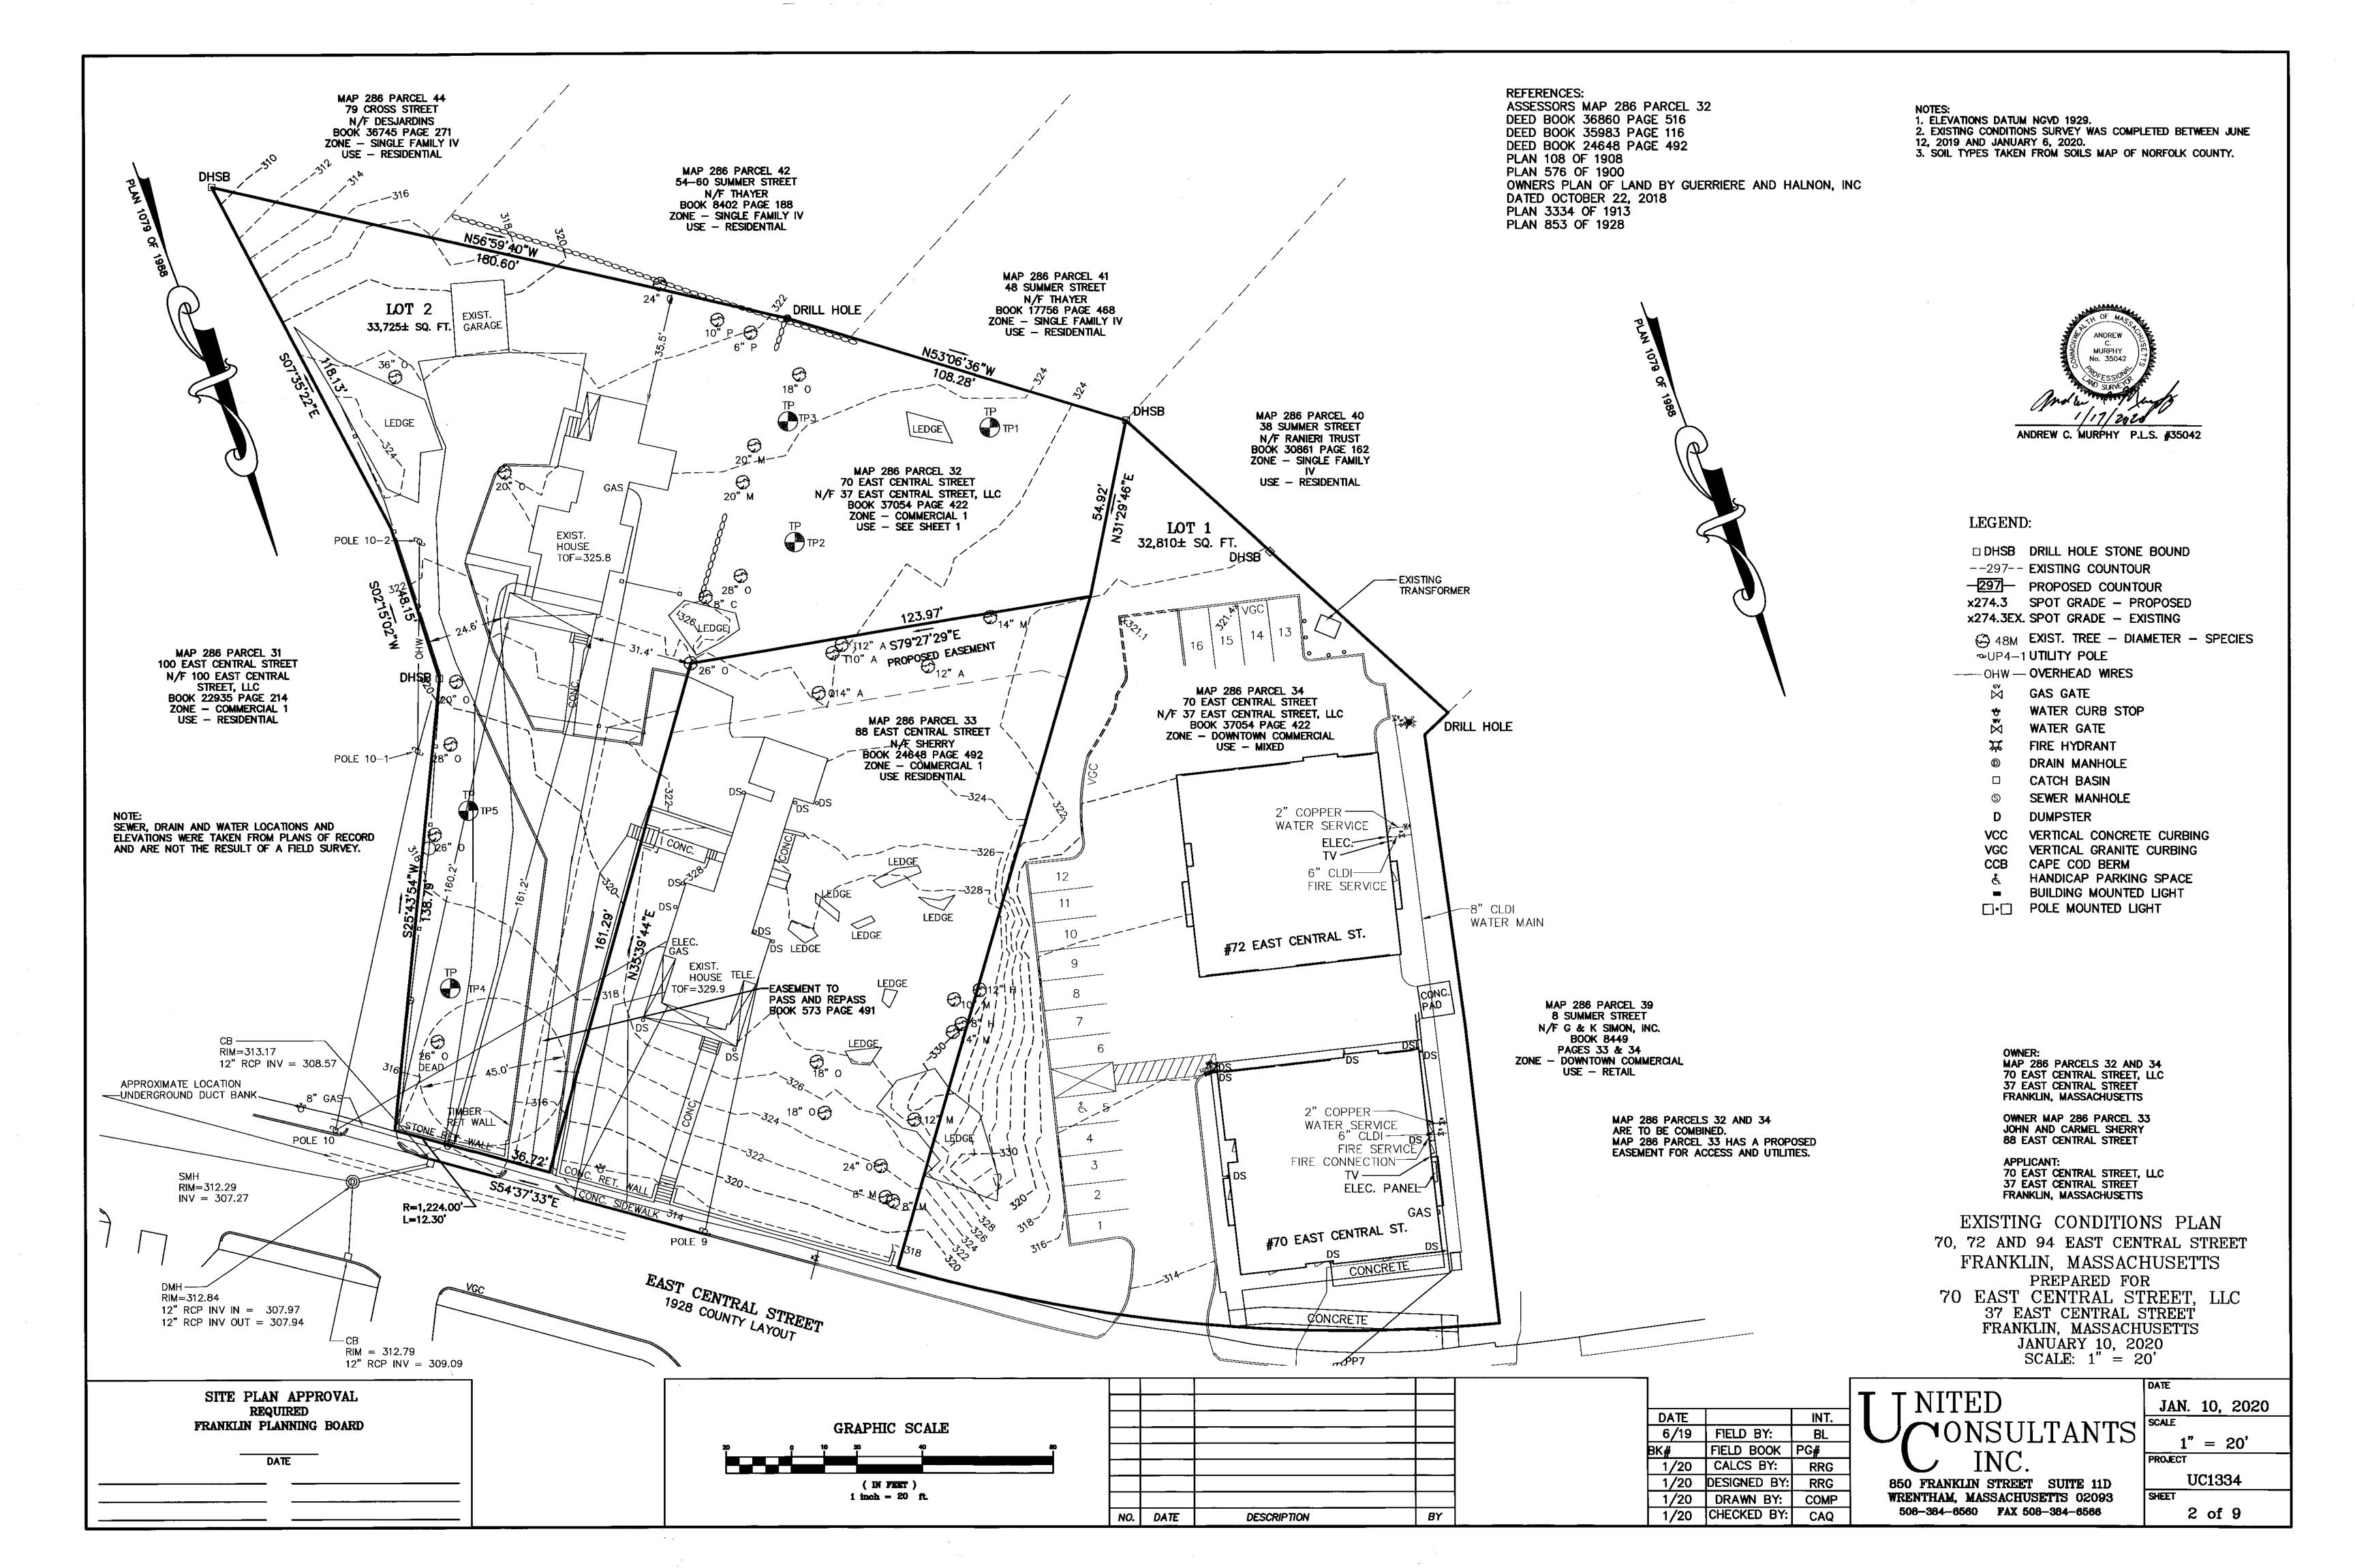

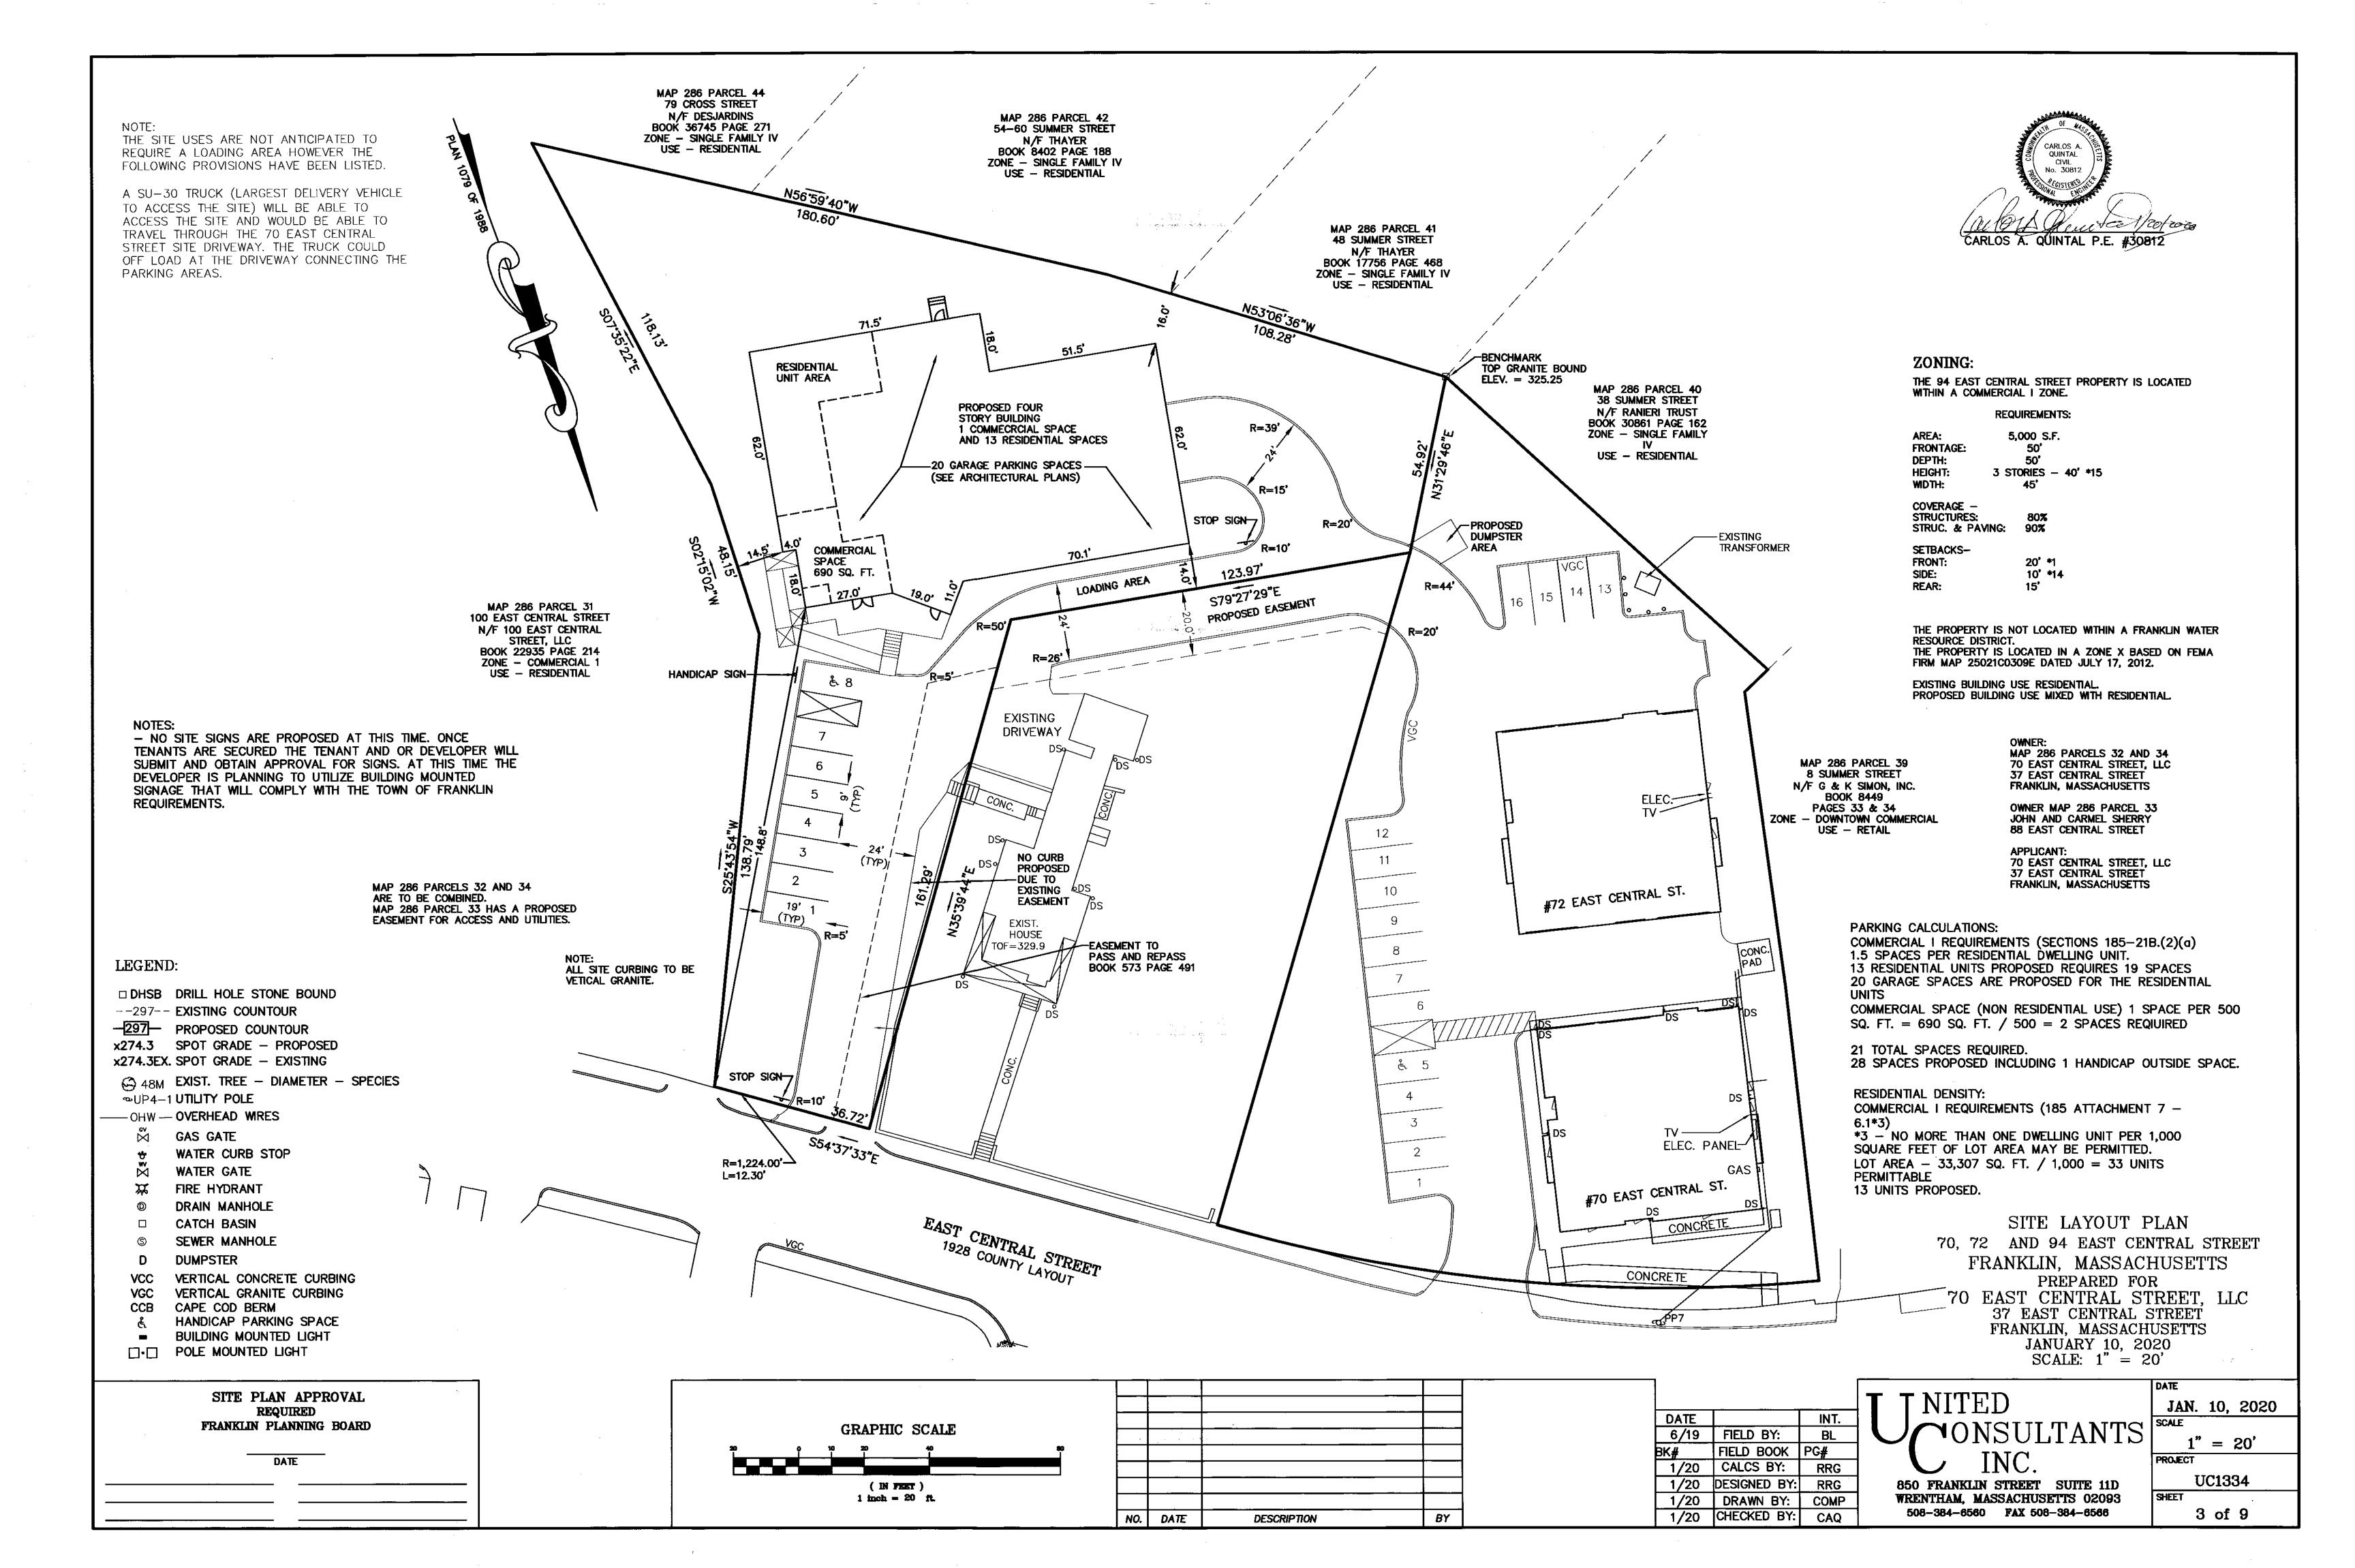

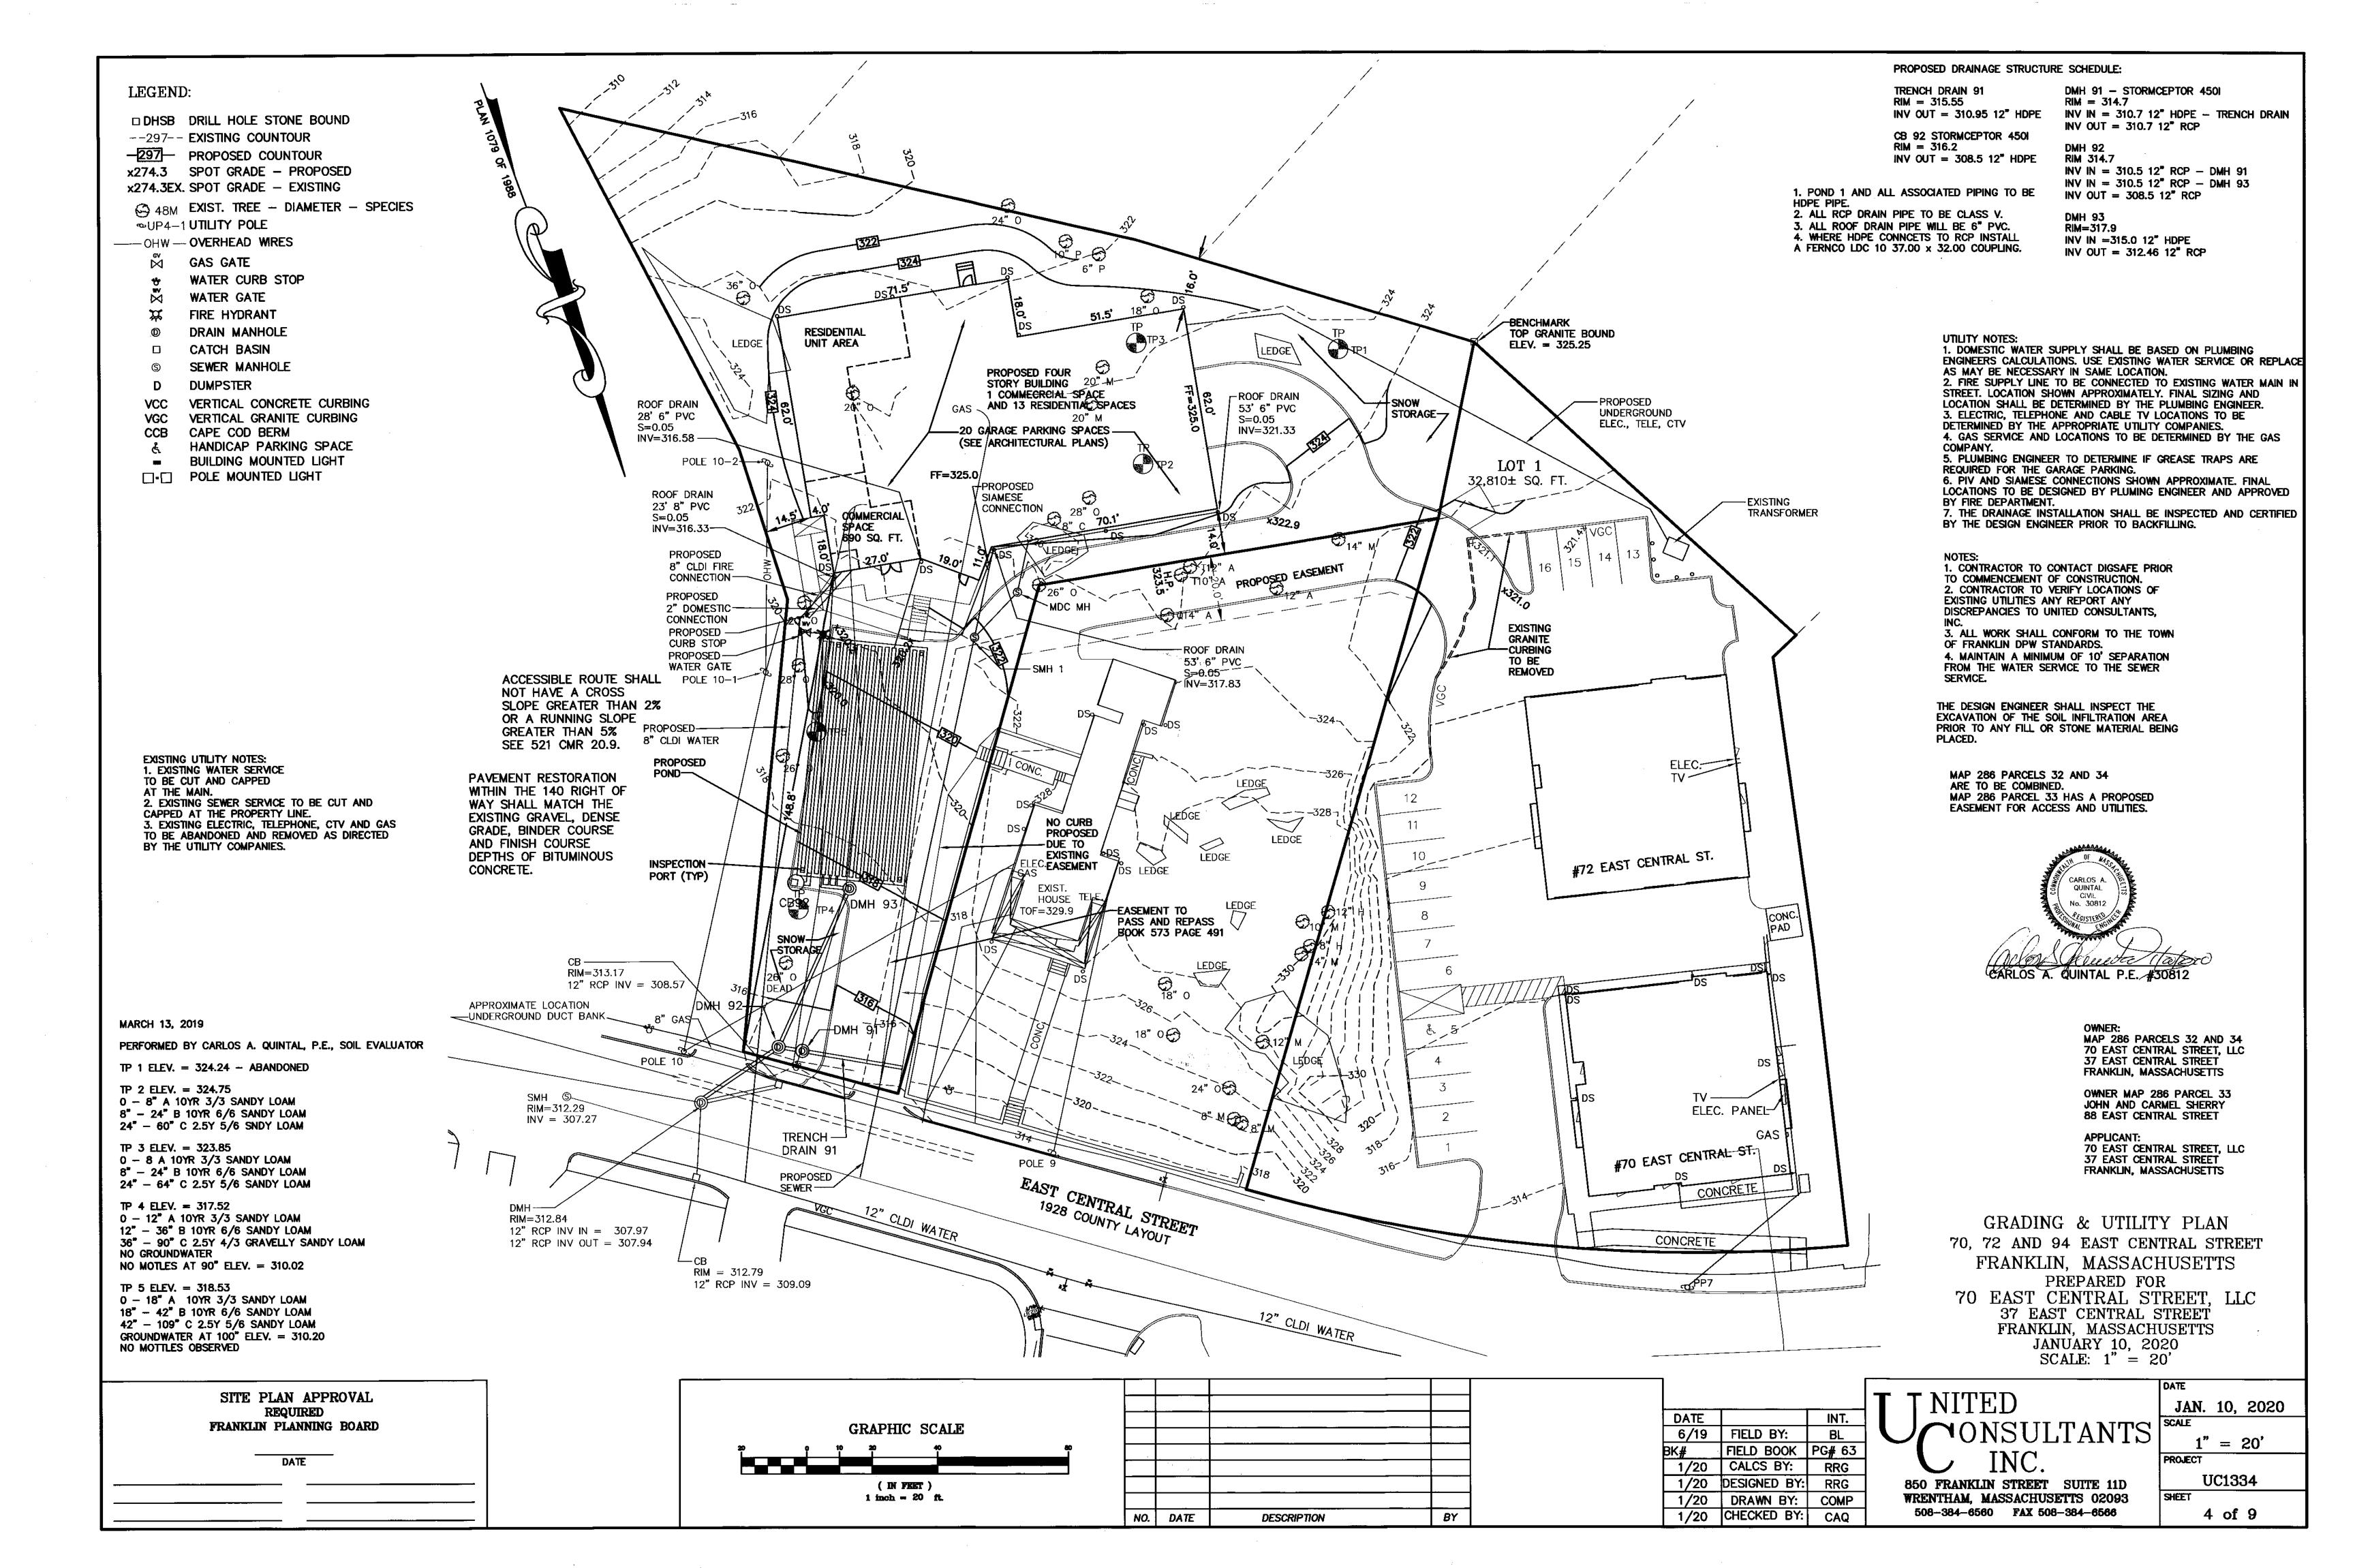

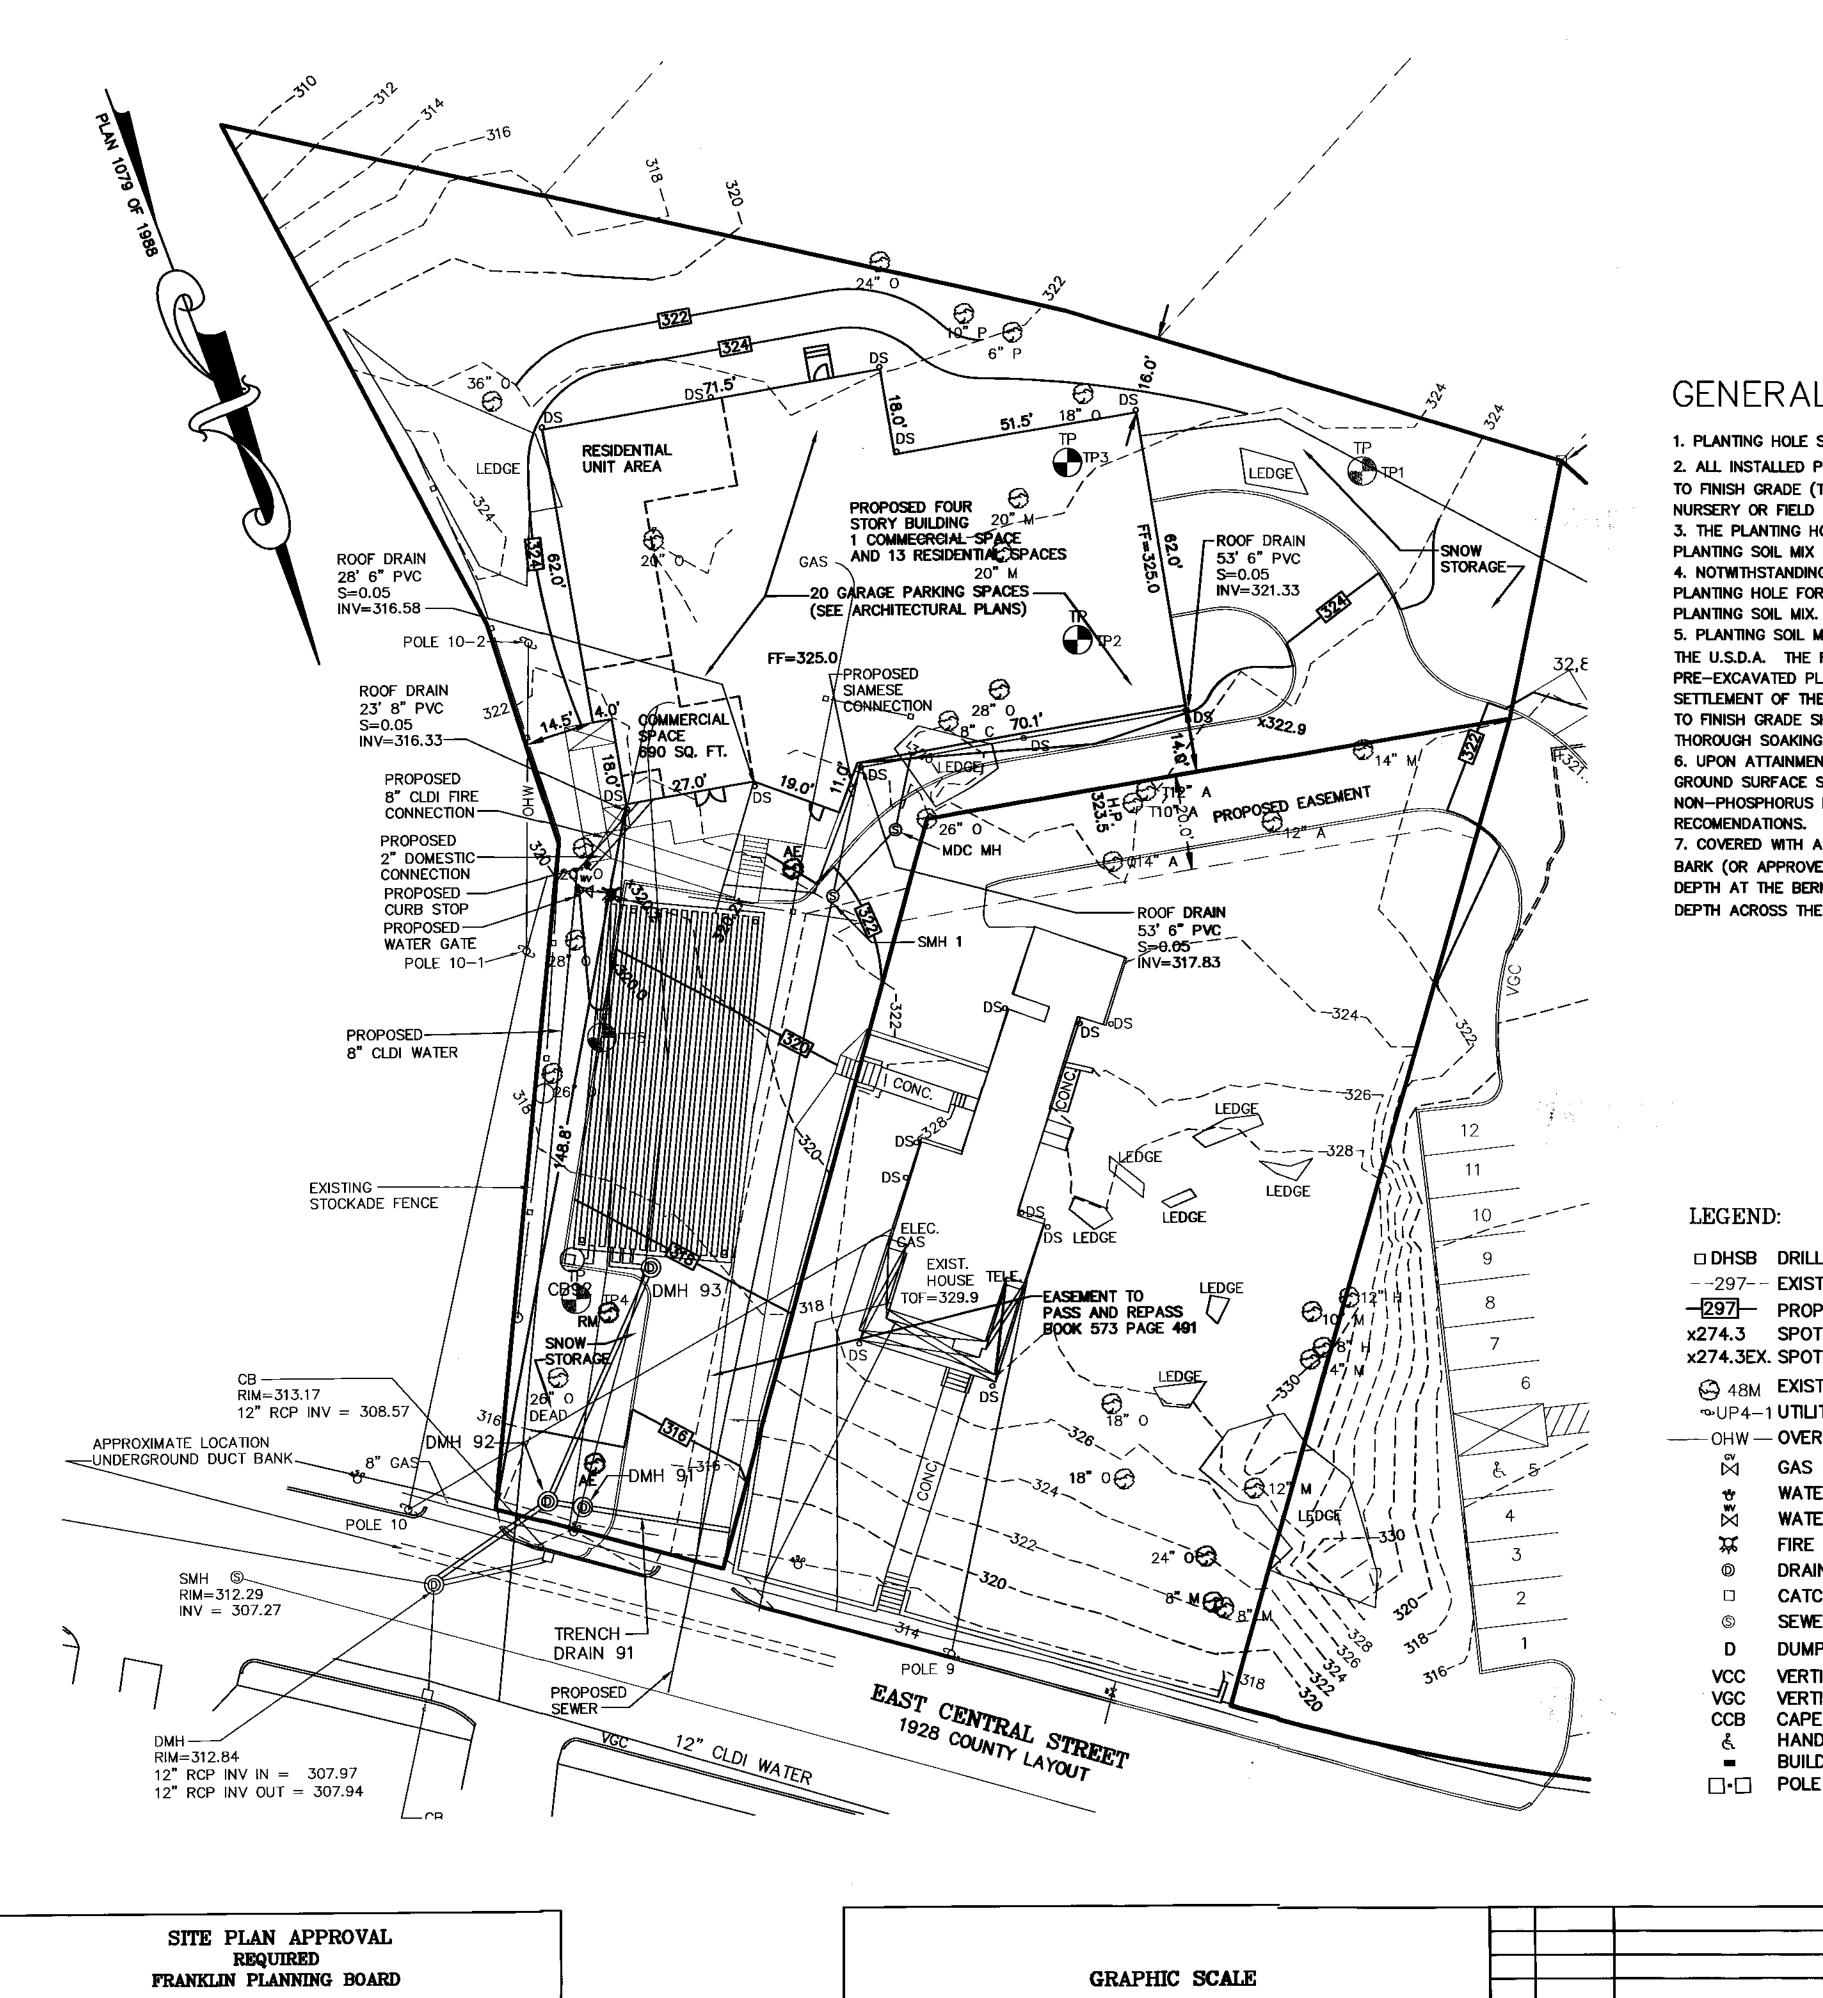

(IN FEET) 1 inch = 20 ft.

DATE

- PER SECTION 185-21C(5) PROVIDE 1 TREE PER 10 PARKING SPACES. 8 PARKING SPACES OUTSIDE OF BUIDLING AND 28 SPACES TOTAL = 3 TREES


3 TREES PROVIDED. - ALL PLANTINGS ARE IN ACCORDANCE WITH THE TOWN OF FRANKLIN BEST DEVELOPMENT PRACTICES GUIDEBOOK.

PLANTING SCHEDULE

NUMBER	COMMON NAME	SCIENTIFIC NAME	SIZE	CONDITION
2	AMERICAN ELM - AE	ULMUS AMERICANA	2 - 2 1/2"	B&B
1	RED MAPLE - RM	ACER RUBRUM	2 - 2 1/2*	B&B

GENERAL NOTES

- 1. PLANTING HOLE SHALL BE THREE TIMES ROOT BALL DIAMETER.
- 2. ALL INSTALLED PLANT MATERIAL SHALL BEAR THE SAME RELATIONSHIP TO FINISH GRADE (TOP OF PLANTING SOIL MIX), AS IT BORE TO THE NURSERY OR FIELD GRADE.
- 3. THE PLANTING HOLE DEPTH SHALL PROVIDE FOR A SIX INCH DEPTH OF PLANTING SOIL MIX BELOW THE ANTICIPATED ROOT BALL BOTTOM. 4. NOTWITHSTANDING THE REQUIREMENTS OF NOTES 1 & 3 ABOVE, NO PLANTING HOLE FOR TREES SHALL HAVE LESS THAN ONE CUBIC YARD OF
- 5. PLANTING SOIL MIX SHALL BE A LOAM OR SANDY LOAM, AS DEFINED BY THE U.S.D.A. THE FIRST (BOTTOM) SIX INCH LAYER IN THE
- PRE-EXCAVATED PLANTING HOLE SHALL BE FIRMLY TAMPED TO PREVENT SETTLEMENT OF THE ROOT BALL POSITIONED THEREON. SUBSEQUENT LIFTS TO FINISH GRADE SHALL BE IN SIX INCH LOOSE LIFTS, EACH SETTLED BY THOROUGH SOAKING.
- 6. UPON ATTAINMENT OF FINISH GRADE WITHIN EACH PLANTING BED, THE GROUND SURFACE SHALL RECEIVE AN EVEN APPLICATION OF ORGANIC NON-PHOSPHORUS FERTILIZER APPLIED PER THE MANUFACTURERS RECOMENDATIONS.
- 7. COVERED WITH A THREE INCH NOMINAL DEPTH OF SHREDDED CEDAR BARK (OR APPROVED EQUIVALENT), MAINTAINING A ONE INCH MINIMUM DEPTH AT THE BERM EDGE, AND IMMEDIATELY RISING TO A THREE INCH DEPTH ACROSS THE PLANTING BED OR LANDSCAPE ISLAND. (SEE DETAIL)

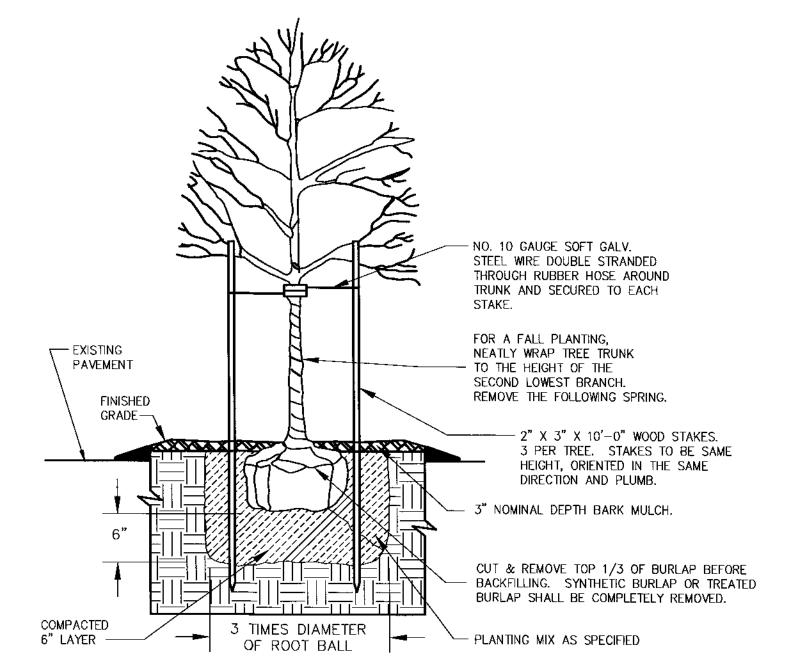

DECIDUOUS TREE PLANTING

LEGEND:

- ☐ DHSB DRILL HOLE STONE BOUND
- --297-- **EXISTING COUNTOUR**
- PROPOSED COUNTOUR SPOT GRADE - PROPOSED
- x274.3EX. SPOT GRADE EXISTING
- 48M EXIST. TREE DIAMETER SPECIES
- ©UP4-1 UTILITY POLE
- -----OHW -- OVERHEAD WIRES
 - GAS GATE WATER CURB STOP
 - WATER GATE
 - FIRE HYDRANT
 - DRAIN MANHOLE
 - CATCH BASIN
 - SEWER MANHOLE
 - DUMPSTER

DESCRIPTION

NO. DATE

- VERTICAL CONCRETE CURBING
- VERTICAL GRANITE CURBING
- CAPE COD BERM
- HANDICAP PARKING SPACE BUILDING MOUNTED LIGHT


BY

POLE MOUNTED LIGHT

MAP 286 PARCELS 32 AND 34 ARE TO BE COMBINED. MAP 286 PARCEL 33 HAS A PROPOSED EASEMENT FOR ACCESS AND UTILITIES. MAP 286 PARCELS 32 AND 34 70 EAST CENTRAL STREET, LLC 37 EAST CENTRAL STREET FRANKLIN, MASSACHUSETTS

OWNER MAP 286 PARCEL 33 JOHN AND CARMEL SHERRY 88 EAST CENTRAL STREET

APPLICANT: 70 EAST CENTRAL STREET, LLC 37 EAST CENTRAL STREET FRANKLIN, MASSACHUSETTS

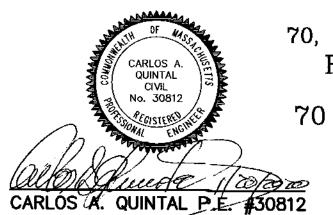

PLANTING PLAN 70, 72 AND 94 EAST CENTRAL STREET FRANKLIN, MASSACHUSETTS


PREPARED FOR 70 EAST CENTRAL STREET, LLC 37 EAST CENTRAL STREET FRANKLIN, MASSACHUSETTS JANUARY 10, 2020


NITED ONSULTANTS INC. 850 FRANKLIN STREET SUITE 11D


508-384-6560 FAX 508-384-6566

SCALE: 1" = 20'JAN. 10, 2020 " = 20'PROJECT UC1334 SHEET WRENTHAM, MASSACHUSETTS 02093 5 of 9


DATE INT. FIELD BY: 6/19 FIELD BOOK PG# CALCS BY: 1/20 RRG DESIGNED BY: DRAWN BY: CHECKED BY:

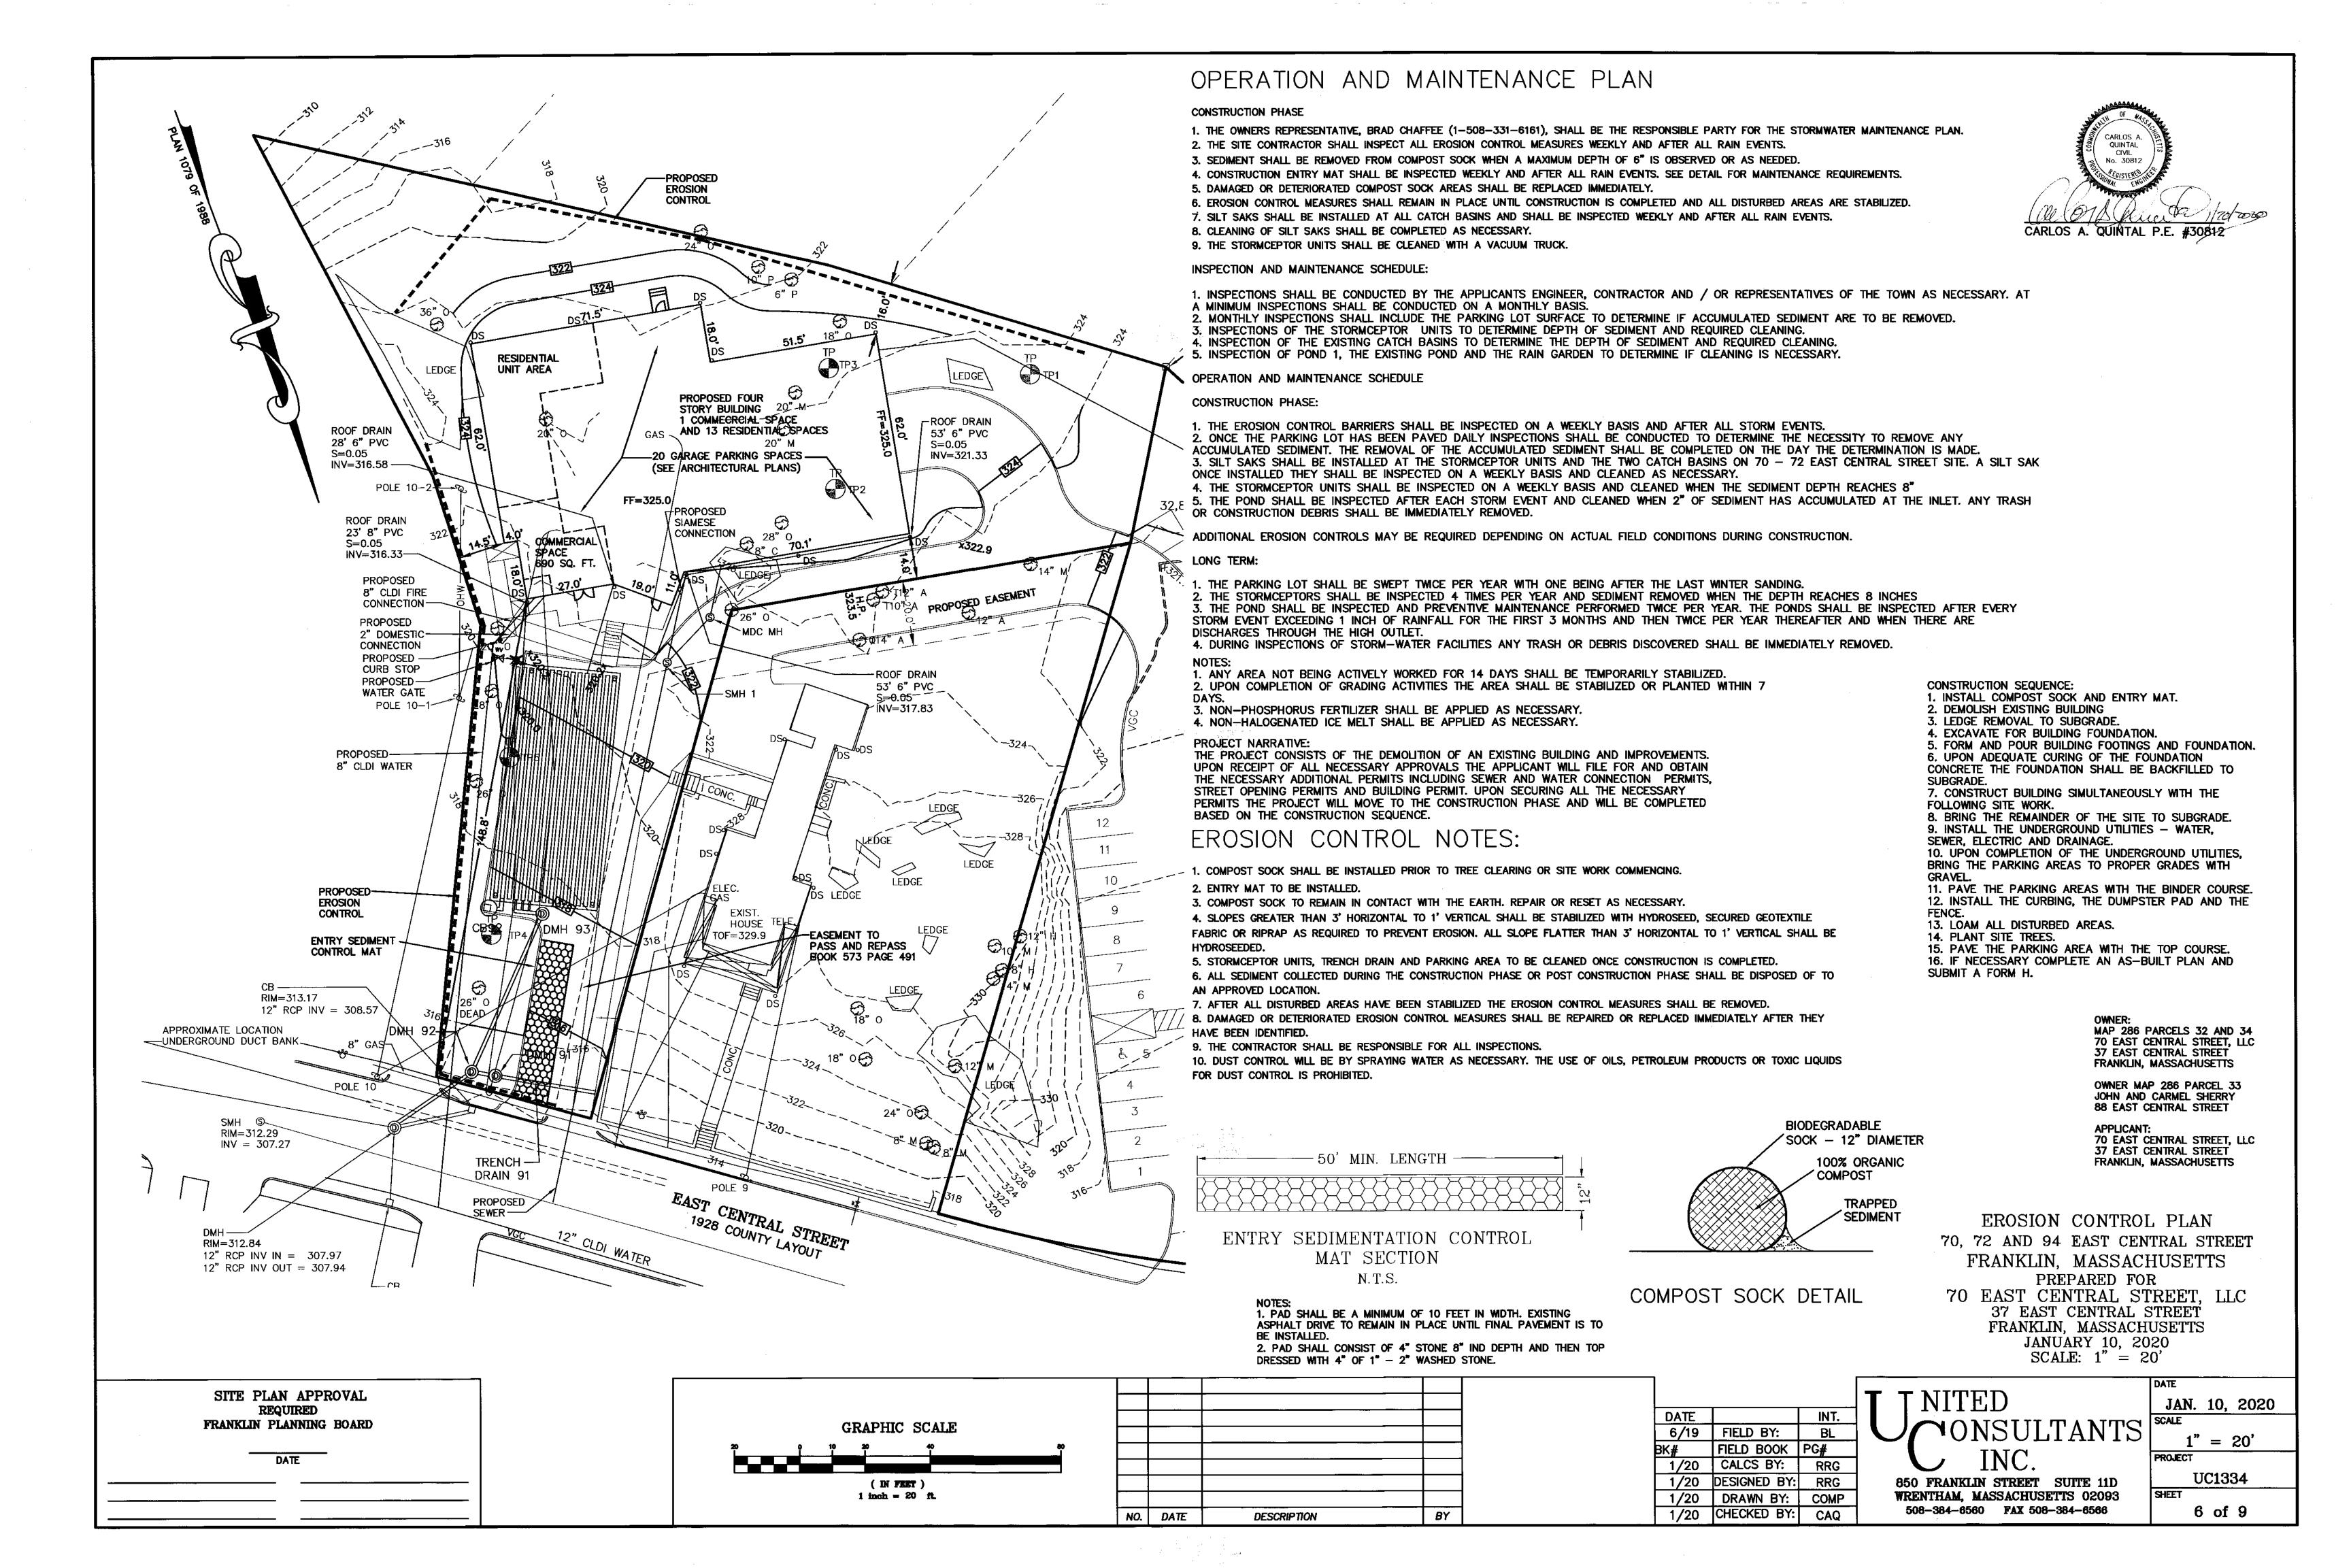

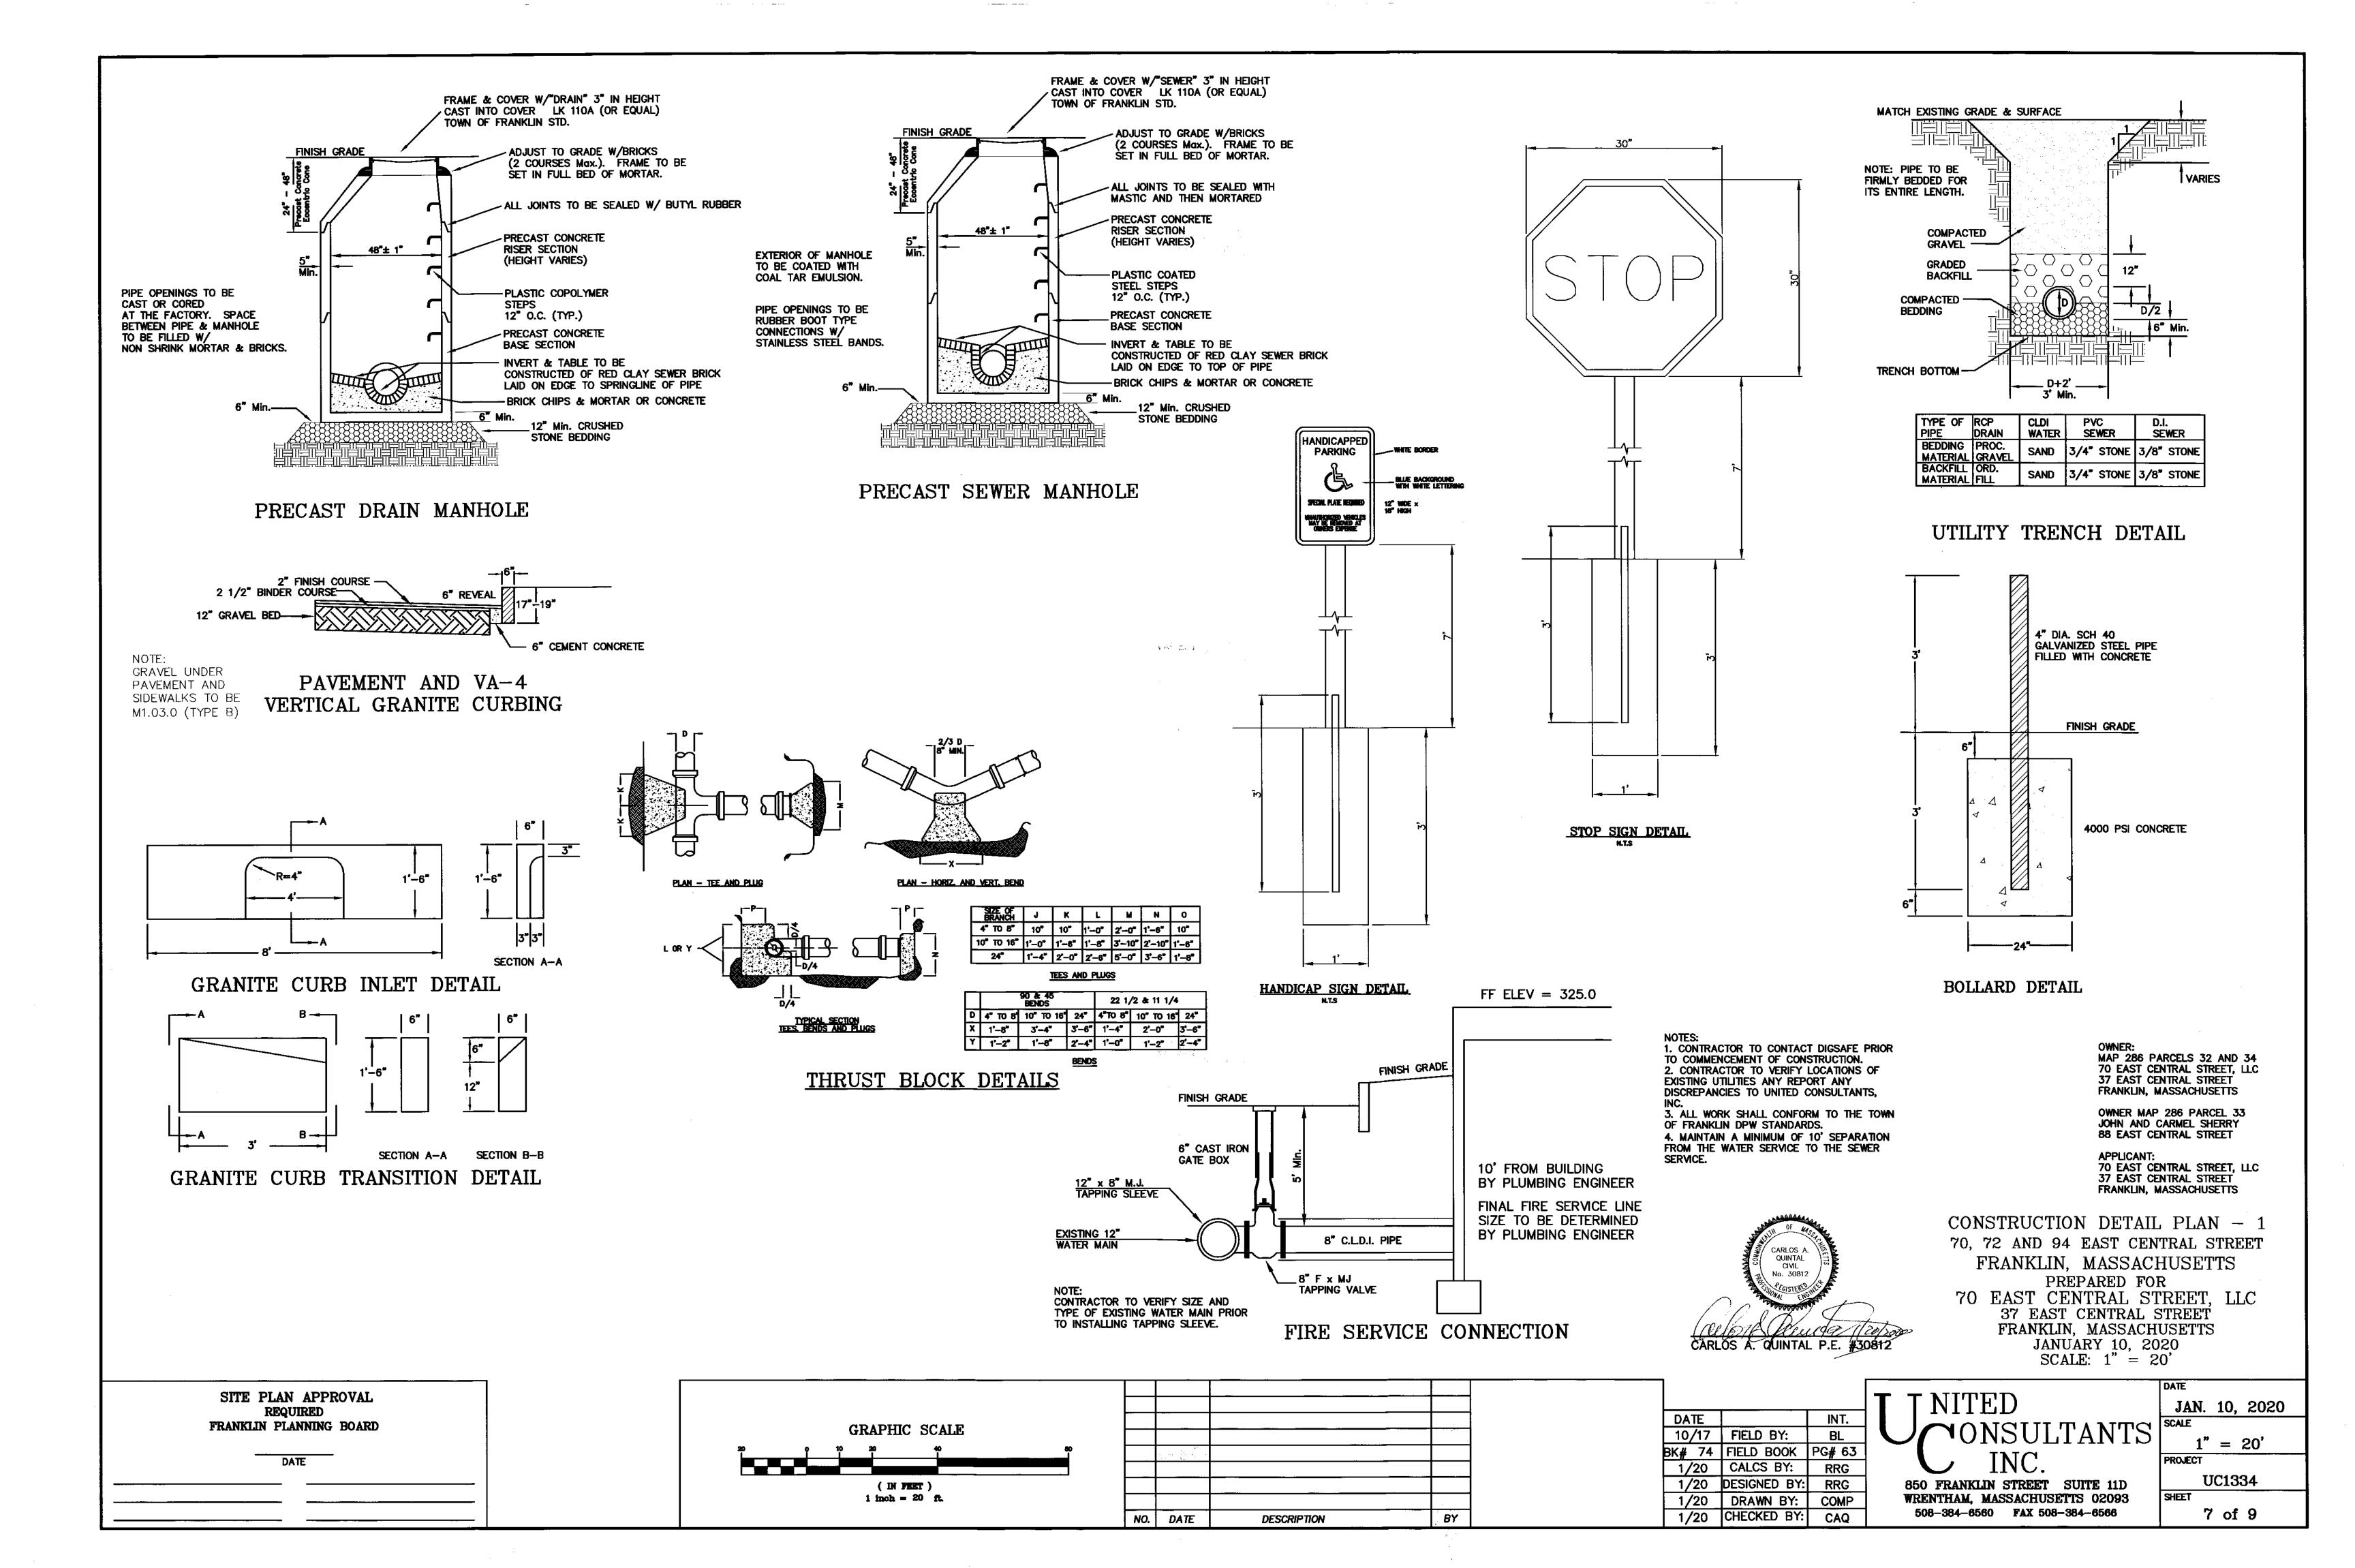


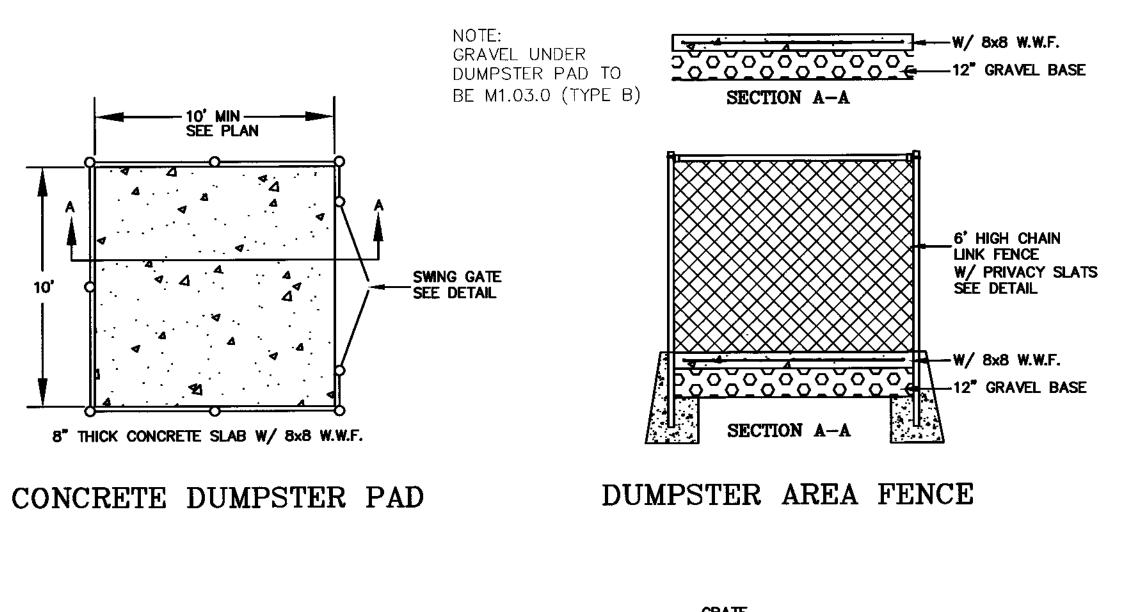


FINISH GRADE

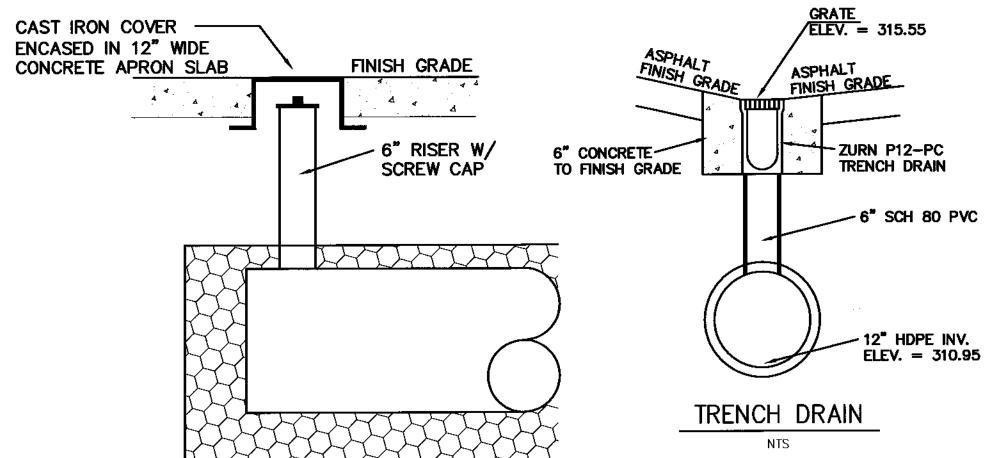


INSPECTION PORT DETAIL DRAINAGE INFILTRATION AREAS N.T.S.

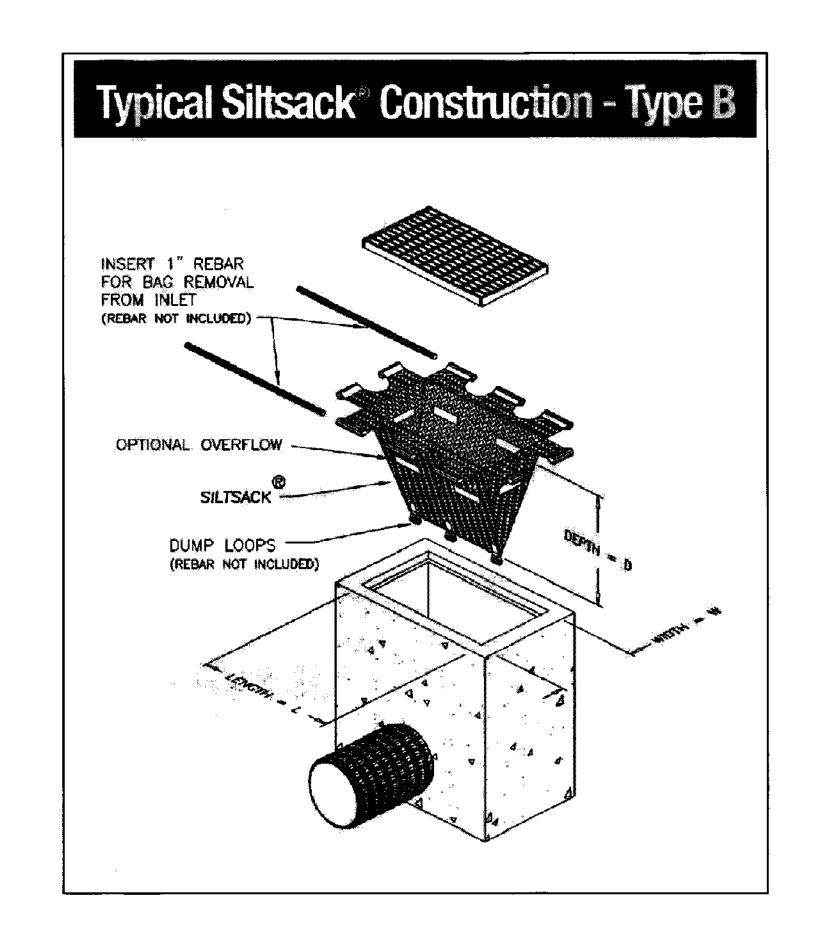


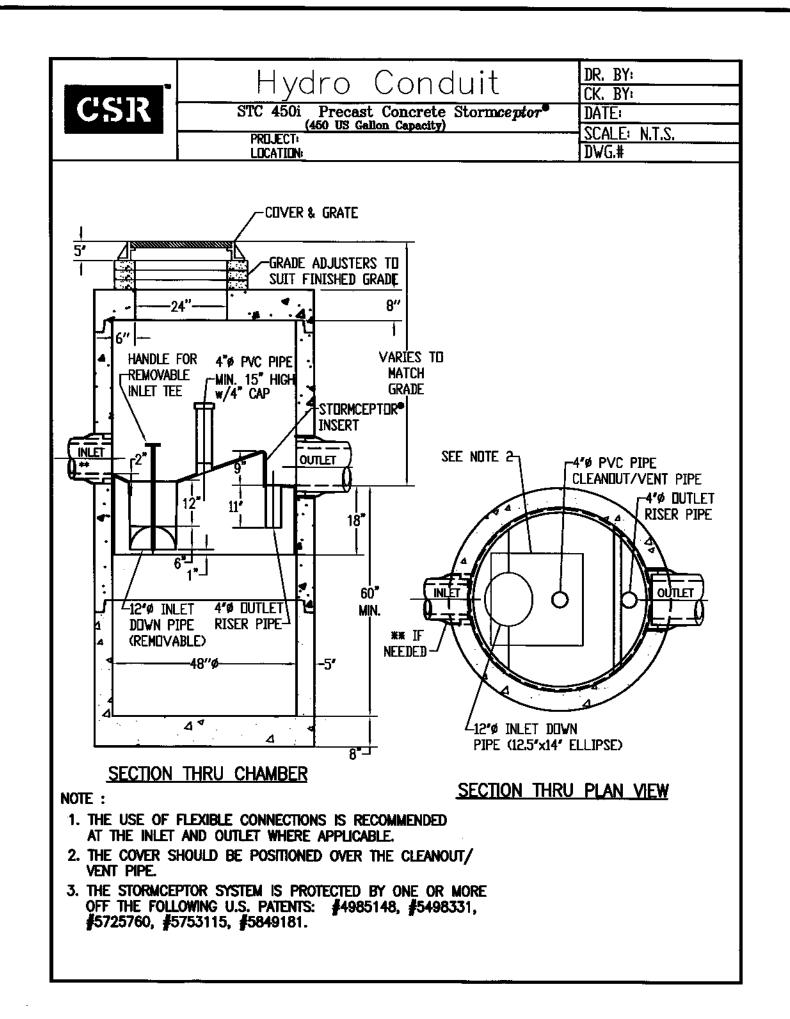

1. CONTRACTOR TO CONTACT DIGSAFE PRIOR TO COMMENCEMENT OF CONSTRUCTION.
2. CONTRACTOR TO VERIFY LOCATIONS OF EXISTING UTILITIES ANY REPORT ANY DISCREPANCIES TO UNITED CONSULTANTS,

3. ALL WORK SHALL CONFORM TO THE TOWN OF FRANKLIN DPW STANDARDS. 4. MAINTAIN A MINIMUM OF 10' SEPARATION FROM THE WATER SERVICE TO THE SEWER

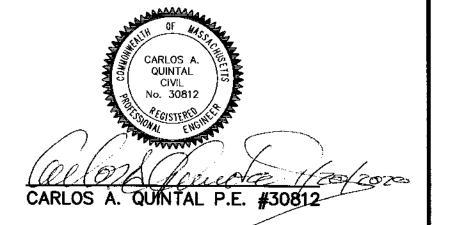

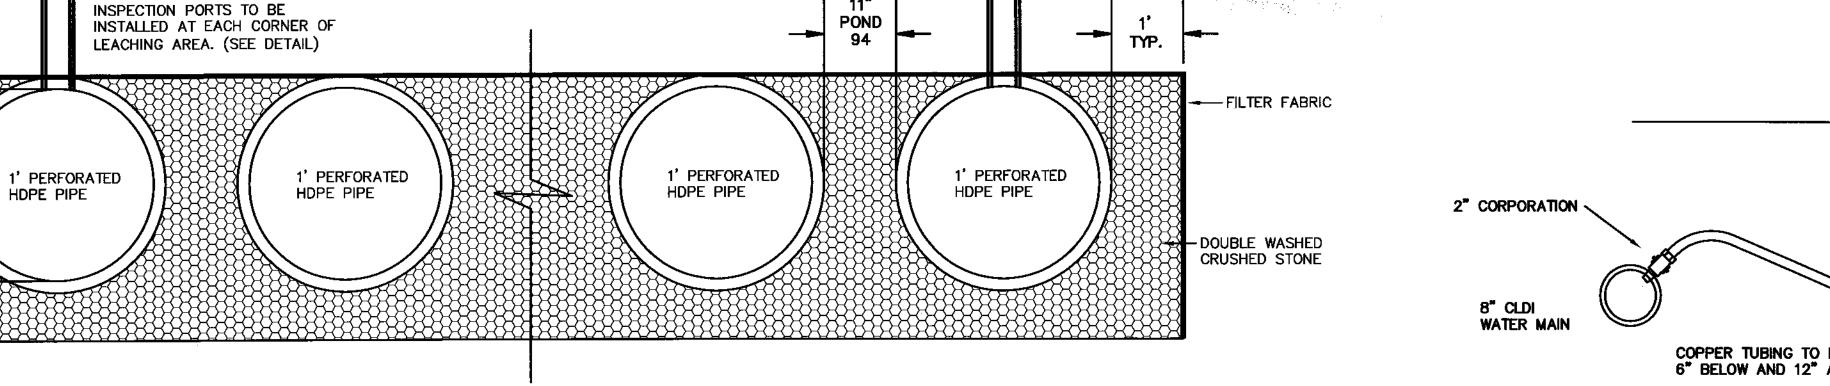

INFILTRATION POND 1 CONSISTS OF 3 ROWS OF 1.5' DIAMETER PERFORATED HDPE PIPE 60 ' IN LENGTH. INFILTRATION POND 2 CONSISTS OF 3 ROWS OF 2' DIAMETER PERFORATED HDPE PIPE 68' IN

POND 94 = 314.72

POND 94 = 315.72

DRAINAGE INFILTRATION AREAS

THE DESIGN ENGINEER SHALL INSPECT THE EXCAVATION OF THE SOIL INFILTRATION AREA PRIOR TO ANY FILL BEING PLACED.

FINISH GRADE 2" CURB STOP W/ BOX 2" TYPE "K" COPPER TUBING NO UNIONS IN ROADWAY

COPPER TUBING TO BE SET IN SAND ENVELOPE 6" BELOW AND 12" ABOVE TUBING

BY

2" DOMESTIC WATER SERVICE

OWNER:
MAP 286 PARCELS 32 AND 34
70 EAST CENTRAL STREET, LLC
37 EAST CENTRAL STREET
FRANKLIN, MASSACHUSETTS

OWNER MAP 286 PARCEL 33 JOHN AND CARMEL SHERRY 88 EAST CENTRAL STREET

APPLICANT:
70 EAST CENTRAL STREET, LLC
37 EAST CENTRAL STREET
FRANKLIN, MASSACHUSETTS

CONSTRUCTION DETAIL PLAN - 2 70, 72 AND 94 EAST CENTRAL STREET FRANKLIN, MASSACHUSETTS

PREPARED FOR

70 EAST CENTRAL STREET, LLC

37 EAST CENTRAL STREET

FRANKLIN, MASSACHUSETTS

JANUARY 10, 2020

SCALE: 1" = 20'

SITE PLAN APPROVAL REQUIRED FRANKLIN PLANNING BOARD


	ŗ		
CDADING SCALE			
GRAPHIC SCALE			
20 0 10 20 40 80			
(IN FEET) 1 inch = 20 ft.			
1 inch = 20 ft.			
	NO.	DATE	DESCRIPTION
			· · · · · · · · · · · · · · · · · · ·


			_
DATE		INT.	
10/17	FIELD BY:	BL	
3K# 74	FIELD BOOK	PG# 63	
1/20	CALCS BY:	RRG	
1/20	DESIGNED BY:	RRG	
1/20	DRAWN BY:	COMP	
1/20	CHECKED BY:	CAQ	

NITED ONSULTANTS SCALE 850 FRANKLIN STREET SUITE 11D WRENTHAM, MASSACHUSETTS 02093

508-384-6560 FAX 508-384-6566

JAN. 10, 2020 1" = 20'PROJECT UC1334 SHEET 8 of 9

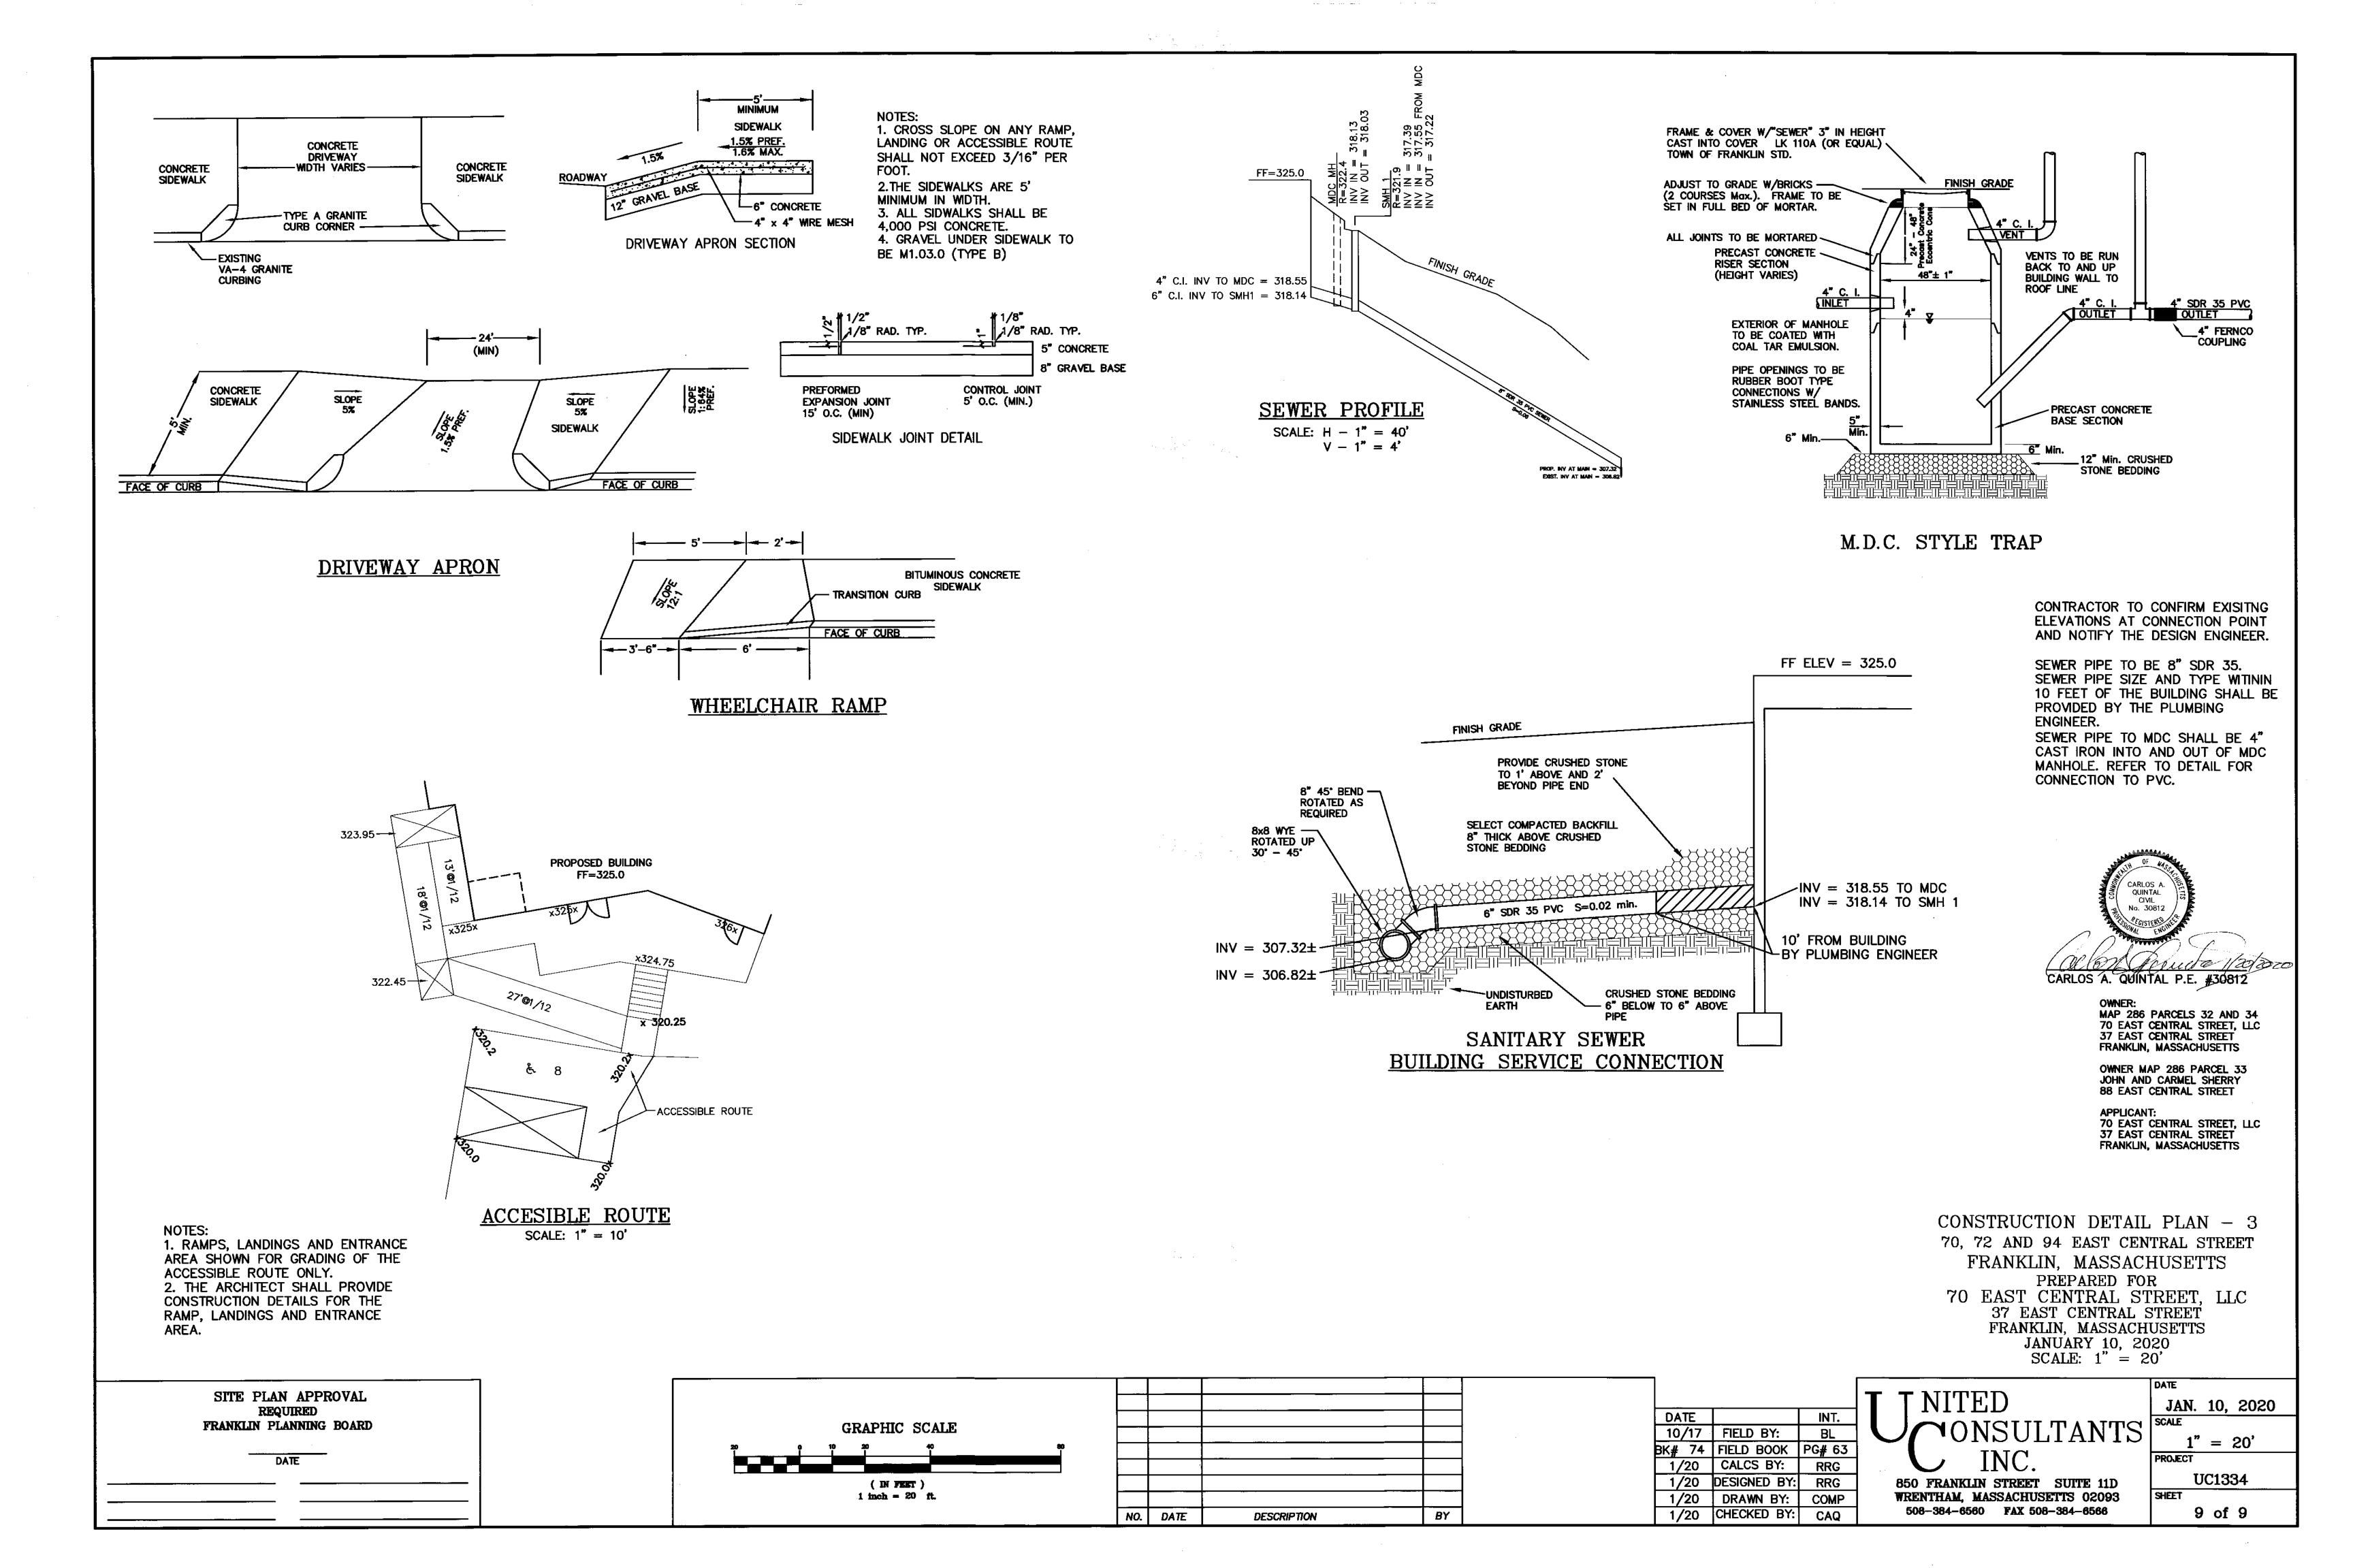


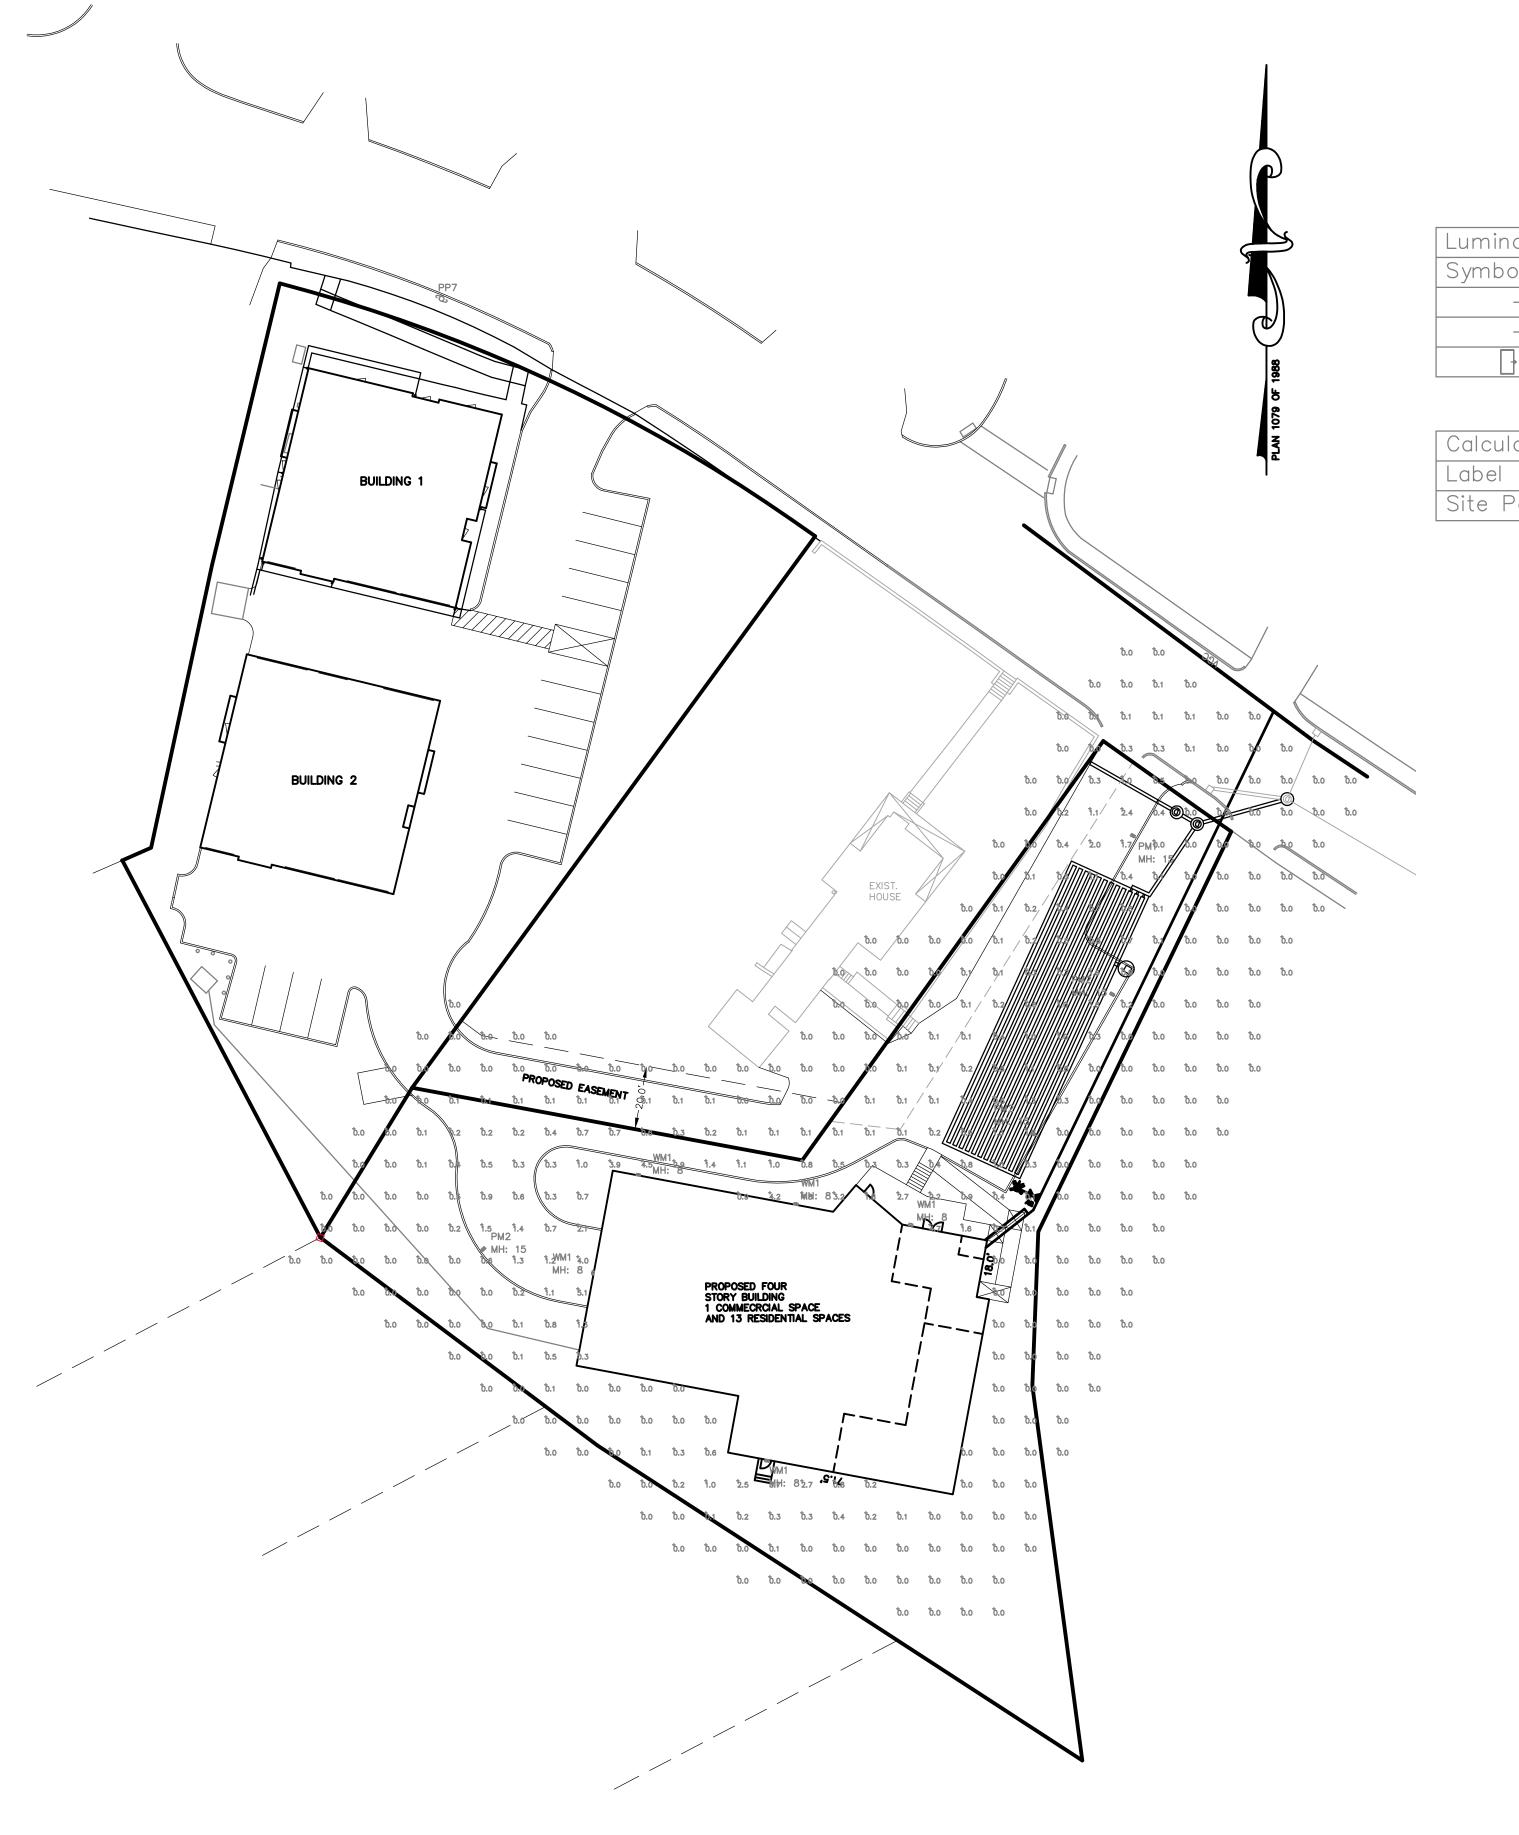


Site Lighting Plan
SCALE: 1"=30'-0"


Luminaire Schedule							
Symbol	Label	Qty	Description	LLF	Lum. Watts	Lum. Lumens	
-	PM1	1	Visionaire # VSX-1-T2-16AR-5L-4K-HS	0.900	34	1636	
-	PM2	3	Visionaire # VSX-1-T2-16AR-5L-4K-HS	0.900	34	1599	
	WM1	5	Visionaire # PGAS-1-T2-16LC-3-4K-UNV-WM	0.900	17	2235	

Calculation Summary							
Label	CalcType	Units	Avg	Max	Min	Avg/Min	Max/Min
Site Points	Illuminance	Fc	0.14	5.1	0.0	N.A.	N.A.

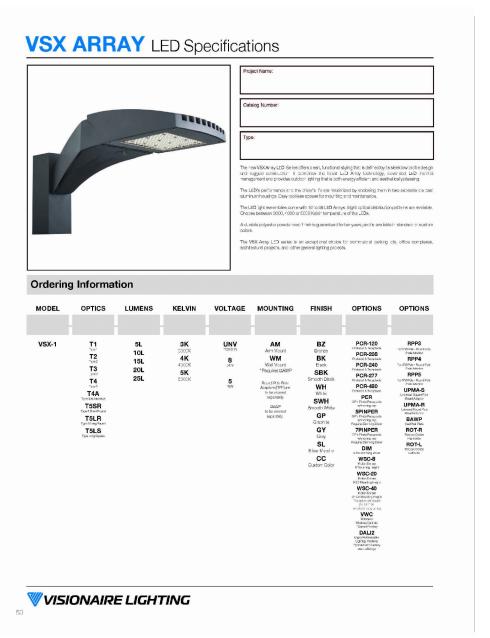

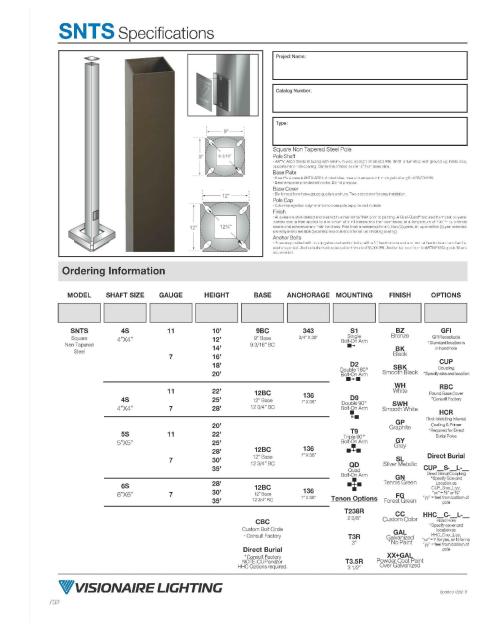

2 Fixture Specification - Visionaire VSX Array 3 Pole Specification - Visionaire SNTS

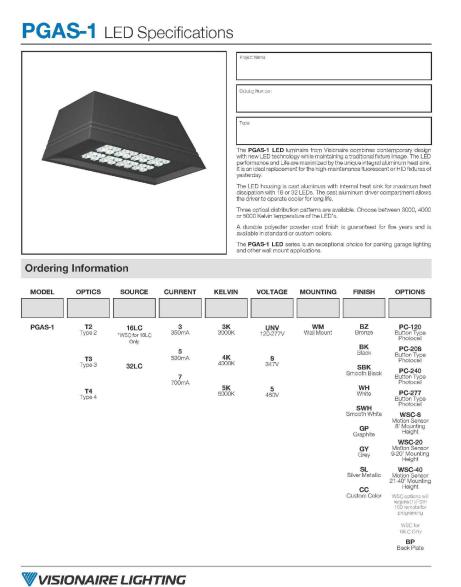

3 Fixture Specification - Visionaire PGAS

ABBREVIATIONS: Avg= Average AFG= Above Finished Grade CF = Compact Fluorescent CV= Coefficient of variation fc = Footcandles
HPS = High Pressure Sodium
LLF= Light Loss Factor
MH = Mounting Height
NTS = Not to Scale
PSMH = Pulse Start Metal Halide SF = Square foot W = Watts

- NOTES:

 A. CALCULATION POINTS INDICATED ARE BASED ON MAINTAINED FOOTCANDLE (FC) LEVELS AFTER A LIGHT LOSS FACTOR (LLF) IS APPLIED TO FIXTURE. REFER TO SCHEDULES FOR LLF AND LUMEN INFORMATION.
- B. REFER TO PLAN FOR FIXTURE MOUNTING HEIGHTS.
- C. CALCULATION POINTS TAKEN AT GRADE.

94 East Central Street- Franklin, MA

Chaffe Power Group, LLC

SEAL

REVISIONS						
No.	Description	Date				
<i>5.</i>						
4.						
3.						
2.						

Issue Date: 01/21/20 Project #: Checked: HD

Approved: HD Scale: AS NOTED DRAWING NAME

Site Lighting Plan, Schedules and Specifications

DRAWING NUMBER

SL1

Copyright SK & Associates Inc. 2019