
SITE PLAN WASHINGTON STREET FRANKLIN MASSACHUSETTS

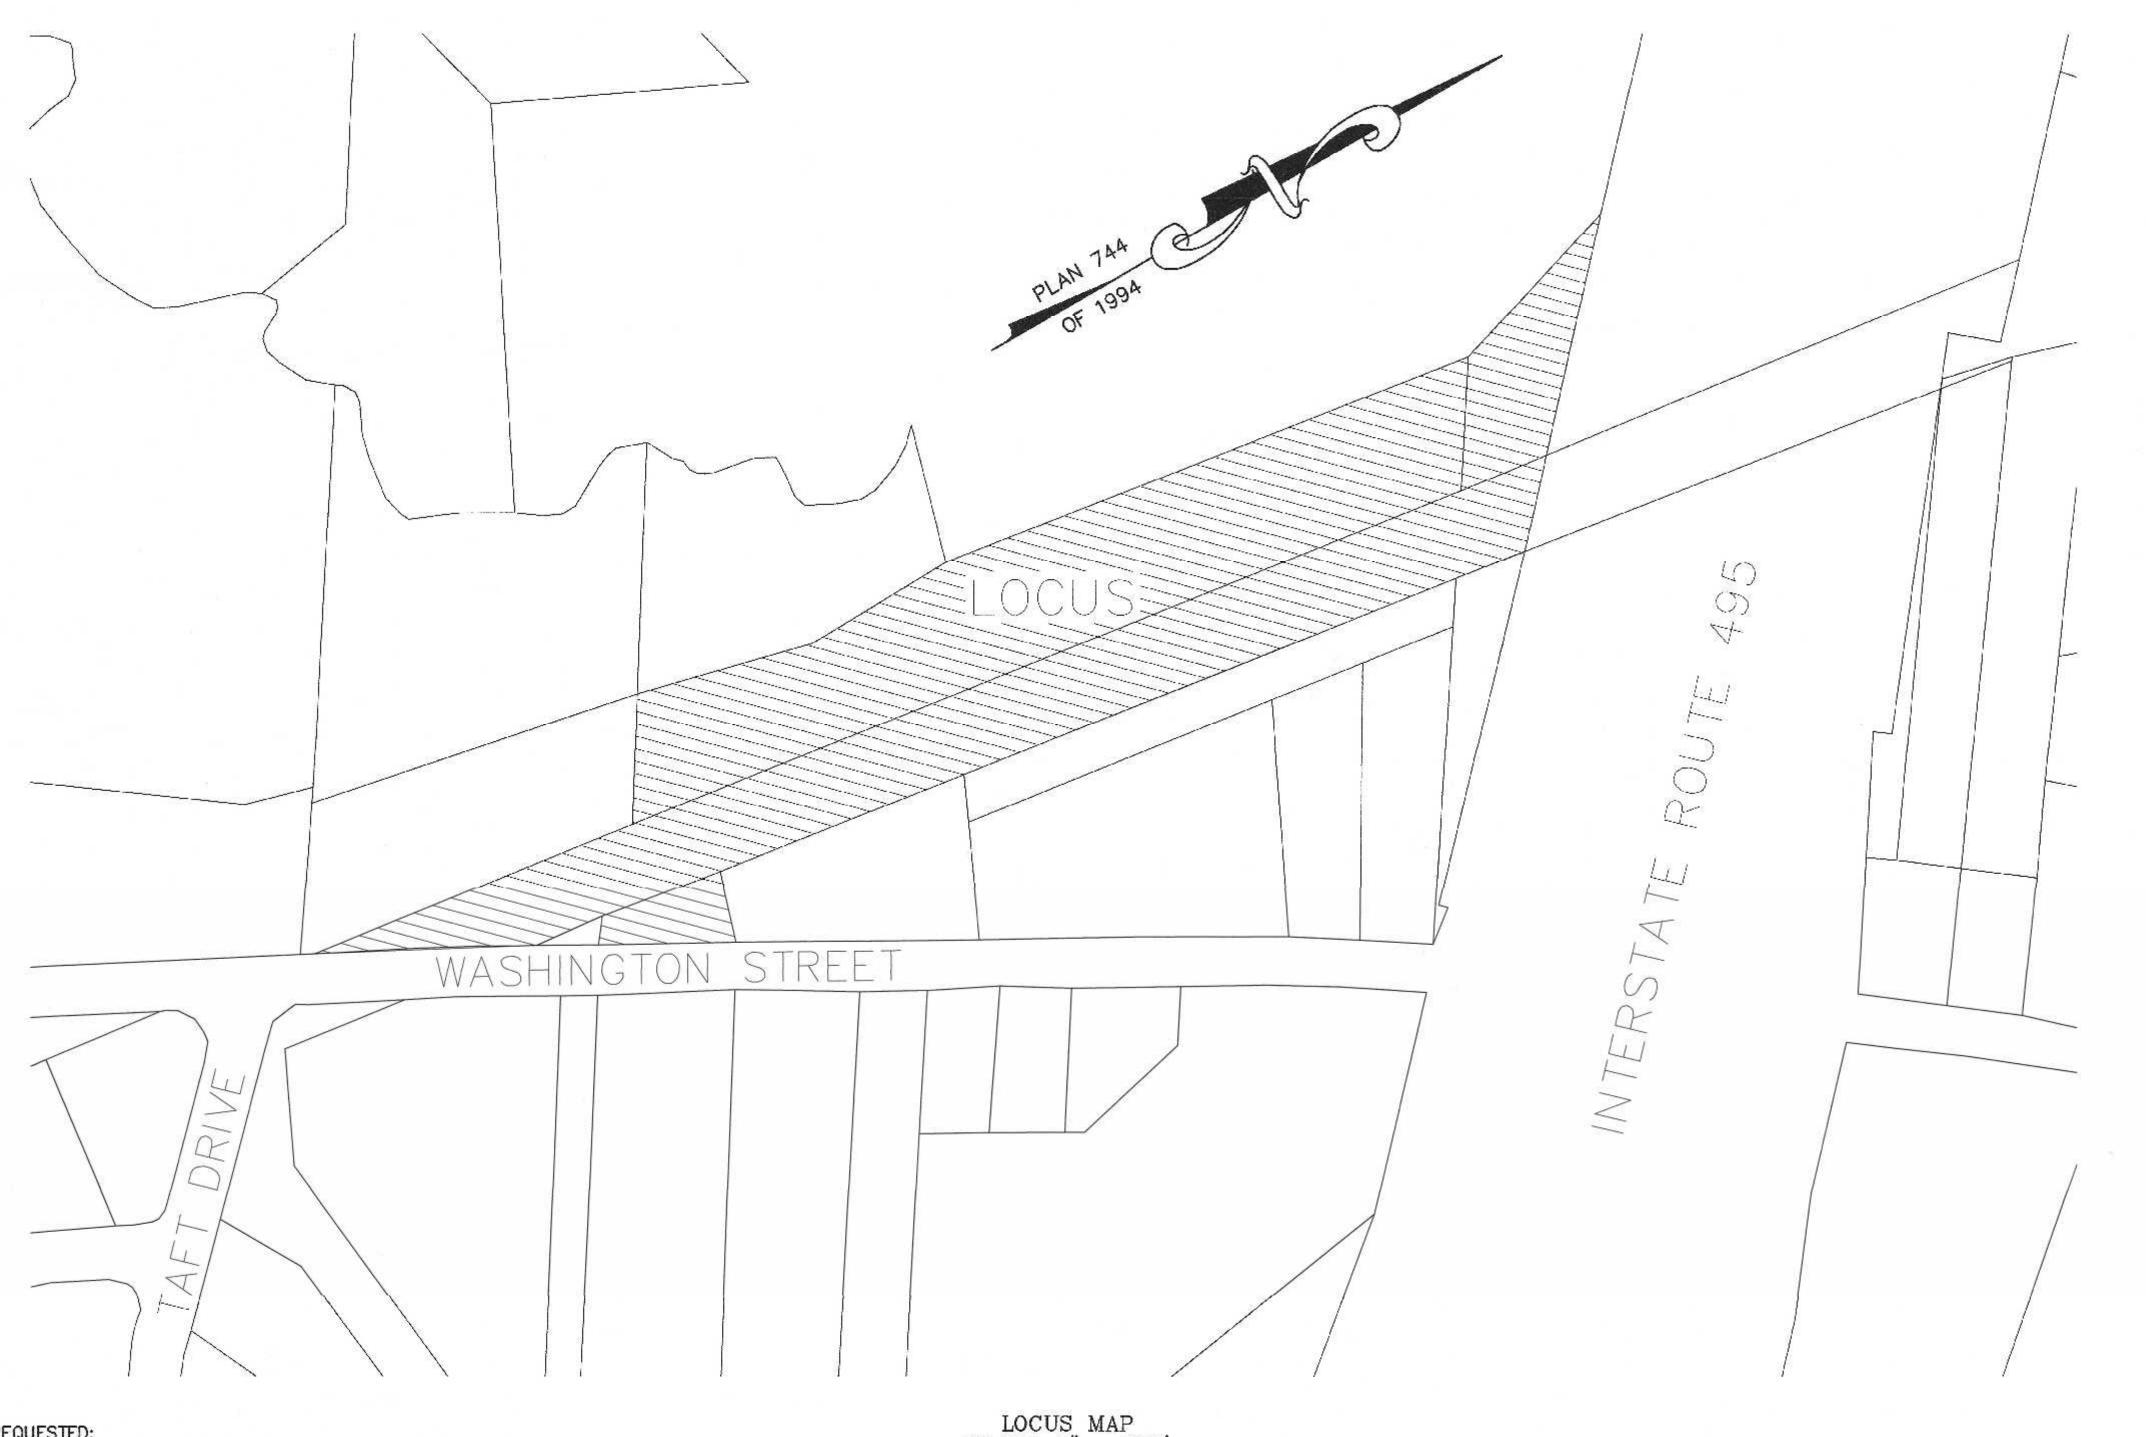

WAIVER REQUESTED: 1. TO ALLOW LESS THAN 42" OF COVER OVER THE RCP DRAIN PIPE. PROPOSED CLASS V RCP. 2. TO ALLOW THE USE OF HDPE PIPE FOR THE MANIFOLDS AND POND 1, POND 2, POND 3 AND THE TRENCH DRAINS. 3. TO ALLOW MINIMAL LIGHT SPILLAGE ONTO THE WASHINGTON STREET RIGHT OF WAY.

> SITE PLAN APPROVAL REQUIRED FRANKLIN PLANNING BOARD

> > DATE

(IN FEET) 1 inch = 100 ft.

SCALE: 1'' = 100'

2 1/11/22 REVIEW COMMENTS RRG 1 11/22/21 REVIEW COMMENTS - SITE LAYOUT RRG NO. DATE DESCRIPTION

THE WASHINGTON STREET SITE IS LOCATED WITHIN AN INDUSTRIAL ZONE.

R	EQUIREMENTS:	EXISTING	PROPOSED
INDUSTRIAL ZONE			
AREA:	40,000 S.F.	268,038± S	S.F. 268,038± S.I
FRONTAGE:	175'	253.47	253.47'
DEPTH:	200'	299.9'	299.9'
HEIGHT: 3	STORIES *6	7000 (A. 1000 (A. 100	22' - 1 STO
WIDTH:	157.5'		REFER TO 185-10.E
COVERAGE -			
STRUCTURES:	70%	1. 111	16.9 %
STRUC. & PAVING	: 80%	(201)	51.1%
SETBACKS-			
FRONT:	40'	10 1	99.9'
RIGHT SIDE:	30" *5	Pass	31.0'
LEFT SIDE	30' *5	-	100.4
REAR:	30' *5	142	110.3
*5 - INCREASE E	BY THE COMMON	BUILDING HEIGHT OF	THE STRUCTURE, WI

*5 - INCREASE BY THE COMMON BUILDING HEIGHT OF THE STRUCTURE, WHEN ABUTTING A RESIDENTIAL USE *6 - BUILDINGS UP TO 60 FEET IN HEIGHT MAY BE PERMITTED BY A SPECIAL PERMIT FROM THE PLANNING BOARD.

LOT COVERAGE CALCULATION AREA BASED ON UPLAND AREA

THE ENTIRE PROPERTY IS LOCATED WITHIN A FRANKLIN WATER RESOURCE DISTRICT AND A DEP ZONE II.
THE SITE AREA PROPOSED FOR DEVELOPMENT IS LOCATED IN A ZONE X BASED ON FEMA FIRM MAP 25021C0308E DATED JULY 17, 2012.

AREA WITHIN THE WATER RESOURCE DISTRICT $-268,038\pm$ SQ. FT. UPLAND AREA WITHIN THE WATER RESOURCE DISTRICT $-243,477\pm$ SQ. FT. IMPERVIOUS AREA WITHIN THE WATER RESOURCE DISTRICT $-136,999\pm$ SQ. FT. COVERAGE WITHIN THE WATER RESOURCE DISTRICT -=56.3%

PROPOSED BUILDINGS USE — OFFICE, WAREHOUSE AND LIGHT MANUFACTURING OFFICE — SEE 185 ATTACHMENT 3 — 2.3 — ANTICIPATED WATER USAGE — 1,496 GPD WAREHOUSE - SEE 185 ATTACHMENT 4 - 3.10 LIGHT MANUFACTURING - SEE 185 ATTACHMENT 4 - 3.5.b. ANTICIPATED WATER USAGE - 1,496 GPD

HOUSE OF OPERATION 7 AM TO 5 PM - OFFICE HOURS OF OPERATION 7 AM TO 10 PM MONDAY THROUGH SATURDAY.

ASSESSORS MAP 304 PARCEL 064-000-000 DEED BOOK 39157 PAGE 493 ASSESSORS MAP 304 PARCEL 064-001-000 DEED BOOK 36281 PAGE 195 PLAN 160 OF 1992 PLAN 80 OF 2006 PLOT PLAN BY GUERRIERE & HALNON INC. DATED SEPTEMBER RIGHT OF WAY AND TRACK MAP STATIONS 20+98.18 TO STATION 73+80 DATED JUNE 30, 1915. PLAN 829 OF 1961.

DRAWING INDEX:

1. COVER SHEET

2. EXISTING CONDITIONS PLAN

3. SITE LAYOUT PLAN

4. SITE GRADING AND UTILITY PLAN

5. SITE PLANTING PLAN

6. EROSION CONTROL PLAN

7. CONSTRUCTION DETAILS -

8. CONSTRUCTION DETAILS - 2

9. CONSTRUCTION DETAILS - 3 10. CONSTRUCTION DETAILS - 4 SITE LIGHTING-LIGHTING PLAN,

PHOTOMETRICS AND SCHEDULES BY SK & ASSOCIATES

MAP 304 PARCEL 064-000 ABRUZZI REALTY TRUST 55 COUTU STREET FRANKLIN, MASSACHUSETTS

MAP 304 PARCEL 064-001 FERRARA FAMILY REALTY TRUST PO BOX 482 FRANKLIN, MA 02038

APPLICANT: FRANKLIN FLEX SPACE, LLC 13 CLOVELLY ROAD WELLESLEY, MASSACHUSETTS

MEDWAY MASSACHUSETTS

GENERAL CONTRACTOR: A & H BUILDING PARTNERS - DESIGN BUILD - CONSTRUCTION MANAGERS - OWNERS REPRESENTATION - DUE DILLIGANCE ANALYSIS

DATE

6/21

6/21

6/21

5/21 | FIELD BY:

DESIGNED BY:

COMP

DRAWN BY:


CHECKED BY:


SITE PLAN COVER SHEET WASHINGTON STREET FRANKLIN, MASSACHUSETTS PREPARED FOR FRANKLIN FLEX SPACE, LLC 13 CLOVELLY ROAD WELLESLEY, MASSACHUSETTS JUNE 28, 2021 SCALE: 1" = 100'


INT. FIELD BOOK PG# INC. 6/21 CALCS BY: RRG


850 FRANKLIN STREET SUITE 11D WRENTHAM, MASSACHUSETTS 02093 508-384-6560 FAX 508-384-6566


JUNE 28, 2021 1" = 100' PROJECT UC1502 SHEET 1 of 10

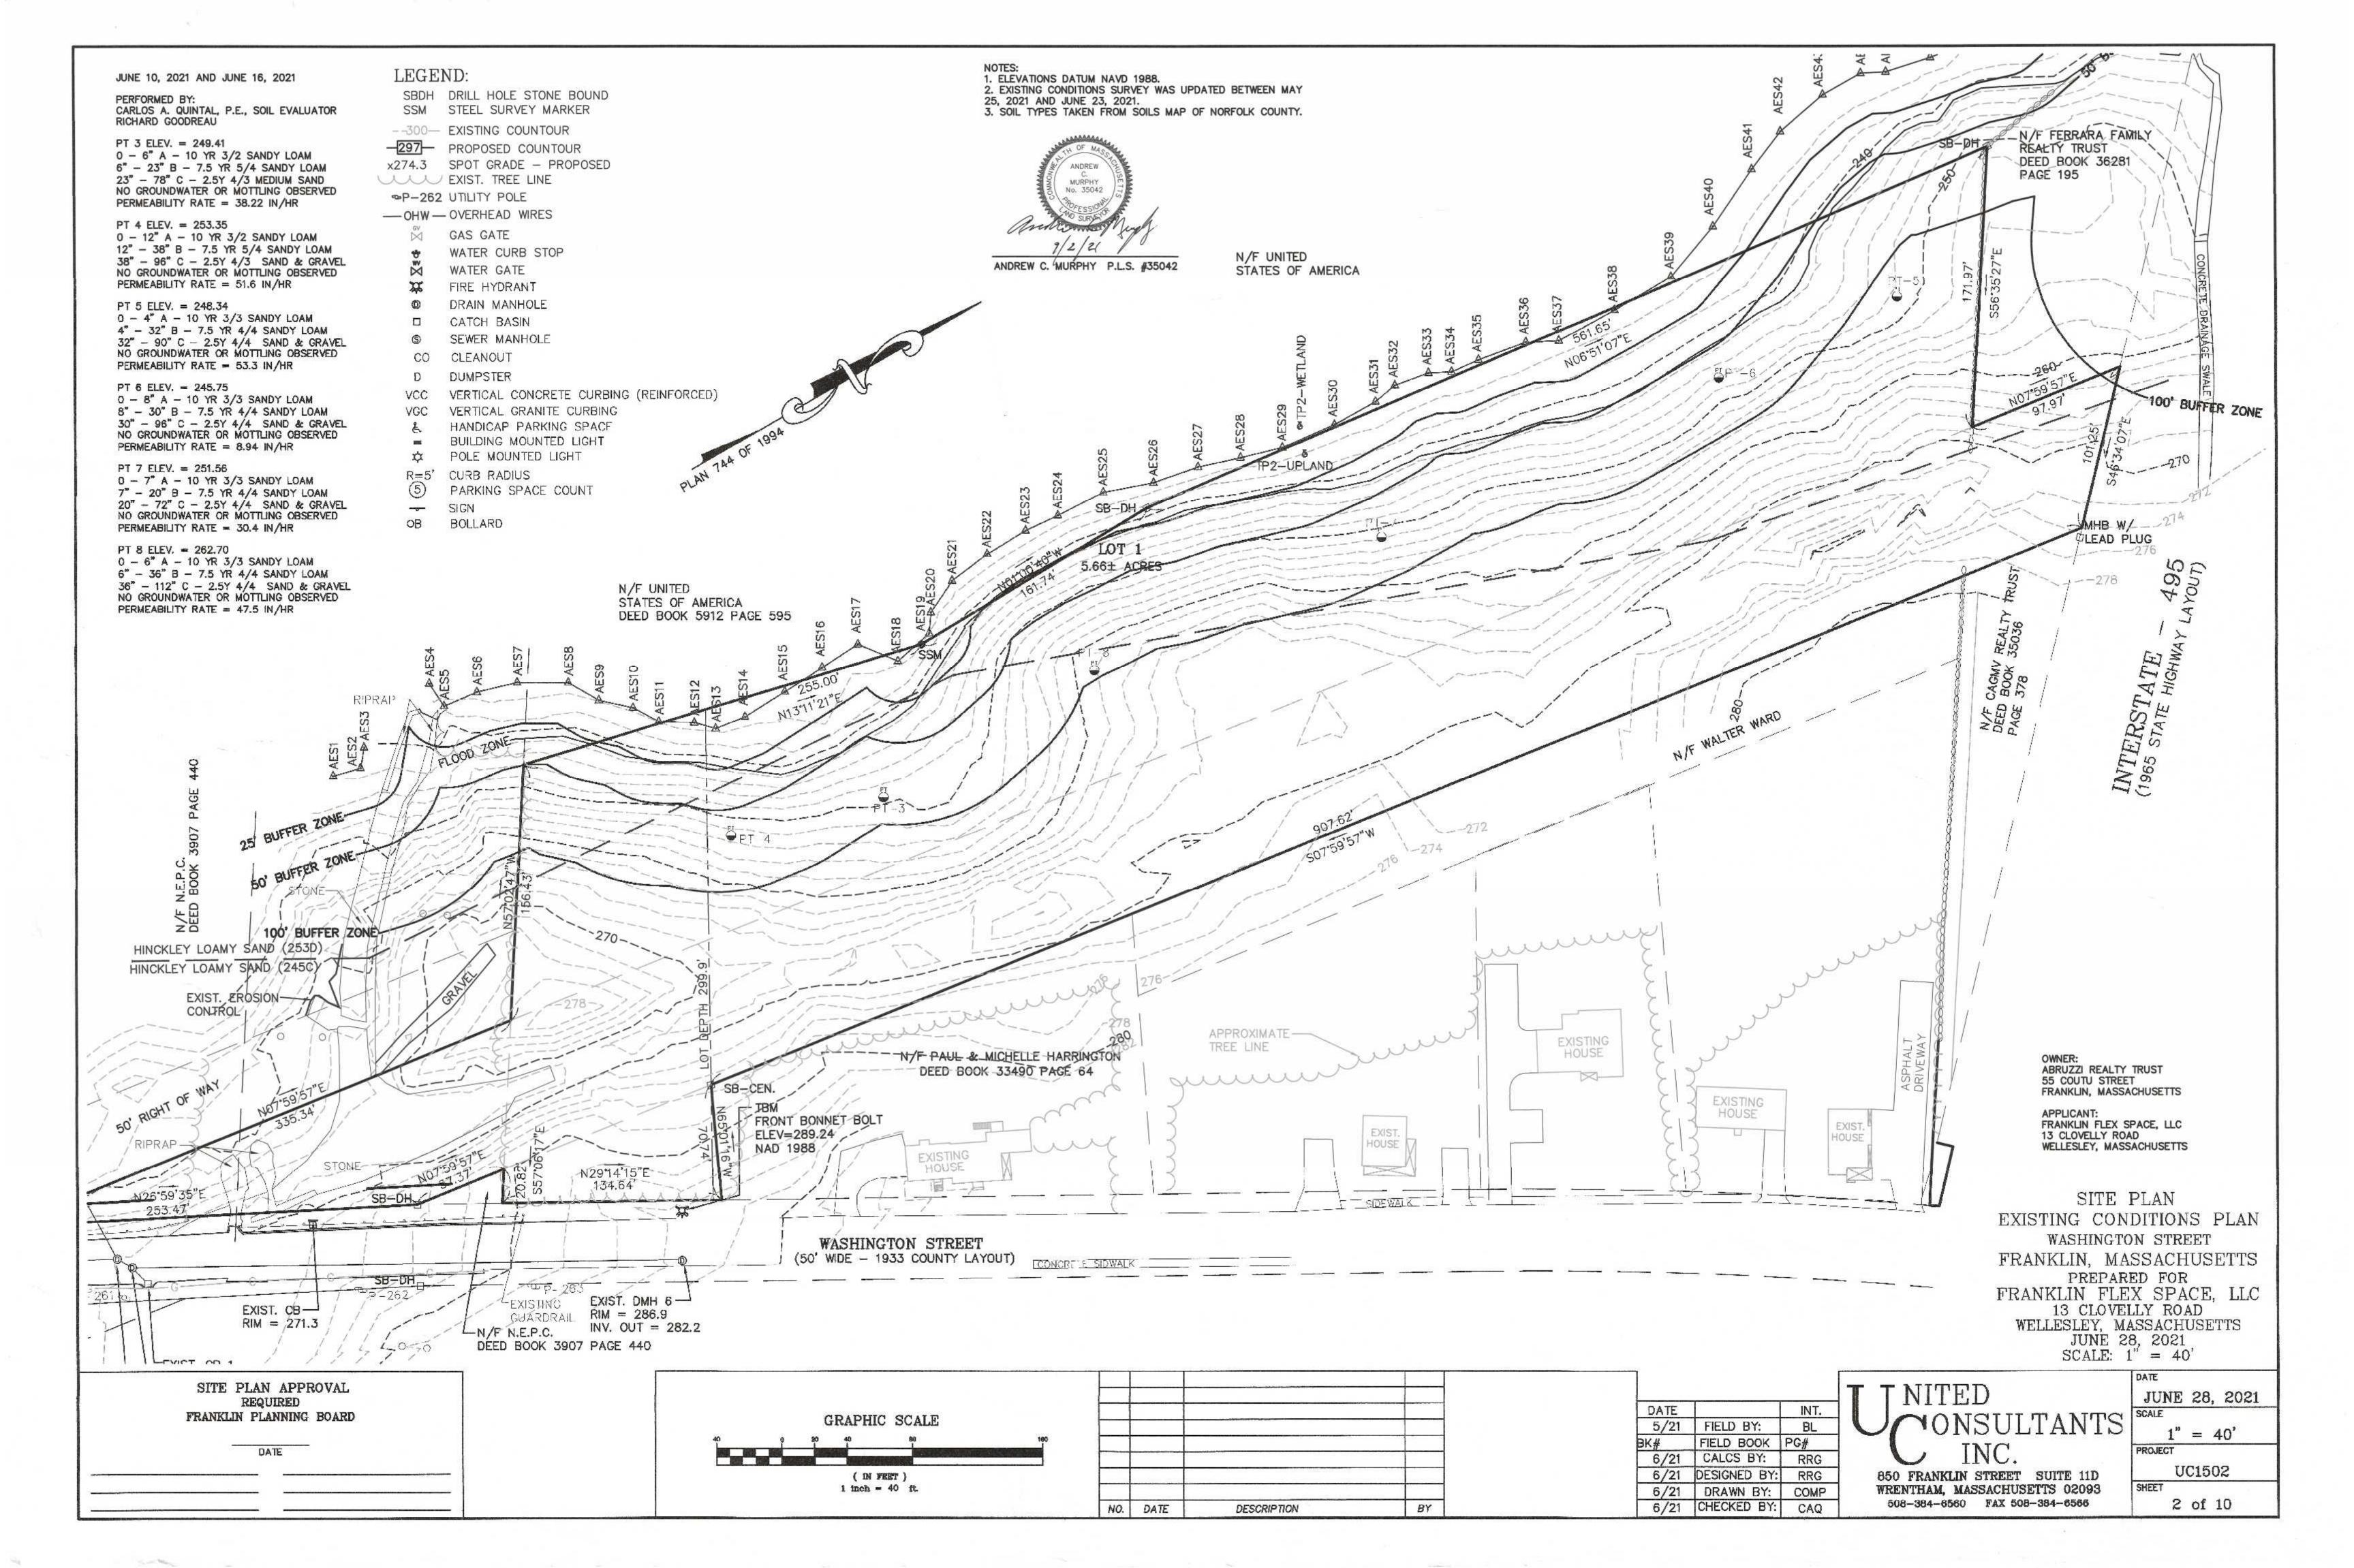


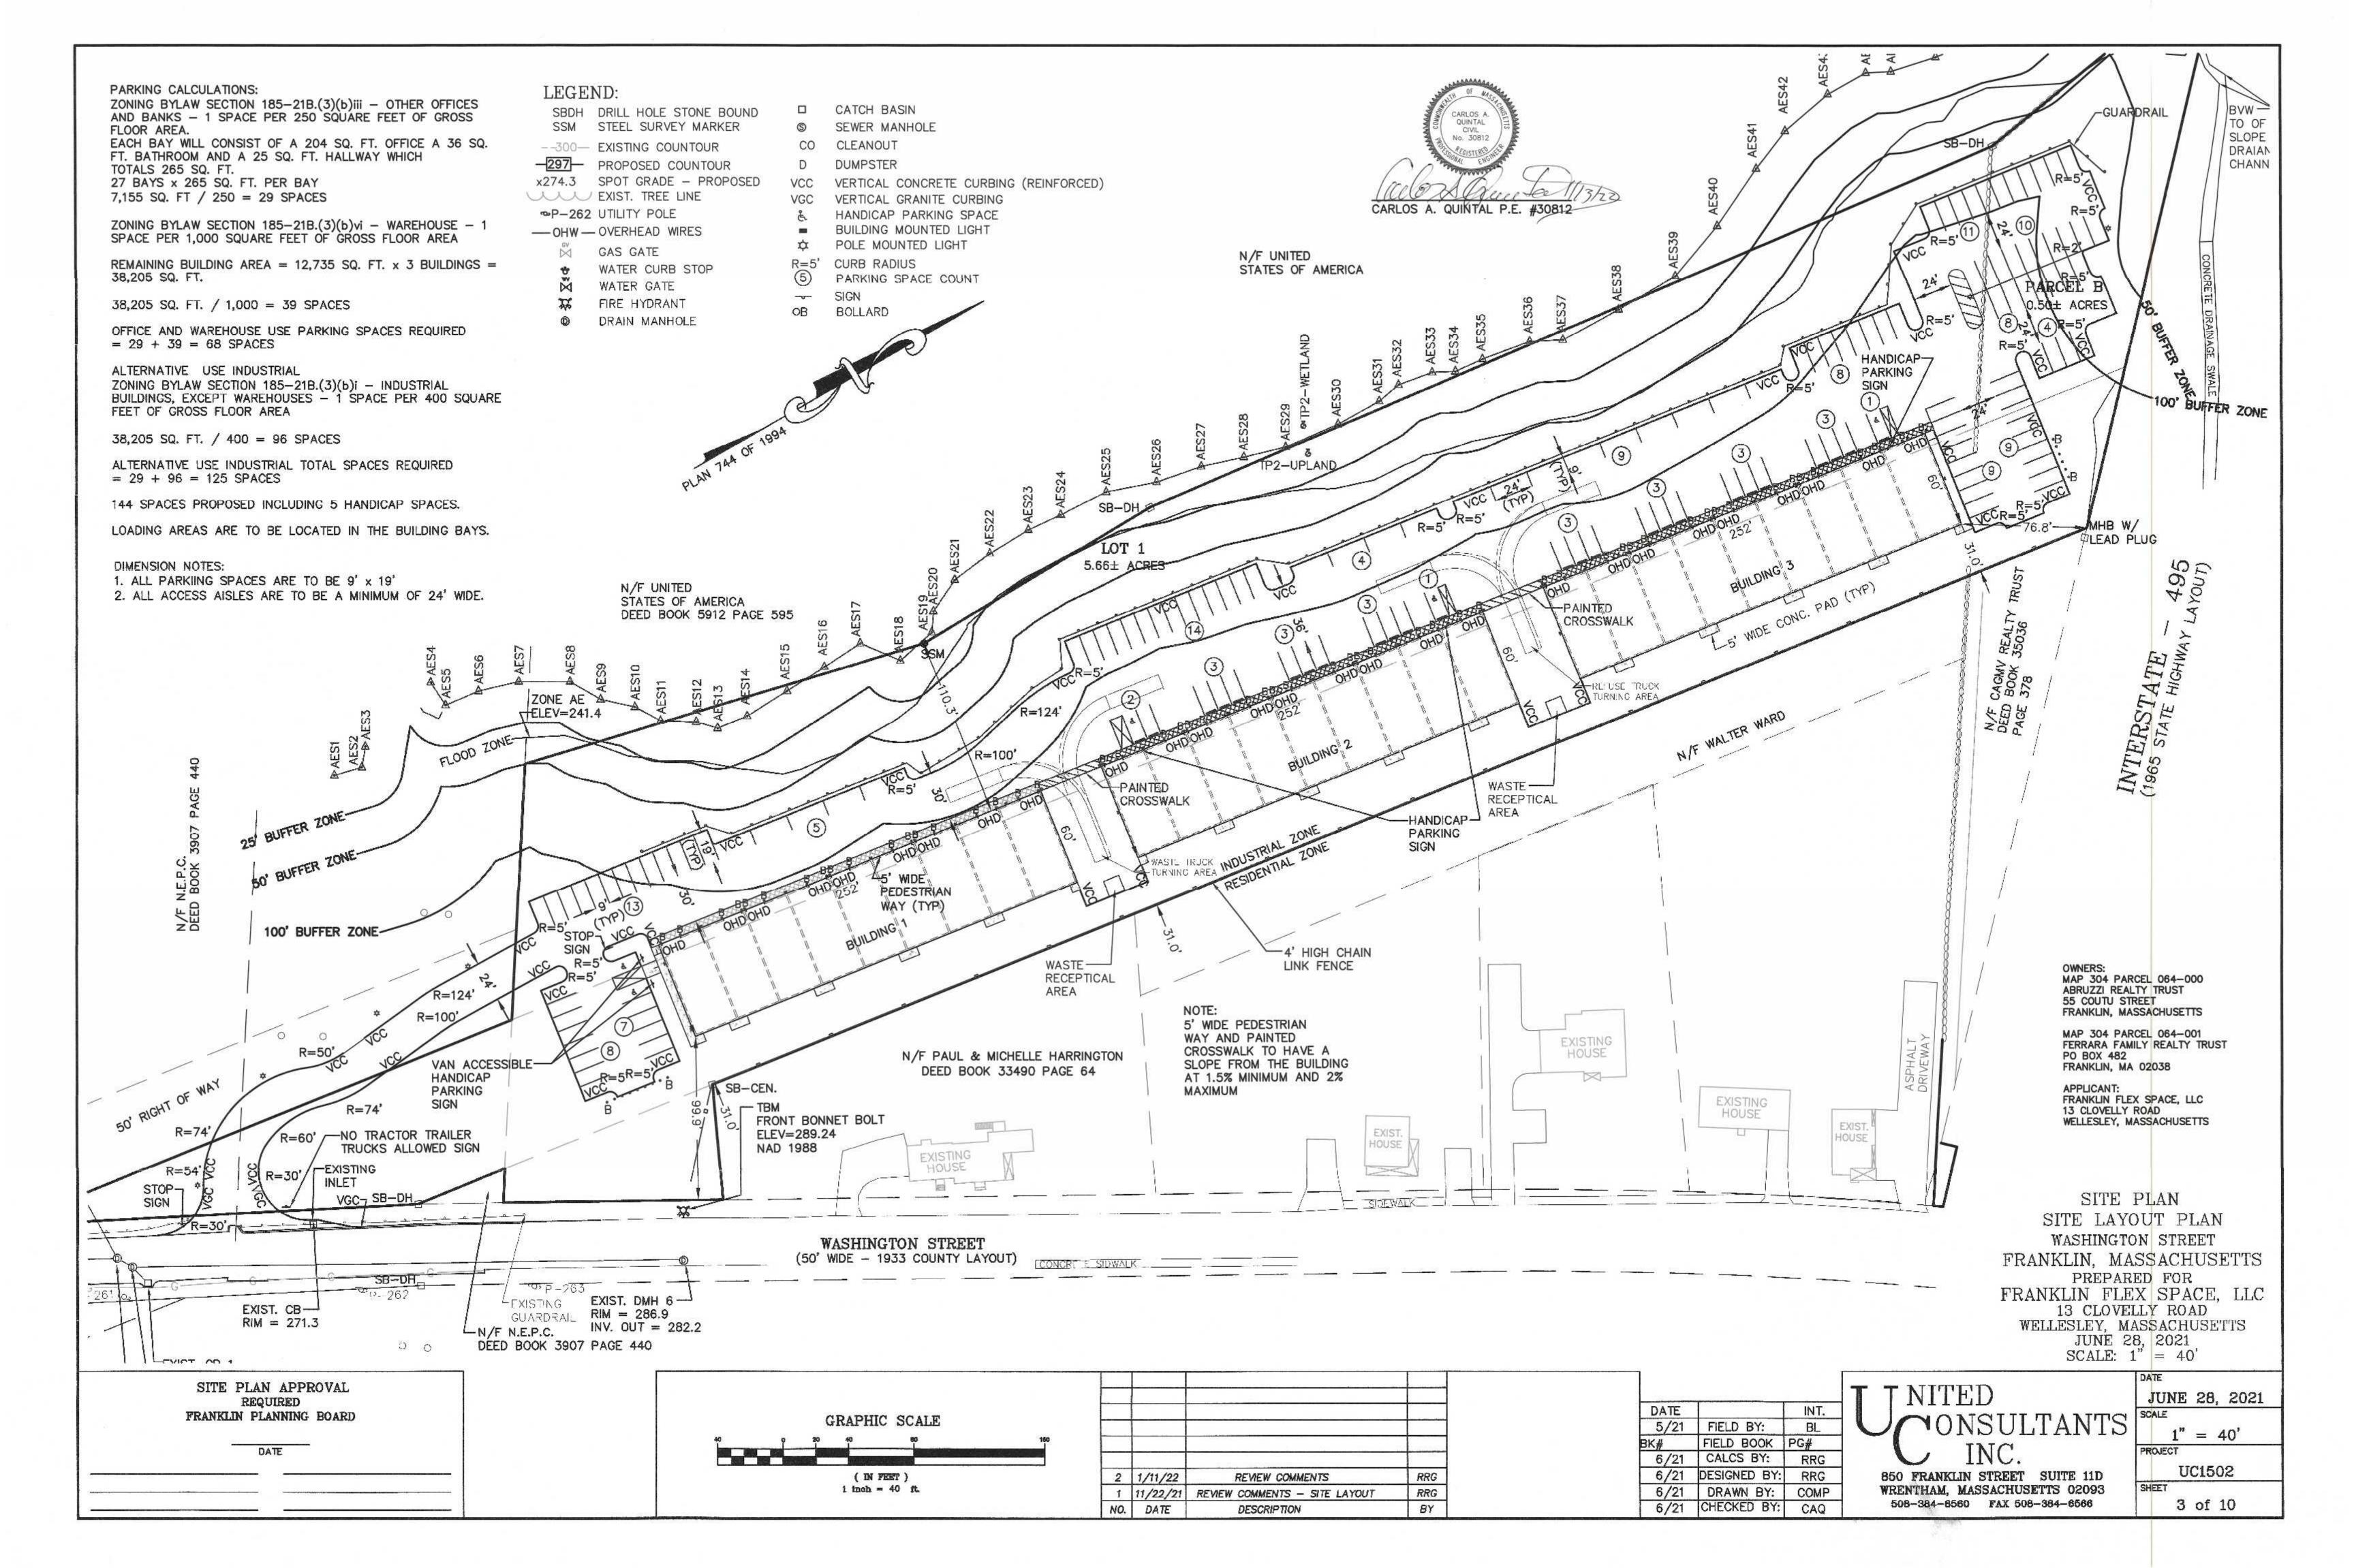


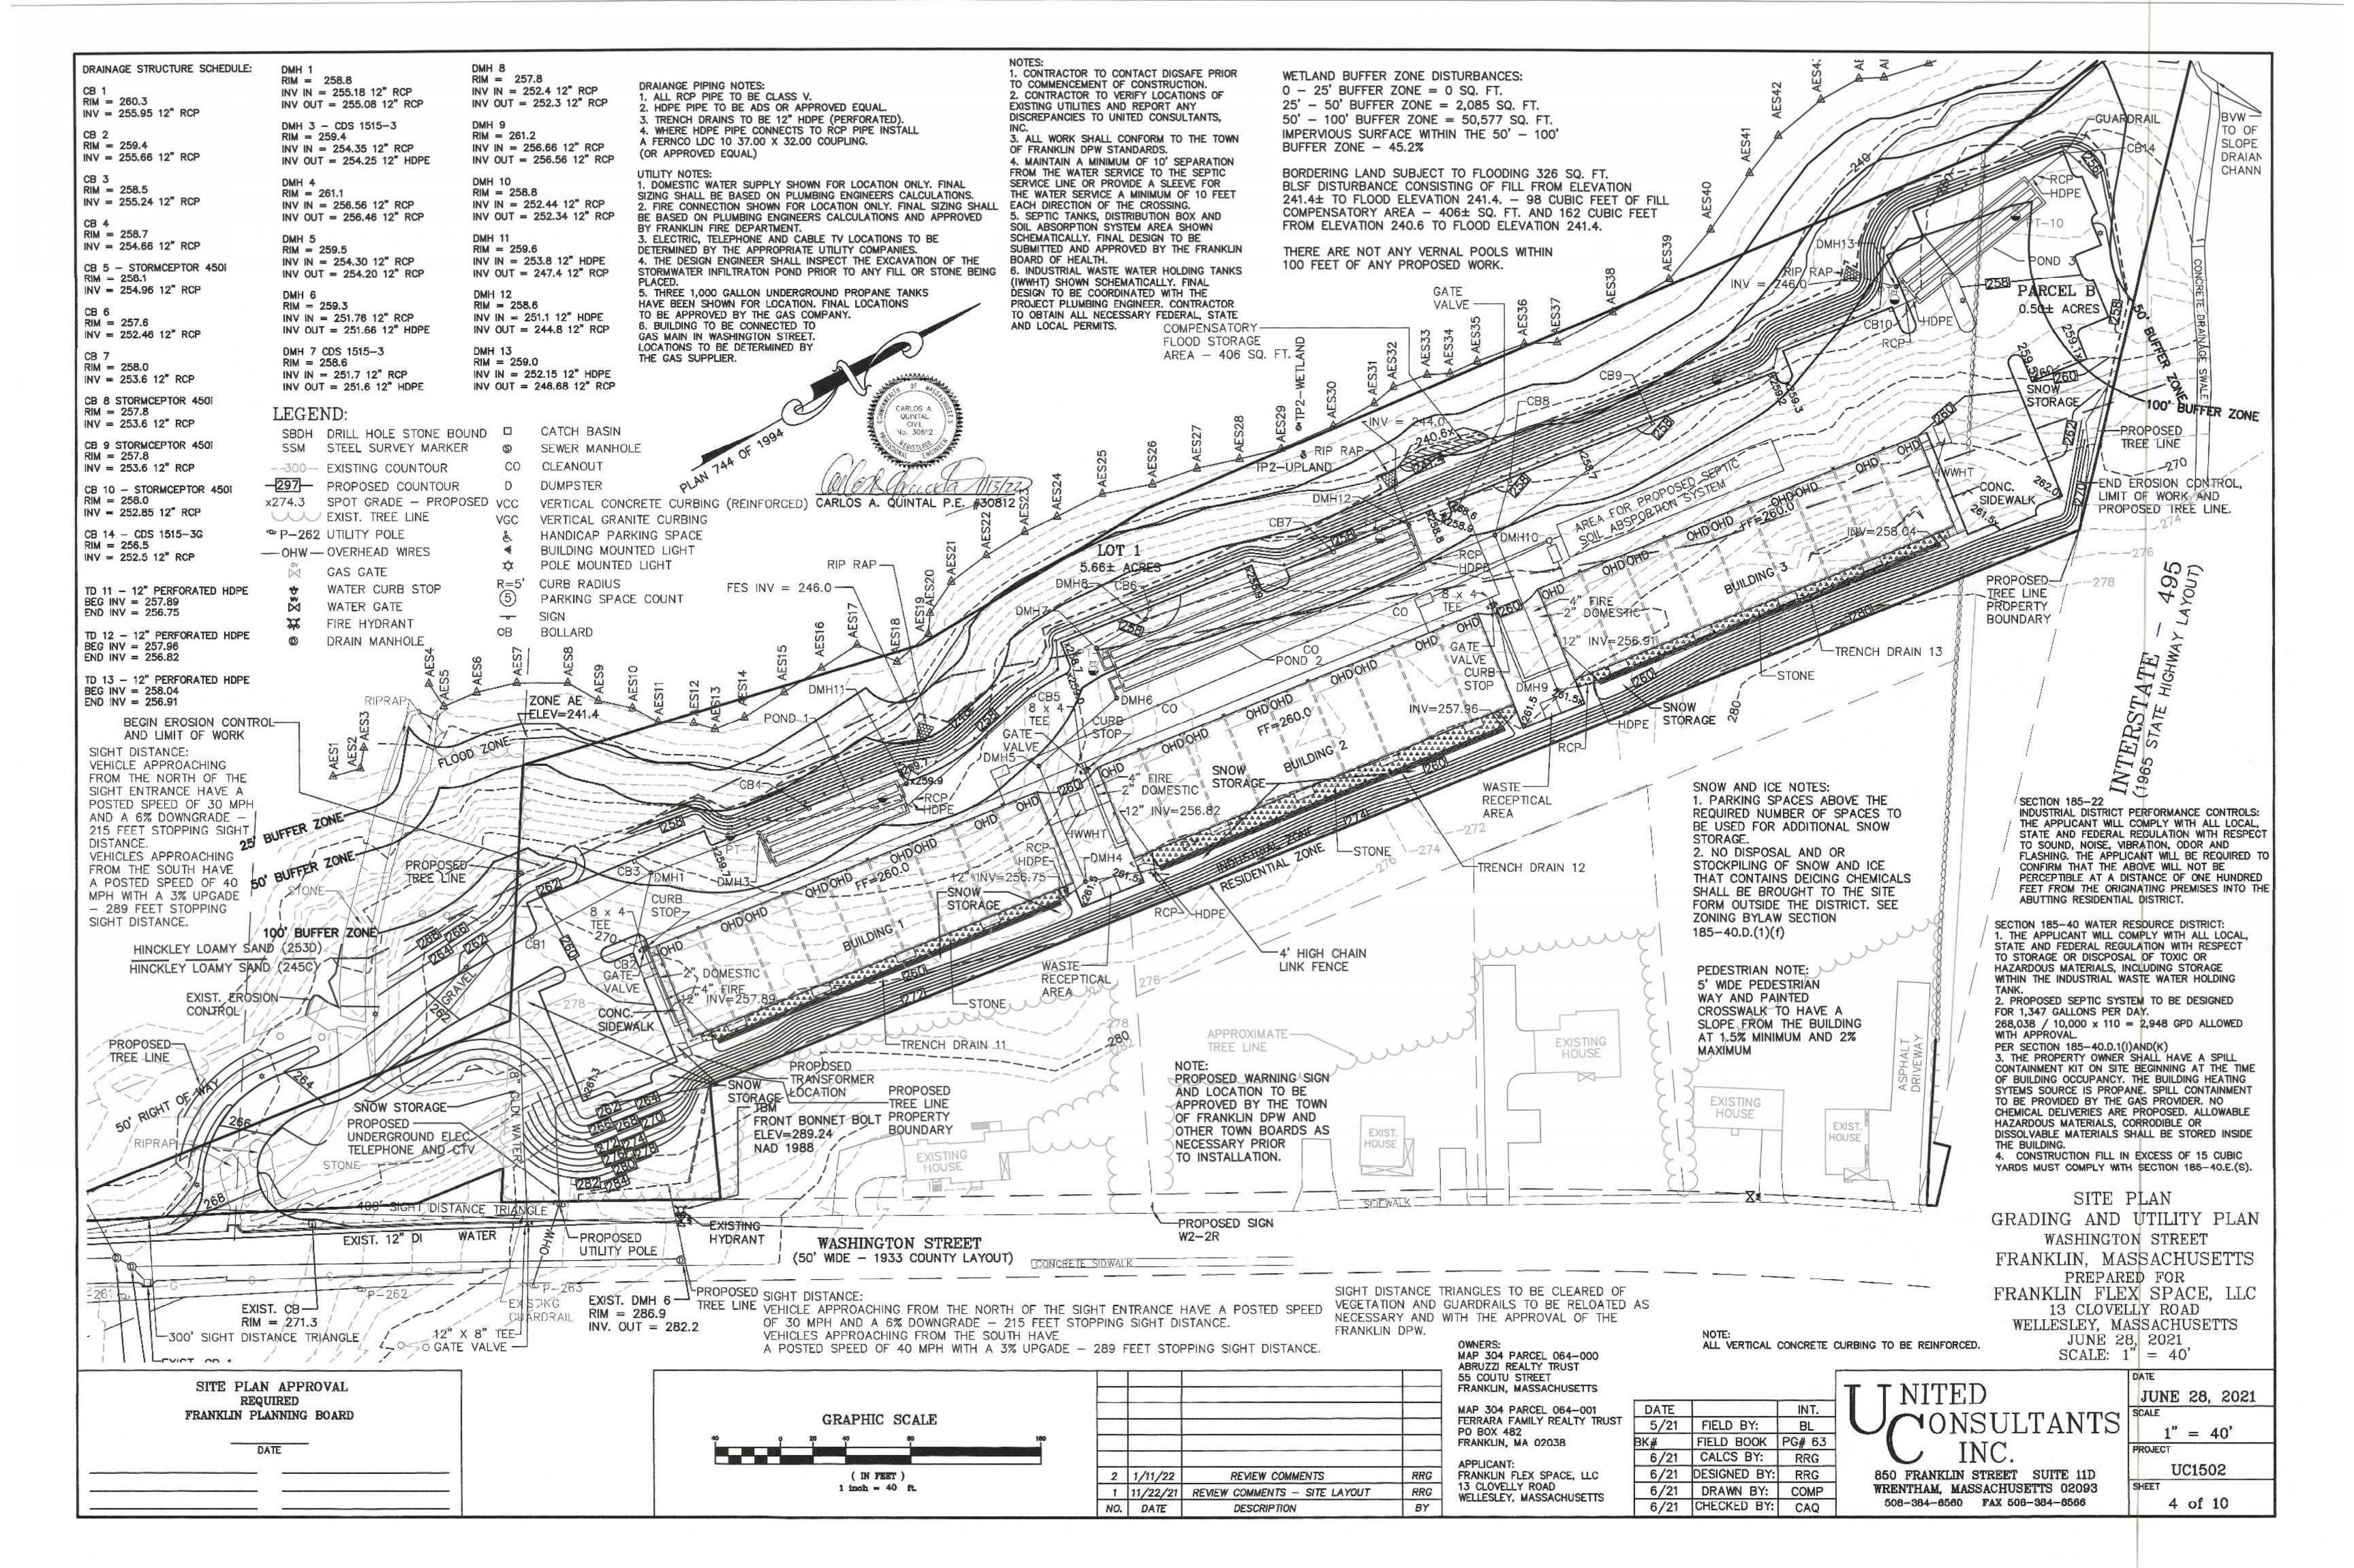


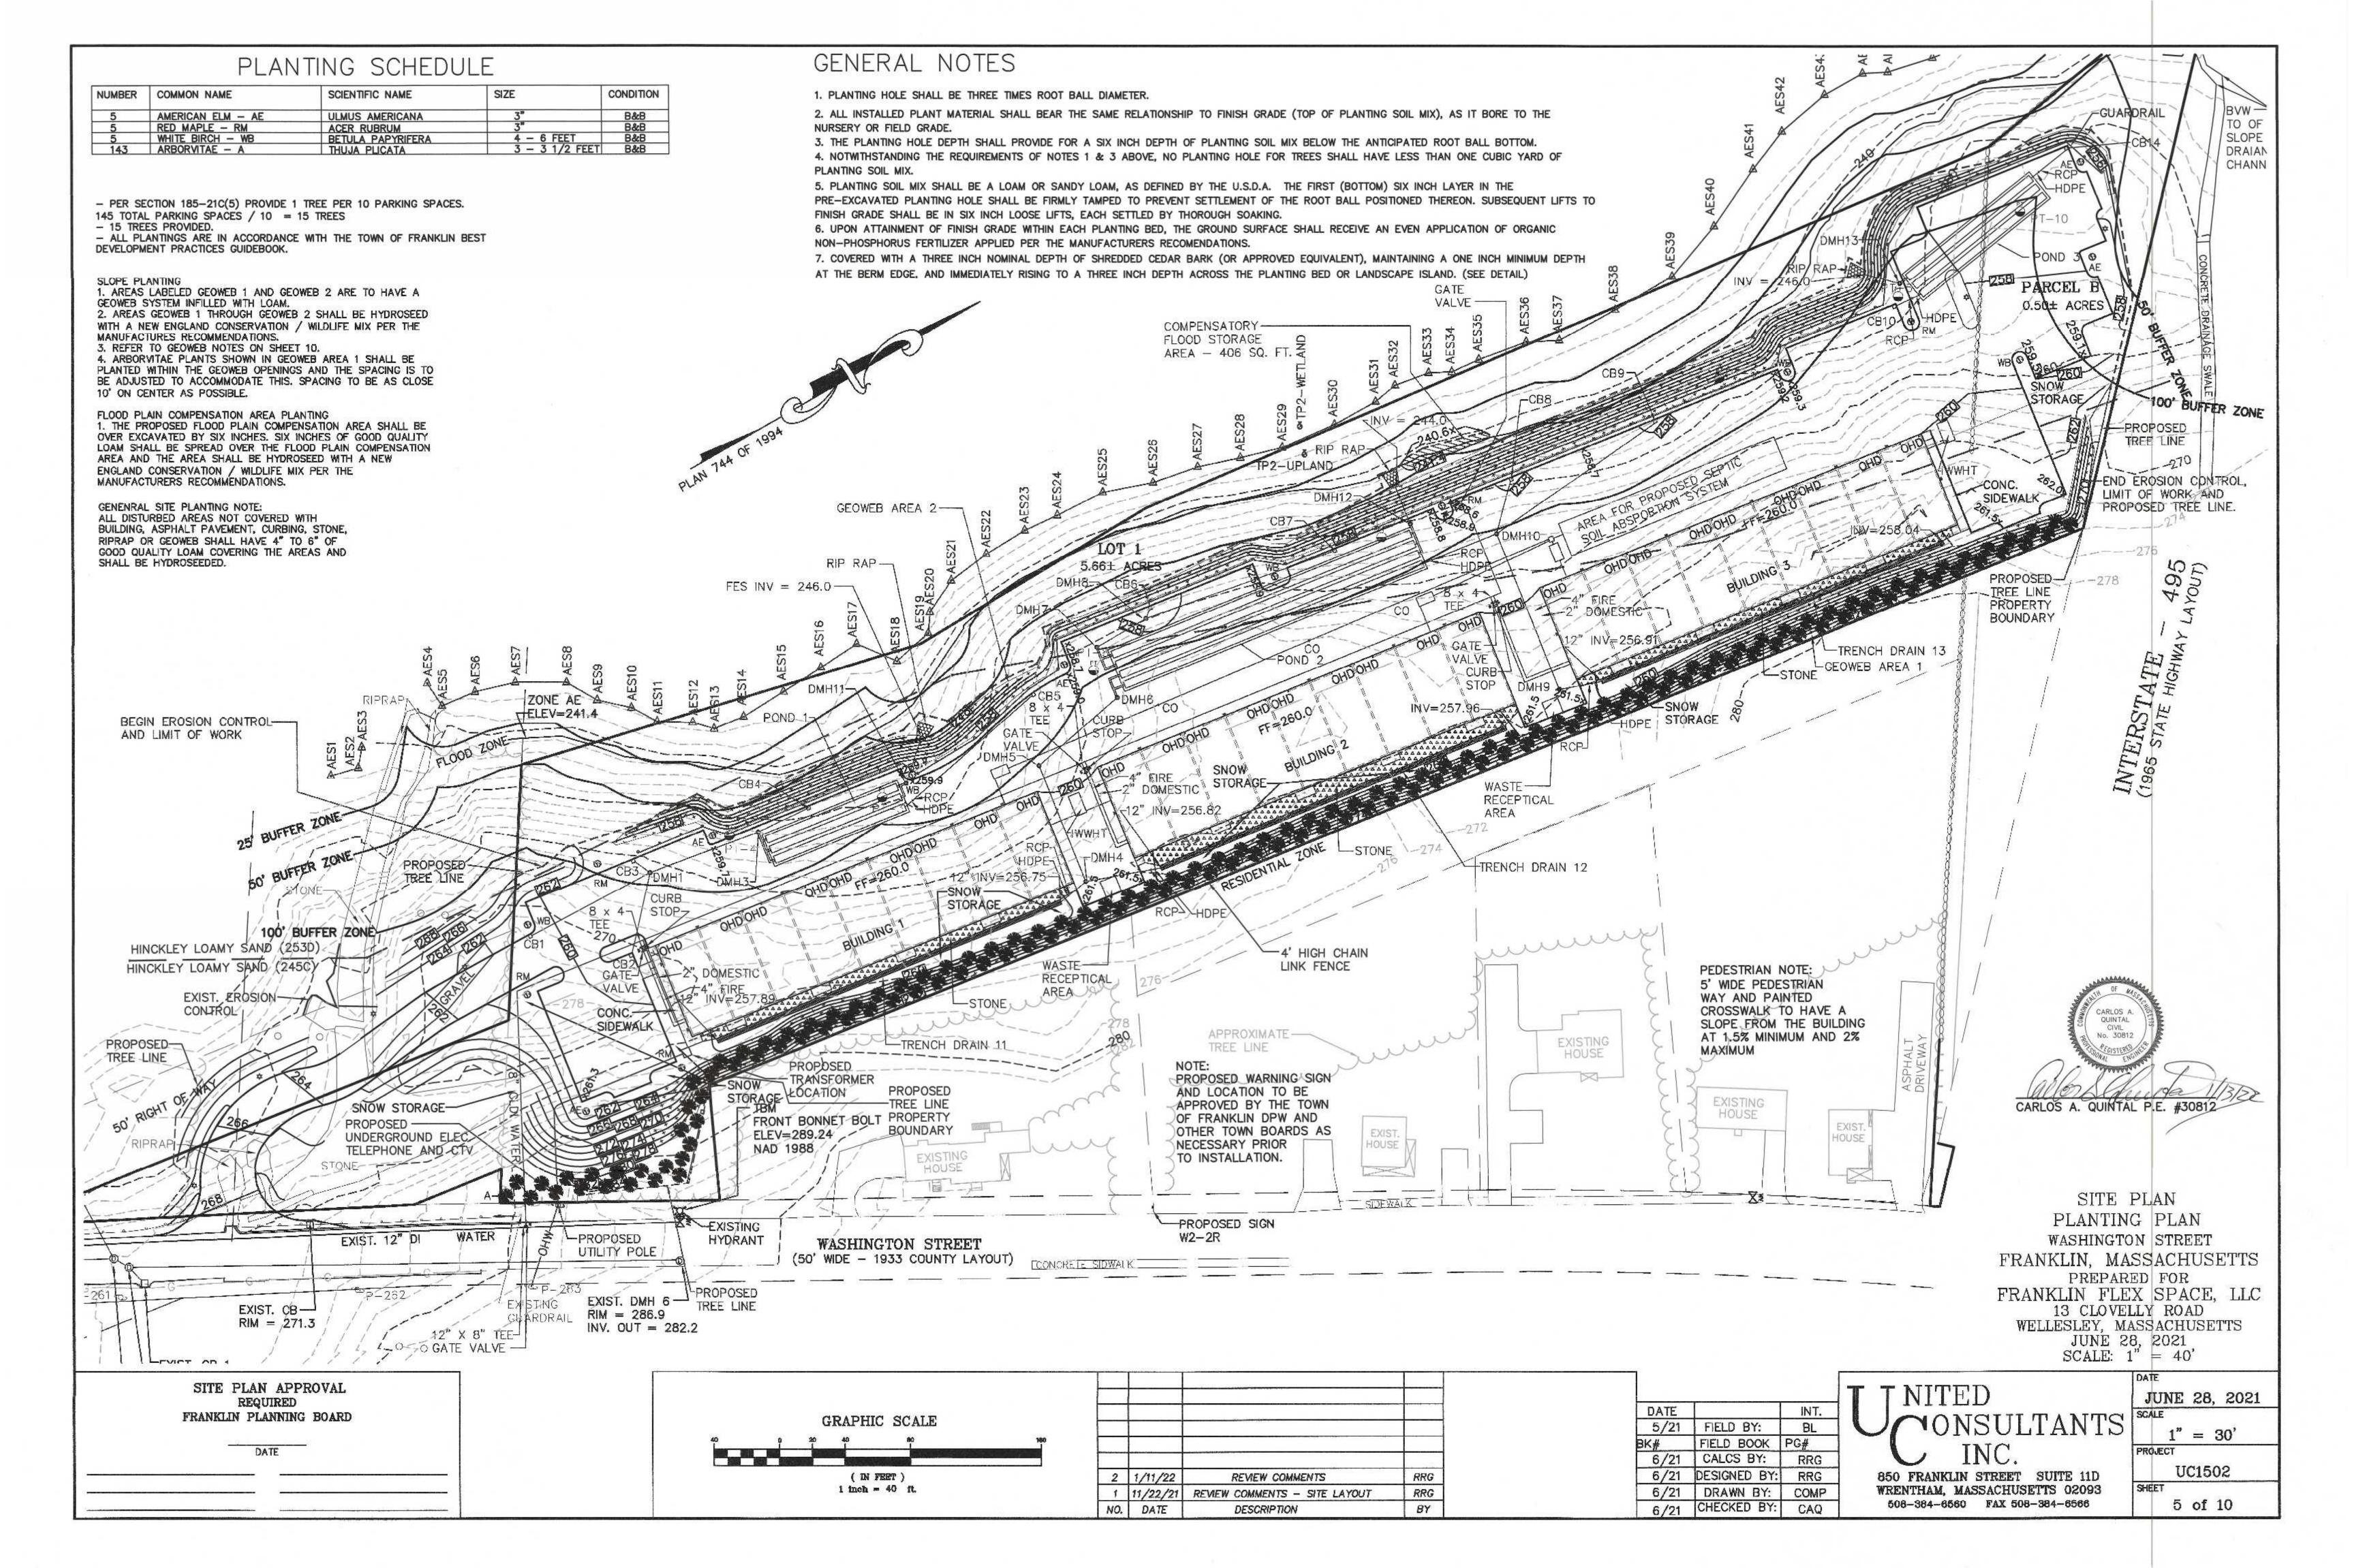


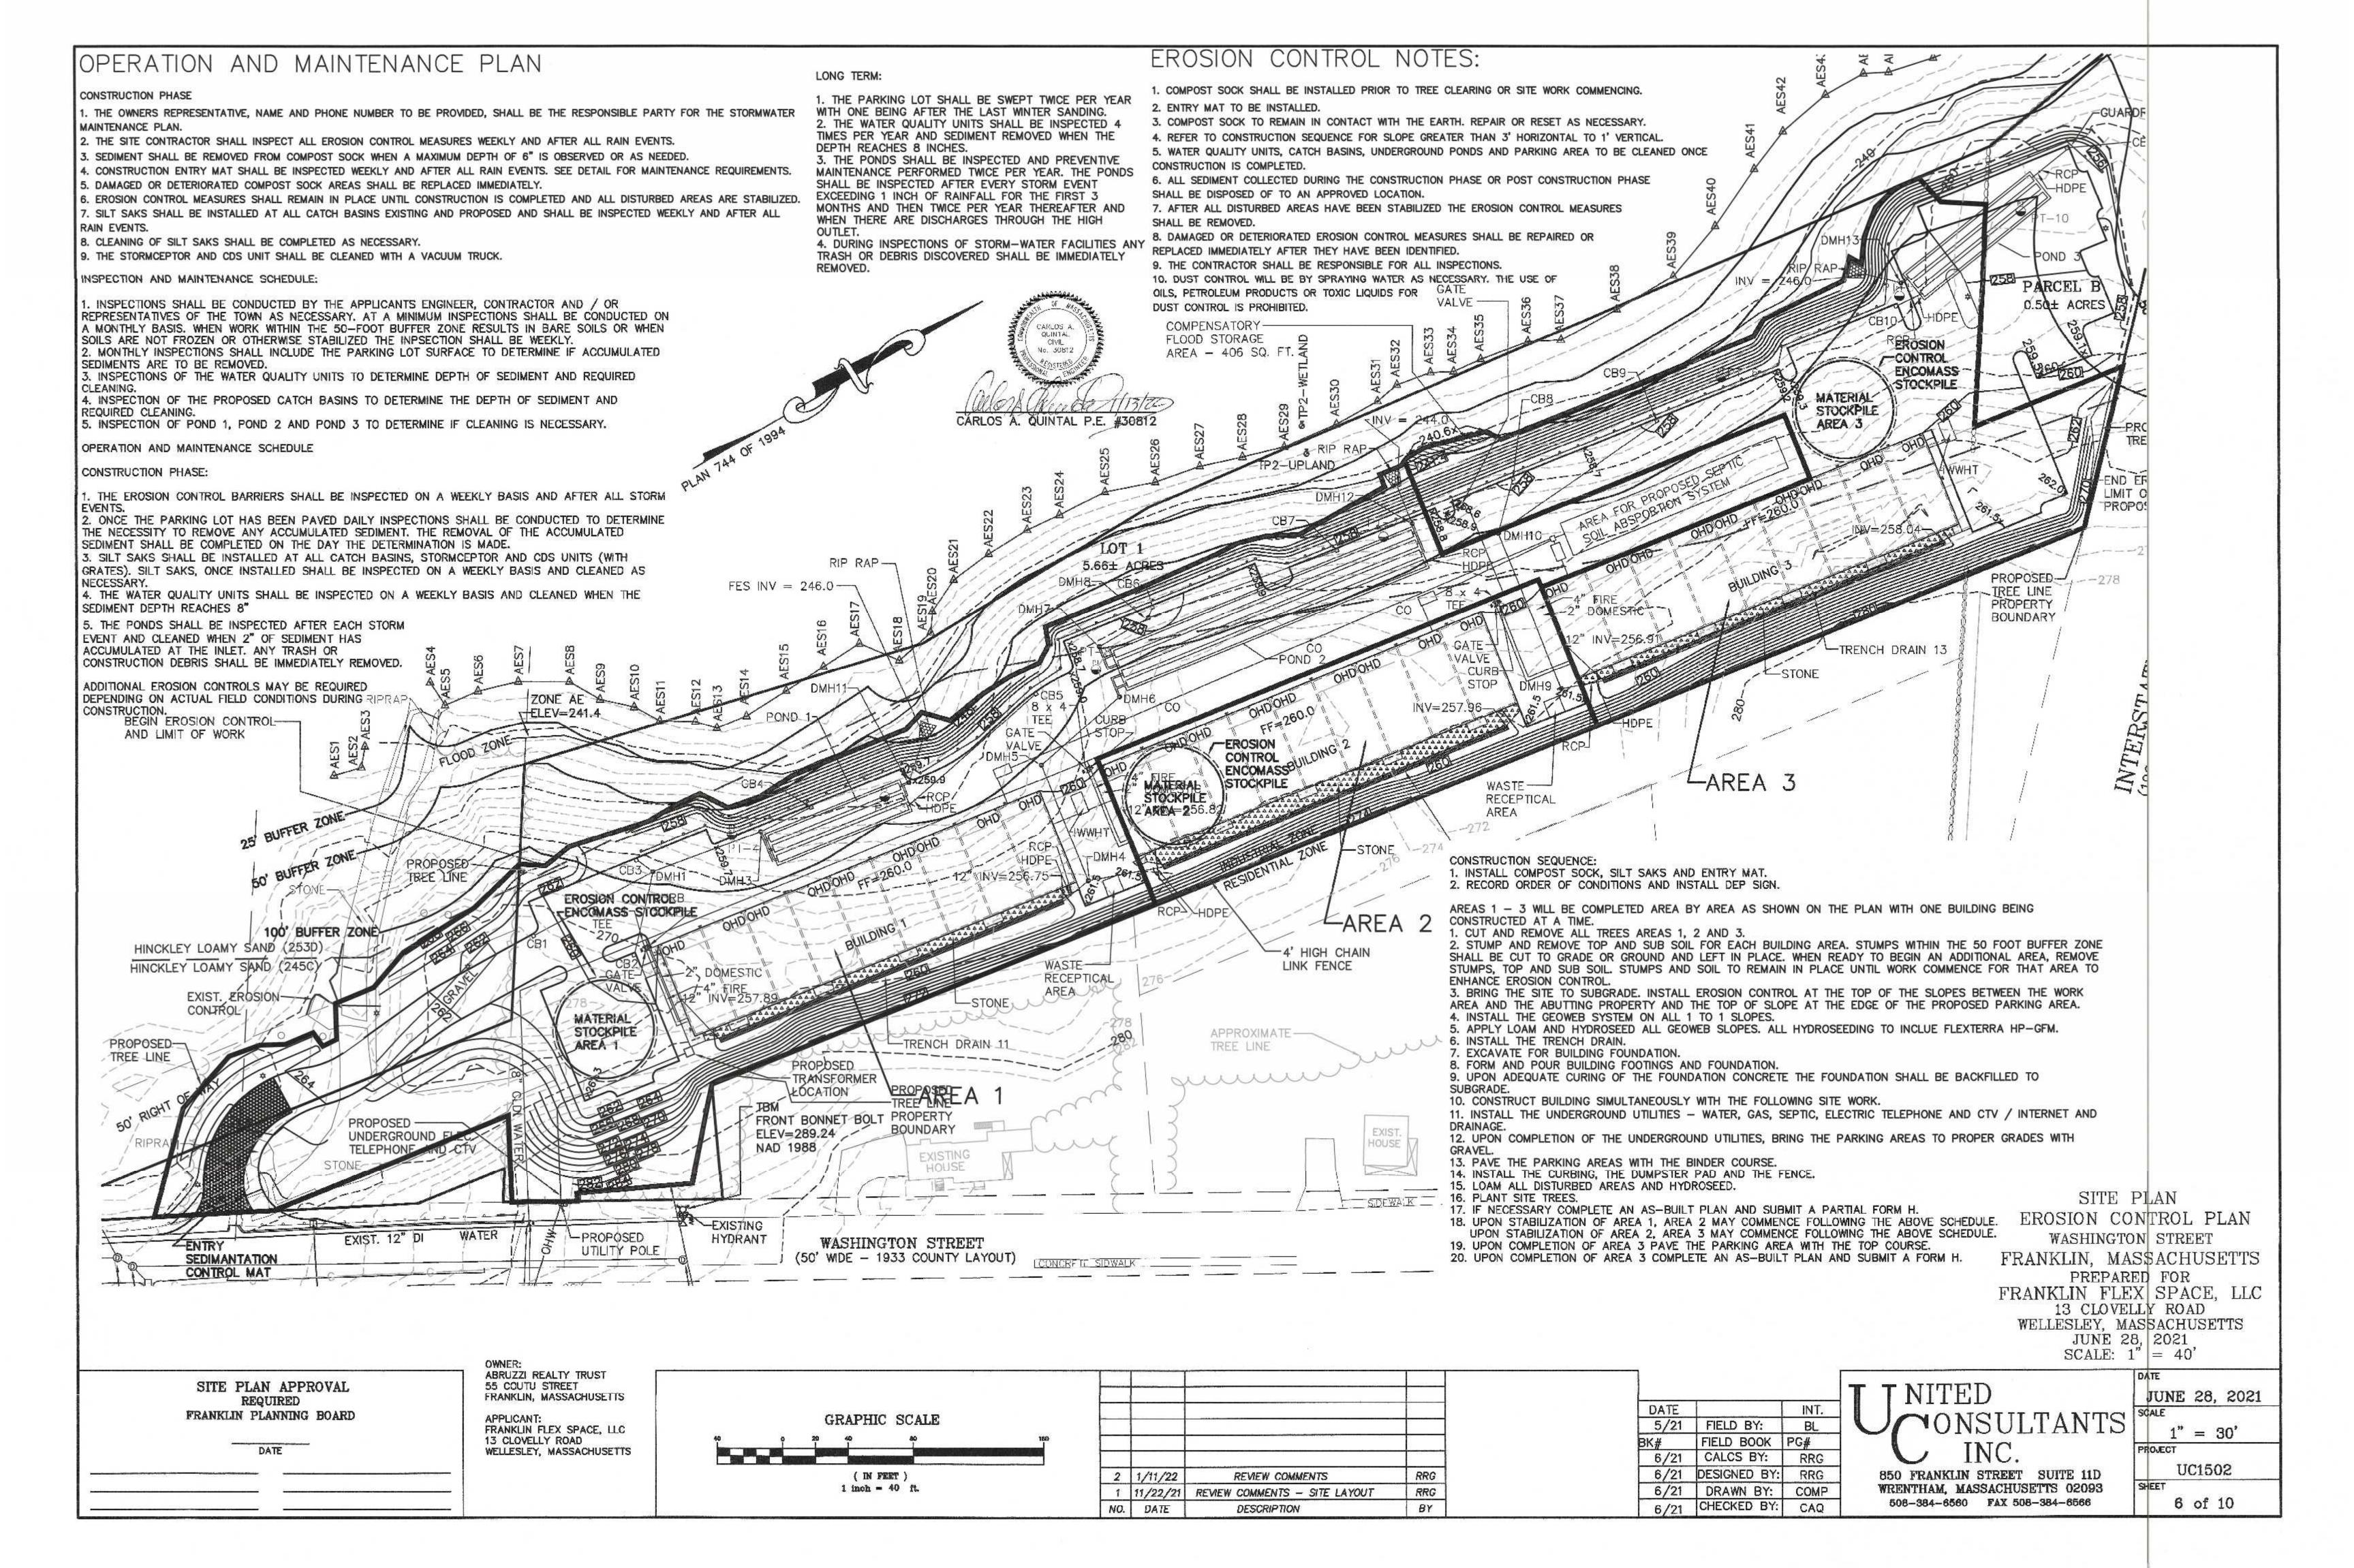


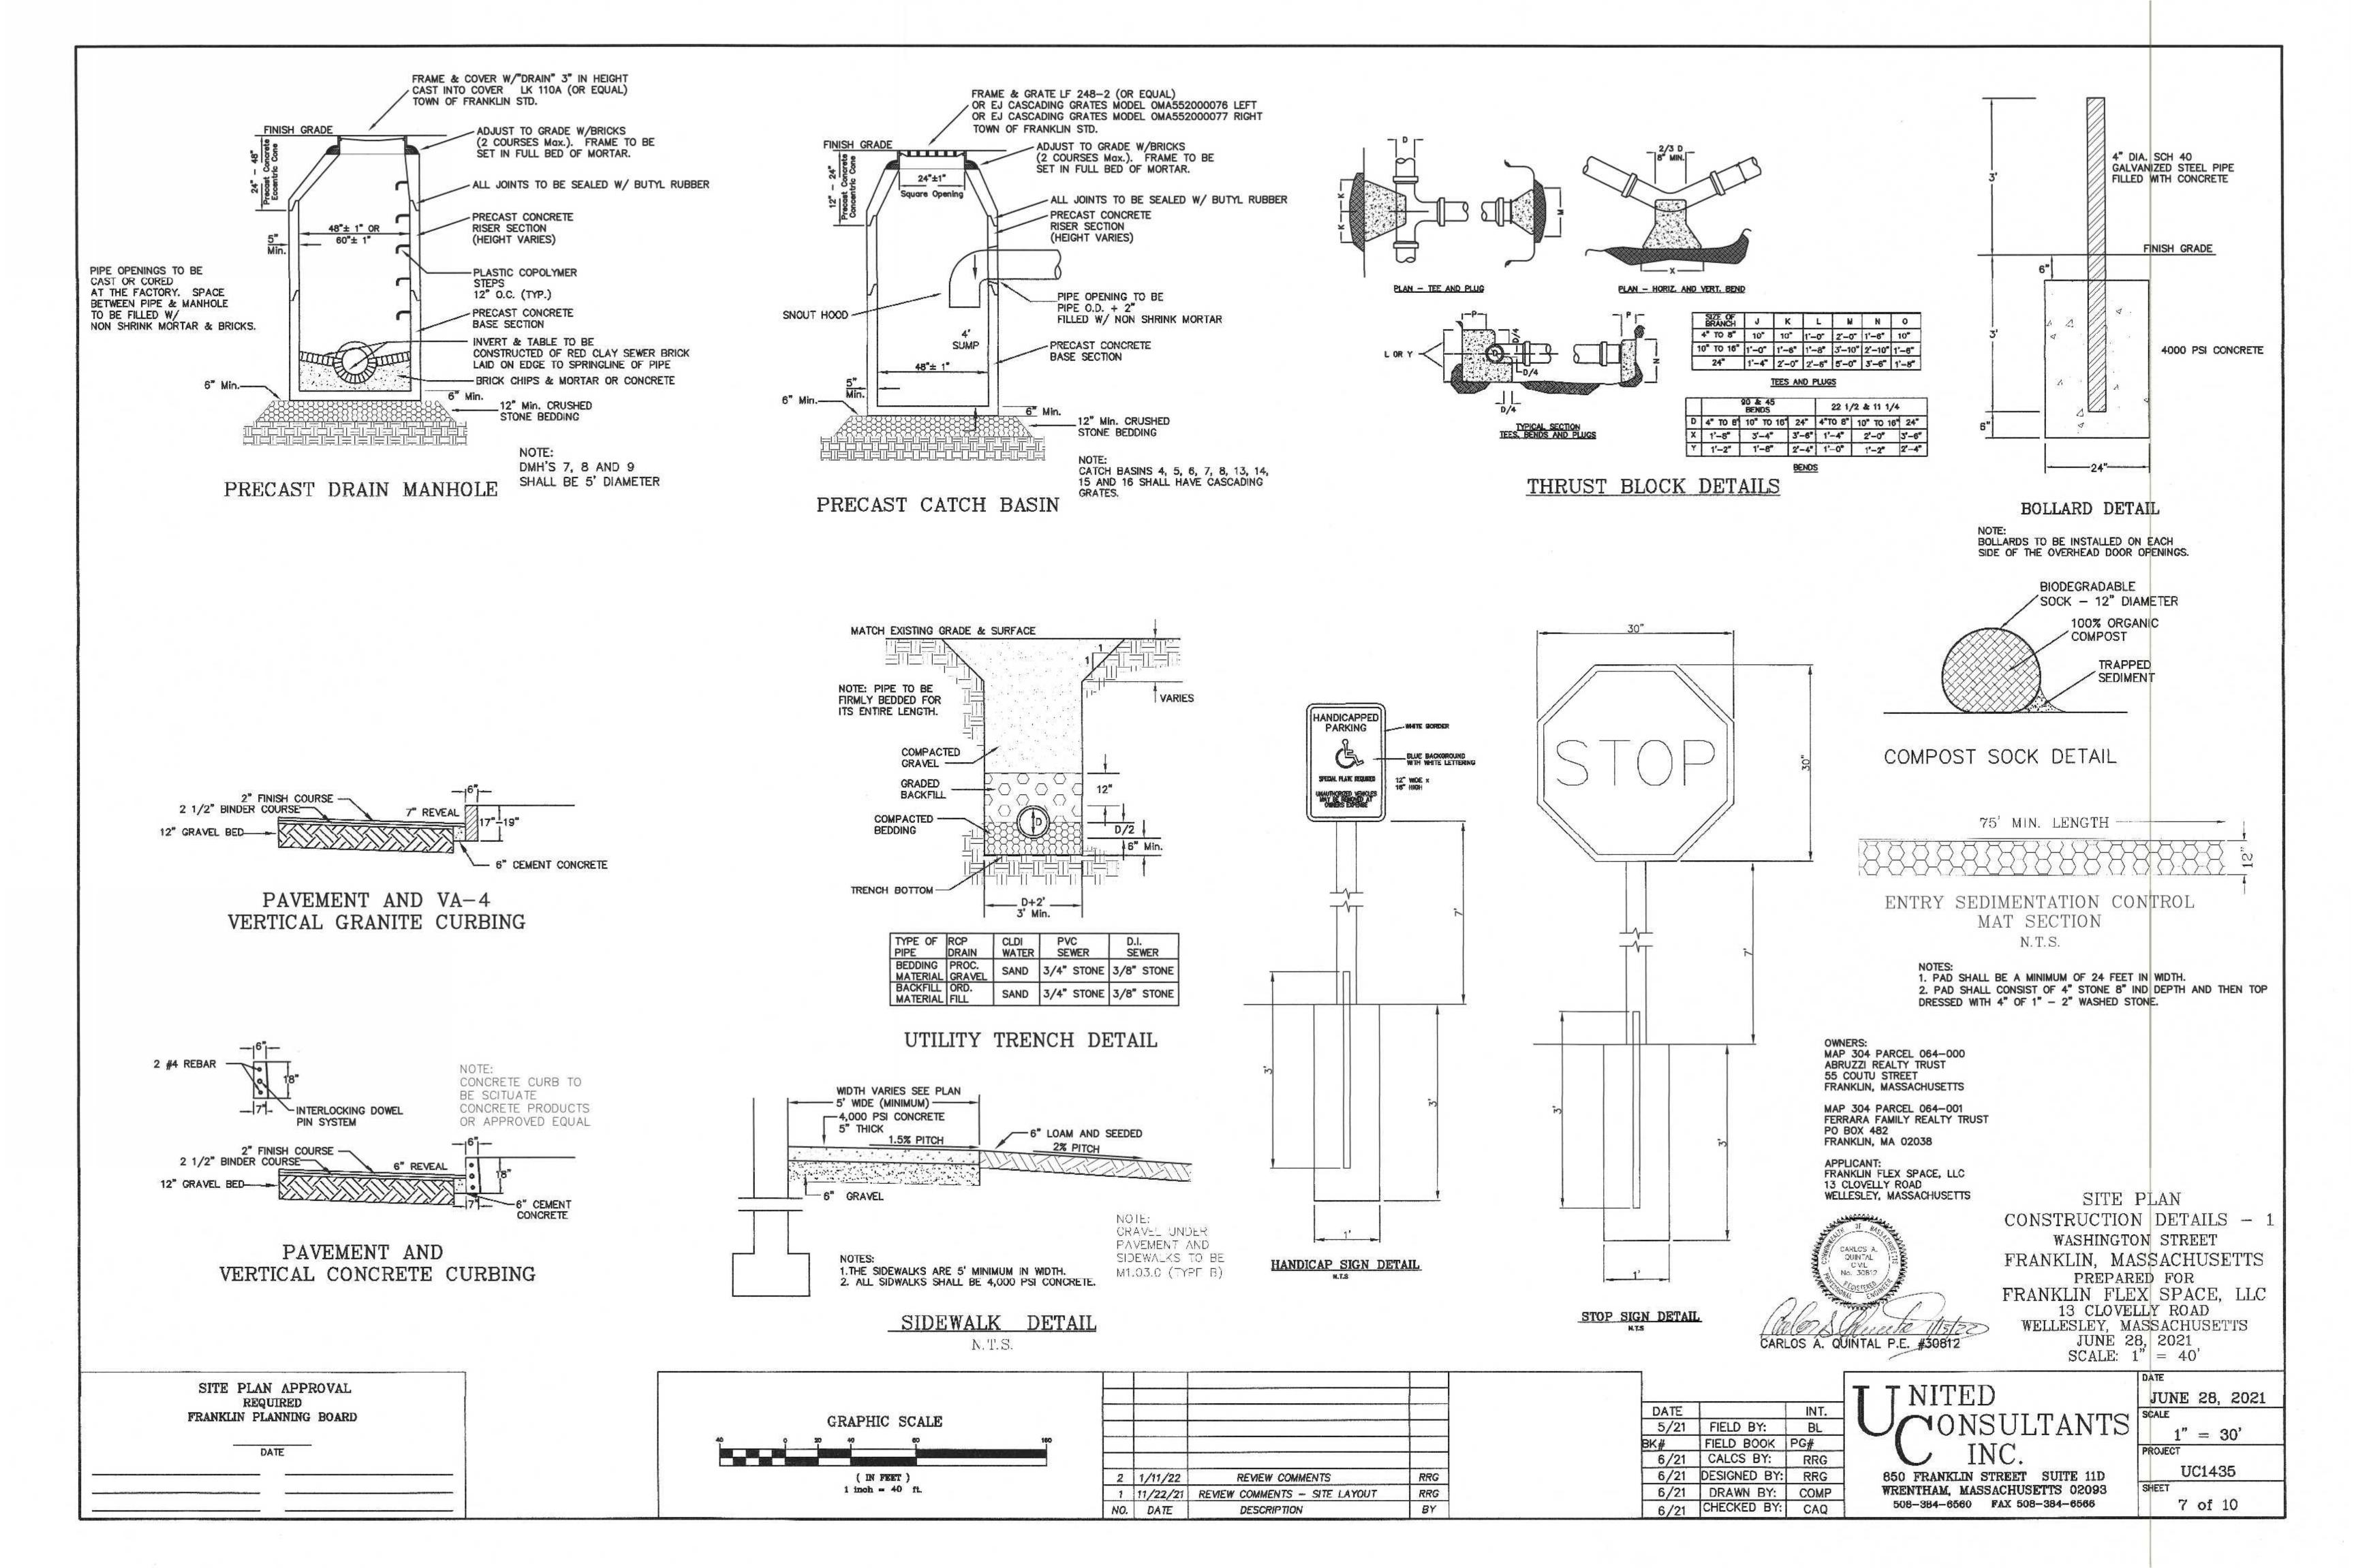

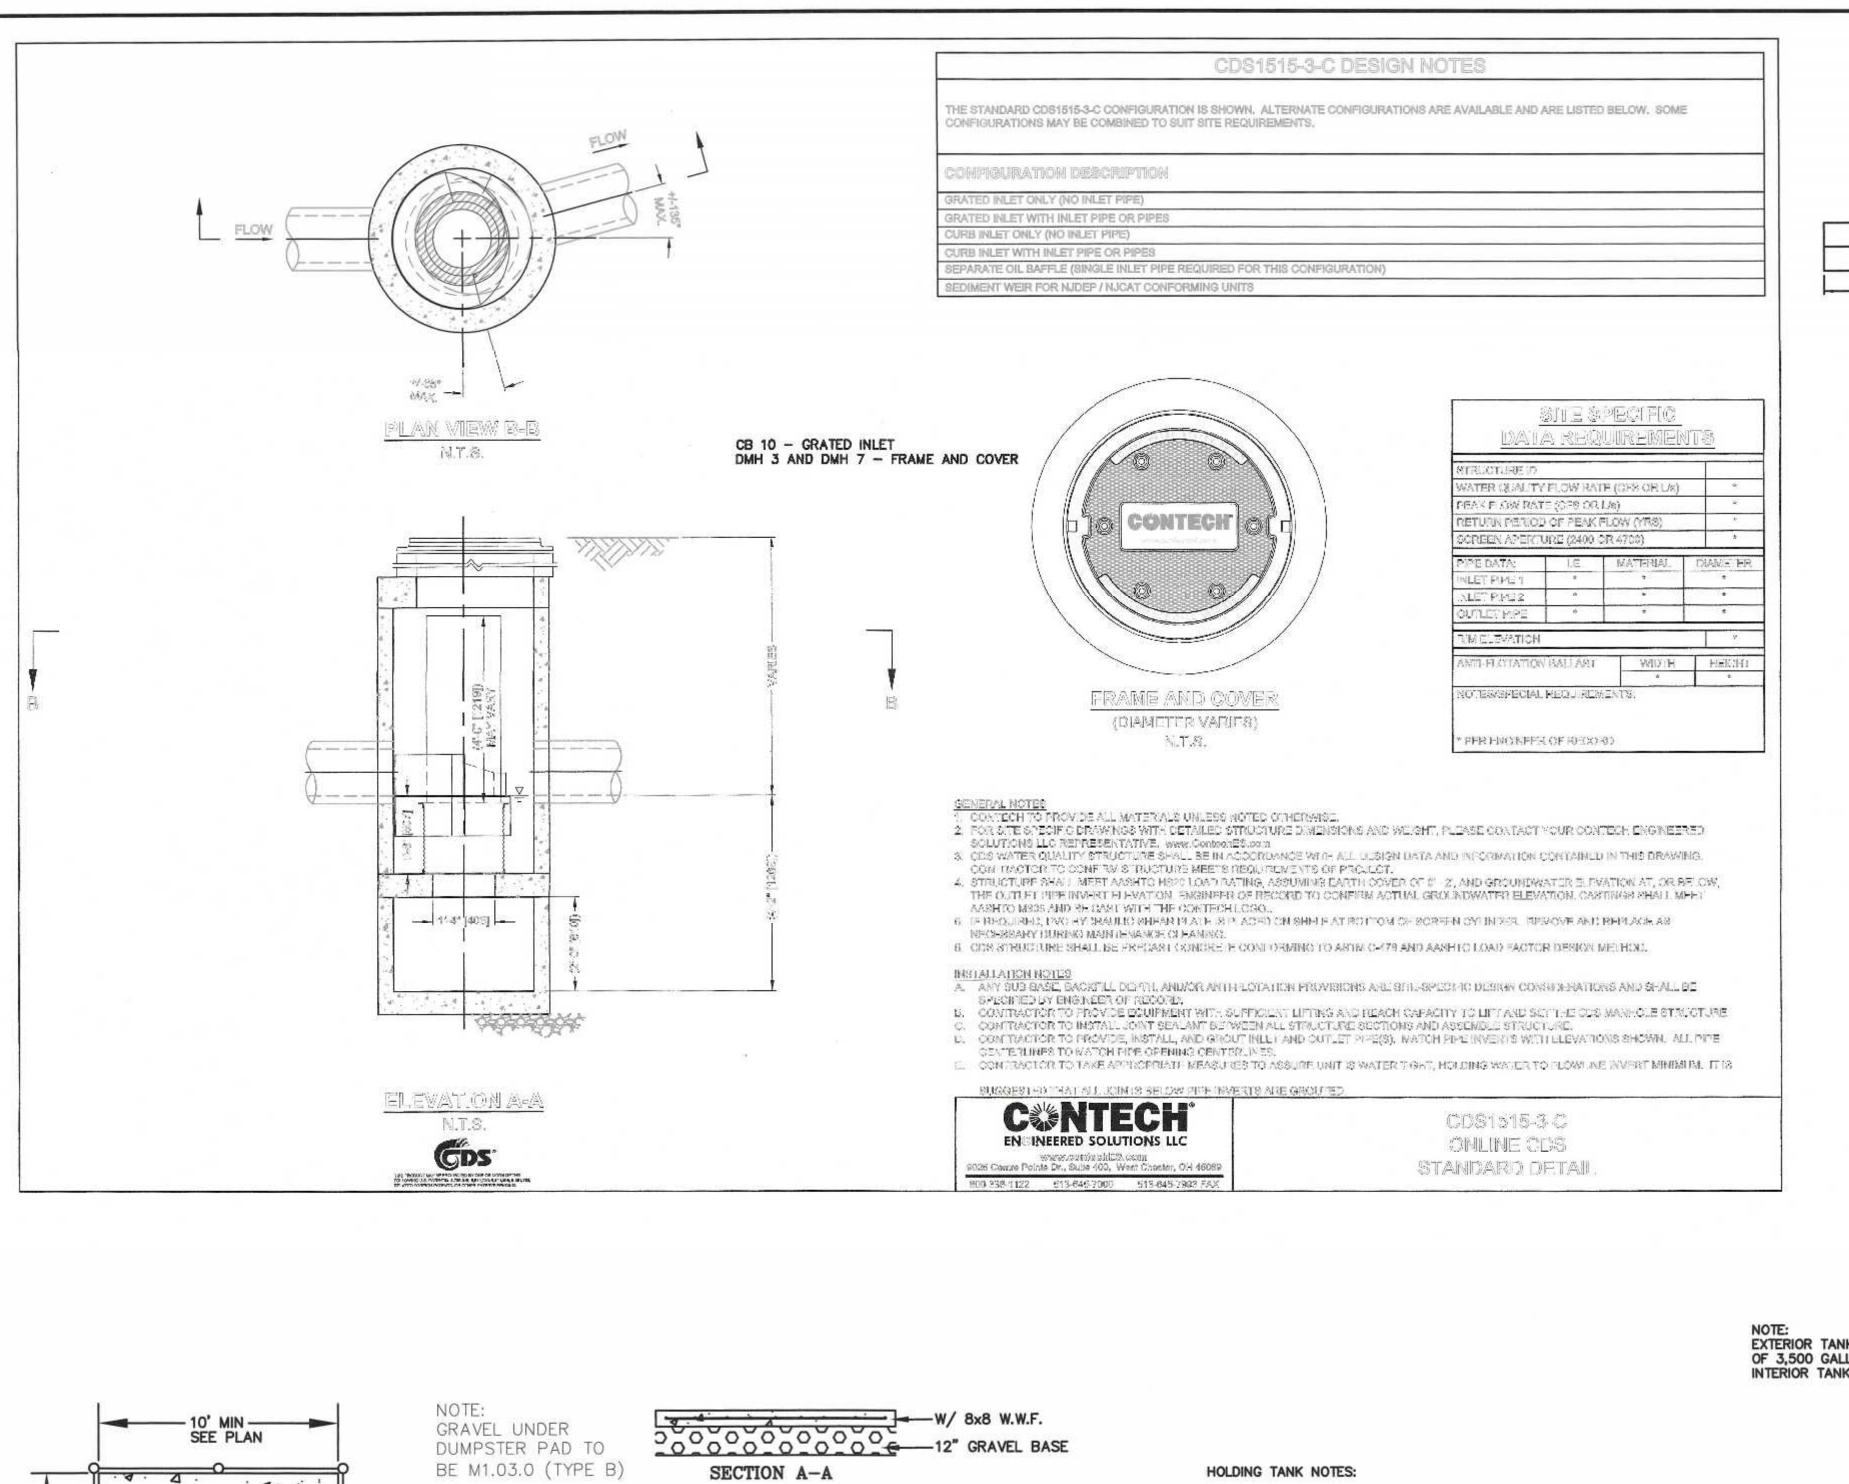

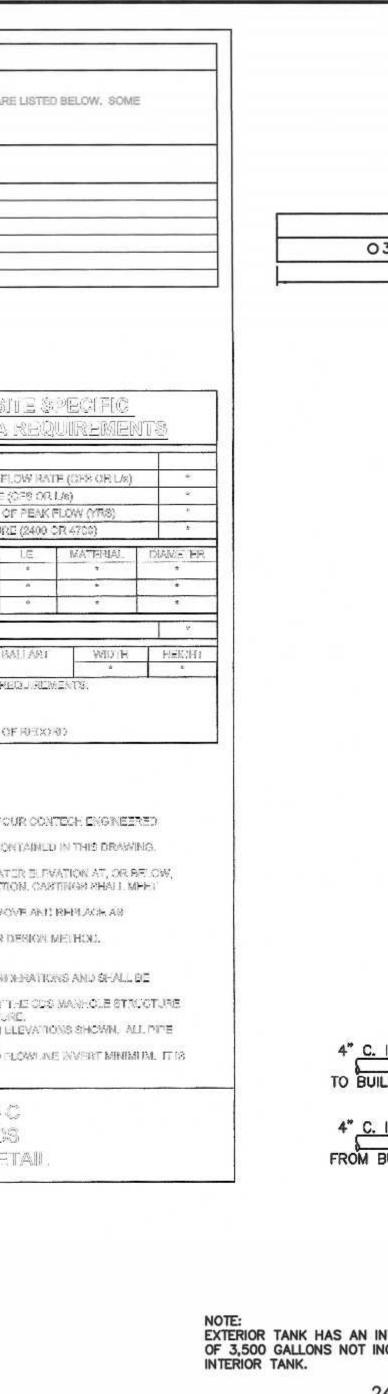

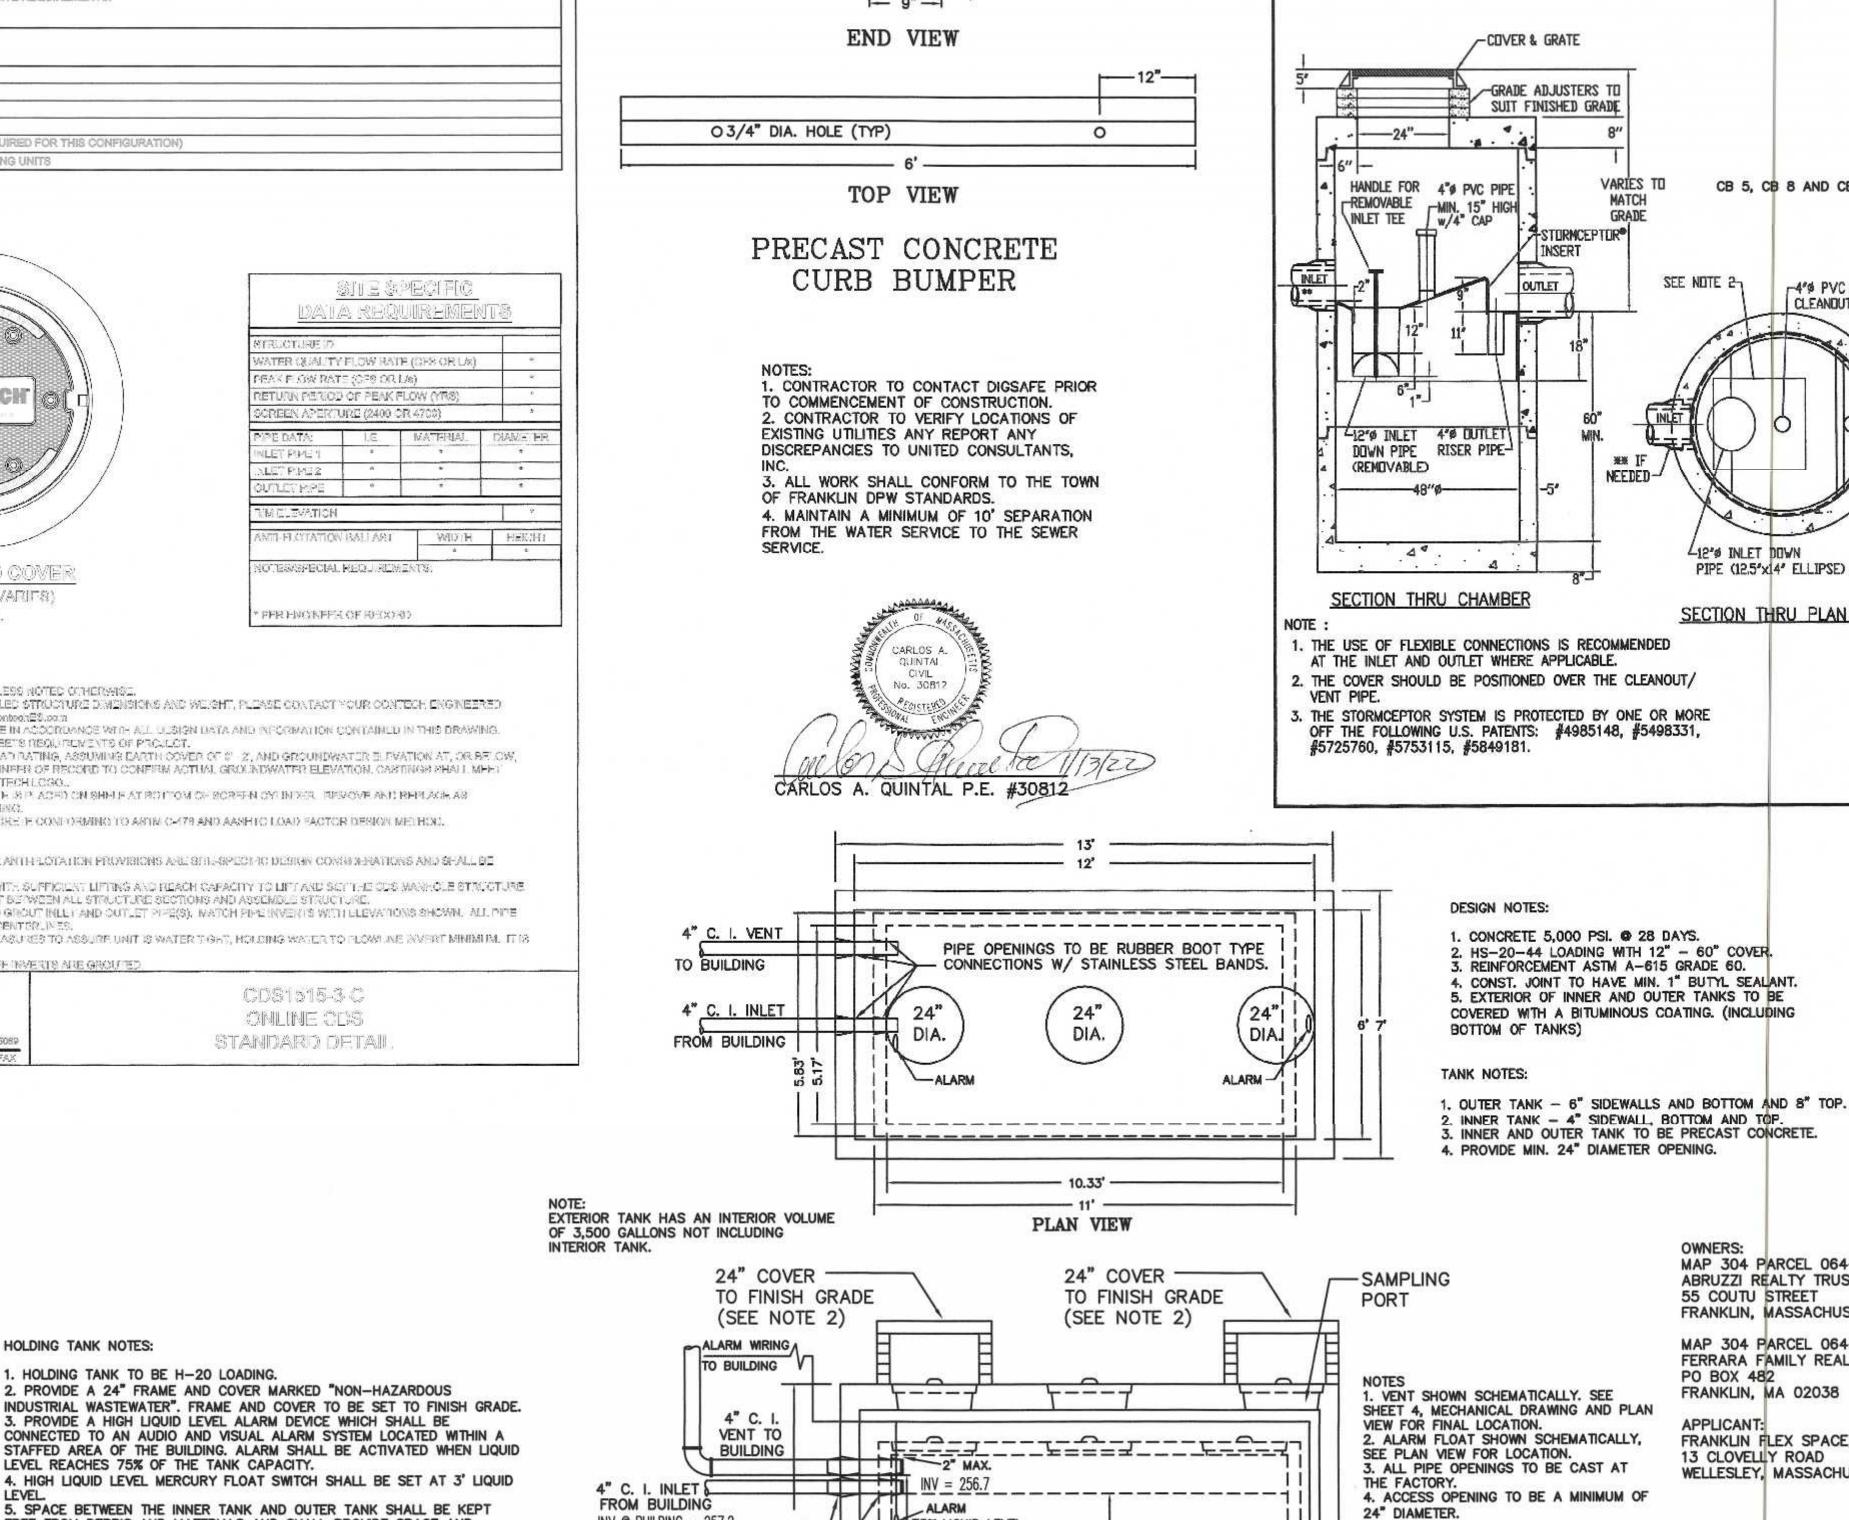

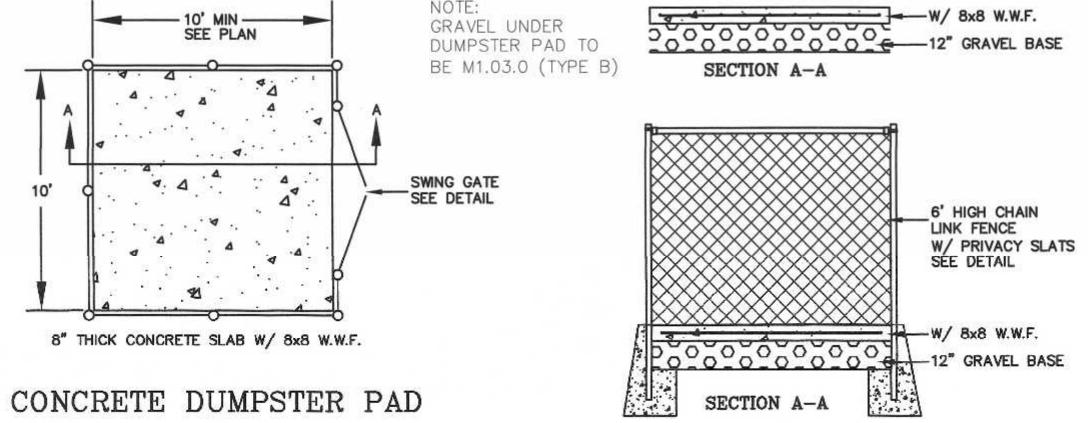

NOTE: DUMPSTER PAD AT BUILDING 1 WILL HAVE

FENCE IS PROPOSED TO THE REAR OF THE

DUMPSTER PAD.

THE FENCE CONNECT TO THE RETAINING WALL. NO

9. POTENTIAL AVERAGE DAILY FLOW 10 GALLONS - 500% CAPACITY 50 GALLONS. PRIMARY HOLDING TANK CAPACITY = 1,500 GALLONS BELOW INLET INVERT. 10. WASTE ANTICIPATED TO BE RAIN WATER AND SNOW MELT CARRIED IN ON VEHICLES AND EQUIPMENT. 11. HOLDING TANK PUMPING TO BE COMPLETED BY: TO BE DETERMINED.

12. EMERGENCY RESPONSE, SPILL CONTROL AND CONTAINMENT TO BE COMPLETED BY: TO BE DETERMINED 13. TANK TO BE VENTED THROUGH ROOF FOR ODOR CONTROL. 14. OWNER TO COMPLY WITH ALL PERMITS OR OTHER REQUIREMENTS MANDATED BY THE LOCAL AUTHORITIES PERTAINING TO THE HOLDING TANK.

2. PROVIDE A 24" FRAME AND COVER MARKED "NON-HAZARDOUS

3. PROVIDE A HIGH LIQUID LEVEL ALARM DEVICE WHICH SHALL BE

FREE FROM DEBRIS AND MATERIALS AND SHALL PROVIDE SPACE AND

ACCESS TO DETECT AND REMOVE ANY LEAKAGE FROM THE INNER TANK.

6. SEAL ALL TANK SEAMS AND PENETRATION WITH BIT. BUTYL MASTIC


8. TANK TO BE IMMEDIATELY REPLACED IF LEAKAGE IS DISCOVERED.

7. TANK TO BE INSPECTED ON A WEEKLY BASIS FOR LEAKAGE.

1. HOLDING TANK TO BE H-20 LOADING.

SEALANT.

LEVEL REACHES 75% OF THE TANK CAPACITY.

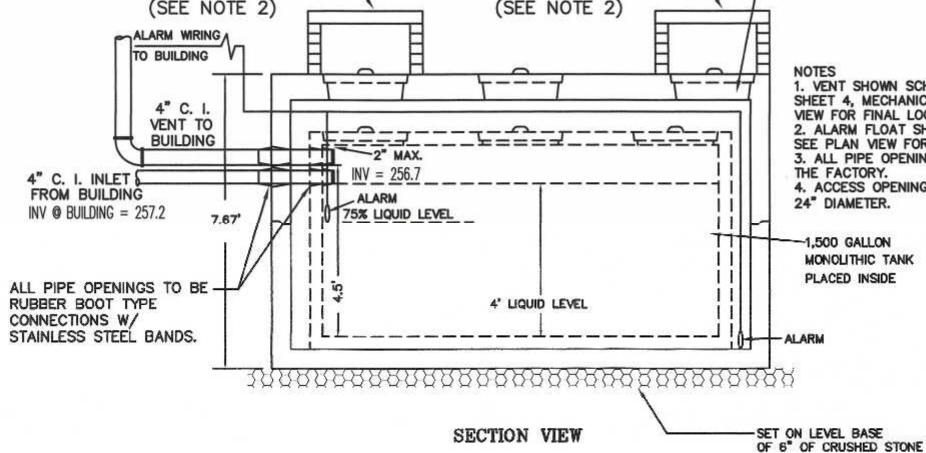

SCITUATE COMPANIES

1,500 GALLON DOUBLE WALL TANK

6/21 CHECKED BY: CAQ

DATE

CONSTRUCTION DETAILS - 2 WASHINGTON STREET FRANKLIN, MASSACHUSETTS PREPARED FOR

FRANKLIN FLEX SPACE, LLC 13 CLOVELLY ROAD WELLESLEY, MASSACHUSETTS

MAP 304 PARCEL 064-000

55 COUTU STREET FRANKLIN, MASSACHUSETTS

MAP 304 PARCEL 064-001

FRANKLIN FLEX SPACE, LLC

WELLESLEY, MASSACHUSETTS

FRANKLIN, MA 02038

13 CLOVELLY ROAD

SITE PLAN

PO BOX 482

APPLICANT

FERRARA FAMILY REALTY TRUST

ABRUZZI REALTY TRUST

JUNE 28, 2021 SCALE: 1'' = 40'

SITE PLAN APPROVAL REQUIRED FRANKLIN PLANNING BOARD DATE

DUMPSTER AREA FENCE

40	Ŷ	G	RAPHI	C SCALE	180				
			Carried St. T. Carried St. Car	PEET)		2	1/11/22	REVIEW COMMENTS	RRG
			1 inch =	= 40 ft.		NO.	11/22/21 DATE	REVIEW COMMENTS - SITE LAYOUT DESCRIPTION	RRG BY

T NITED INT. 5/21 | FIELD BY: BL FIELD BOOK PG# INC. 6/21 | CALCS BY: RRG 6/21 DESIGNED BY: 6/21 | DRAWN BY: COMP

JUNE 28, 2021 SCALE 1" = 30'PROJECT UC1435 850 FRANKLIN STREET SUITE 11D SHEET WRENTHAM, MASSACHUSETTS 02093 508-384-6560 FAX 508-384-6566 8 of 10

Hydro Condui

STC 450i Precast Concrete Stormceptor (450 US Gallon Capacity)

CB 5, CB 8 AND CB 9

412'S INLET DOWN


PIPE (12.5"x14" ELLIPSE)

SECTION THRU PLAN VIEW

r4"ø PVC PIPE CLEANDUT/VENT PIPE

-4°0 DUTLET

RISER PIPE

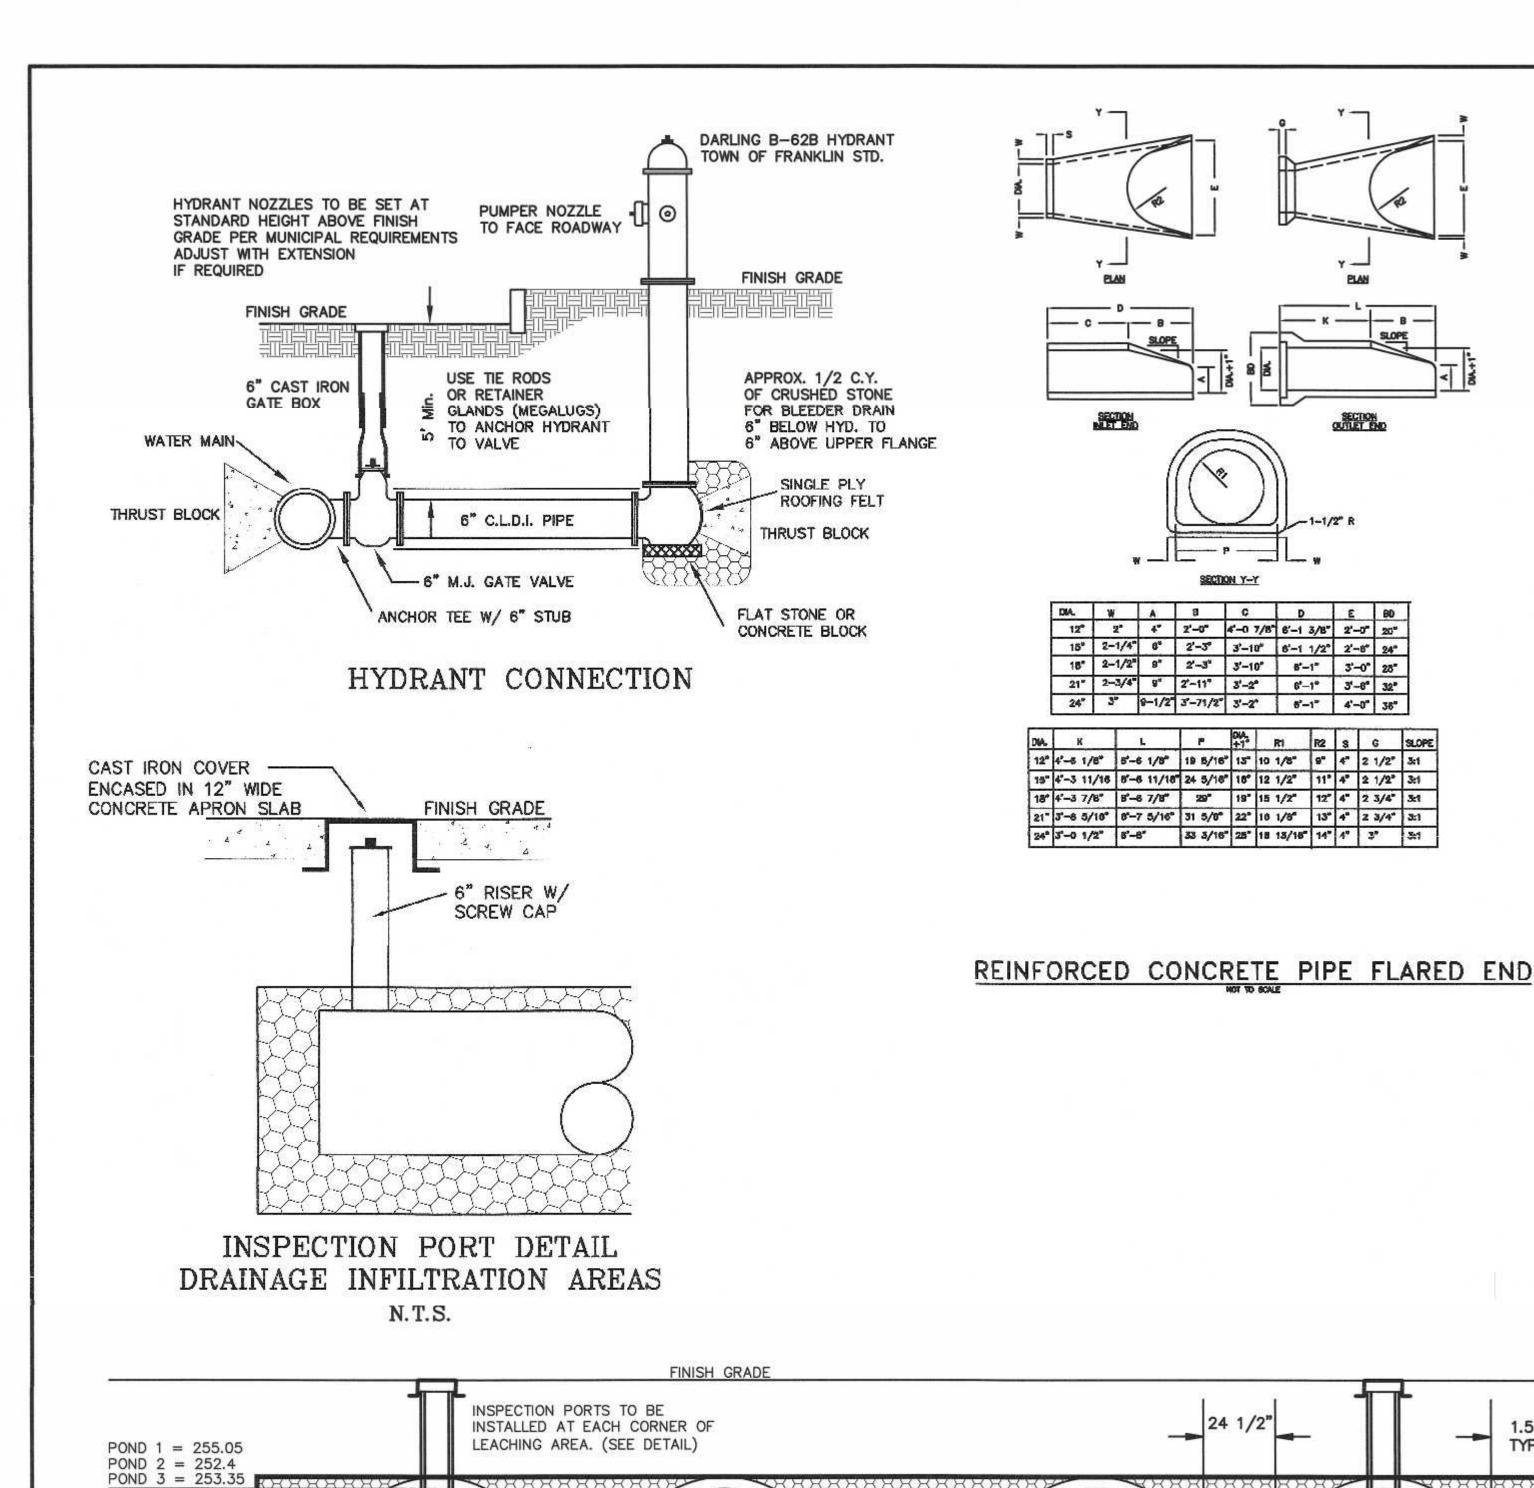

4' PERFORATED

INFILTRATION PONDS 1, 2 AND 3

HDPE PIPE

4' PERFORATED

(IN FEET) 1 inch = 40 ft.

HDPE PIPE

12" INLETS AND OUTLETS

POND 1 = 253.95

POND 2 = 251.3 POND 3 = 252.25

POND 1 = 251.05 POND 2 = 248.4 POND 3 = 249.35

POND 1 = 249.8

POND 2 = 247.15 POND 3 = 248.1

STONE ENVELOPE IS 20.7' x 89'

STONE ENVELOPE IS 27.3' x 200'

STONE ENVELOPE IS 20.7' x 100'

1. INFILTRATION POND 1 CONSISTS OF 3 ROWS OF 4'

2. INFILTRATION POND 2 CONSISTS OF 4 ROWS OF 4'

3. INFILTRATION POND 3 CONSISTS OF 3 ROWS OF 4'

SITE PLAN APPROVAL

REQUIRED FRANKLIN PLANNING BOARD

DATE


DIAMETER PERFORATED HDPE PIPE 97' IN LENGTH.

DIAMETER PERFORATED HDPE PIPE 197' IN LENGTH.

DIAMETER PERFORATED HDPE PIPE 86' IN LENGTH.

4' PERFORATED

HDPE PIPE

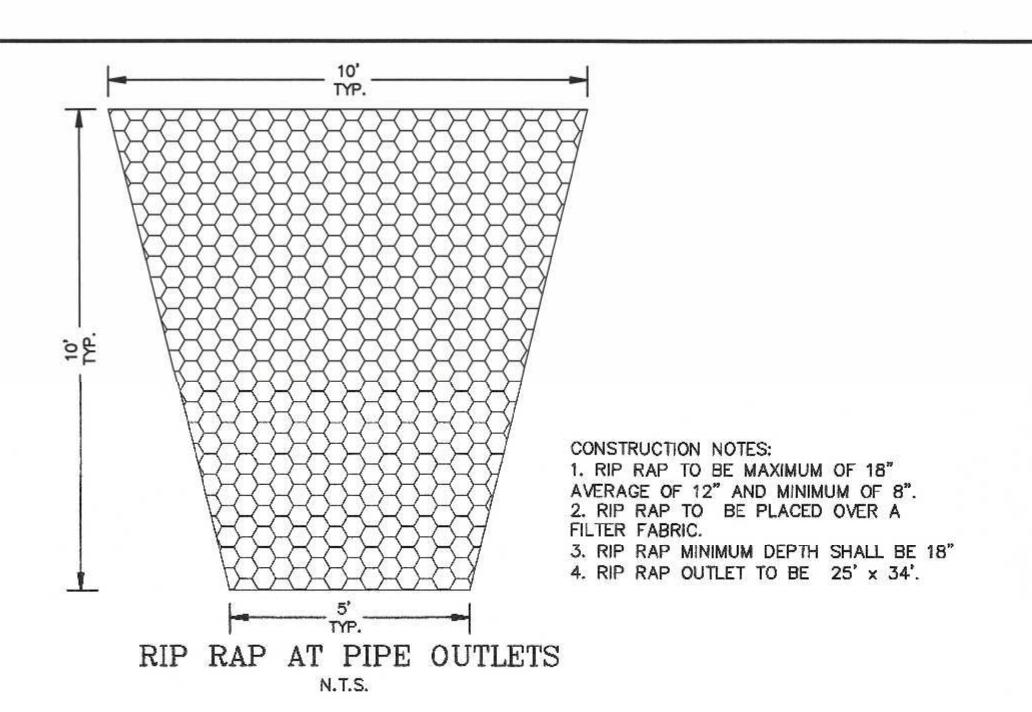

INFILTRATION PONDS 1, 2 AND 3 EXCAVATION AND FILL NOTES:

SOIL REMOVAL AT INFITRATION SYSTEM IN FILL AREAS: ALL EXISTING TOP (A HORIZON) AND SUB-SOIL (B HORIZON SOILS SHALL BE REMOVED UNDER THE INFITRATION SYSTEMS AND FIVE FEET FROM THE OUTER EDGE OF THE STONE ENVELOPE.

Fill material for drainage systems constructed in fill shall consist of select on-site or imported soil material. The fill shall be comprised of clean granular sand, free from organic matter and deleterious substances. Mixtures and layers of different classes of soil shall not be used. The fill shall not contain any material larger than two inches. A sieve analysis, using a #4 sieve, shall be performed on a representative sample of the fill. Up to 45% by weight of the fill sample may be retained on the #4 sieve. Sieve analyses also shall be performed on the fraction of the fill sample passing the #4 sieve, such analyses must demonstrate that the material meets each of the following specifications:

IEVE SIZE	EFFECTIVE	% THAT MUST
	PARTICLE SIZE	PASS SIEVE
4	4.75 mm	100%
50	0.30 mm	10% - 100%
100	0.15 mm	0% - 20%
200	0.075 mm	0% - 2%


A minimum of two representative sample shall be taken from the in-place fill and tested for compliance with the grain size distribution specification. Where fill is required to replace unsuitable or impermeable soils, the excavation of the unsuitable material shall extend a minimum of five feet laterally in all directions beyond the outer perimeter of the soil drainage systems to the depth of naturally occurring pervious material and replaced with fill.

Prior to placement of the fill, the bottom surface of the excavation shall be scarified and relatively dry. Fill shall not be placed during rain or snow storms. If the water table elevation is above the elevation of the bottom of the excavation, the excavation shall be dewatered as necessary.

THE DESIGN ENGINEER SHALL INSPECT AND CERTIFY THE EXCAVATION OF THE SOIL INFILTRATION AREAS AND THE RAIN GARDEN AREA PRIOR TO ANY FILL BEING PLACED.


RRG

RRG

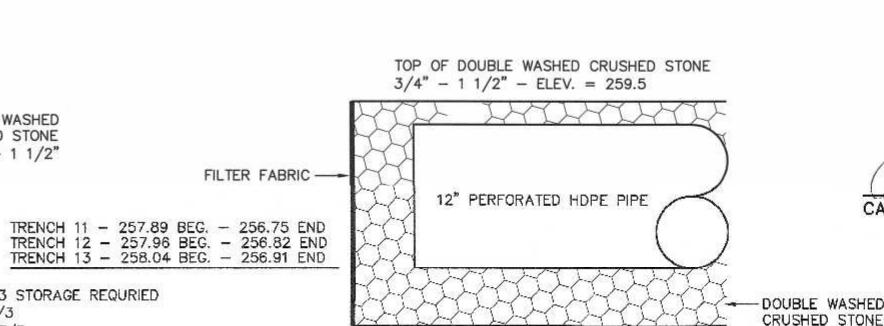

1. TRENCH WIDTH 3'. 2. REFER TO SHEET 4 FOR INVERT ELEVATION LOCATIONS.

DATE		INT.
5/21	FIELD BY:	BL
BK#	FIELD BOOK	PG#
6/21	CALCS BY:	RRG
6/21	DESIGNED BY:	RRG
6/21	DRAWN BY:	COMP
6/21	CHECKED BY:	CAQ

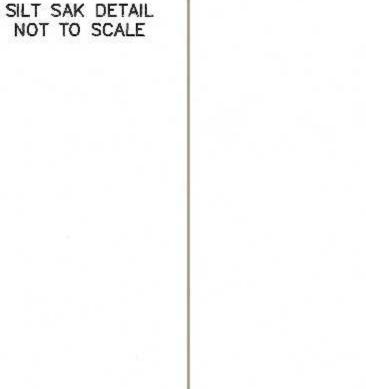

Typical Siltsack® Construction - Type B

INSERT 1" REBAR

FROM INLET (REBAR NOT INCLUDED)

FOR BAG REMOVAL

OPTIONAL OVERFLOW

SILTSACK

DUMP LOOPS -

(REBAR NOT INCLUDED)

OWNERS: MAP 304 PARCEL 064-000 ABRUZZI REALTY TRUST 55 COUTU STREET FRANKLIN, MASSACHUSETTS

MAP 304 PARCEL 064-001 FERRARA FAMILY REALTY TRUST PO BOX 482 FRANKLIN, MA 02038

APPLICANT: FRANKLIN FLEX SPACE, LLC 13 CLOVELLY ROAD WELLESLEY, MASSACHUSETTS

SITE PLAN CONSTRUCTION DETAILS - 3 WASHINGTON STREET FRANKLIN, MASSACHUSETTS PREPARED FOR FRANKLIN FLEX SPACE, LLC

13 CLOVELLY ROAD WELLESLEY, MASSACHUSETTS JUNE 28, 2021 SCALE: 1'' = 40'

ONSULTANTS 850 FRANKLIN STREET SUITE 11D

WRENTHAM, MASSACHUSETTS 02093

508-384-6560 FAX 508-384-6566

CARLOS A. QUINTAL CIVIL No. 30812

CARLOS A. QUINTAL P.E. #30812

JUNE 28, 2021 1'' = 30'PROJECT UC1435

9 of 10

POND 1 STORAGE BELOW OUTLET INVERT = 4,513 FT/3 POND 2 STORAGE BELOW OUTLET INVERT = 13,507 FT/3 POND 3 STORAGE BELOW OUTLET INVERT = 5,077 FT/3 TOTAL VOLUME = 23,097 FT/3TRENCH DRAIN DETAIL ESHGW - POND 1 = 242.91 BOTTOM TEST PIT (PT) 3TRENCH DRAIN NOTE: ESHGW - POND 2 = 242.91 BOTTOM TEST PIT (PT) 3 ESHGW - POND 3 = 243.37 STANDING WATER TEST PIT (PT) 10

REVIEW COMMENTS

DESCRIPTION

1 |11/22/21 | REVIEW COMMENTS - SITE LAYOUT

1.5'

TYP.

IMPERVIOUS AREA - 134,702 x 0.0833 = 11,411 FT/3 STORAGE REQURIED

4' PERFORATED

HDPE PIPE

- FILTER FABRIC

- DOUBLE WASHED CRUSHED STONE 3/44" - 1 1/2"

2 1/11/22

NO. DATE

