TOWN OF FRANKLIN TOWN CLERK

Mr. of Carlot Land

SITE PLAN 1256 WEST CENTRAL STREET

2019 MAY 24 P 12: 20

PROJECT NARRATIVE:
THE PROJECT CONSIST OF THE CONSTRUCTION OF PARKING
AREA 1 AND PARKING AREA 2.
THE EXISTING SITE PARKING AREAS WILL BE REVISED.
THE DUMPSTER PAD WILL BE RELOCATED.
THE EXISTING LOADING DOCK WILL BE ELIMINATED AND THE
PAVEMENT WILL BE ELEVATED.
TREES WILL BE PLANTED AND THE DISTURBED AREAS WILL BE
COVERED WITH 4" TO 6" OF GOOD QUALITY LOAM AND SEEDED.

WEST CENTRAL STREET LOCUS MAP SCALE: 1" = 200

WAIVER REQUESTS:

1. TO ALLOW LESS THAN 42" OF COVER OVER THE RCP DRAIN PIPE. PROPOSED CLASS V RCP.

2. TO ALLOW THE USE OF HPDE PIPE FOR DRAINAGE POND 1 INCLUDING THE CONNECTION OF DMH 1 TO THE INFILITRATION POND AND DRAINAGE POND 2 OUTLET.

3. TO ALLOW THE PROPOSED CURBING TO BE CAPE COD BERM TO MATCH THE EXISTING CURBING.

4. TO ALLOW AN INCREASE IN THE VOLUME OF RUNOFF FROM THE SITE IN THE POST DEVELOPMENT CONDITIONS. THIS REQUEST IS FOR THE REAR PARKING AREA DUE TO SITE SOIL CONDITIONS.

- ALL EROSION CONTROL MITIGATION MEASURES SHALL BE IN PLACE PRIOR TO MAJOR CONSTRUCTION OR SOIL DISTURBANCE COMMENCING ON THE SITE.

SITE PLAN APPROVAL REQUIRED FRANKLIN PLANNING BOARD

DATE

GRAPHIC SCALE (IN FEET) 1 inch = 200 ft. NO. DATE DESCRIPTION ZONING:

THE PROPERTY IS LOCATED WITHIN AN INDUSTRIAL ZONE.

MA: 2 4 2019 REQUIREMENTS: EXISTING INDUSTRIAL AREA: FRONTAGE: 479,167 SQ. FT. 369,36° ANNING DEPT. 1,251 ANNING DEPT. 2 STORIES 264' 479,167 S.F. 40,000 S.F. 369.40' 1,251' 2 STORIES 264' DEPTH: HEIGHT: WDTH: COVERAGE -STRUCTURES: STRUC. & PAVING: SETBACKS-FRONT: SIDE: REAR: 80° 30,5° 1,034°

RECEIVED

SEE FOOTNOTES *5 & *6 FRANKLIN ZONING BYLAW

THE PROPERTY IS NOT LOCATED WITHIN A FRANKLIN WATER RESOURCE DISTRICT. THE PROJECT DEVELOPMENT AREA IS LOCATED IN A ZONE X BASED ON FEMA FIRM MAP 25021C0304E DATED JULY 17, 2012.

EXISTING BUILDING USE MIXED WITH WAREHOUSE, YOGA STUDIO AND OFFICE .
PROPOSED BUILDING USE MIXED WITH WAREHOUSE, YOGA STUDIO, OFFICE AND MARIJUANA DISPENSARY.

DRAWING INDEX:

1. COVER SHEET
2. EXISTING CONDITIONS PLAN
3. SITE LAYOUT PLAN
4. SITE GRADING AND UTILITY PLAN
5. SITE PLANTING PLAN
6. EROSION CONTROL PLAN
7. CONSTRUCTION DETAILS

7. CONSTRUCTION DETAILS

8. CONSTRUCTION DETAILS

SITE LIGHTING-LIGHTING PLAN, PHOTOMETRICS AND SCHEDULES BY SK & ASSOCIATES

REFERENCES:
ASSESSORS MAP 286 PARCEL 34
DEED BOOK 15264 PAGE 546
PLAN 863 OF 1997
LAND COURT BOOK 799 PAGE 54
LAND COURT PLAN 7594-37

OWNER: COLEBROOK REALTY TRUST 120 GROVE STREET FRANKLIN, MASSACHUSETTS

APPLICANT: GTE FRANKLIN, LLC PO BOX 2844 BROCKTON, MASSACHUSETTS

COVER SHEET 1256 WEST CENTRAL STREET FRANKLIN, MASSACHUSETTS PREPARED FOR GTE FRANKIN, LLC
PO BOX 2844
BROCKTON, MASSACHUSETTS
MARCH 27, 2019
SCALE: 1" = 200'

T NITED PONSULTANTS INC. 850 FRANKLIN STREET SUITE 11D

1" = 200' UC1388 WRENTHAM, MASSACHUSETTS 02093 508-384-6560 FAX 508-384-6566 1 of 8

MAR. 27, 2019

3/19 DESIGNED BY: RRG


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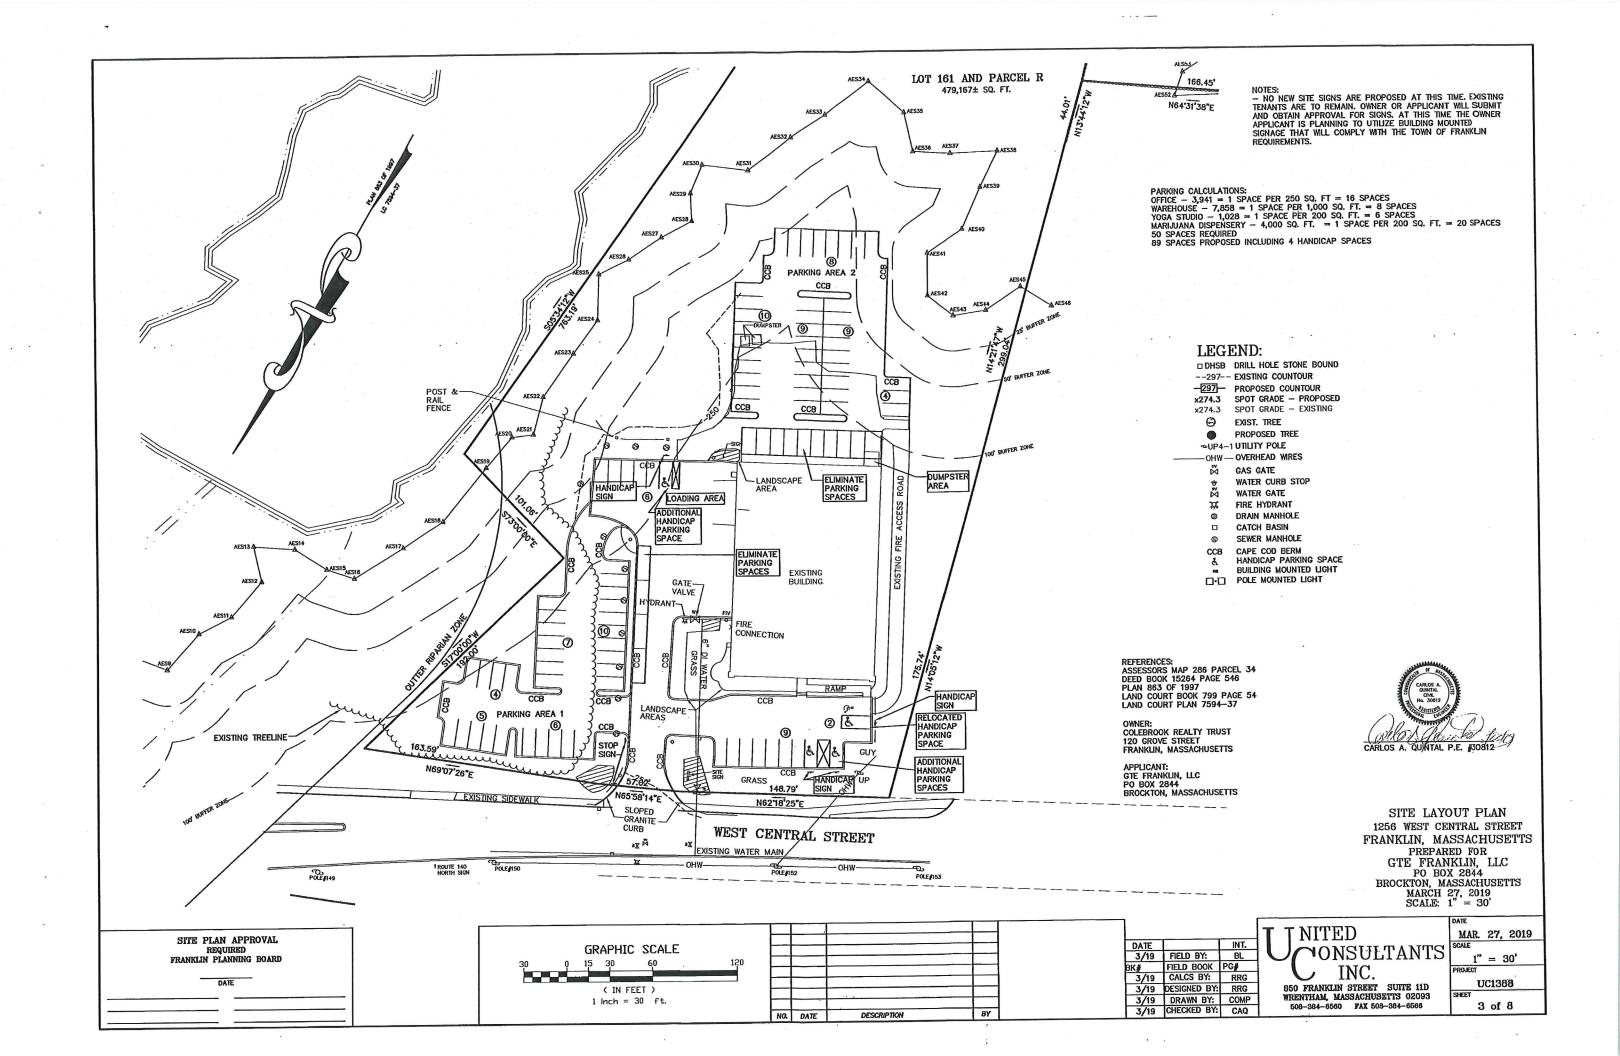
3/19 FIELD BY: BL


3/19 DRAWN BY: COMP


3/19 CHECKED BY: CAQ


FIELD BOOK PG# BK# FIELD BOOK PG# 3/19 CALCS BY: RRG




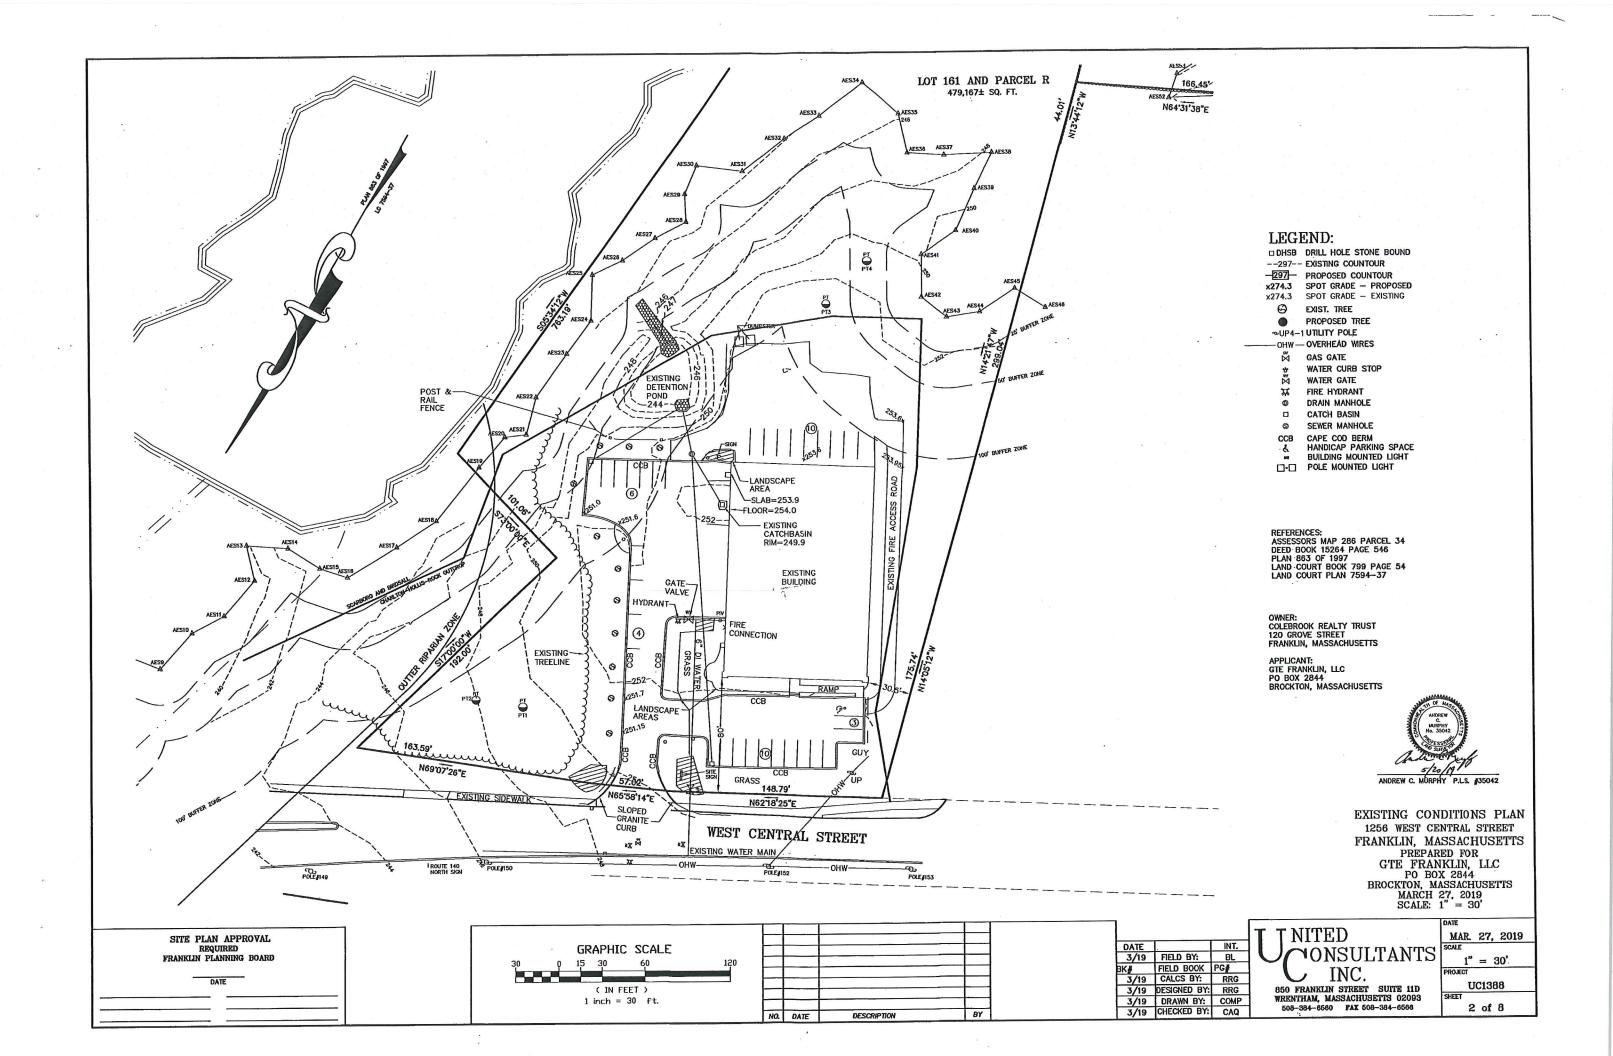

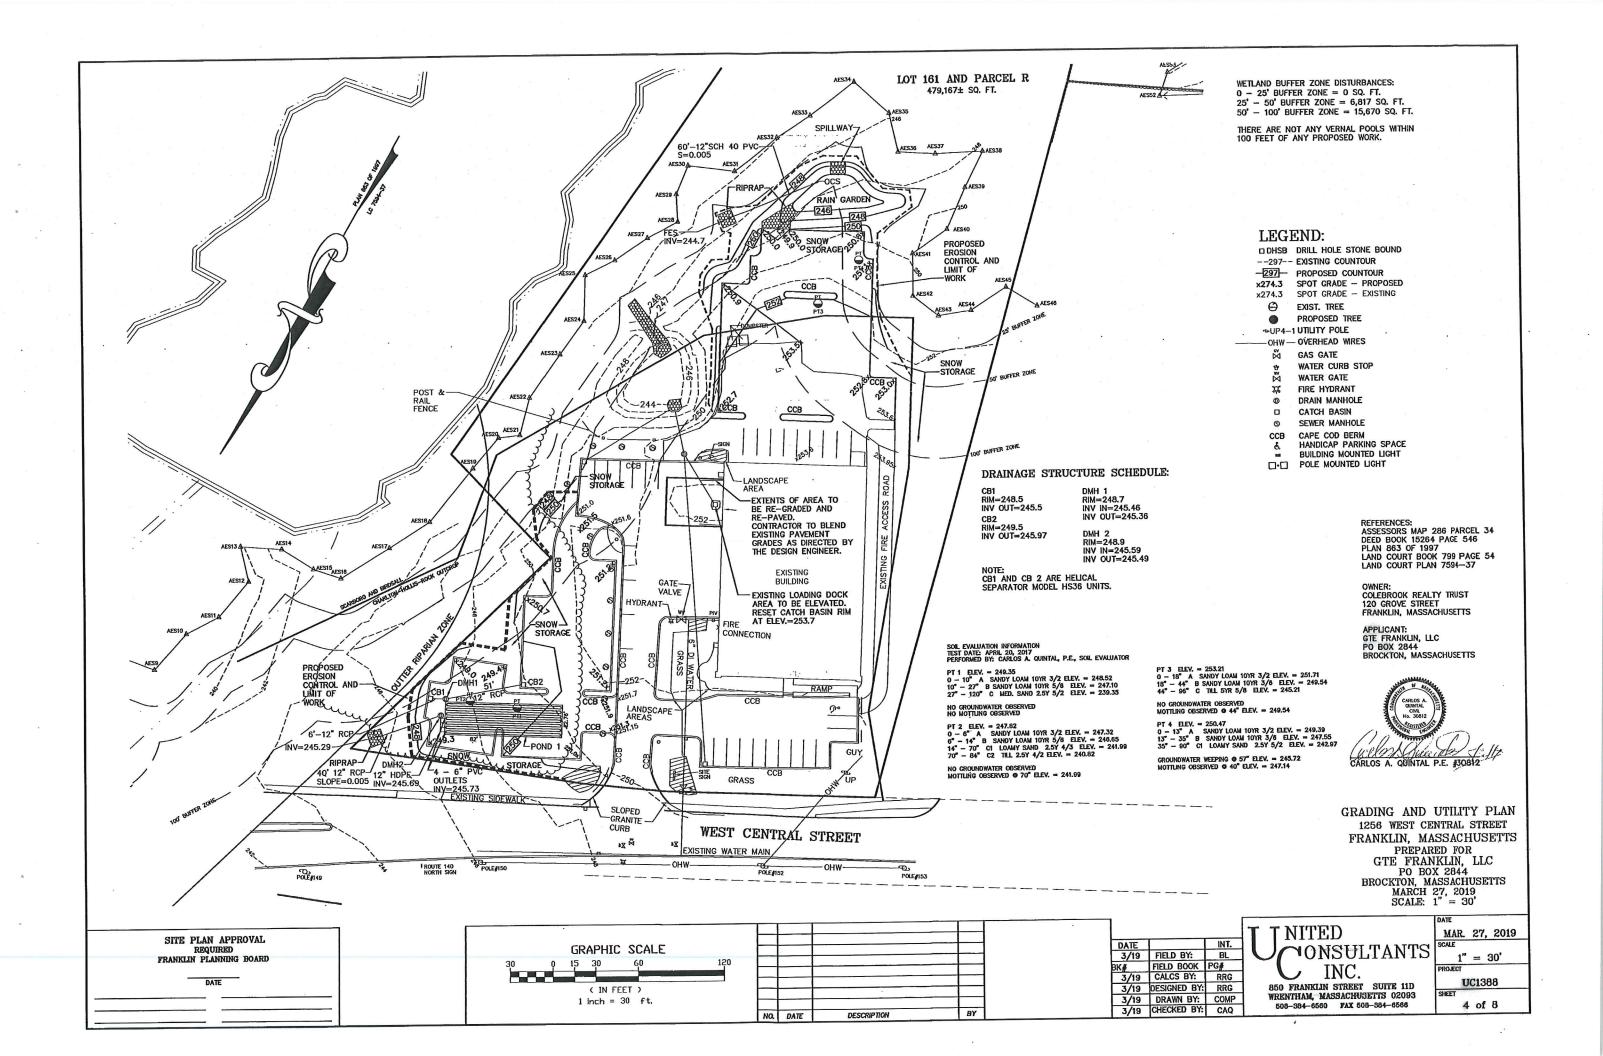


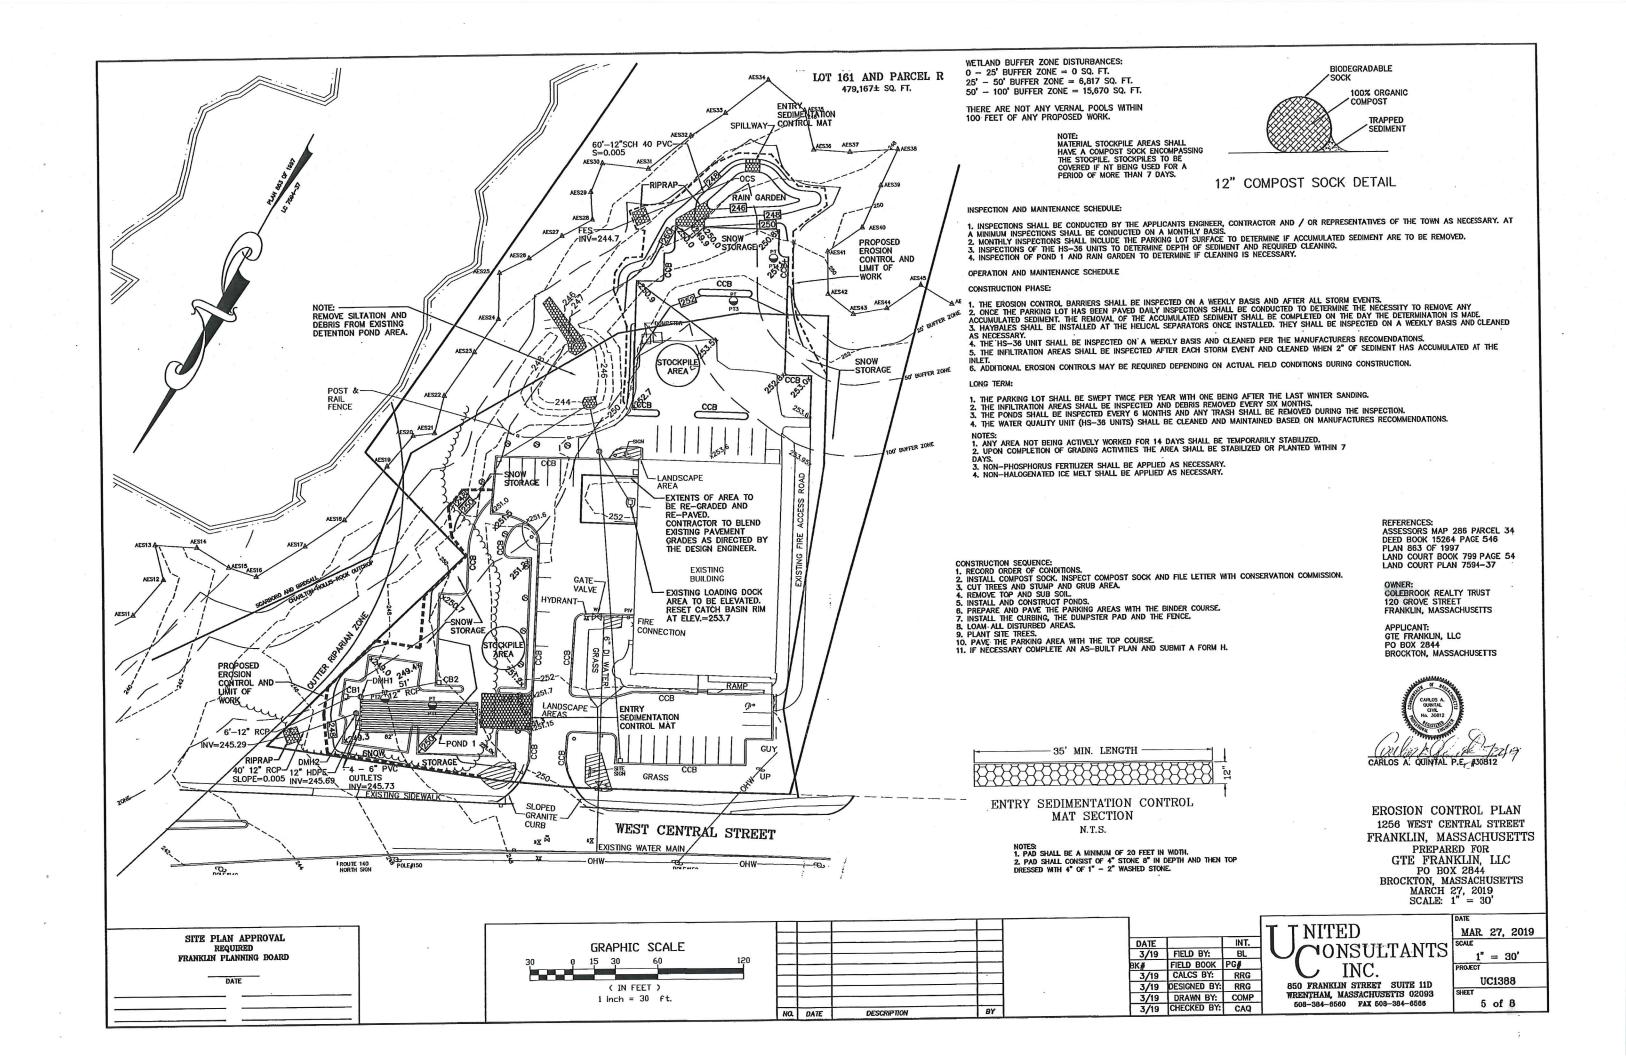


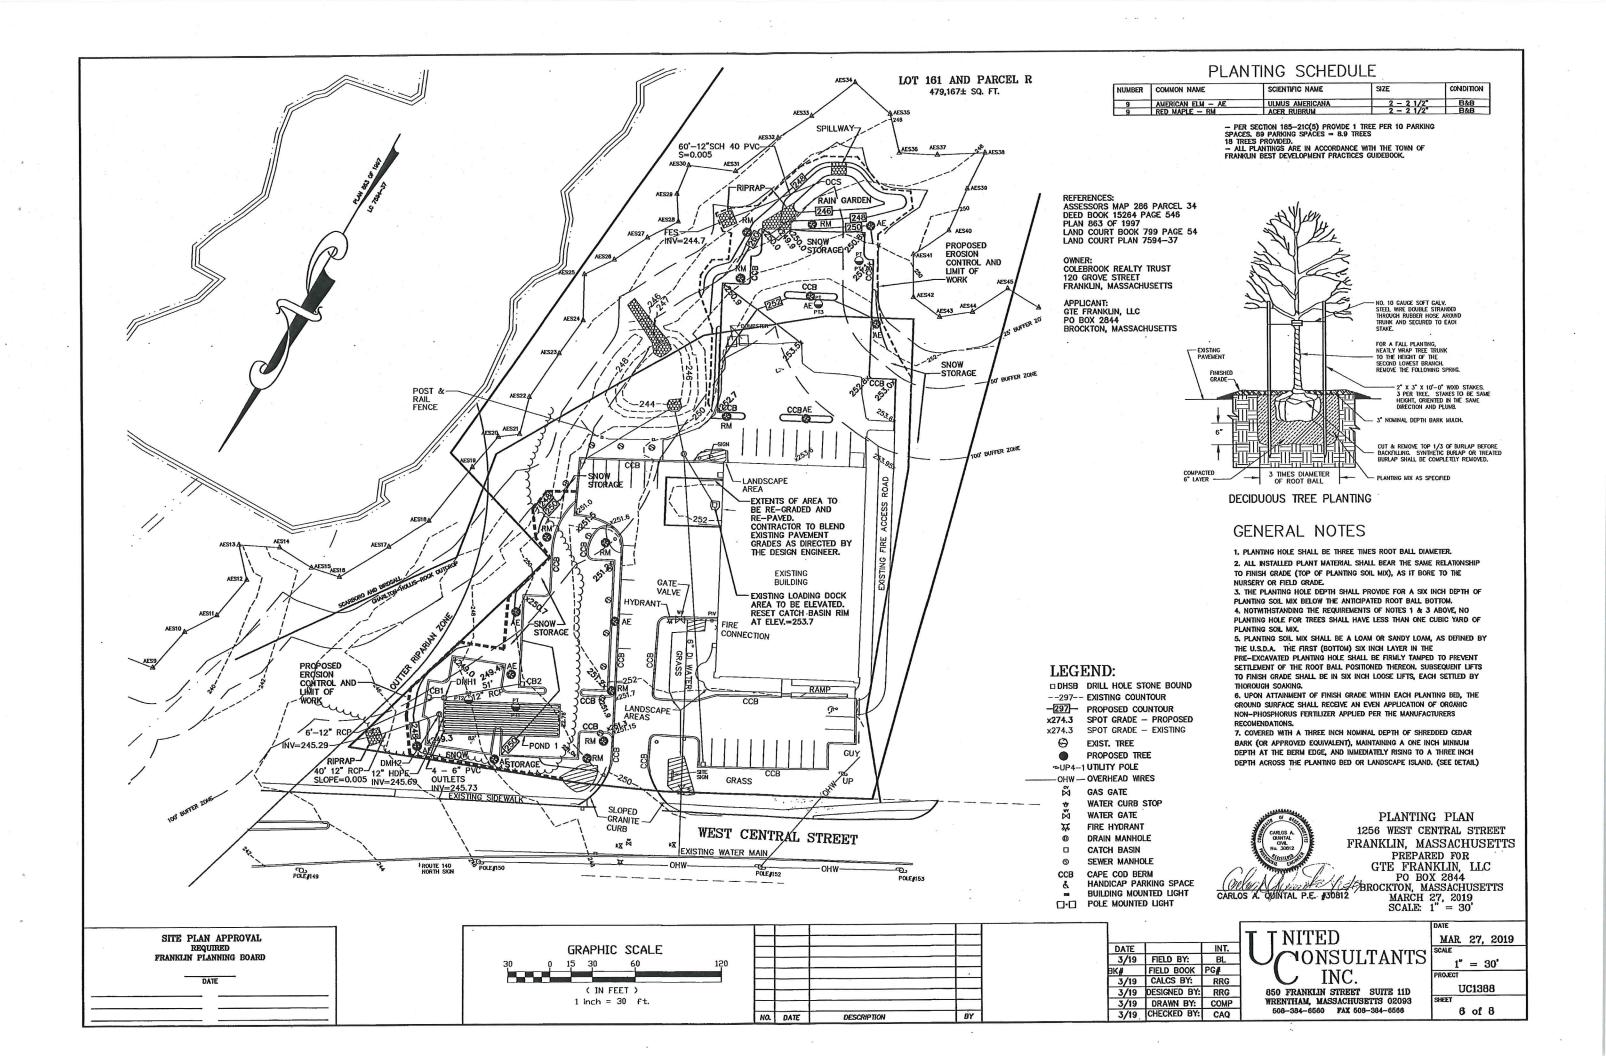

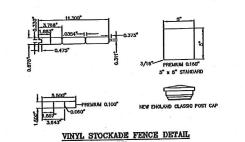

FENCE TO BE INSTALLED AROUND DUMPSTER PAD AND AT THE LOCATONS LISTED ON THE SITE PLAN.

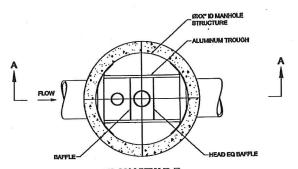


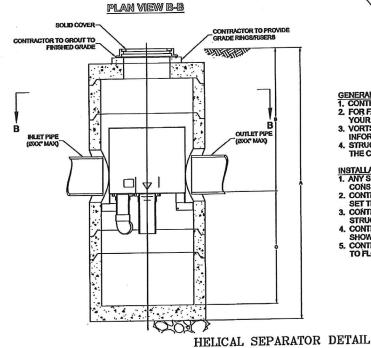


SITE PLAN APPROVAL

FRANKLIN PLANNING BOARD

GRAVEL UNDER DUMPSTER PAD TO BE M1.03.0 (TYPE B)

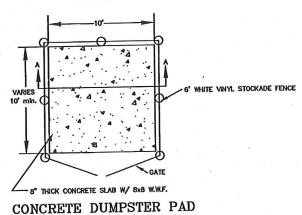

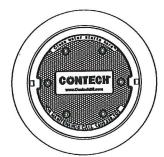

FRAME AND COVER (DIAMETER VARIES 24" MIN.) N.T.S.

VortSentry Model	Manhole Diameter (D)		Total Treatment Flow Rate		Typical Total Distance Rim to Outside Bottom A		Typical Distance Rim to Invert B	Typical Depth Below Invert (Inside) C			
	ft	mm	cfs	1/9	ft	m	ft	m	ft	m	
HS36	1		0.55	-	10.16	3.1	4.08	1.24	5.58	1702	

WQS - HS 36 IS A HELICAL SEPARATOR MODEL HS36




PARKING AREA AND CAPE COD BERM DETAIL

1. GRAVEL BED TO BE PLACED IN 6" LIFTS - MIN. 95% DRY DENSITY COMPACTION.

2. GRAVEL MATERIAL SHALL COMPLY WITH THE

TOWN OF FRANKLIN PLANNING BOARD RULES AND REGULATIONS.

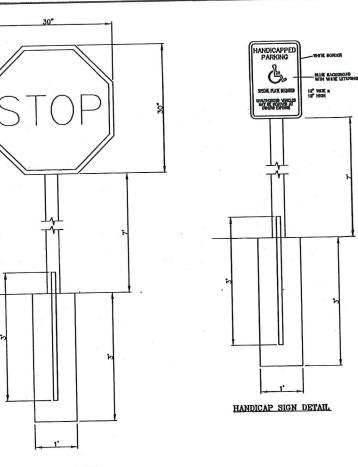

STOP SIGN DETAIL

OWNER: COLEBROOK REALTY TRUST 120 GROVE STREET FRANKLIN, MASSACHUSETTS

APPLICANT: GTE FRANKLIN, LLC PO BOX 2844 BROCKTON, MASSACHUSETTS



CONSTRUCTION DETAILS 1256 WEST CENTRAL STREET FRANKLIN, MASSACHUSETTS PREPARED FOR GTE FRANKLIN, LLC PO BOX 2844 BROCKTON, MASSACHUSETTS MARCH 27, 2019 SCALE: 1" = 30'

GRAPHIC SCALE (IN FEET) 1 Inch = 30 ft.

GENERAL NOTES

1. CONTECH TO PROVIDE ALL MATERIALS UNLESS NOTED OTHERWISE.

2. FOR FABRICATION DRAWINGS WITH DETAILED STRUCTURE DIMENSIONS AND WEIGHT, PLEASE CONTACT YOUR CONTECH CONSTRUCTION PRODUCTS REPRESENTATIVE. www.contach-col.com

3. VORTSENTRY HS WATER CUALITY STRUCTURE SHALL BE IN ACCORDANCE WITH ALL DESIGN DATA AND INFORMATION CONTAINED IN THIS DRAWING.

4. STRUCTURE SHALL MEET AASHTO H20 LOAD RATING. CASTINGS SHALL MEET AASHTO M308, CAST WITH THE CONTECH STORMWATER SOLUTIONS LOGO.

INSTALLATION NOTES

1. ANY SUB-BASE, BACKFILL DEPTH, AND/OR ANTI-FLOTATION PROVISIONS ARE SITE-SPECIFIC DESIGN
CONSIDERATIONS AND SHALL BE SPECIFIED BY ENGINEER OF RECORD.
2. CONTRACTOR TO PROVIDE EQUIPMENT WITH SUFFICIENT LIFTING AND REACH CAPACITY TO LIFT AND
SET THE VORTSENTRY HS MANHOLE STRUCTURE (LIFTING CLUTCHES PROVIDED).
3. CONTRACTOR TO INSTALL JOINT SEALANT BETWEEN ALL STRUCTURE SECTIONS AND ASSEMBLE

SHOWN.

5. CONTRACTOR TO TAKE APPROPRIATE MEASURES TO ASSURE UNIT IS WATER TIGHT, HOLDING WATER TO FLOWLINE INVERT MINIMUM. IT IS SUGGESTED THAT ALL JOINTS BELOW PIPE INVERTS ARE GROUTED.

STRUCTURE.
4. CONTRACTOR TO PROVIDE, INSTALL, AND GROUT PIPES. MATCH PIPE INVERTS WITH ELEVATIONS


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NO. D	ATE	DESCRIPTION	BY

			TTN
DATE		INT.	
3/19	FIELD BY:	BL	
BK#	FIELD BOOK	PG#	
3/19	CALCS BY:	RRG	
3/19	DESIGNED BY:	RRG	850 FF
3/19	DRAWN BY:	COMP	WRENTI
7/40	CHECKED BY.	CAO	508-3

IITED ONSULTANTS INC.


Franklin Street Suite 11D Tham, Massachusetts 02093 384-8560 FAX 508-384-6566

MAR, 27, 2019 1" = 30' UC1388 8 of 8

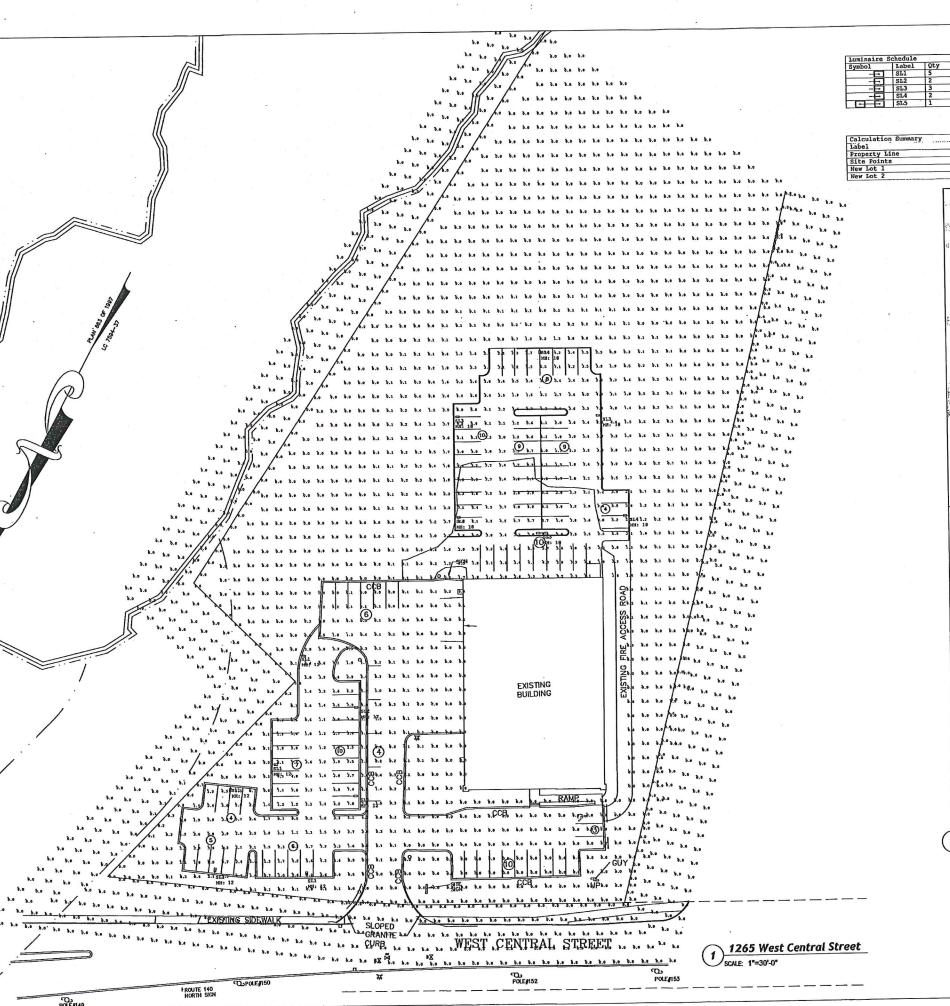

Luminaire S			Description	LLF	Lum. Watts	
Symbol	Label	Qty		0.335	78	6589
-	SL1	5	VIOLUTE TO A AN INTER SIA DE		78	10229
	SL2	2	Visionaire # VMX-1-T3-48LC-5-4K-UNV-AM-BK		142	17006
	SL3	3	Visionaire # VMX-1-T4-64LC-7-4K-UNV-AM-BK		140	11347
	SL4	2	Visionaire # VMX-1-T4-64LC-7-4K-UNV-AM-BK-CLS	0.900		10061
	SL5	1	Visionaire # (2) VMX-1-T5-64LC-3-4K-UNV-AM-BK	0.900	70	10001

				200 0			
Calculation Summary		Units	Ävg	Мах	Min	Avg/Min	
Label	CalcType	FC	0.00	0.8	0.0	N.A.	N.A.
Property Line	Illuminance		0.82	9.8	0.0	N.A.	N.A.
Site Points	Illuminance	FC				5.88	16.00
New Lot 1	Illuminance	FC	2.94	8.0	0.5		16.33
New Lot 2	Illuminance	Fc	3.42	9.8	0.6	5.70	10.33

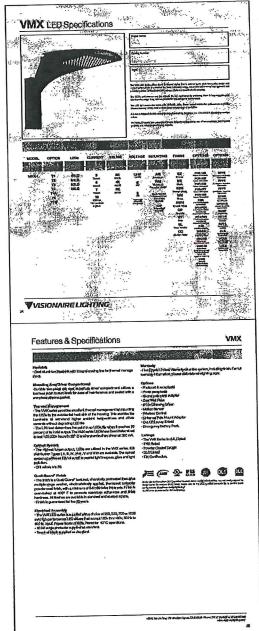

Fixture Specification- Visionaire VMX

ABBREVIATIONS:

Avg= Average
AFG= Above Finished Grade
CF = Compact Fluorescent
CV= Coefficient of variation
fo = Foolcandles
HPS = High Pressure Sodium
LLF= Light Loss Factor
MH = Mounting Height
NTS = Not to Scale
PSMH = Pulse Start Metal Halide
SF = Square foot
W = Watts

NO.

- A. CALCULATION POINTS INDICATED ARE BASED ON MAINTAINED FOOTCANDLE (FC) LEVELS AFTER A LIGHT LOSS FACTOR (LLF) IS APPLIED TO FIXTURE. REFER TO SCHEDULES FOR LLF AND LUMEN INFORMATION.

 B. REFER TO PLAN FOR FIXTURE MOUNTING HEIGHTS.
- HEIGHTS.
 C. CALCULATION POINTS TAKEN AT GRADE.

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United Consultants

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| REVISIONS | Description | De

Project #: 18099

Drawn: AD

Checked: TJ

Approved: HD

Scale: AS NOTED

Site Lighting-Lighting Plan, Schedules and Specifications

DRAWING NUMB

SL₁

Convright SK & Associates Inc. 2019