

SPRING STREET RENEWABLES, LLC
LARGE-CAPACITY GROUND MOUNTED
SOLAR ENERGY SYSTEM
SPRING STREET

FRANKLIN, MASSACHUSETTS

NOVEMBER 21, 2018
REV: APRIL 8, 2019

APPLICANT:

SPRING ST RENEWABLES, LLC
101 SUMMER STREET
BOSTON, MA 02110

LAND SURVEYOR & CIVIL ENGINEER:

ANDREWS SURVEY & ENGINEERING, INC.
104 MENDON STREET
UXBRIDGE, MA 01569
P: 508.278.3897
F: 508.278.2289

ENVIRONMENTAL:

ECR, LLC.
P.O. BOX 4012
PLYMOUTH, MA 02361
P: 617-529-3792


CONSULTANT:

NEXAMP, INC.
101 SUMMER STREET
BOSTON, MA 02110

RECEIVED

APR 10 2019

PLANNING DEPT.

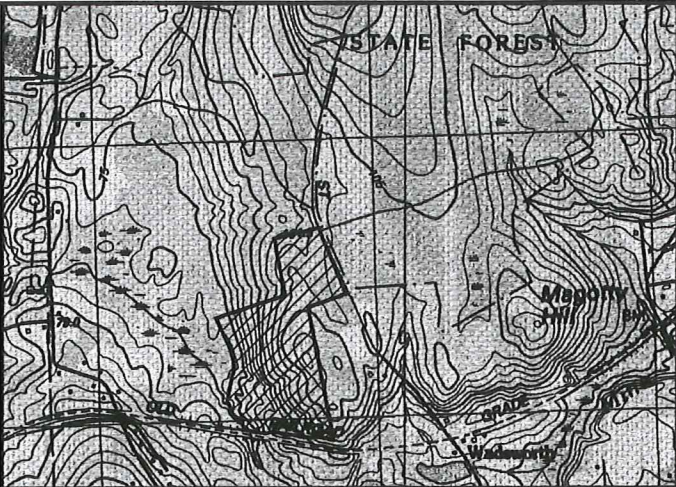

LOCUS MAP
SCALE: 1" = 1,000'



Andrews Survey & Engineering, Inc.
Land Surveying - Civil Engineering - Site Planning

P.O. Box 312, 104 Mendon Street
Uxbridge, Massachusetts 01569
P: 508-278-3897 F: 508-278-2289

500 East Washington Street
North Attleboro, Massachusetts 02760
P: 508-316-0452 F: 508-316-0963

APPROVAL UNDER SITE PLAN REVIEW
FRANKLIN PLANNING BOARD

BEING A MAJORITY DATE:

THIS CERTIFIES THAT THE NOTICE OF APPROVAL
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BOARD HAS BEEN RECEIVED AND RECORDED ON
AT
AND NO APPEAL WAS RECEIVED DURING THE 20
DAYS NEXT AFTER SUCH RECEIPT OF SAID
NOTICE.

FRANKLIN TOWN CLERK DATE

PROJECT:
LARGE-CAPACITY GROUND
MOUNTED SOLAR ENERGY SYSTEM
SPRING STREET
FRANKLIN, MA

APPLICANT:
SPRING ST. RENEWABLES, LLC
101 SUMMER STREET
BOSTON, MA 02110

REVISIONS

NO.	DATE	DESCRIPTION
1	02/1/19	PEER REVIEW COMMENTS
2	03/11/19	DEP COMMENTS
3	03/28/19	PER 3/28/19 WSI REVIEW
4	04/08/19	PER TOWN/PEER REVIEW COMMENTS

SHEET TITLE

COVER SHEET



DES BY: KNP DATE: NOVEMBER 21, 2018
CHK BY: RMM PROJECT NO. 2018-101

C0.0
PLAN NO. L-5891

<p>OWNER OF RECORD: RICHARD COSTELLO PO BOX 283 FRANKLIN, MA 02038 FRANKLIN ASSESSORS INFORMATION: MAP 310, PARCEL 02 TOTAL PARCEL AREA: 570,636± S.F. (13.2± AC.)</p> <p>DEED REFERENCE: DEED BK. 2731, PG. 108</p> <p>PLAN REFERENCES: P.B. 54, PL. 2557</p>	<p>OWNER OF RECORD: MICHAEL J BUCCI 4 ALMOND DRIVE JOHNSTON, RI 02919 FRANKLIN ASSESSORS INFORMATION: MAP 309, PARCEL 15 TOTAL PARCEL AREA: 424,013± S.F. (9.7± AC.)</p> <p>DEED REFERENCE: DEED BK. 34238, PG. 115</p> <p>PLAN REFERENCES: P.B. 468, PL. 616</p>	<p>OWNER OF RECORD: ANTHONY DEPOTO ETALS 8 SPRING STREET FRANKLIN, MA 02038 FRANKLIN ASSESSORS INFORMATION: MAP 323, PARCEL 44 TOTAL PARCEL AREA: 1,121,670± S.F. (25.75± AC.)</p> <p>DEED REFERENCE: DEED BK. 589, PG. 111</p> <p>PLAN REFERENCES: P.B. 54, PL. 2557</p>
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DRAWING DATE	LAST REVISION	SHEET NO.	SHEET TITLE
11/21/18	4/08/19	C0.0	COVER SHEET
11/21/18	4/08/19	C0.1	LEGEND, ABBREVIATIONS, & GENERAL NOTES
11/21/18	4/08/19	C1.0	VICINITY MAP
11/21/18	3/11/19	C1.1 - C1.3	EXISTING CONDITION PLANS
11/21/18	4/08/19	C2.0 - C2.3	SITE PLAN
11/21/18	4/08/19	C3.1 - C-3.3	EROSION & SEDIMENT CONTROL PLAN
11/21/18	4/08/19	C3.4	EROSION & SEDIMENT CONTROL NOTES & DETAILS
11/21/18	4/08/19	C4.1-C4.2	CONSTRUCTION DETAILS
11/21/18	4/08/19	C5.1	WETLAND CROSSING & REPLICATION PLAN
11/21/18	4/08/19	C5.2	LANDSCAPE PLAN
11/21/18	4/08/19	C5.3	SPRING ST IMPROVEMENTS PLAN & PROFILE
11/21/18		E-101	AC 1-LINE ELECTRIC DIAGRAM (NEXAMP)

GOVERNMENT / UTILITY CONTACTS

<p>FRANKLIN POLICE DEPT. 911 PANTHER WAY P: 508-528-1212 ATTN: THOMAS LYNCH, CHIEF</p> <p>FRANKLIN FIRE DEPT. 40 WEST CENTRAL STREET P: 508-528-2323 P: 508-520-4912 ATTN: GARY MCCARRAHER, CHIEF</p> <p>FRANKLIN PLANNING DEPARTMENT 355 EAST CENTRAL STREET P: 508-520-4907 ATTN: AMY LOVE, PLANNER</p>	<p>FRANKLIN D.P.W. 257 FISHER STREET P: 508-520-4910 F: 508-520-4939 ATTN: ROBERT CANTOREGGI, DIRECTOR</p> <p>FRANKLIN BUILDING DEPT. 355 EAST CENTRAL STREET P: 508-520-4926 F: 508-520-4906 ATTN: LLOYD BROWN, BUILDING COMMISSIONER</p>
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GENERAL ABBREVIATIONS

AAB	ARCHITECTURAL ACCESS BOARD	MH	MANHOLE
ASHTO	AMERICAN ASSOCIATION OF STATE HIGHWAY AND TRANSPORTATION OFFICIALS	MB	MAIL BOX
ADA	AMERICANS WITH DISABILITIES ACT	MHD	MASSACHUSETTS HIGHWAY DEPARTMENT
AIA	AMERICAN INSTITUTE OF ARCHITECTURE	MHW	MEAN HIGH WATER
ASTM	AMERICAN SOCIETY FOR TESTING AND MATERIALS	MIN	MINIMUM
ANSI	AMERICAN NATIONAL STANDARDS INSTITUTE	MISC	MISCELLANEOUS
AWWA	AMERICAN WATERWORKS ASSOCIATION	MLW	MEAN LOW WATER
BOP	BITUMINOUS CONCRETE PAVEMENT	MSL	MEAN SEA LEVEL
BLDG	BUILDING	MUTCD	MANUAL ON UNIFORM TRAFFIC CONTROL DEVICES
C/O	CENTER TO CENTER	NA	NOT APPLICABLE
CB	CATCH BASIN	NSF	NATIONAL SANITATION FOUNDATION
CBR	CALIFORNIA BEARING RATIO	NIC	NOT IN CONTRACT
CP	CAST-IN-PLACE	NTS	NOT TO SCALE
CLF	CHALK LINK FENCE	O/D	OUTSIDE TO OUTSIDE
CO	CLEANOUT	OSHA	OCCUPATIONAL SAFETY & HEALTH ADMINISTRATION
CONC	CONCRETE	PCC	PORTLAND CEMENT CONCRETE
DIA. #	DIAMETER	PSTR	POST AND RAIL FENCE
DHM	DRAIN MANHOLE	PWW	PAVED WATERWAY
EA	EACH	RR	RAILROAD
EG	EXISTING GRADE	RW	RETAINING WALL
EL.ELEV	ELEVATION	S/E	SIMILAR OR EQUAL TO
ESHGW	ESTIMATED SEASONAL HIGH GROUND WATER	SMH	SEWER MANHOLE
EW	EACH WAY	STCK	STOCKAD FENCE
EX.DIST	EXISTING DISTANCE	TBA	TO BE ABANDONED
FF	FINISHED FLOOR	TBC	TOP BACK CURB
FDN	FOUNDATION	TBD	TO BE DETERMINED
FG	FINISH GRADE	TBR	TO BE REMOVED
GALV	GALVANIZED	TC	TOP OF CONCRETE
GW	GROUNDWATER	TEMP	TEMPORARY
HAR	HANDICAP ACCESSIBLE RAMP	TF	TOP OF FOUNDATION
HOR	HORIZONTAL	TO	TOP OF OPENING
HWM	HIGH WATER MARK	TP	TOP OF PAVEMENT
INV	INVERT	TW	TOP OF WALL
MAX	MAXIMUM	TYP	TYPICAL
		VERT	VERTICAL
		WS	WATER SURFACE
		WWF	WELDED WIRE FABRIC

UNIT ABBREVIATIONS

AC	ACRES	KWH	KILOWATT HOURS
AC-FT	ACRE-FOOT	LB	POUNDS
AFA	ACRE-FOOT ANNUALLY	LF	LINEAR FEET
CF	CUBIC FEET	MG	MILLION GALLONS
CFM	CUBIC FEET PER MINUTE	MGD	MILLION GALLONS PER DAY
CFS	CUBIC FEET PER SECOND	MGL	MILLIGRAMS PER LITER
CY	CUBIC YARDS	MI	MILES
FPM	FEET PER MINUTE	MPH	MILES PER HOUR
FPS	FEET PER SECOND	PSI	POUNDS PER SQUARE INCH
FT	FEET	RPM	REVOLUTIONS PER MINUTE
GAL	GALLONS	SF	SQUARE FEET
GPM	GALLONS PER MINUTE	SM	SQUARE MILES
HP	HORSEPOWER	SY	SQUARE YARD
HR	HOURS	T	TONS
IN	INCHES	V	VOLTS
		W	WATTS

PIPE AND VALVE ABBREVIATIONS

AC	ASBESTOS CEMENT	ID	INSIDE DIAMETER
ACCM	ASPHALT-COATED CORRUGATED METAL	IRR	IRRIGATION
AVRV	AIR/VACUUM RELIEF VALVE	MJD	MECHANICAL JOINT DUCTILE IRON
BF	BLIND FLANGE	OD	OUTSIDE DIAMETER
BFV	BUTTERFLY VALVE	OIL	CRUDE OR FUEL OIL
BV	BALL VALVE	PE	PLAIN END
BW	BUTT WELD	PDI	PUSH-ON JOINT DUCTILE IRON
CI	CAST IRON	PRV	PRESSURE REDUCING VALVE
CL	CLASS	PSV	PRESSURE SUSTAINING VALVE
CLD	CEMENT LINED DUCTILE IRON	PVC	POLYVINYL CHLORIDE
CMP	CORRUGATED METAL PIPE	RCP	REINFORCED CONCRETE PIPE
CS	COMBINED SEWER	RD	ROOF DRAIN
CV	CHECK VALVE	RJ	RESTRAINED JOINT
DI	DUCTILE IRON	RW	RESILIENT WEDGE
FD	FOUNDATION DRAIN	S	STEAM
FJD	FLANGED JOINT DUCTILE IRON	ST	STEAM
FLG	FLANGE	UD	UNDERDRAIN
G	GAS	VC	VITRIFIED CLAY
GV	GAS VALVE	WV	WATER VALVE
HDPE	HIGH DENSITY POLYETHYLENE		
HP	HIGH POINT		

SURVEY AND HIGHWAY ABBREVIATIONS

BCC	BITUMINOUS CONCRETE CURB	N/F	NOW OR FORMERLY
BVC	BEGIN VERTICAL CURVE	PC	POINT OF CURVATURE
(C)	CALCULATED	PCC	POINT OF COMPOUND CURVATURE
CCB	CAPE COD BERM	PROG	PRECAST CONCRETE CURB
CTR. BK.	CENTER BACK	PI	POINT OF INTERSECTION
CW	CROSSWALK	PM	PUNCH MARK
DH	DRILL HOLE	PRC	POINT OF REVERSE CURVATURE
DHCB	DRILL HOLE IN CONCRETE BOUND	PT	POINT OF TANGENCY
DHCB	DRILL HOLE IN STONE BOUND	PVC	POINT OF VERTICAL CURVATURE
EOP	EDGE OF PAVEMENT	PVI	POINT OF VERTICAL INTERSECTION
EPLP	ESCUTCHEON PIN IN LEAD PLUG	PVT	POINT OF VERTICAL TANGENCY
EVC	END VERTICAL CURVE	R	RADIUS
FD	FOUND	R	RECORD
HP	HIGH POINT	(R/H)	RECORD AND HOLD
HAT	HUB & TACK	ROW	RIGHT OF WAY
LROD	IRON ROD	SB	STONE BOUND
LPIPE	IRON PIPE	SGC	SLOPED GRANITE CURB
LPIN	IRON PIN	SHLL	STATE HIGHWAY LAYOUT LINE
L	LENGTH	S&S	STAKE & STONES
LP	LOW POINT	STA	STATION
(M)	FIELD MEASURED	SW	SIDEWALK
MAG	MAGNETIC	VOC	VERTICAL GRANITE CURB
MHB	MASS. HIGHWAY BOUND	WCHB	WORCESTER COUNTY HIGHWAY BOUND
MON	MONUMENT	WC	WOOD CURB

TREE ABBREVIATIONS

MP	MAPLE	CH	CHERRY	DG	DOGWOOD
OK	OAK	EM	ELM	AP	APPLE
PN	PINE	AS	ASH	PO	POPLAR
PR	PEAR	BR	BIRCH	WL	WILLOW
CD	CEDAR	LC	LOCUST	HM	HEMLOCK
CA	CATALPA	SP	SPRUCE	BE	BEECH
FR	FIR	WA	WALNUT		

GEOPHYSICAL LEGEND

EXISTING	PROPOSED

UTILITIES LEGEND

EXISTING	PROPOSED

SURVEY AND HIGHWAY LEGEND

EXISTING	PROPOSED

SITE IMPROVEMENTS LEGEND

EXISTING	PROPOSED



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APPROVAL UNDER SITE PLAN REVIEW. FRANKLIN PLANNING BOARD

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FRANKLIN TOWN CLERK DATE


PROJECT:	LARGE-CAPACITY GROUND MOUNTED SOLAR ENERGY SYSTEM SPRING STREET FRANKLIN, MA
APPLICANT:	SPRING ST. RENEWABLES, LLC 101 SUMMER STREET BOSTON, MA 02110

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GRAPHIC SCALE

SHEET TITLE

LEGEND, ABBREVIATIONS & GENERAL NOTES

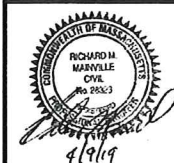

DES BY: KNP DATE: NOVEMBER 21, 2018
CHK BY: RMM PROJECT NO. 2018-101

CO.1

PLAN NO. L-5681


ZONING REQUIREMENTS

ZONE: RURAL RESIDENTIAL I
PROPOSED USE: GROUND-MOUNTED SOLAR PV SYSTEM

	REQUIRED	PROPOSED
AREA	40,000 SF	2,098,739 SF
FRONTAGE	200 FT	997 FT
DEPTH	200 FT	N/A
LOT WIDTH	160 FT	N/A
FRONT YARD	40 FT	N/A
SIDE YARD	40 FT	N/A
REAR YARD	40 FT	N/A
MAXIMUM HEIGHT	35 FT	N/A
MAXIMUM IMPER. COVERAGE OF EXISTING UPLAND	25%	0.00%

- 1 RICHARD COSTELLO
MAP 310, PARCEL 2
ZONE: RURAL RESIDENTIAL I (RR1)
USE: RES. DEV LAND
- 2 MICHAEL BUCCI
MAP 309, PARCEL 15
ZONE: RR1
USE: RES. UNDEV LAND
- 3 ANTHONY DEPOTO
MAP 323, PARCEL 44
ZONE: RR1
USE: RES. UNDEV LAND
- 4 STUART KLEIN
MAP 324, PARCEL 31
ZONE: RR1
USE: ONE FAMILY
- 5 EDWARD MAZUKINA
MAP 323, PARCEL 2
ZONE: RR1
USE: ONE FAMILY
- 6 WILLIAM LESSARD
MAP 323, PARCEL 4
ZONE: RR1
USE: ONE FAMILY
- 7 GREGORY & JILL KUYKENDALL
MAP 323, PARCEL 5
ZONE: RR1
USE: ONE FAMILY
- 8 HEDWIG & KARL VONNEGUT
MAP 323, PARCEL 6
ZONE: RR1
USE: ONE FAMILY
- 9 ROBERT BECKMANN
MAP 323, PARCEL 7
ZONE: RR1
USE: ONE FAMILY
- 10 COMMONWEALTH OF MASSACHUSETTS
MAP 323, PARCEL 40
ZONE: RR1
USE: SNR - PARKS & RECREATION
- 11 PATRICIA MORSE
MAP 323, PARCEL 41
ZONE: RR1
USE: 61A/61B/COM
- 12 ERIC & KRISTEN POLITO
MAP 323, PARCEL 43
ZONE: RR1
USE: ONE FAMILY
- 13 BARBARA & HARRY COCHRAN
MAP 310, PARCEL 1
ZONE: RR1
USE: ONE FAMILY
- 14 PATRICIA MORSE
MAP 323, PARCEL 46
ZONE: RR1
USE: 61A/61B/COM

- 15 COMMONWEALTH OF MASSACHUSETTS
MAP 293, PARCEL 1
ZONE: RR1
USE: SNR - PARKS & RECREATION
- 16 TOWN OF FRANKLIN
MAP 310, PARCEL 2
ZONE: RR1
USE: VACANT - CONSERVATION
- 17 GARY & SUSAN NASSOY
MAP 308, PARCEL 20
ZONE: RR1
USE: ONE FAMILY
- 18 CHRISTOPHER QUEALLY
MAP 308, PARCEL 21
ZONE: RR1
USE: ONE FAMILY
- 19 JOHN WAHLBERG
MAP 308, PARCEL 22
ZONE: RR1
USE: ONE FAMILY
- 20 TORI DUNHAM
MAP 308, PARCEL 23
ZONE: RR1
USE: ONE FAMILY
- 21 KYLE & KERI VINING
MAP 308, PARCEL 25
ZONE: RR1
USE: ONE FAMILY
- 22 FLOYD HENO
MAP 308, PARCEL 76
ZONE: RR1
USE: 61A/61B/COM
- 23 ALAN & LISA DAVIS
MAP 324, PARCEL 17
ZONE: RR1
USE: ONE FAMILY
- 24 MARK & ALEXANDRA LEPAGE
MAP 309, PARCEL 12
ZONE: RR1
USE: ONE FAMILY
- 25 JOSEPH & MICHELE TODESCA
MAP 309, PARCEL 13
ZONE: RR1
USE: ONE FAMILY
- 26 MICHAEL & KATHLEEN FITZGERALD
MAP 309, PARCEL 14
ZONE: RR1
USE: ONE FAMILY
- 27 STEPHEN & NANCY CUNNINGHAM
MAP 324, PARCEL 16
ZONE: RR1
USE: ONE FAMILY

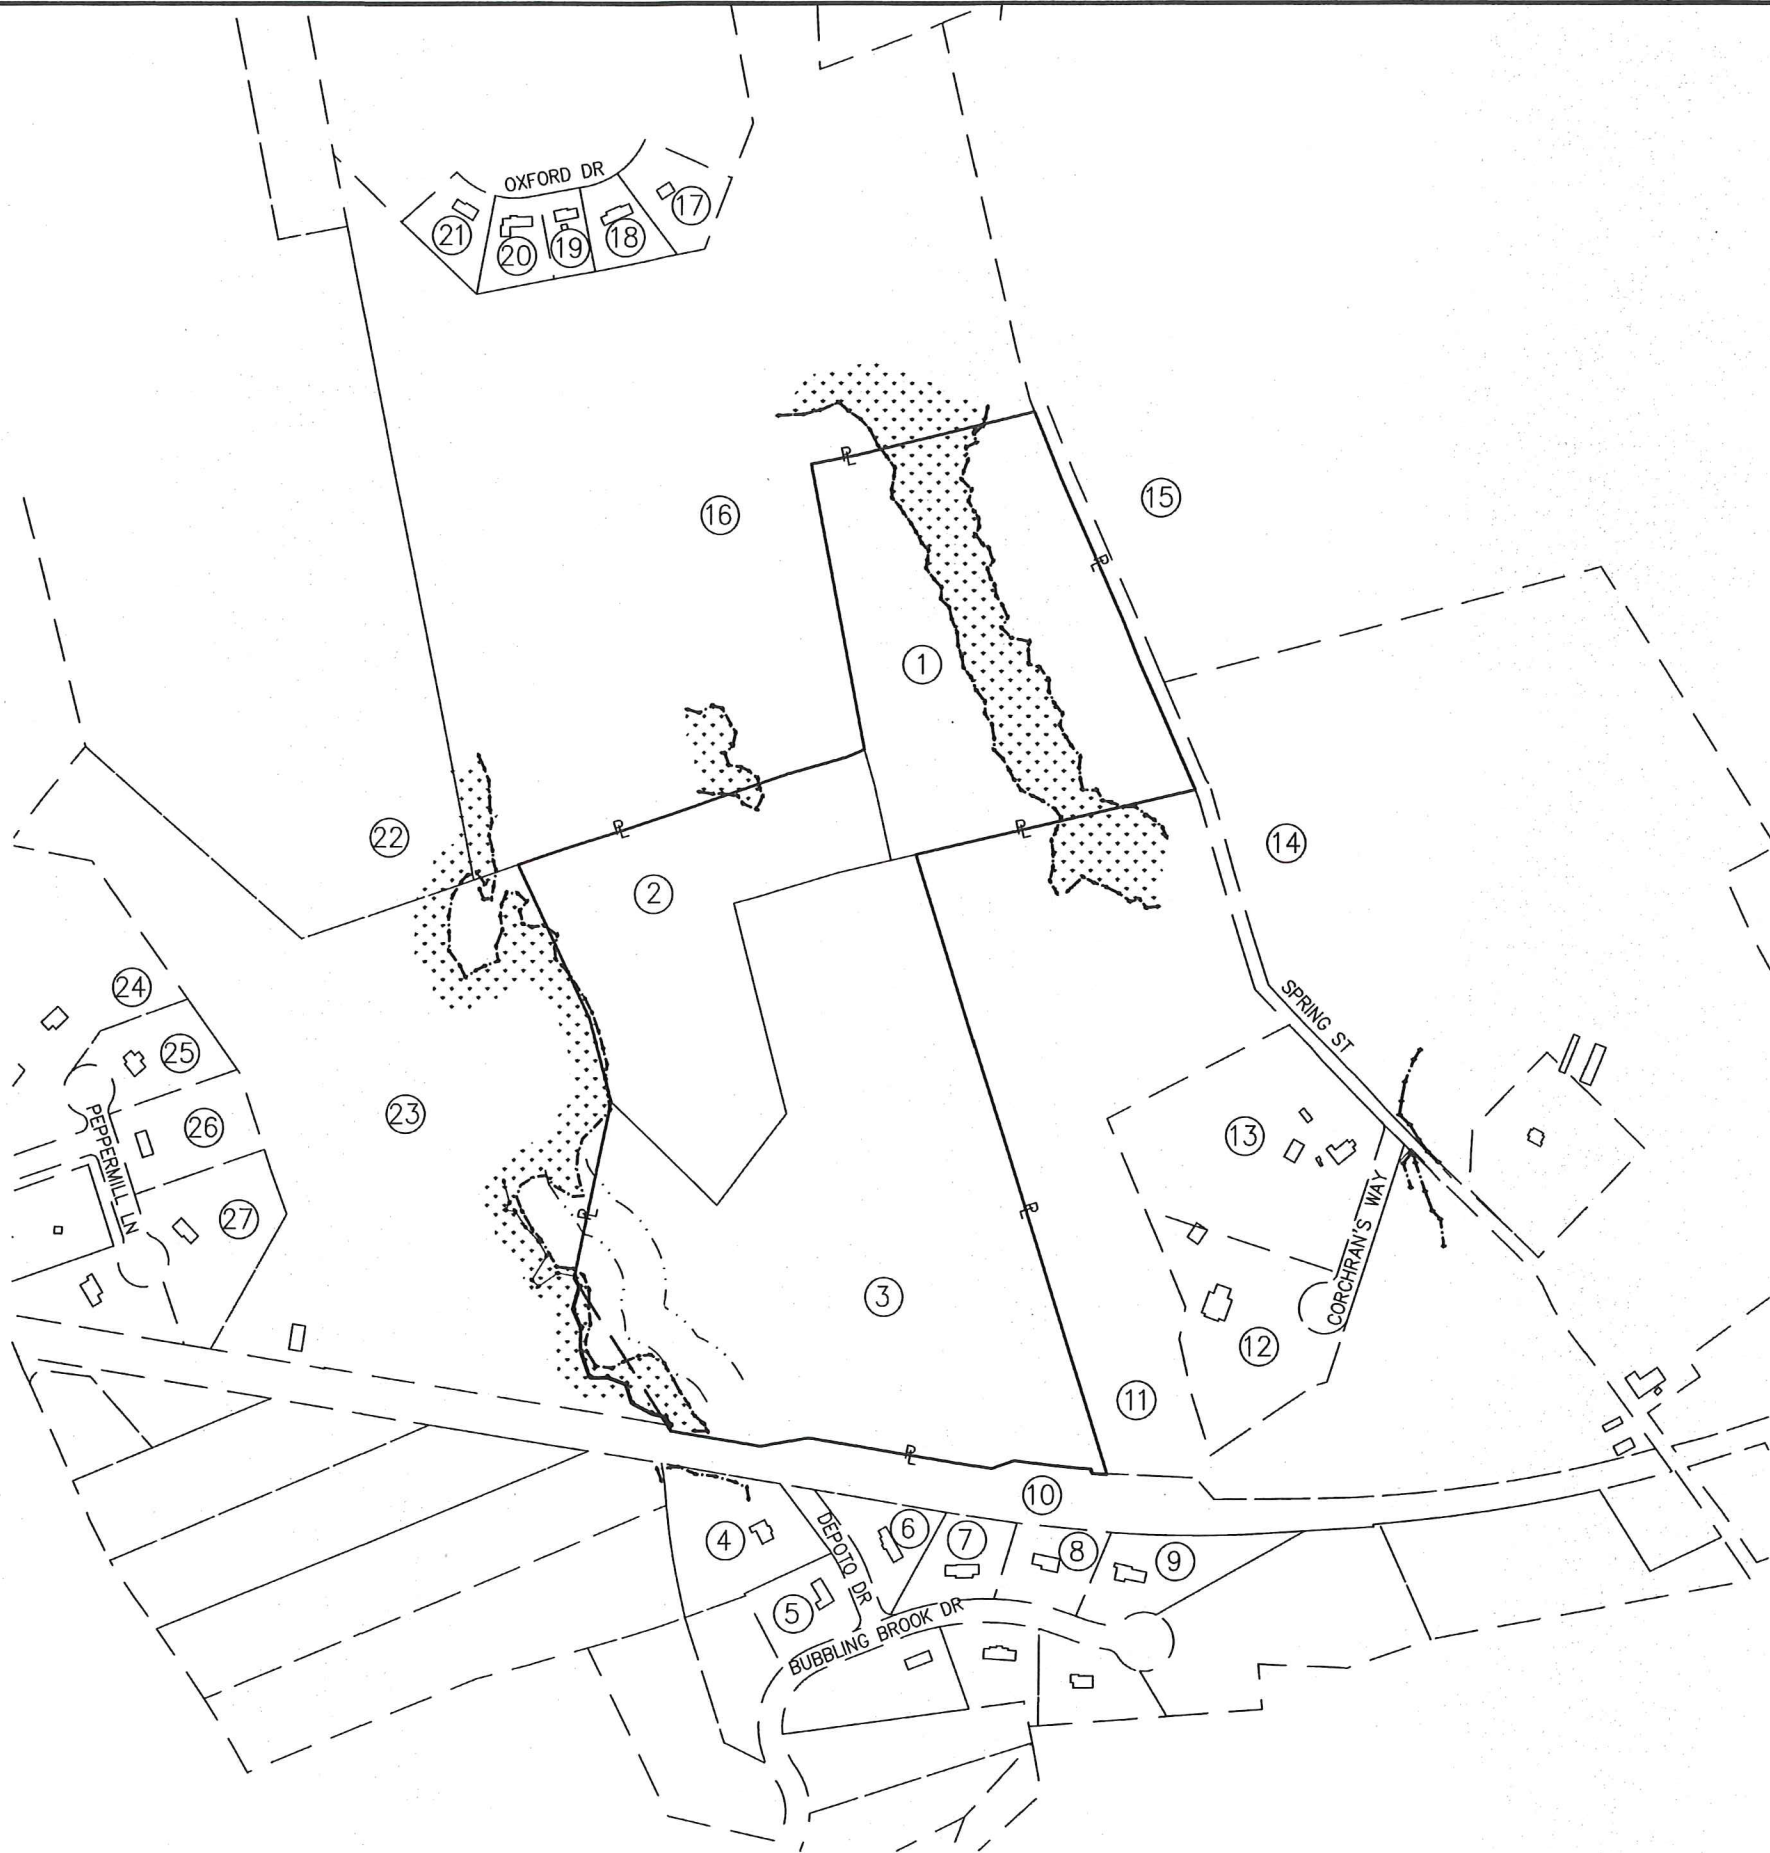

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APPROVAL UNDER SITE PLAN REVIEW.
FRANKLIN PLANNING BOARD


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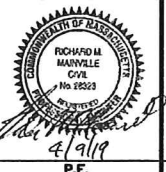
FRANKLIN TOWN CLERK DATE

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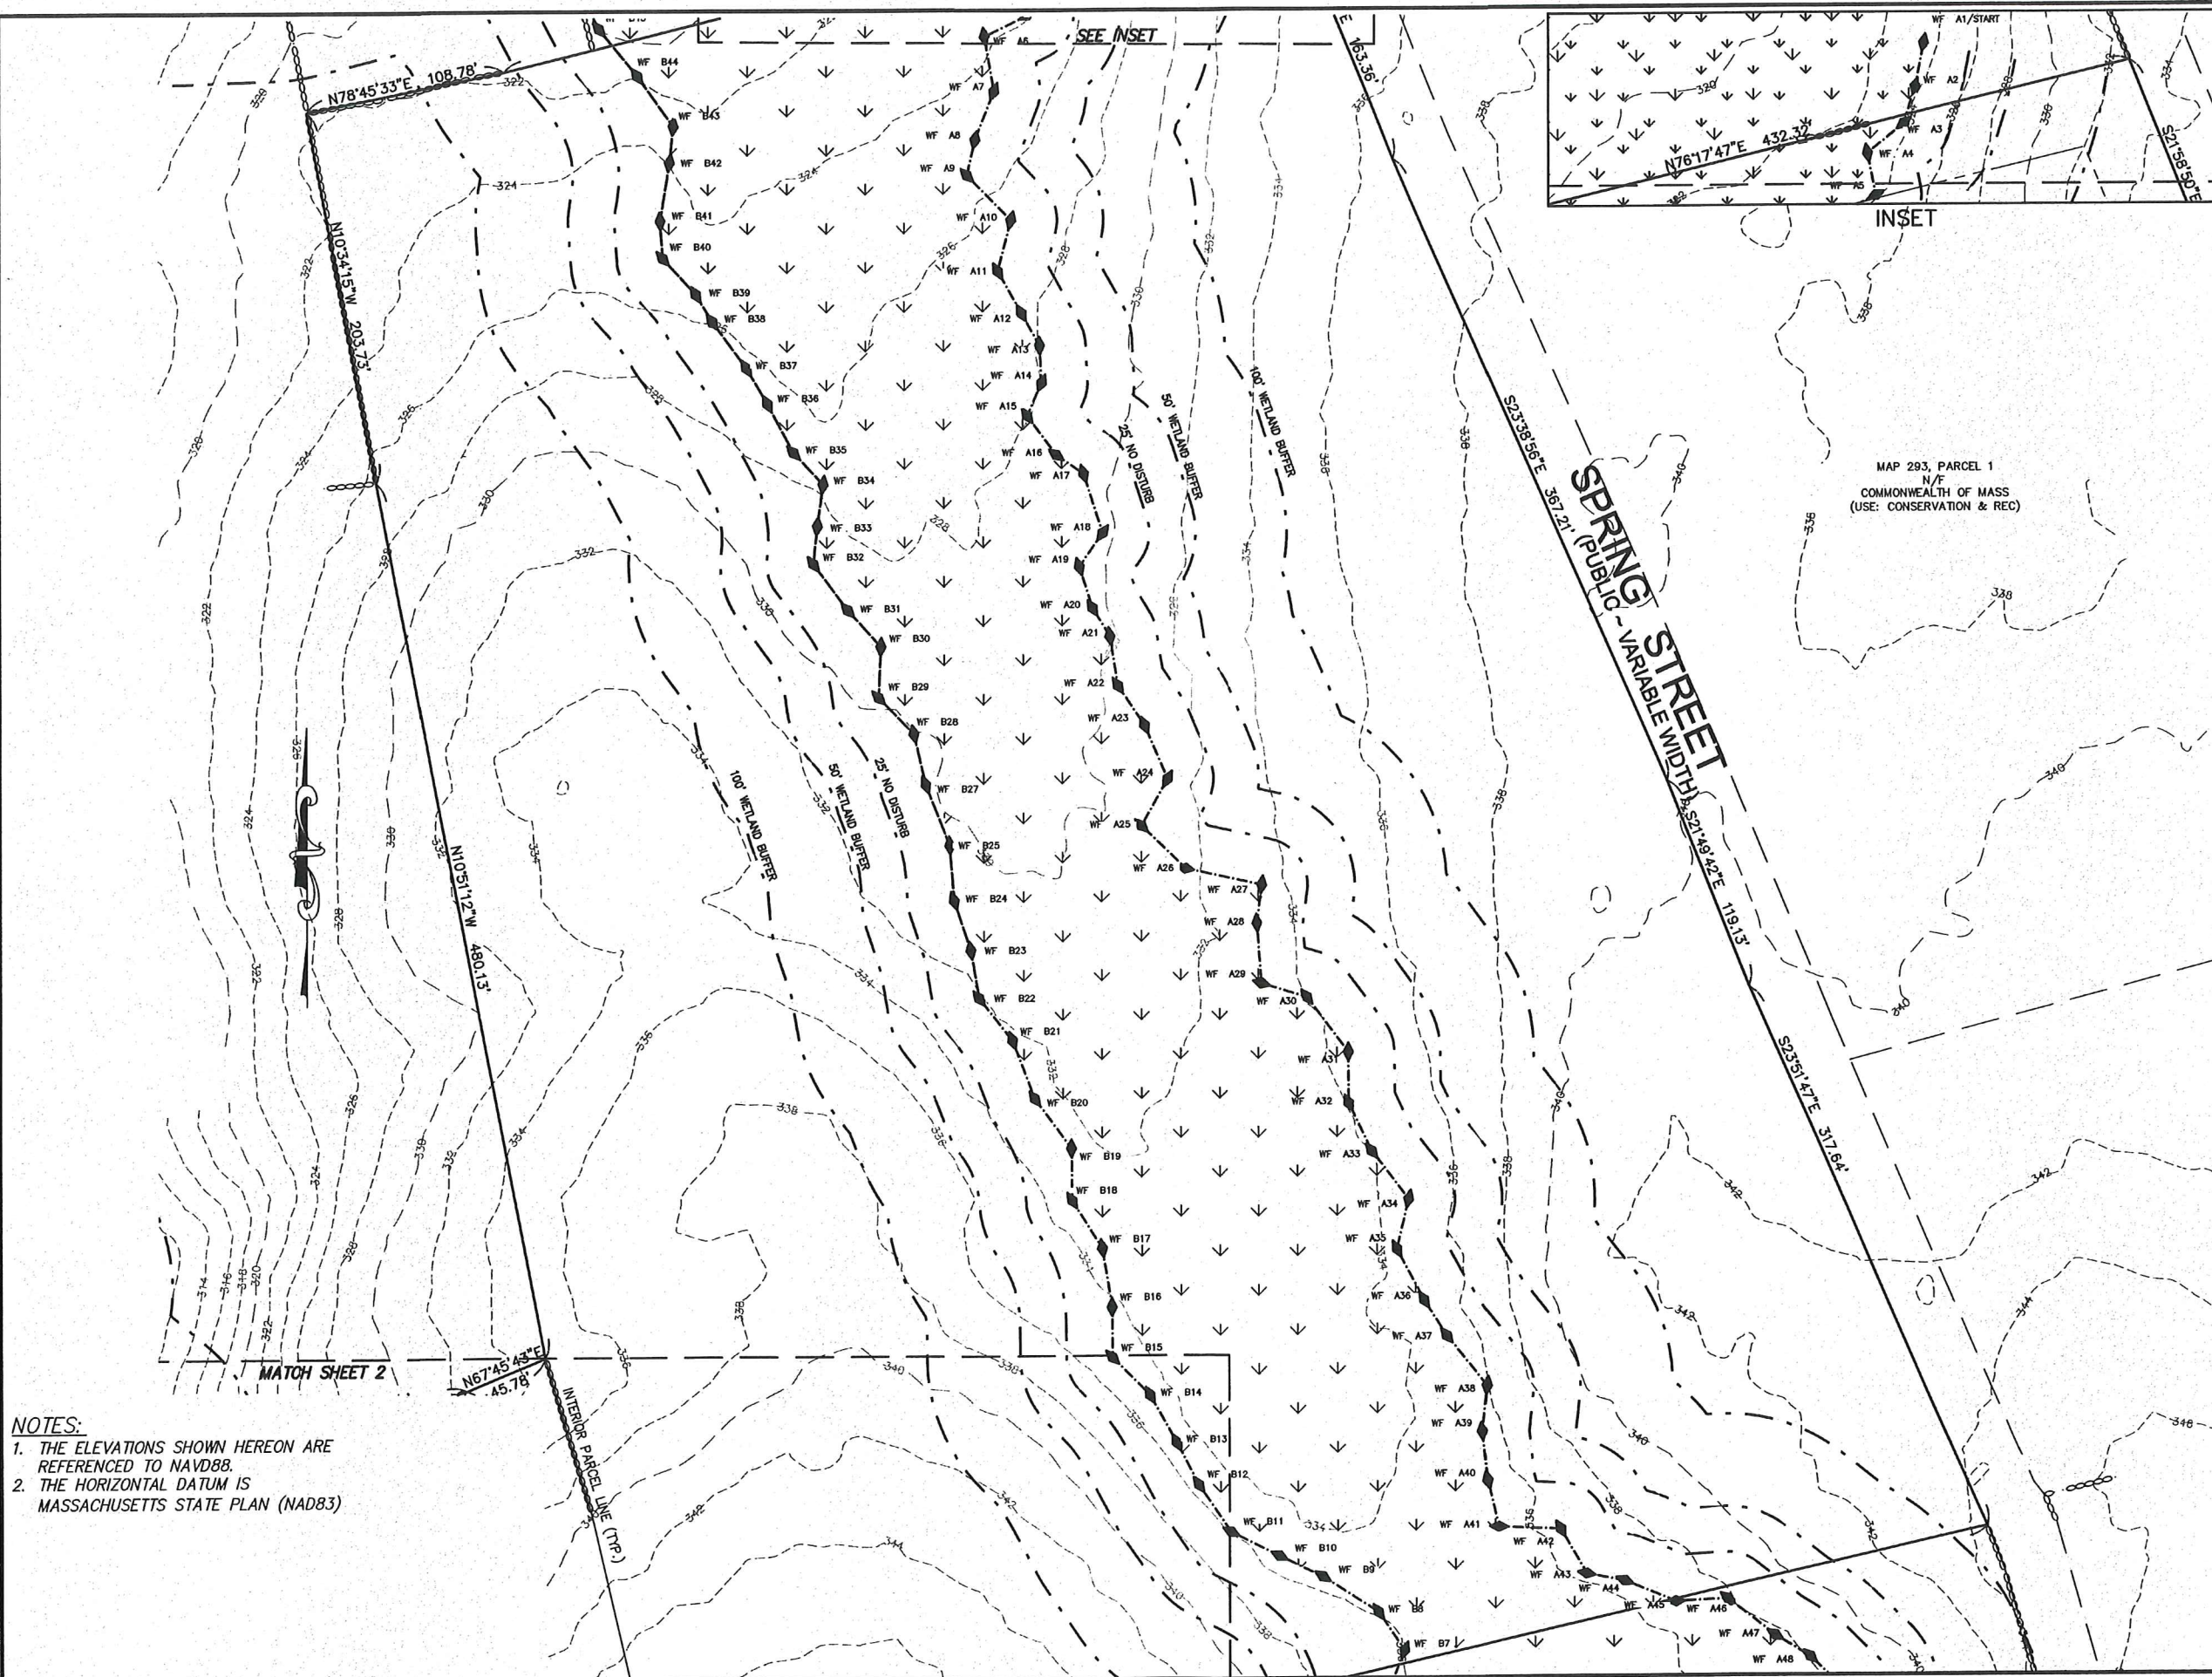
SHEET TITLE
VICINITY MAP



DES BY: KMP DATE: NOVEMBER 21, 2018
CHK BY: RAM PROJECT NO. 2018-101

C1.0
PLAN NO. L-5591

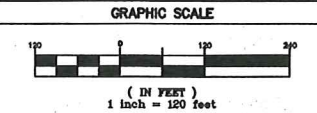F:\ACAD\2018 PROJECTS\2018-101\SP_02.DWG 03-28-19 11:52:57 AM - LAYOUT 1



- NOTES:
1. THE ELEVATIONS SHOWN HEREON ARE REFERENCED TO NAVD88.
 2. THE HORIZONTAL DATUM IS MASSACHUSETTS STATE PLAN (NAD83)



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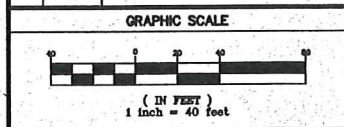
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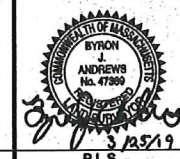
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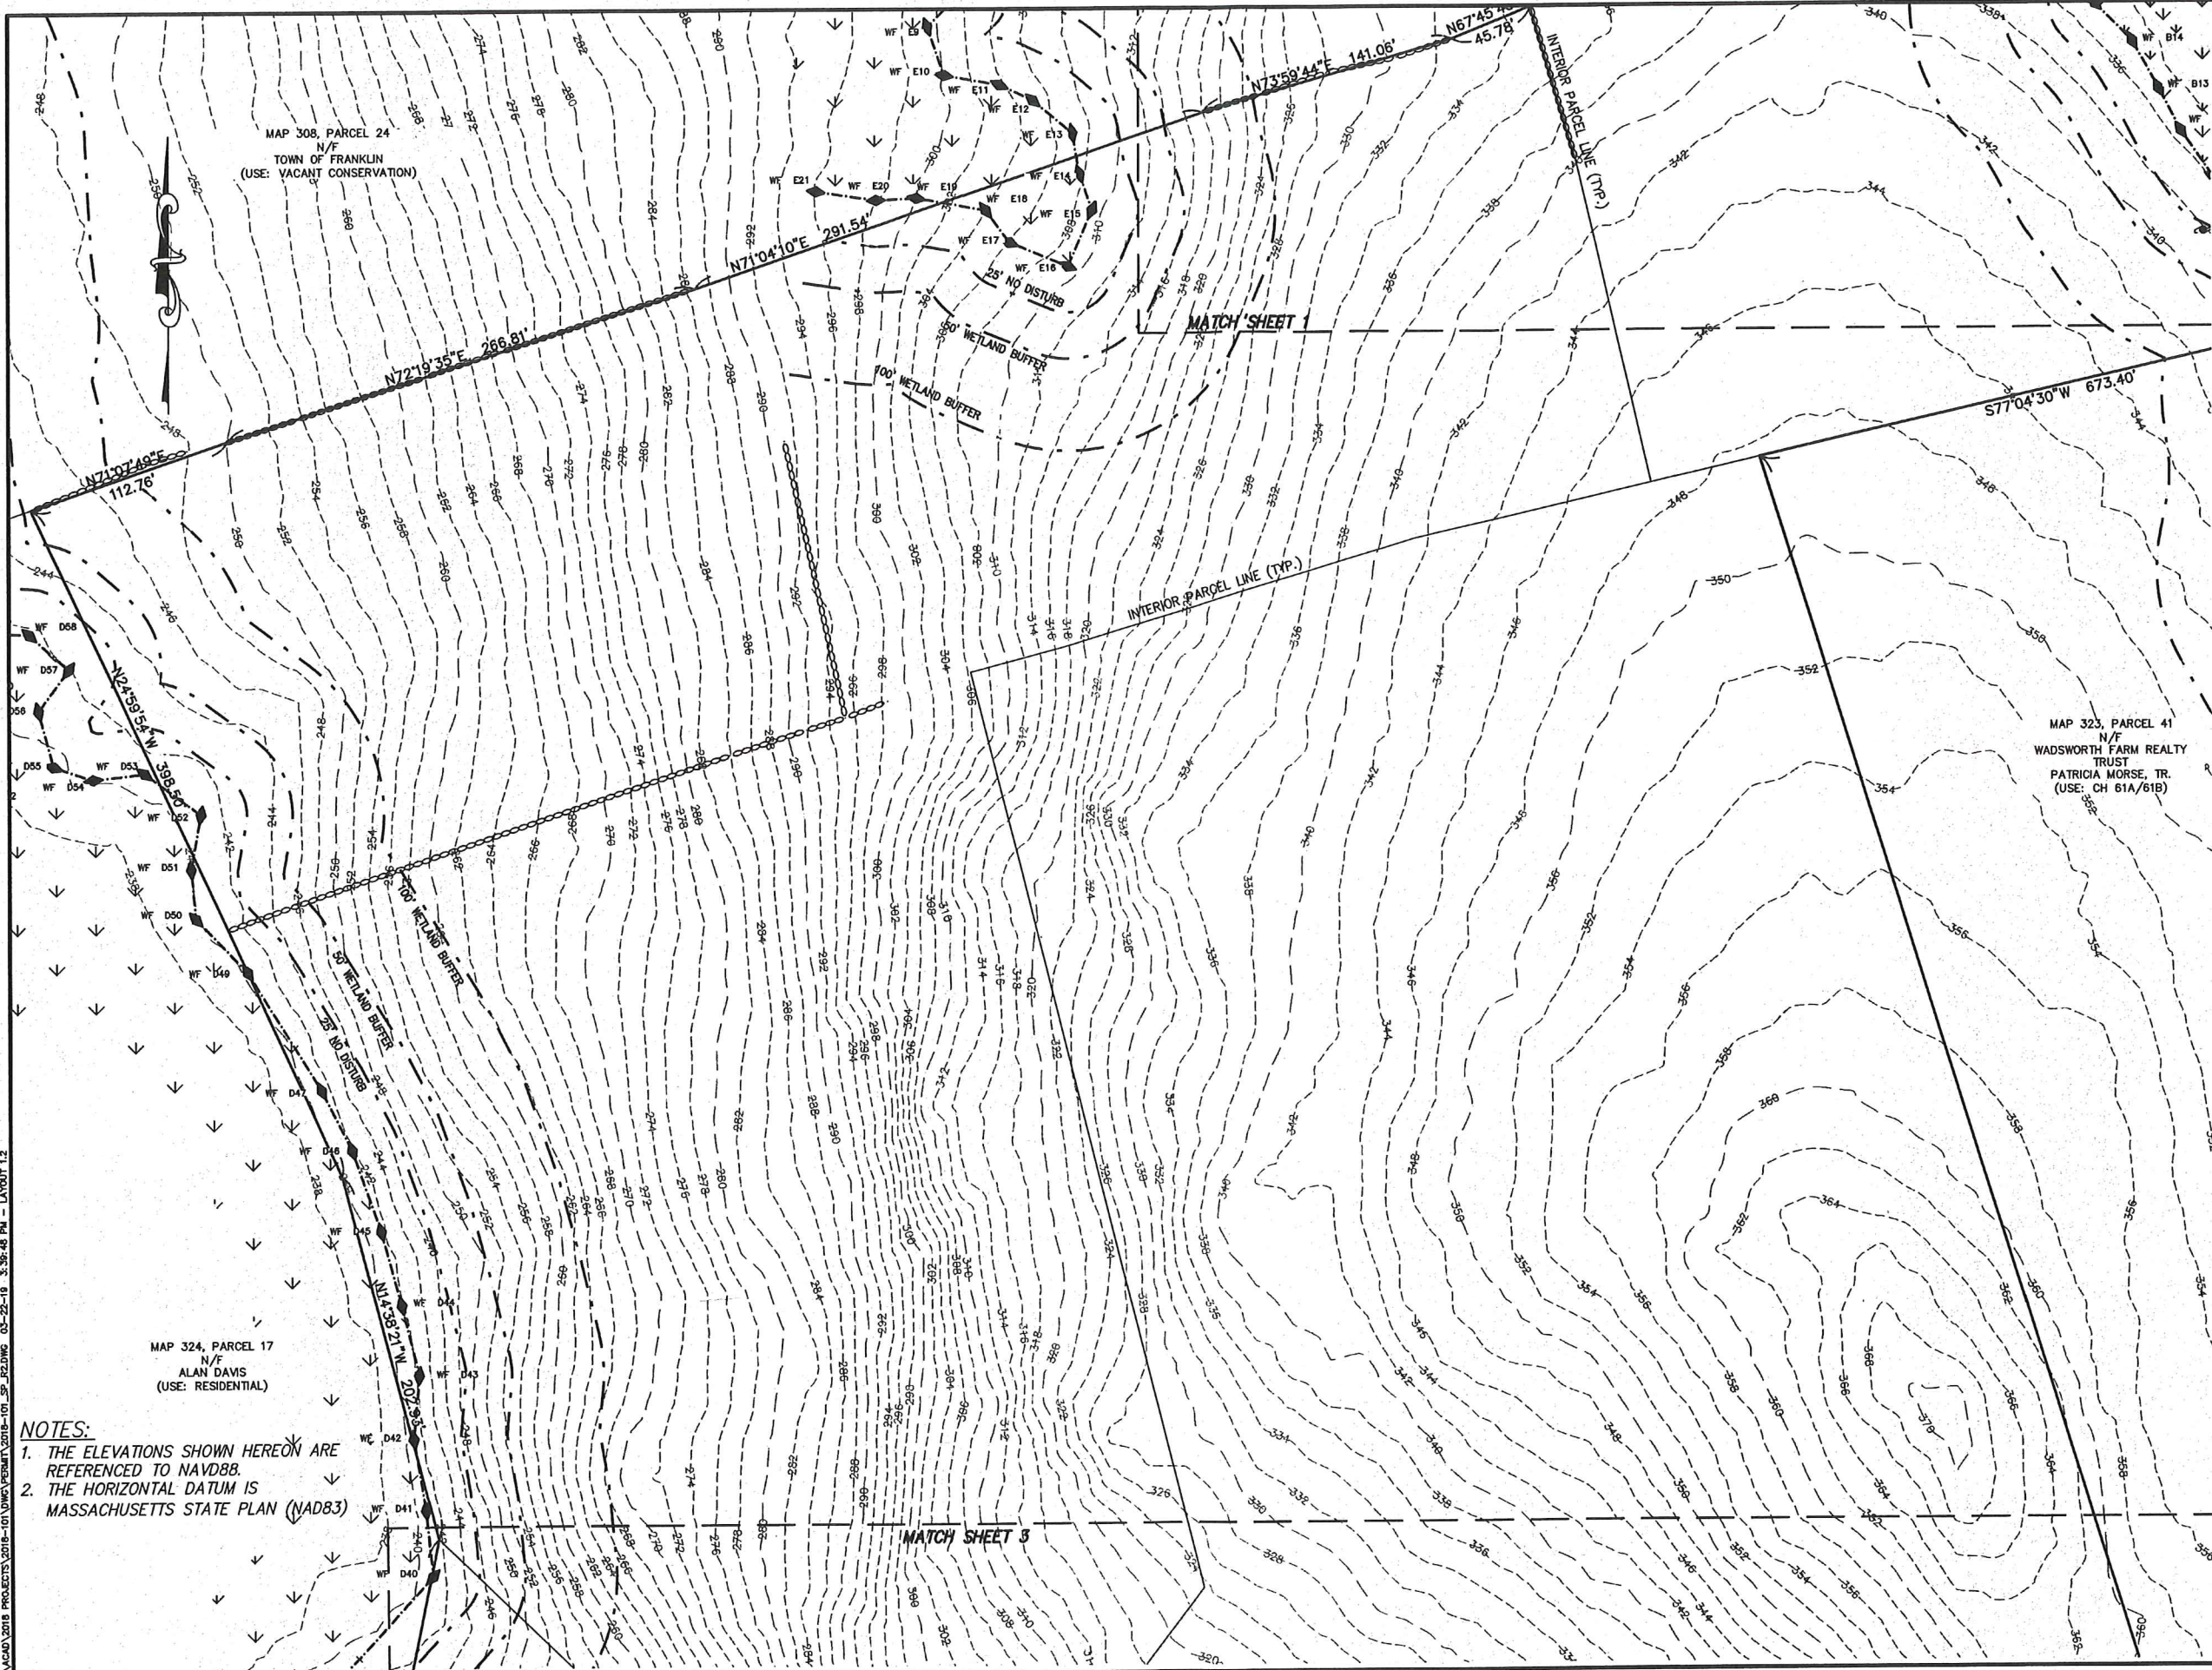


SHEET TITLE
EXISTING CONDITIONS
SHEET 1 OF 3



DES BY: KMP DATE: NOVEMBER 21, 2018
CHK BY: RMM PROJECT NO. 2018-101
P.L.S. C1.1
PLAN NO. L-5691

F:\VACAD\2018 PROJECTS\2018-101\VACAD\2018-101_SP_122.DWG 03-22-18 3:39:48 PM - LAYOUT 1.2



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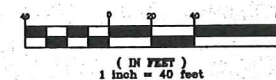
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SPRING STREET
FRANKLIN, MA

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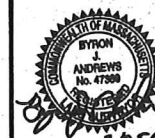
GRAPHIC SCALE



SHEET TITLE

EXISTING CONDITIONS


SHEET 2 OF 3



DES BY: KNP DATE: NOVEMBER 21, 2018
CHK BY: RJM PROJECT NO. 2018-101

P.L.S.
C1.2

PLAN NO. L-5891

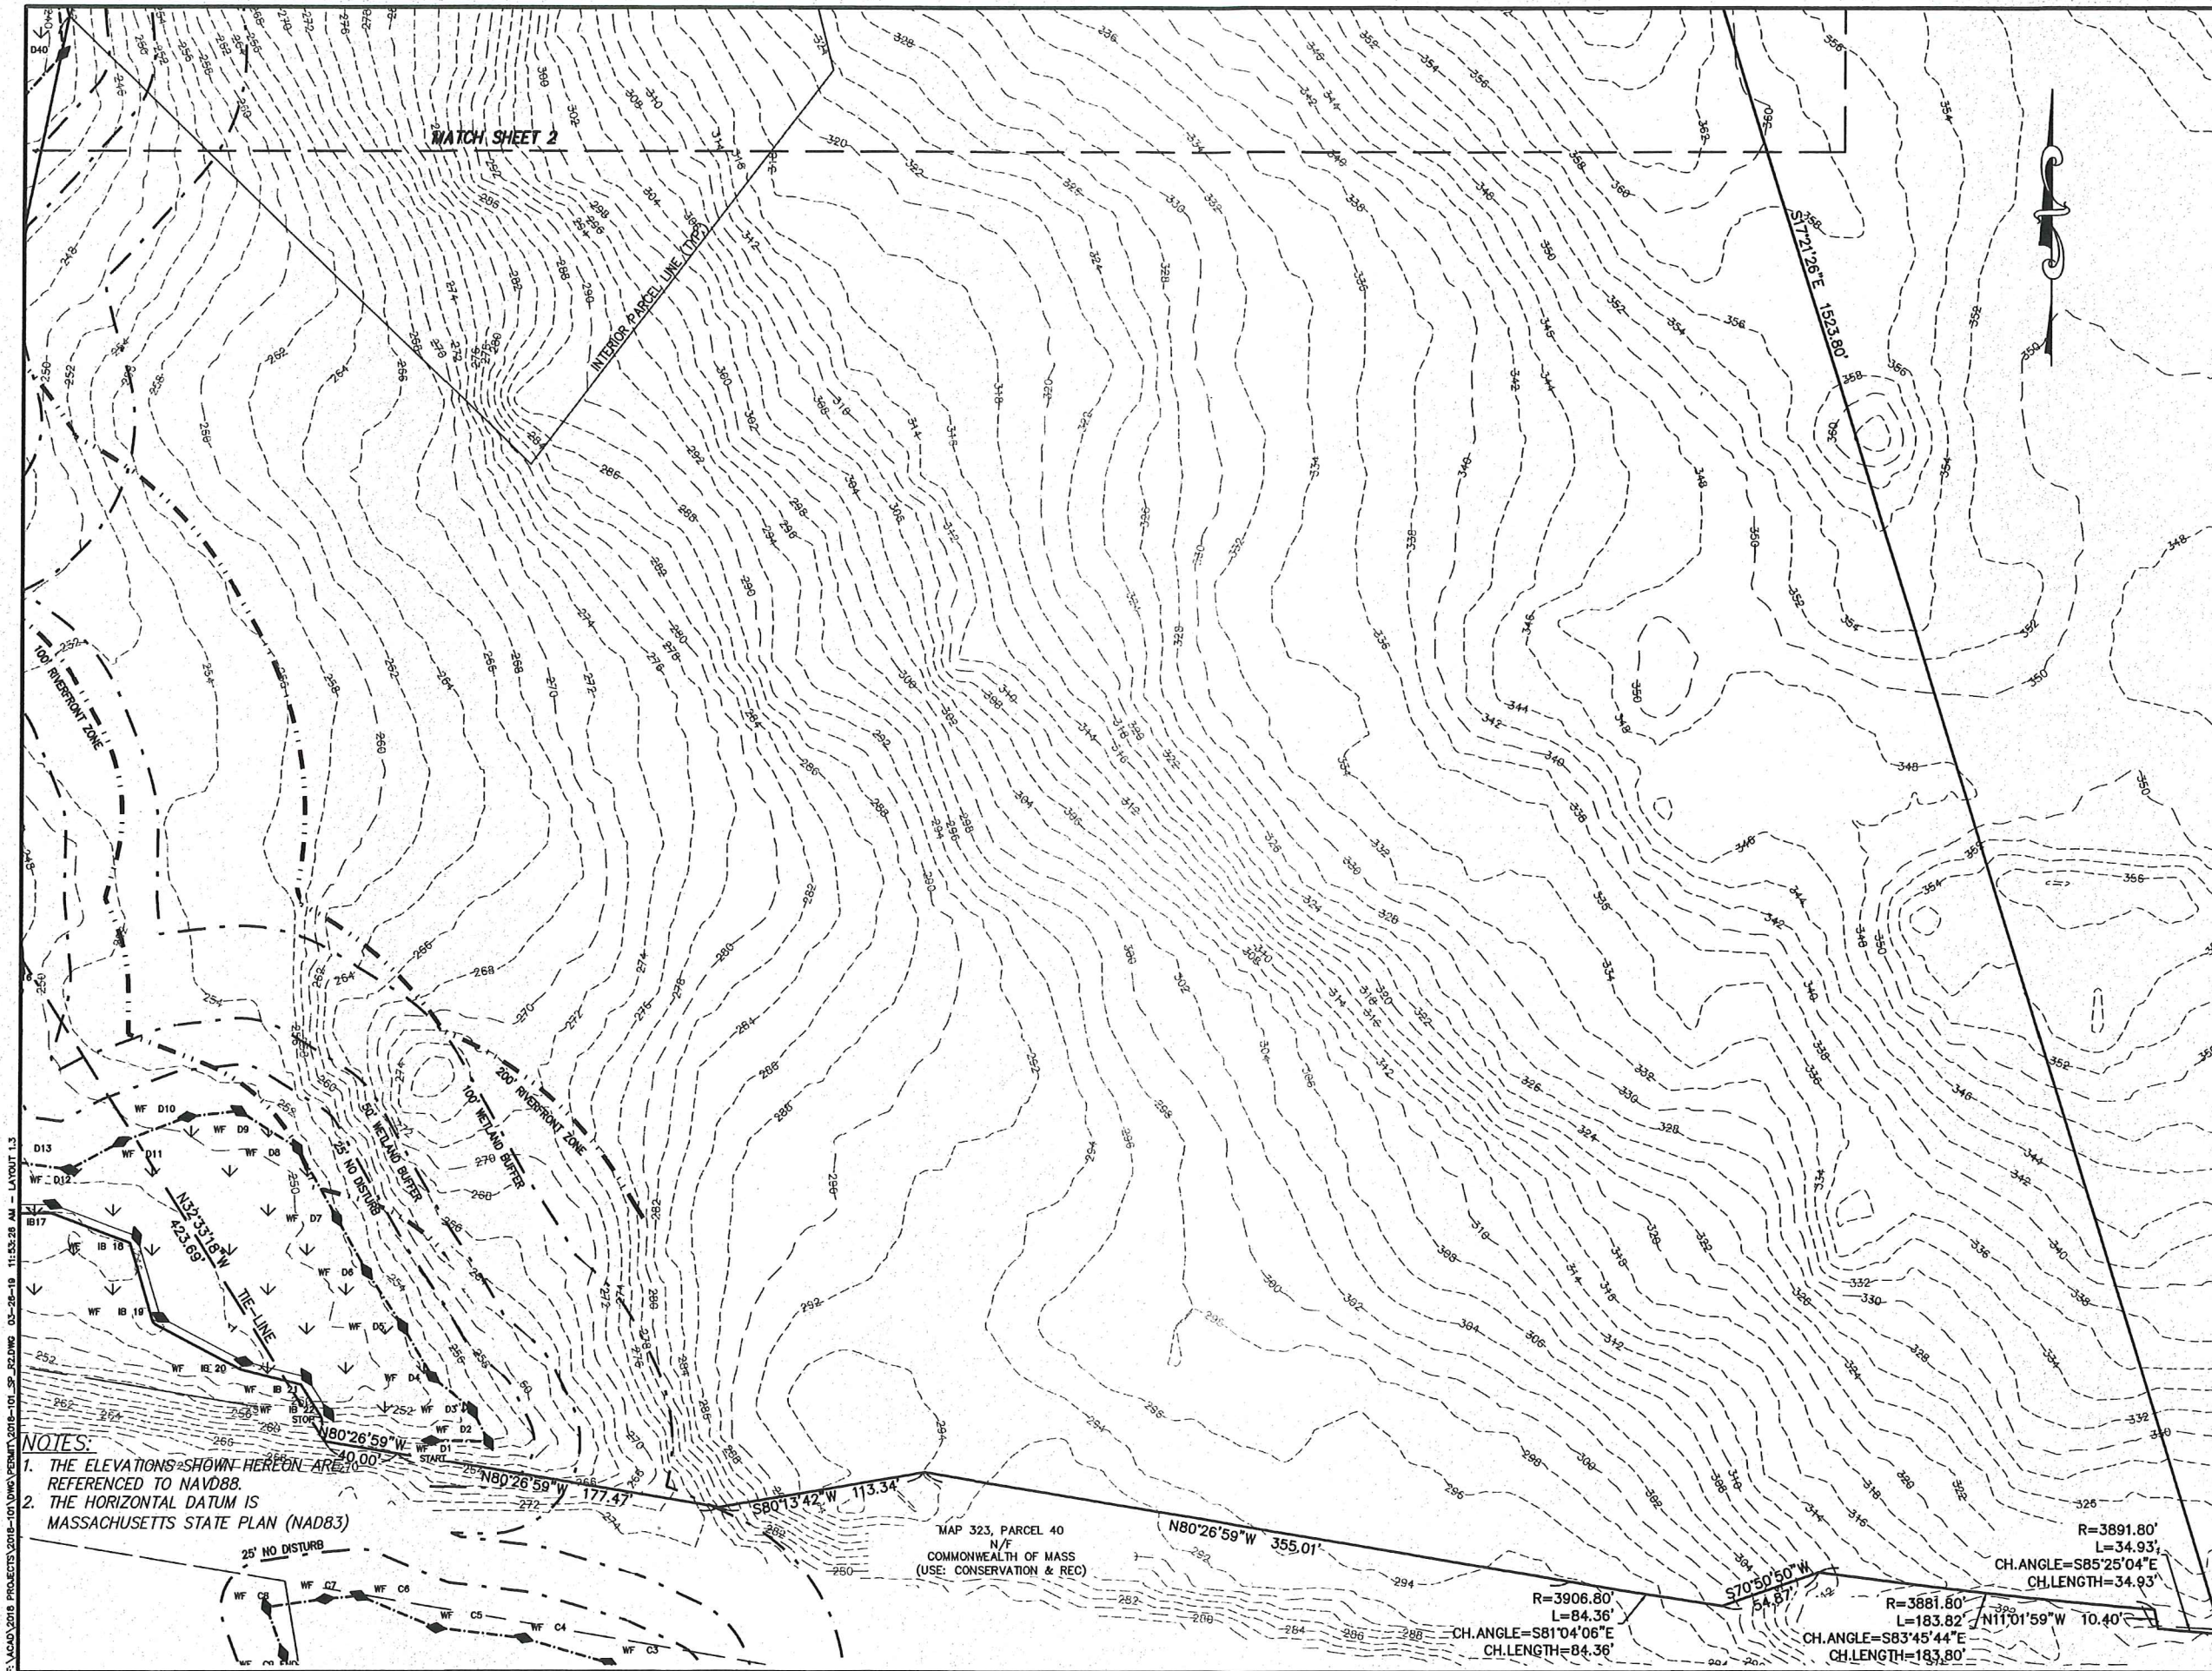

F:\VACUO\2018 PROJECTS\2018-101 VMS PERMIT\2018-101 SP PLD.WG 03-28-18 11:53:28 AM - LAYOUT 1.3

- NOTES:
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 2. THE HORIZONTAL DATUM IS MASSACHUSETTS STATE PLAN (NAD83)

MAP 323, PARCEL 40
N/F
COMMONWEALTH OF MASS
(USE: CONSERVATION & REC)



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North Attleboro, Massachusetts 01760
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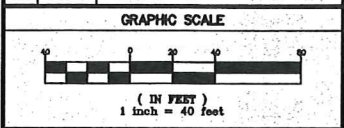
APPROVAL UNDER SITE PLAN REVIEW.
FRANKLIN PLANNING BOARD.

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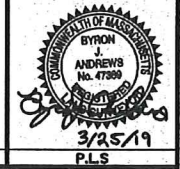
FRANKLIN TOWN CLERK DATE

PROJECT: LARGE-CAPACITY GROUND MOUNTED SOLAR ENERGY SYSTEM
MOUNTED SPRING STREET
FRANKLIN, MA
APPLICANT: SPRING ST. RENEWABLES, LLC
101 SUMMER STREET
BOSTON, MA 02110

REVISIONS		
NO.	DATE	DESCRIPTION
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2	03/11/19	DEP COMMENTS



SHEET TITLE
EXISTING CONDITIONS
SHEET 3 OF 3



DES BY: KNP DATE: NOVEMBER 21, 2018
CHK BY: RMM PROJECT NO: 2018-101
C1.3
PLAN NO. L-5691


ZONING REQUIREMENTS

ZONE: RURAL RESIDENTIAL I
PROPOSED USE: GROUND-MOUNTED SOLAR PV SYSTEM

	REQUIRED	PROPOSED
AREA	40,000 SF	2,098,739 SF
FRONTAGE	200 FT	987 FT
DEPTH	200 FT	1,531 FT
LOT WIDTH	180 DIA.	667 DIA.
FRONT YARD	40 FT	40 FT
SIDE YARD	40 FT	40 FT
REAR YARD	40 FT	40 FT
MAXIMUM HEIGHT	35 FT	N/A
MAXIMUM IMPER. COVERAGE OF EXISTING UPLAND	25%	(971 SF / 1,924,865) 0.05%

OBSERVATION TEST HOLE DATA
PERFORMED BY: JOHN MADEROS, R.S., SE#2849
ANDREWS SURVEY & ENGINEERING, INC. (10/16/18 & 10/17/18)

TH 1016-3 (ELEV. = 261.0)	0-3" A FSL 3-18" B FSL 16-48" C1 SL 48-84" C2 SAND ESIGHT @ 3.0' (258.0) WATER @ 5' (256.0) REFUSAL @ N/A
TH 1016-4 (ELEV. = 260.0)	0-3" A FSL 3-30" B FSL 30-84" C SAND ESIGHT @ 2.5' (257.5) WATER @ 5.2' (254.8) REFUSAL @ N/A
TH 1016-5 (ELEV. = 261.0)	0-4" A FSL 4-32" B FSL 32-84" C SAND ESIGHT @ 2.3' (258.7) WATER @ 6.8' (254.2) REFUSAL @ N/A
TH 1017-10 (ELEV. = 267.0)	0-6" A FSL 6-24" B FSL 24-84" C SAND ESIGHT @ 4.0' (263.0) WATER @ 7.0' (260.0) REFUSAL @ N/A
TH 1017-16 (ELEV. = 338.8)	0-10" A FSL 10-18" B FSL 18-120" C SL ESIGHT @ 5' (333.8) WATER @ 9' (329.8) REFUSAL @ N/A

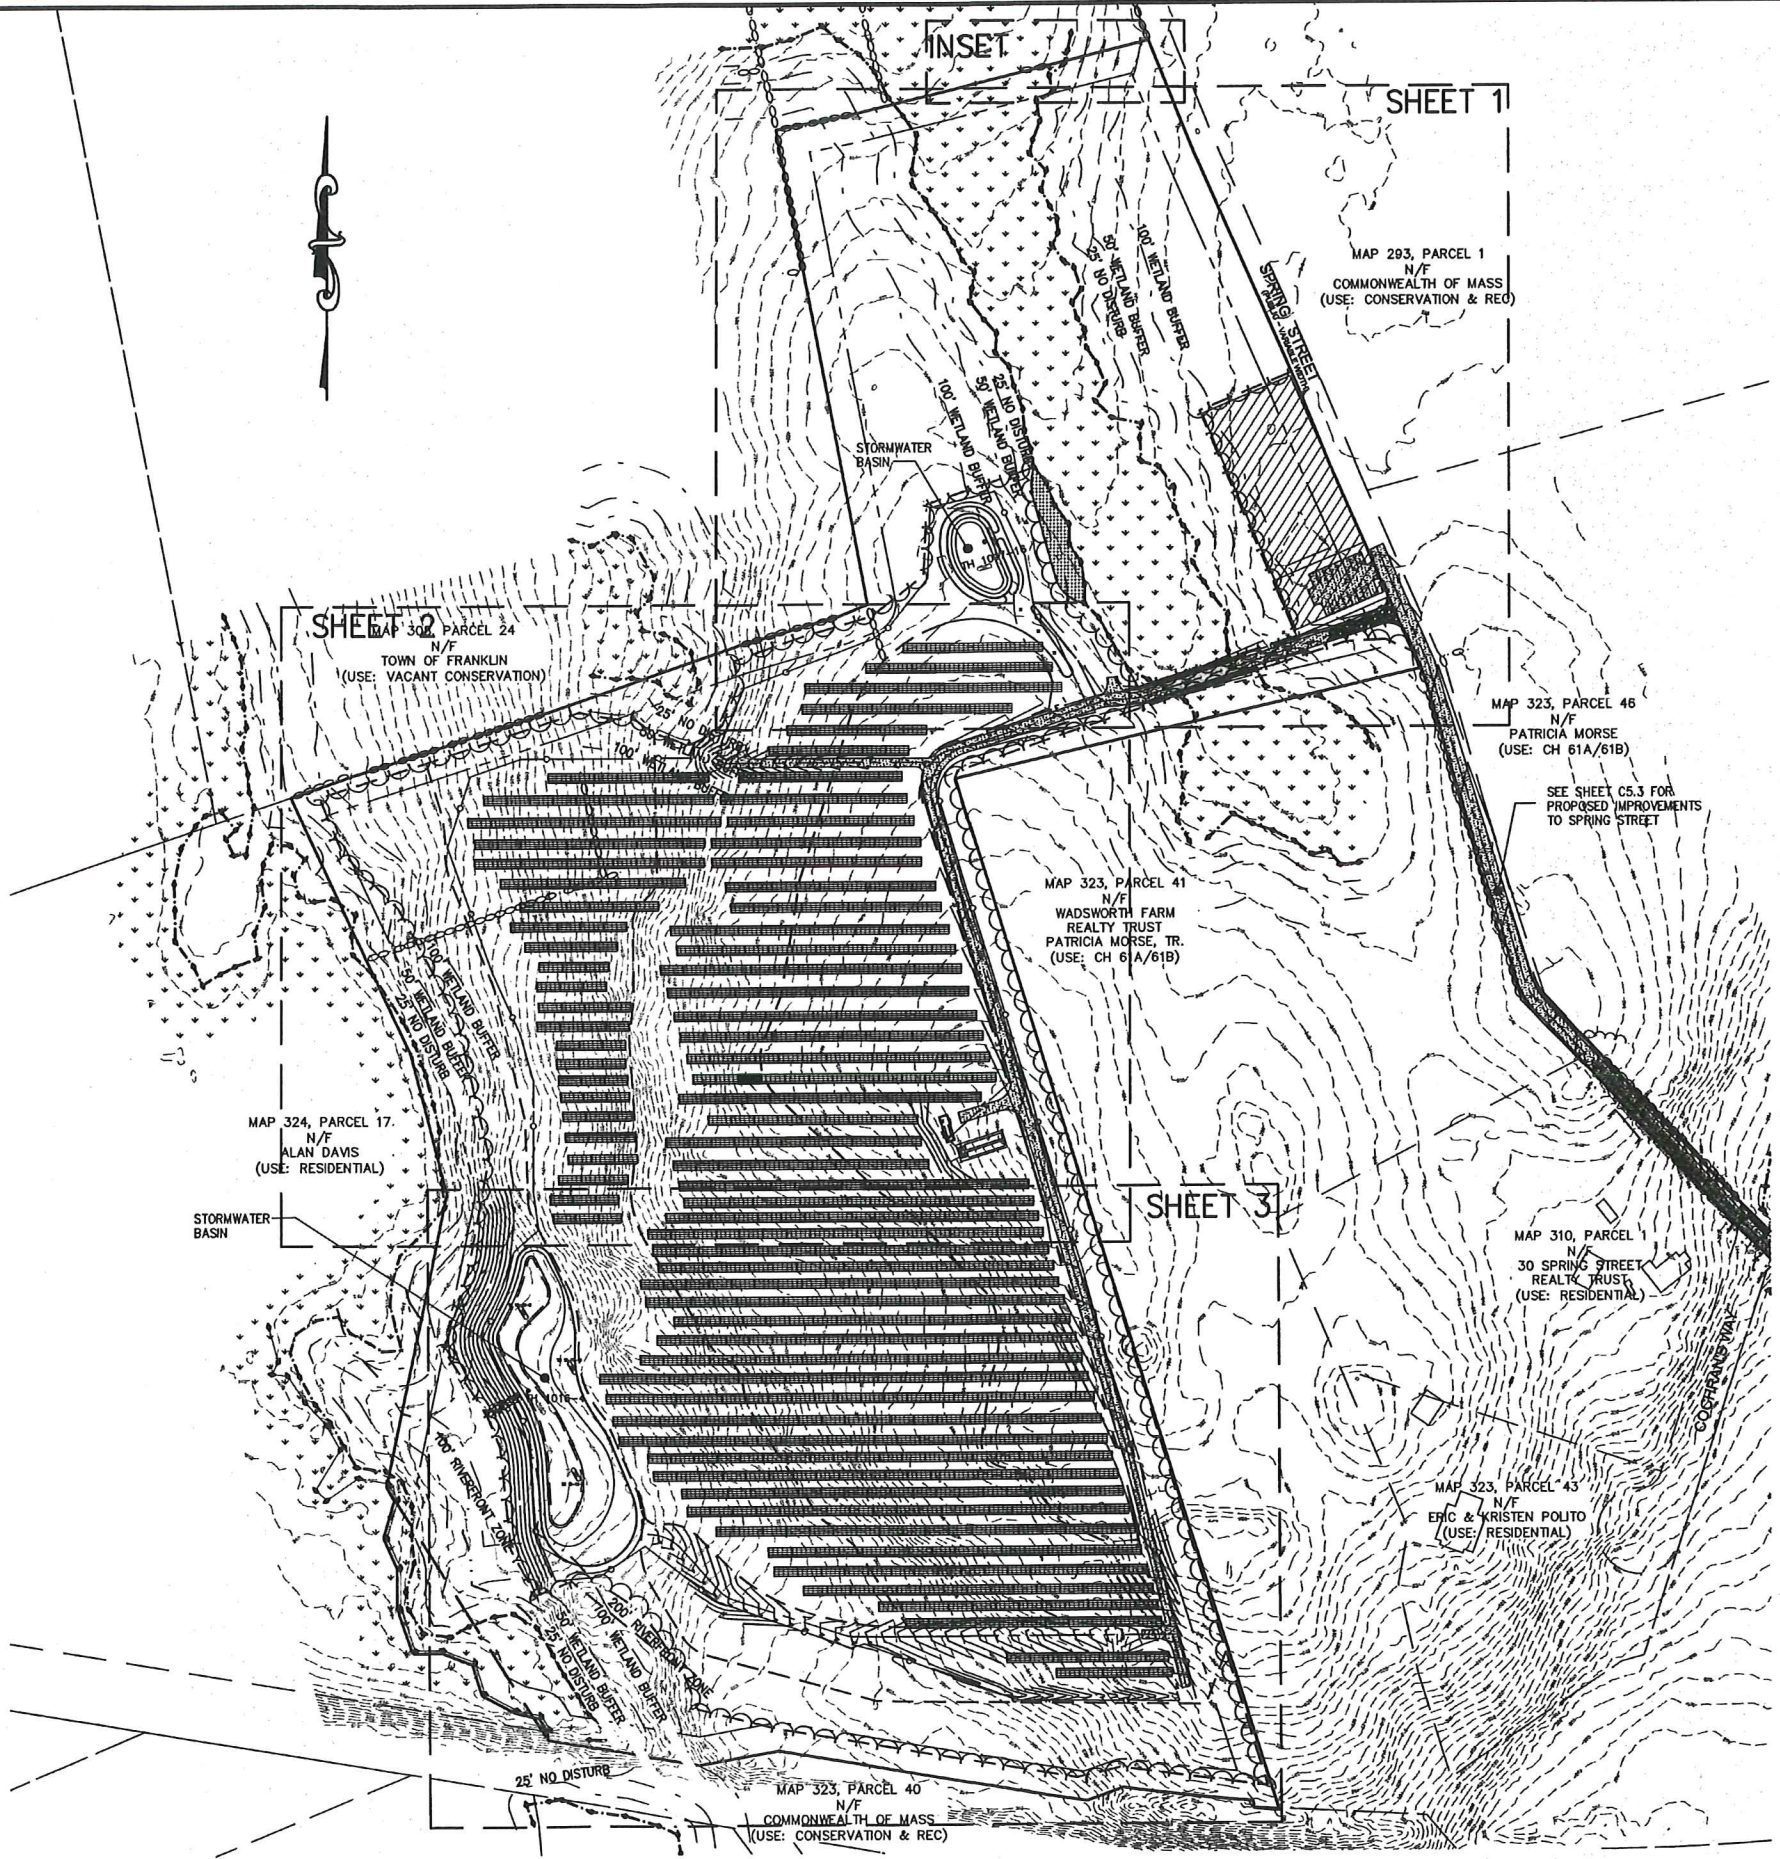

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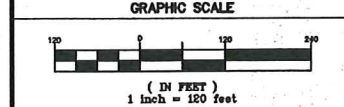
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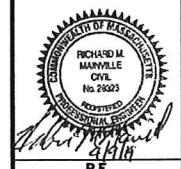
FRANKLIN TOWN CLERK DATE

PROJECT:	LARGE-CAPACITY GROUND MOUNTED SOLAR ENERGY SYSTEM SPRING STREET FRANKLIN, MA	APPLICANT:	SPRING ST. RENEWABLES, LLC 101 SUMMER STREET BOSTON, MA 02110

REVISIONS		
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3	03/28/19	PER 3/28/19 WSI REVIEW
4	04/08/19	PER TOWN/PEER REVIEW COMMENTS




SHEET TITLE
**SITE PLAN
INDEX SHEET**




DES BY: KNP DATE: NOVEMBER 21, 2018
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C2.0
PLAN NO. L-5691

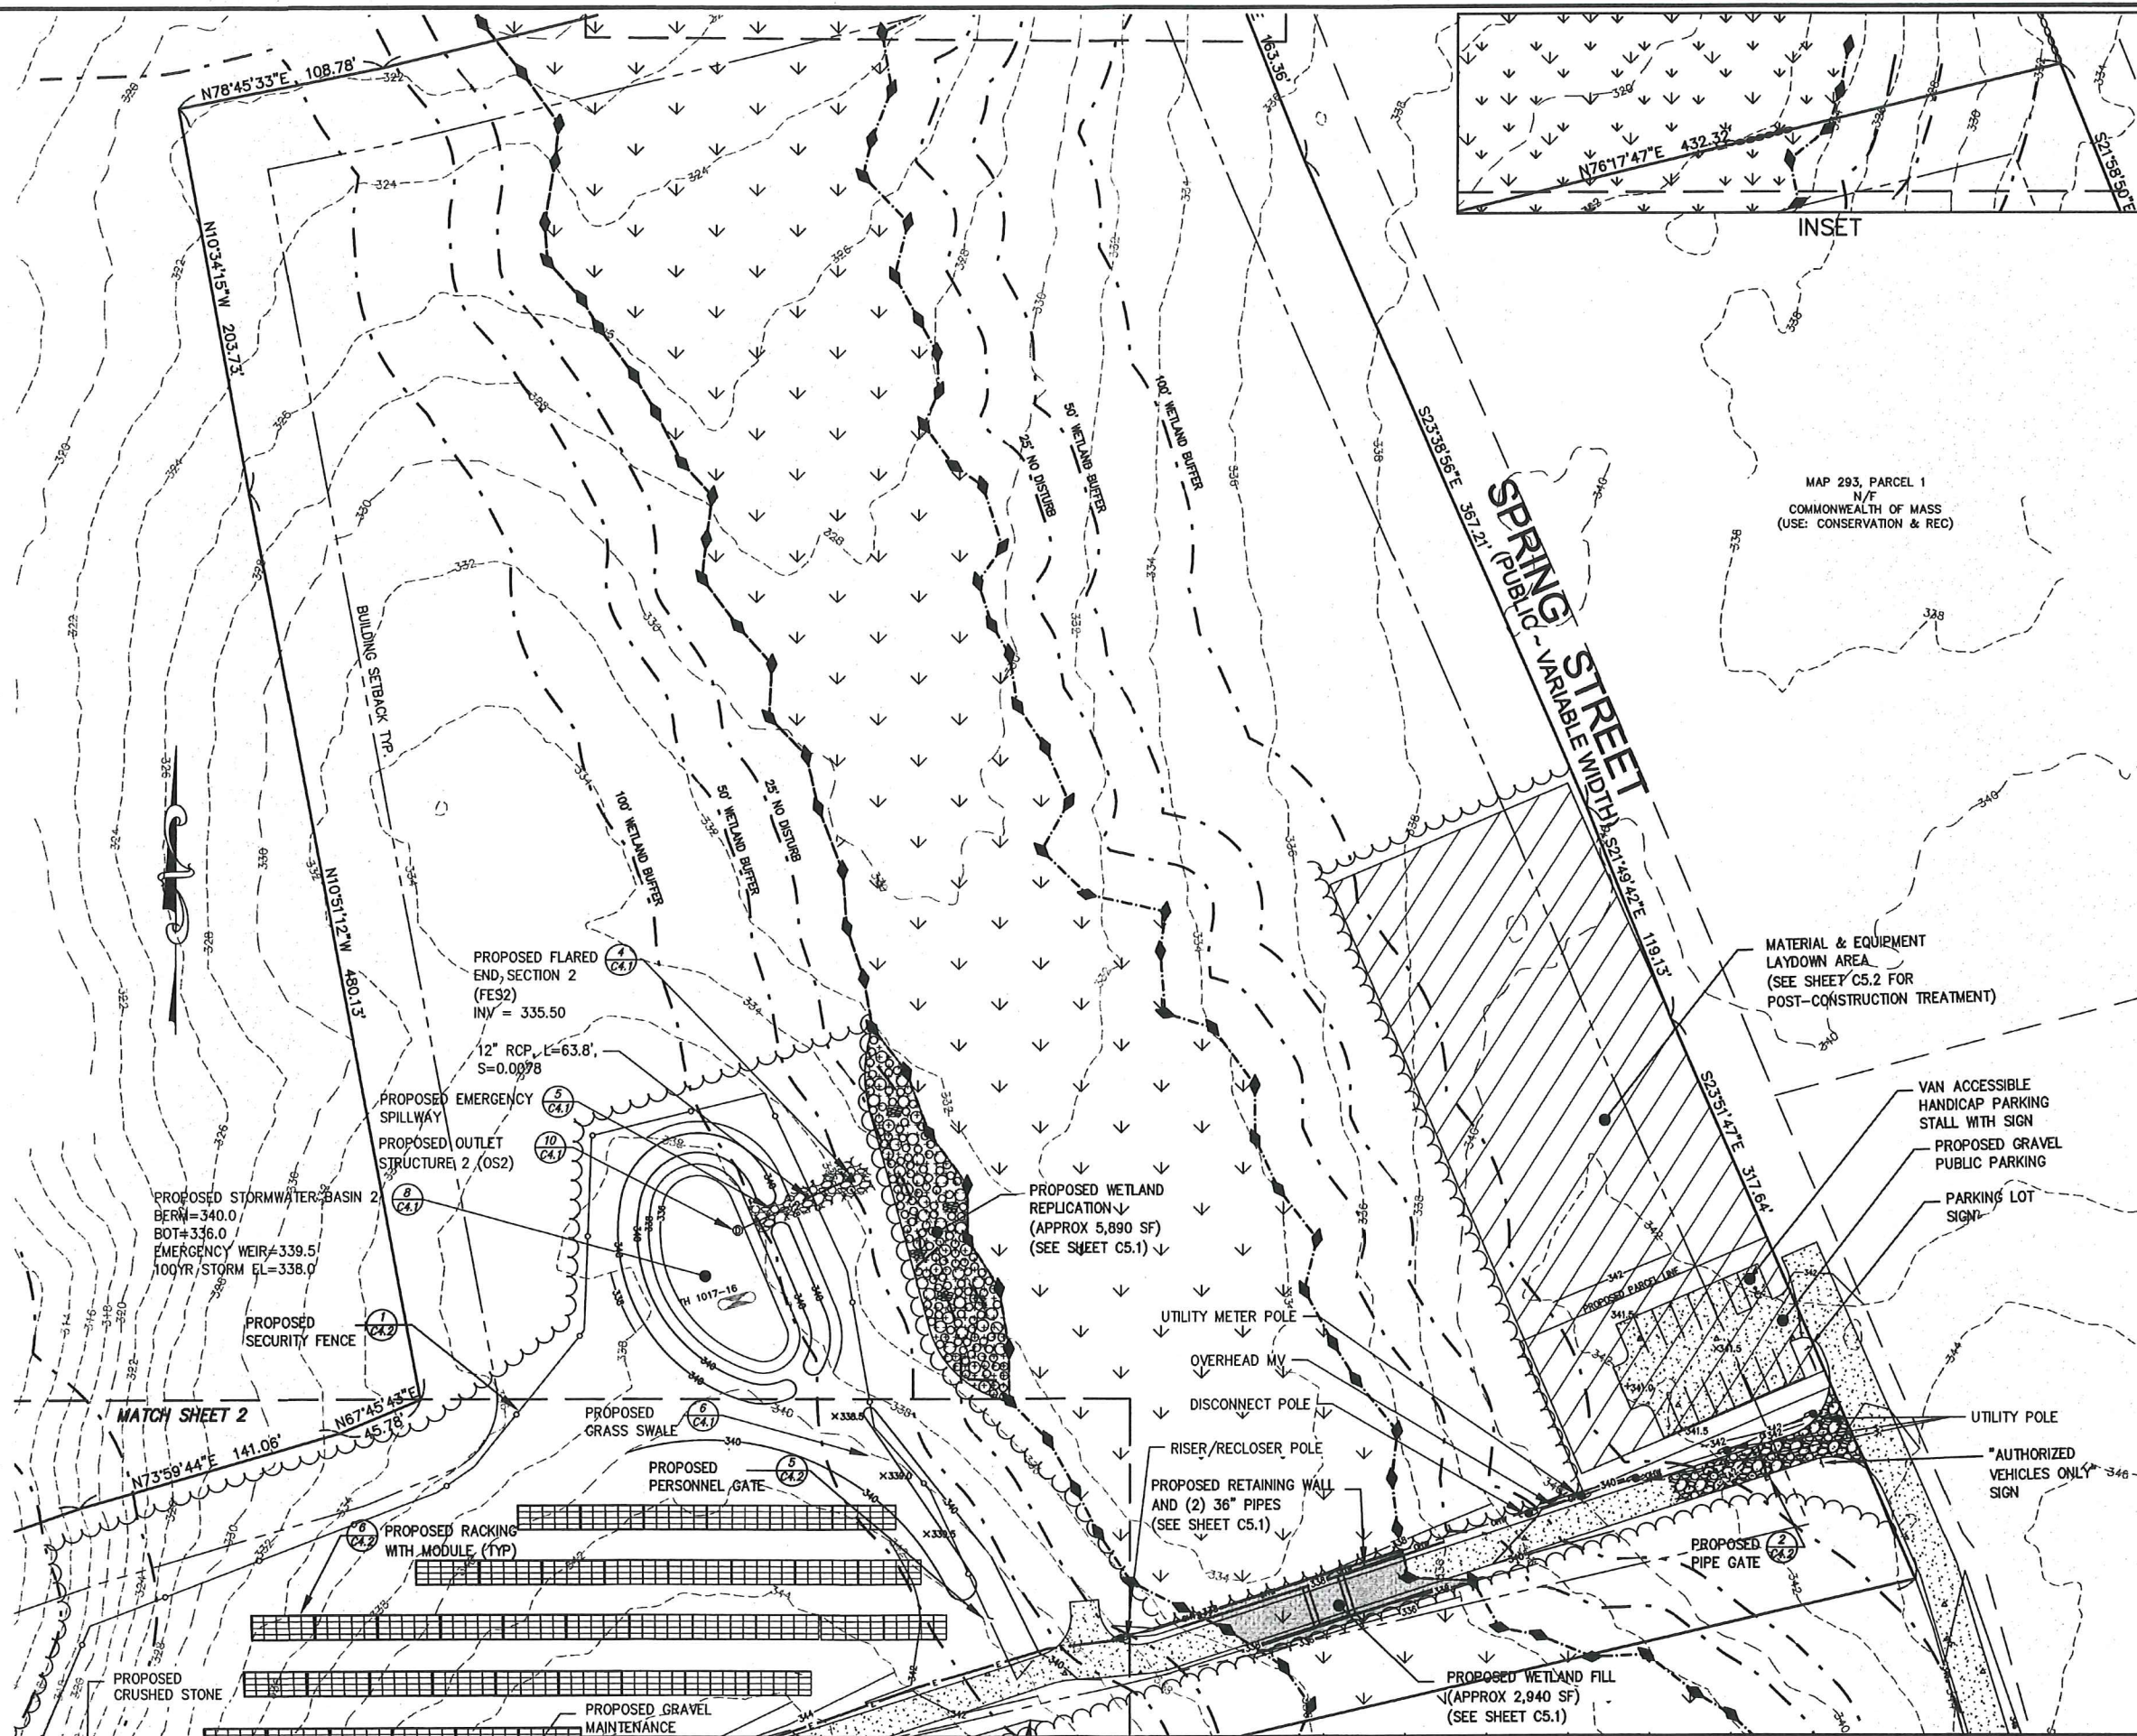

PLACED 2018 PROJECTS 2018-101 DIVE PERMIT 2018-101 25 JULY 04-08-19 7:08:43 PM - LAYOUT 2.2

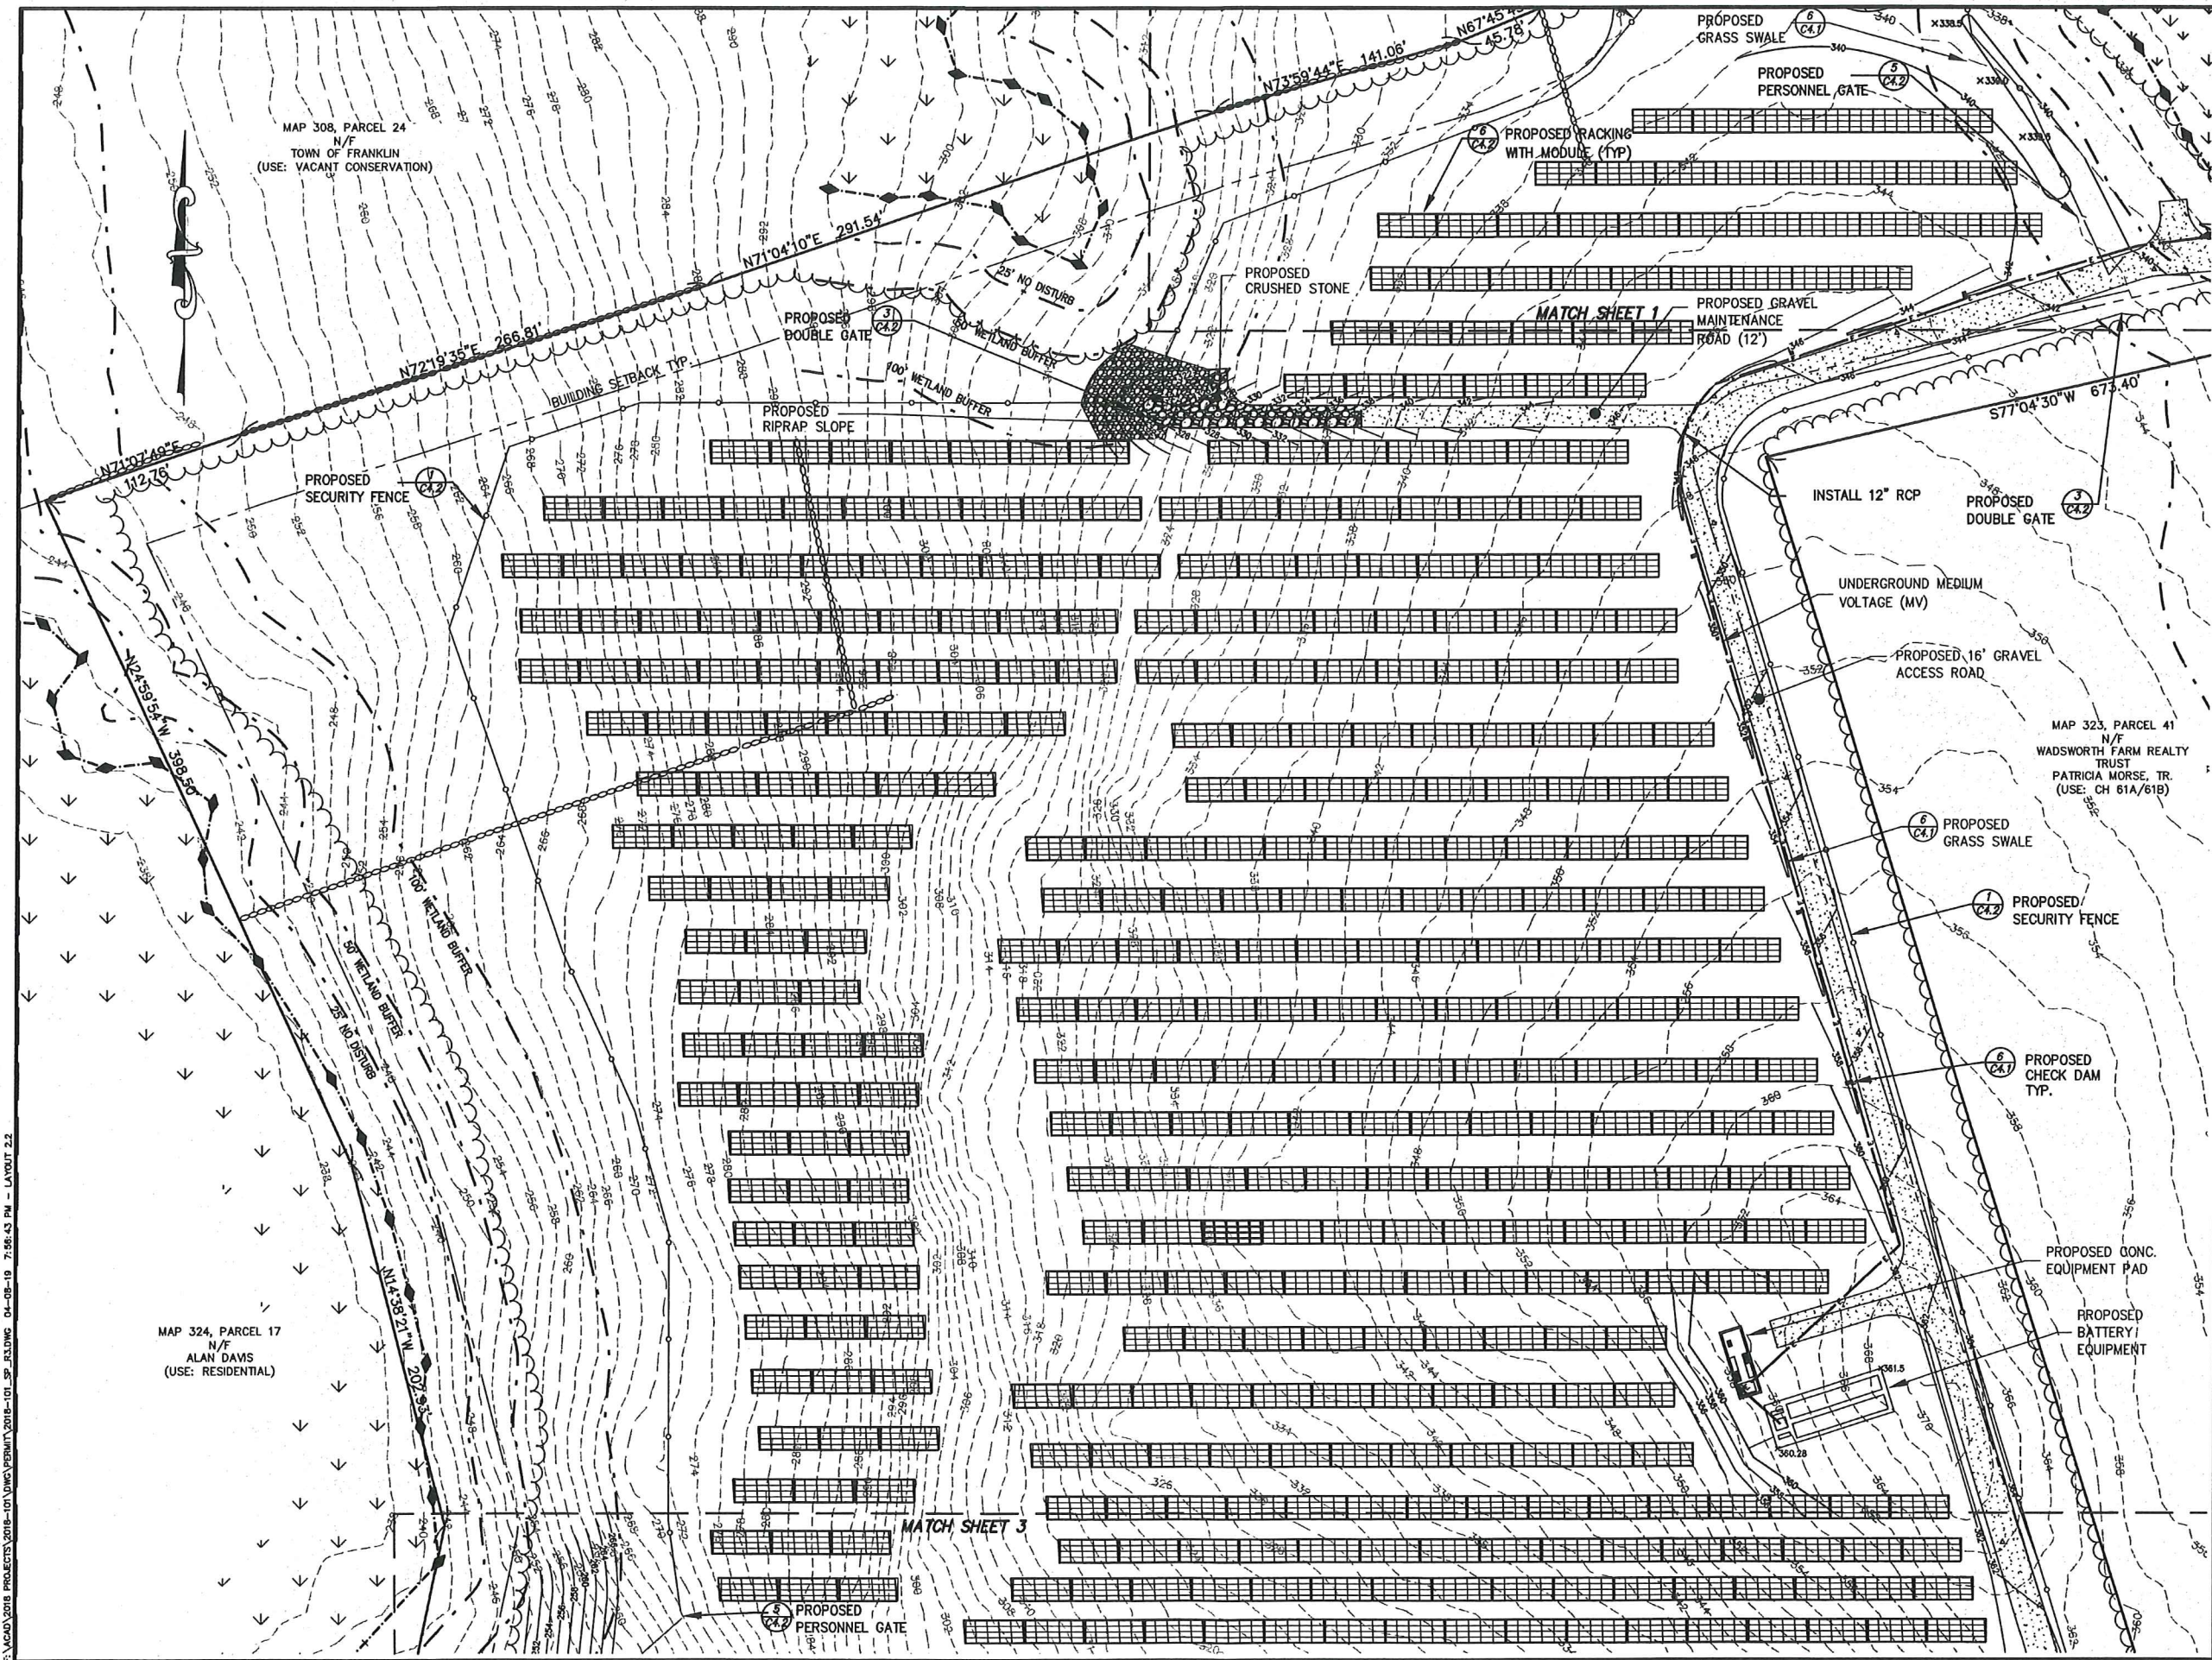

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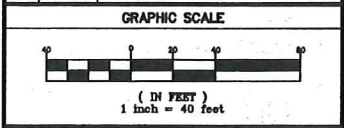
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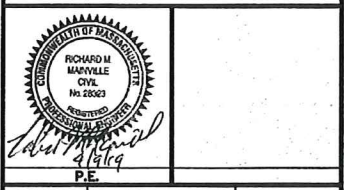
FRANKLIN TOWN CLERK DATE

PROJECT: LARGE-CAPACITY GROUND MOUNTED SOLAR ENERGY SYSTEM
SPRING STREET
FRANKLIN, MA
APPLICANT: SPRING ST. RENEWABLES, LLC
101 SUMMER STREET
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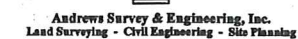


SHEET TITLE
SITE PLAN
SHEET 2 OF 3



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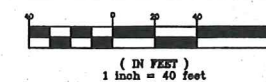
FRANKLIN TOWN CLERK DATE

**LARGE-CAPACITY GROUND
MOUNTED SOLAR ENERGY SYSTEM
SPRING STREET
FRANKLIN, MA**

SPRING ST. RENEWABLES, LLC
101 SUMMER STREET
BOSTON, MA 02110


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GRAPHIC SCALE



SHEET TITLE


SITE PLAN
SHEET 3 OF 3

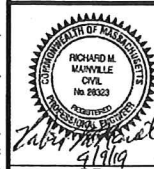

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8	C2.3
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PLAN NO. 1-56



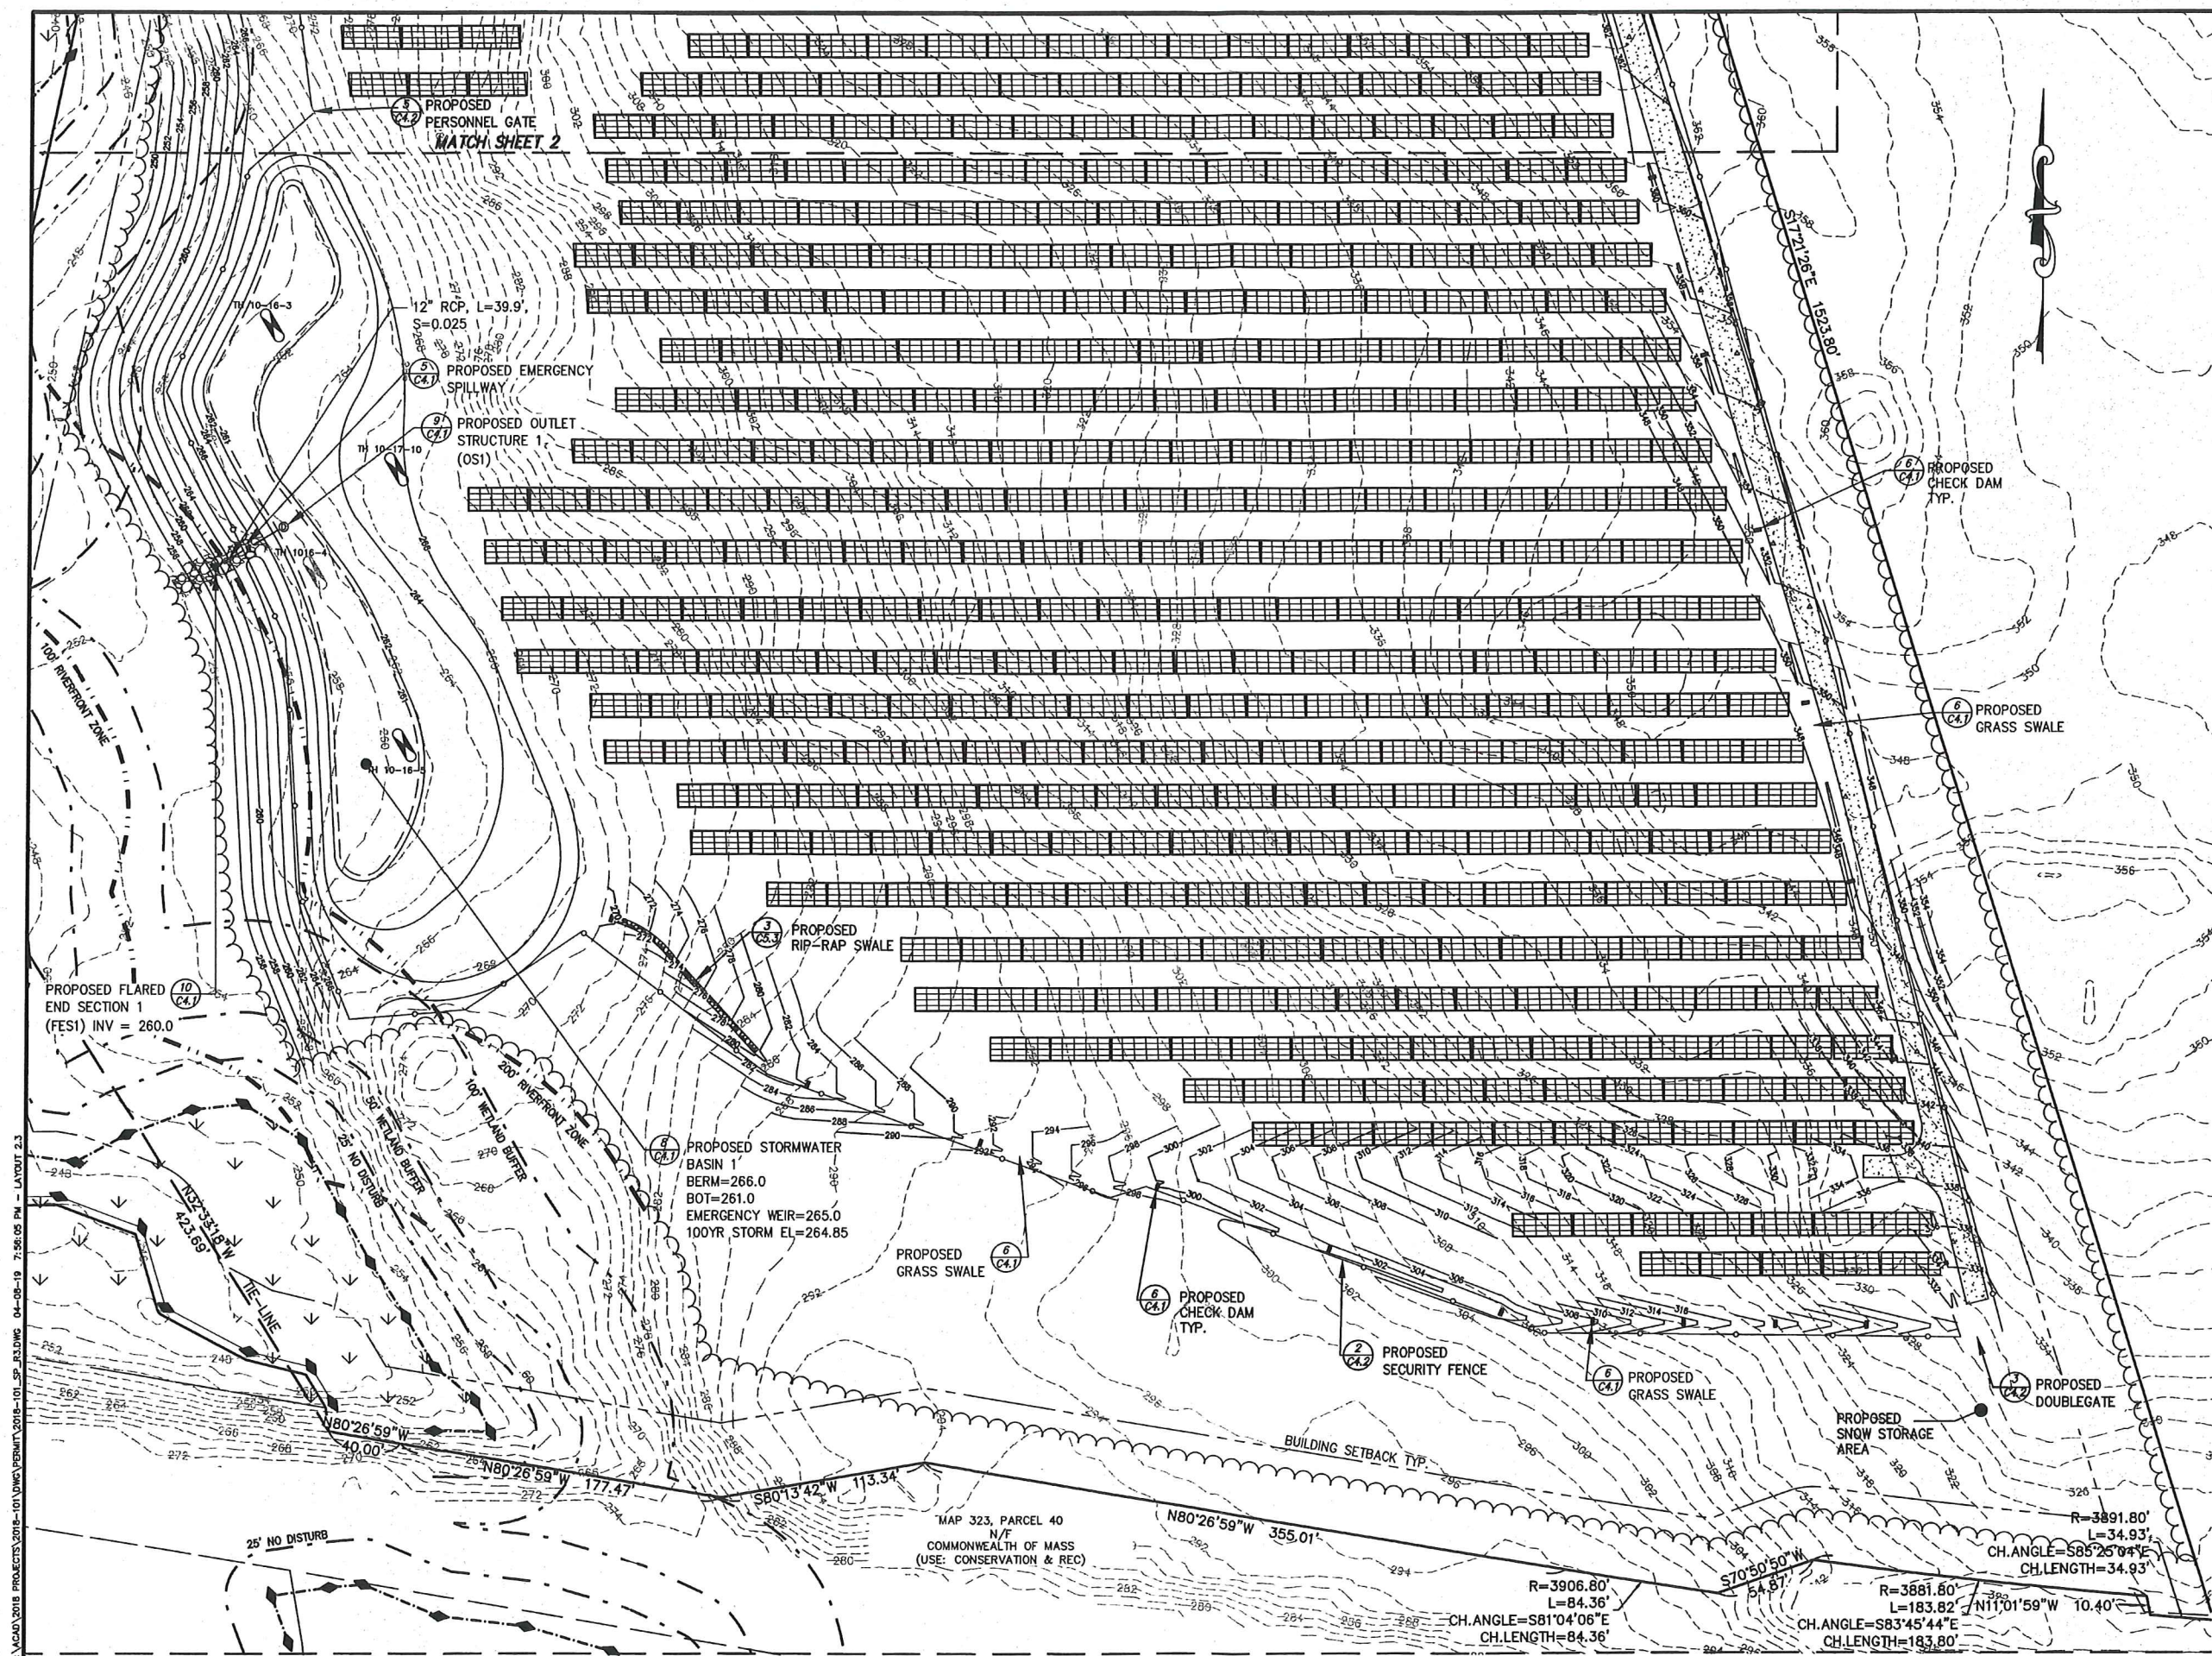

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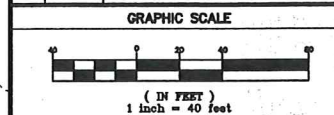
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LARGE-CAPACITY GROUND
MOUNTED SOLAR ENERGY SYSTEM
SPRING STREET
FRANKLIN, MA

APPLICANT:
SPRING ST. RENEWABLES, LLC
101 SUMMER STREET
BOSTON, MA 02110


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SHEET TITLE
**EROSION & SEDIMENT
CONTROL PLAN**
SHEET 1 OF 3

DES BY: NWP DATE: NOVEMBER 21, 2018
CHK BY: RWM PROJECT NO. 2018-101

C3.1
PLAN NO. L-5691



MAP 293, PARCEL 1
N/F
COMMONWEALTH OF MASS
(USE: CONSERVATION & REC)

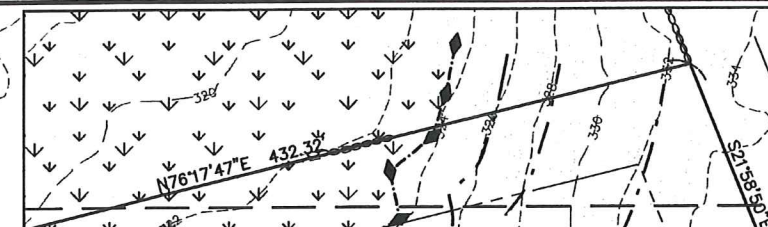SPRING STREET
(PUBLIC)
- VARIABLE WIDTH -

PROPOSED EROSION
CONTROL BARRIER
(LIMIT OF WORK)

PROPOSED WETLAND
REPLICATION
(APPROX 5,890 SF)
(SEE SHEET C5.1)

PROPOSED WETLAND FILL
(APPROX 2,940 SF)
(SEE SHEET C5.1)

- TEMPORARY SEDIMENTATION POND
1. TEMPORARY SEDIMENTATION PONDS SHALL BE CONSTRUCTED IMMEDIATELY AFTER TREE CLEARING AND GRUBBING AND PRIOR TO CONSTRUCTION OF THE PROPOSED GRAVEL DRIVE.
 2. CONSTRUCT PROPOSED DETENTION POND 12" ABOVE FINISHED GRADE.
 3. TEMPORARY SEDIMENTATION/CONTROLS SHALL REMAIN IN PLACE UNTIL THE PROJECT AREA HAS BEEN SEED AND STABILIZED.
 4. ONCE STABILIZED, ANY SEDIMENT ACCUMULATED IN THE PROPOSED DETENTION PONDS SHALL BE REMOVED AND CONSTRUCTED TO FINISH GRADE PER THE SITE PLAN AND DETAIL SHEETS.

MATCH SHEET 2

F:\ACAD\2018 PROJECTS\2018-101 UWS\PERMIT\2018-101_SP_R3.DWG 04-08-19 7:54:57 PM - LAYOUT 3.2



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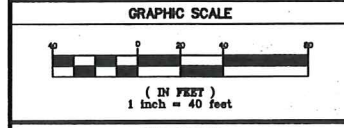
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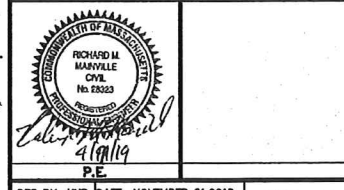
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MOUNTED SOLAR ENERGY SYSTEM
MOUNTED SOLAR ENERGY SYSTEM
SPRING STREET
FRANKLIN, MA

APPLICANT: SPRING ST. RENEWABLES, LLC
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BOSTON, MA 02110

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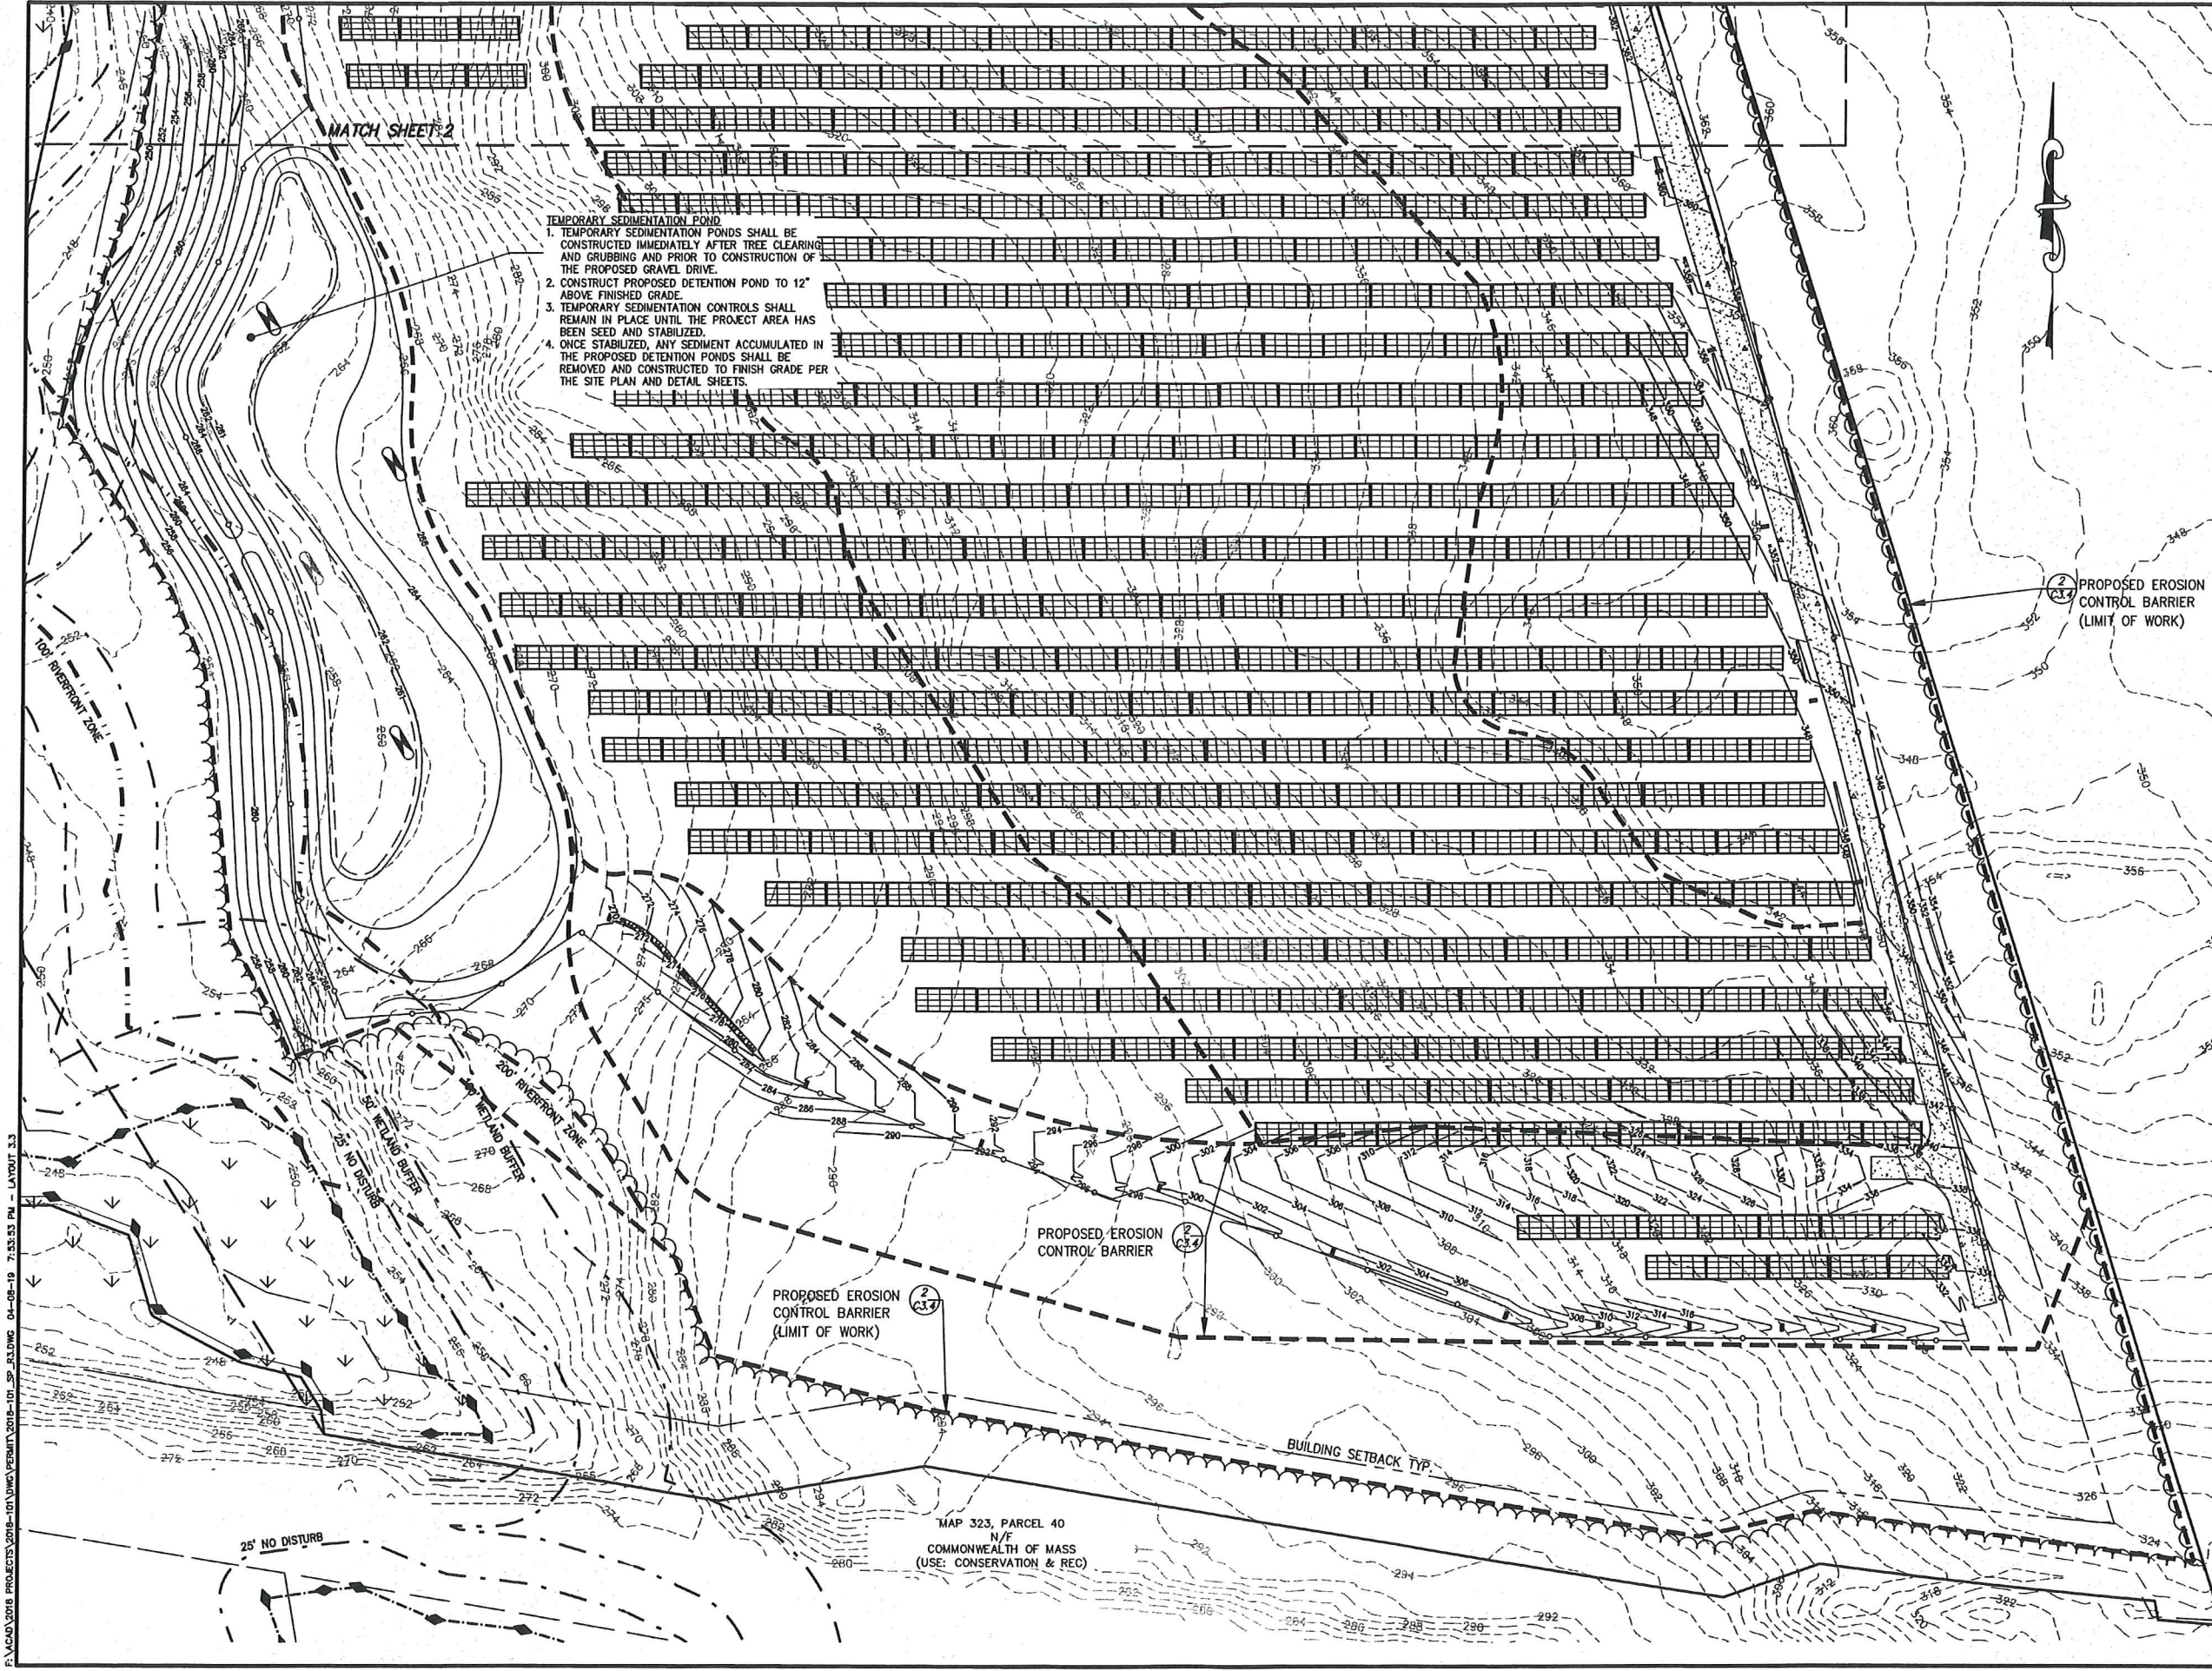
SHEET TITLE
**EROSION & SEDIMENT
CONTROL PLAN**
SHEET 2 OF 3



DES BY: KMP DATE: NOVEMBER 21, 2018
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C3.2
PLAN NO. L-5891

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- TEMPORARY SEDIMENTATION POND
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 2. CONSTRUCT PROPOSED DETENTION POND TO 12" ABOVE FINISHED GRADE.
 3. TEMPORARY SEDIMENTATION CONTROLS SHALL REMAIN IN PLACE UNTIL THE PROJECT AREA HAS BEEN SEED AND STABILIZED.
 4. ONCE STABILIZED, ANY SEDIMENT ACCUMULATED IN THE PROPOSED DETENTION PONDS SHALL BE REMOVED AND CONSTRUCTED TO FINISH GRADE PER THE SITE PLAN AND DETAIL SHEETS.



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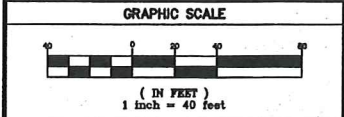
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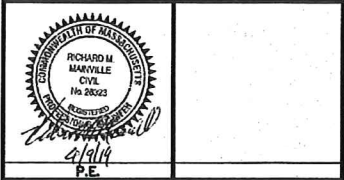
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PROJECT:	LARGE-CAPACITY GROUND MOUNTED SOLAR ENERGY SYSTEM SPRING STREET FRANKLIN, MA	APPLICANT:	SPRING ST. RENEWABLES, LLC 101 SUMMER STREET BOSTON, MA 02110

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**EROSION & SEDIMENT
CONTROL PLAN**
SHEET 3 OF 3



DES BY: KNP DATE: NOVEMBER 21, 2018
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C3.3
PLAN NO. L-5691

EROSION AND SEDIMENT CONTROL REQUIREMENTS

PART 1 - GENERAL

1.01 SUMMARY

A. FURNISH, INSTALL, AND MAINTAIN TEMPORARY AND PERMANENT EROSION AND SEDIMENT CONTROL MEASURES, SUCH AS, BUT NOT NECESSARILY LIMITED TO, STRAW BALE AND Silt FENCE BARRIERS, RIPRAP, VEHICLE TRACKING PADS, DIVERSION CHANNELS AND BERM, CHECK DAMS, STRATEGICALLY LOCATED STOCKPILES, SEDIMENT BASINS, MULCH, AND SEED MIX (HEREINAFTER "CONTROL MEASURES") ADEQUATE TO PREVENT THE CONVEYANCE OF EROSION PRODUCTS (E.G. SOIL, MULCH, SOD) OFF SITE, OR INTO ENVIRONMENTALLY SENSITIVE AREAS, OR INTO AREAS WHERE WORK WILL BE ADVERSELY IMPACTED. ENVIRONMENTALLY SENSITIVE AREAS INCLUDE, BUT ARE NOT NECESSARILY LIMITED TO, WETLANDS, TRIBUTARIES TO WETLANDS, WETLAND BUFFER ZONES, INTERMITTENT AND PERENNIAL STREAMS / RIVERS, AND THEIR ATTENDANT BUFFER ZONES.

ALL METHODS AND MATERIALS USED FOR EROSION CONTROL SHALL CONFORM TO THE REQUIREMENTS SET FORTH IN "EROSION AND SEDIMENT CONTROL GUIDELINES FOR URBAN AND SUBURBAN AREAS A GUIDE FOR PLANNERS, DESIGNERS, AND MUNICIPAL OFFICIALS" AS PUBLISHED BY THE MASSACHUSETTS DEPARTMENT OF ENVIRONMENTAL PROTECTION, BUREAU OF RESOURCE PROTECTION, UNLESS OTHERWISE APPROVED IN WRITING.

1. REFER TO DRAWINGS FOR LOCATION AND DETAILS OF LIMITS OF DISTURBANCE AND CONTROL MEASURES REQUIRED TO COME TO WORK. LIMITS OF DISTURBANCE SHALL BE MARKED WITH TAPE, SIGNS, OR ORANGE CONSTRUCTION FENCE PRIOR TO COMMENCING ANY LAND DISTURBANCE ACTIVITIES. CONTROL MEASURES WILL BE ADEQUATE ONLY FOR VEGETATION CLEARING. THE DRAWINGS ARE NOT INTENDED TO GRAPHICALLY DEPICT ALL CONTROL MEASURES THAT WILL BE REQUIRED TO MEET THE REQUIREMENTS DESCRIBED IN 1.01.A.

2. DEVISE AND EMPLOY CONTROL MEASURES THROUGHOUT THE DURATION OF PROJECT, OVER ALL AREAS DISTURBED OR UNDISTURBED BY CONSTRUCTION, AS NECESSARY TO MEET THE REQUIREMENTS DESCRIBED IN 1.01.A.

3. DEVISE AND EMPLOY TEMPORARY CONTROL MEASURES AS NECESSARY TO MEET THE REQUIREMENTS DESCRIBED IN 1.01.A, WHILE ALLOWING WORK TO PROCEED IN AN EFFICIENT, COST EFFECTIVE MANNER.

4. DEVISE, EMPLOY AND MAINTAIN CONTROL MEASURES UNTIL SUCH TIME AS THE ENTIRE SITE IS PERMANENTLY STABILIZED BY ESTABLISHED VEGETATION, FINISH LANDSCAPE MATERIALS, PAVED SURFACES, AND/OR ROOF AREA.

5. ONCE THE SITE IS PERMANENTLY STABILIZED AND CERTIFIED AS SUCH BY ENGINEER, REMOVE TEMPORARY CONTROL MEASURES WHILE PROTECTING STABILIZED SURFACES.

1.02 SUBMITTALS

A. SUBMIT PRODUCT DATA, WARRANTY, AND TEST REPORTS AS INDICATED ON THE DRAWINGS.

B. SUBMIT SKETCH SHOWING LOCATIONS OF PROPOSED STOCKPILE AREAS, CONSTRUCTION ENTRANCES AND EROSION CONTROLS IF NOT SHOWN ON THE SITE PLAN OR DIFFERENT FROM THOSE LOCATIONS SHOWN ON THE SITE PLAN.

C. A SITE SPECIFIC SEQUENCE OF CONSTRUCTION FOR EACH PORTION OF THE SITE. NO PORTION OF THE SITE SHALL EXCEED FIVE (5) ACRES.

1.03 QUALITY ASSURANCE

A. COMPLY WITH GOVERNING CODES AND REGULATIONS. PROVIDE PRODUCTS FROM ACCEPTABLE MANUFACTURERS. USE EXPERIENCED INSTALLERS. DELIVER, HANDLE, AND STORE MATERIALS IN ACCORDANCE WITH MANUFACTURERS' INSTRUCTIONS.

B. CONFORM TO CONDITIONS OF APPROVAL ISSUED BY REGULATORY AGENCIES INCLUDING, BUT NOT NECESSARILY LIMITED TO, LOCAL PLANNING BOARD, CONSERVATION COMMISSION, CITY COUNCIL, BOARD OF HEALTH, PUBLIC WORKS / HIGHWAY DEPARTMENT, STATE ENVIRONMENTAL PROTECTION DEPARTMENT, AND U.S. GOVERNMENT, ENVIRONMENTAL PROTECTION AGENCY, WHERE CONDITIONS OF REGULATORY APPROVAL DIFFER FROM REQUIREMENTS CONTAINED HEREIN OR ON THE DRAWINGS, COMPLY WITH THE MORE STRINGENT REQUIREMENT.

PART 2 - PRODUCTS

2.01 MATERIALS

A. DOUBLE ROW 12" COMPOST BIODEGRADABLE FILTERMATT: EACH FILTERMATT ROW SHALL BE STAKED WITH A MINIMUM OF 1"x1"x36" LONG HARDWOOD STAKES, PLACED AT 4' O.C. (SEE DETAIL).

B. MULCH: ORGANICS INCLUDING STRAW, PROCESSED PINE / HICKORY THINGS AND NEEDLES.

C. SEED MIXES: SHALL MEET THE REQUIREMENTS OF MASSACHUSETTS HIGHWAY DEPARTMENT STANDARD SPECIFICATIONS FOR HIGHWAYS AND BRIDGES, LATEST EDITION SECTION 6.03.0 OR 6.03.1 AS APPROPRIATE.

D. EXCLOSOR BLANKET: CURLED WOOD FIBER OR PHOTODEGRADABLE EXTRUDED PLASTIC MATRIX, 60% OF FIBERS 6-8 INCHES LONG OR LONGER, WEIGHT 0.975 POUNDS / SQ. YD., CONTAINING NO CHEMICAL ADDITIVES. USE CURLEX I BLANKET BY AMERICAN EXCLOSOR COMPANY, OR APPROVED EQUAL.

E. ROCK RIPRAP: SOUND, ANGULAR, 6-INCH MINUS PROCESSED ROCK, BLAST ROCK, OR TAILINGS.

F. CRUSHED STONE: SOUND, ANGULAR, 2-INCH MINUS PROCESSED CRUSHED STONE.

PART 3 - EXECUTION

3.01 THROUGHOUT CONSTRUCTION

A. DEVISE WORK SEQUENCE SO AS TO LIMIT DRAINAGE AREA THAT IS TRIBUTARY TO DISTURBED AREAS. DEVISE, EMPLOY, AND MAINTAIN CONTROL MEASURES SUCH AS DIVERSION CHANNELS AND BERM, STRATEGICALLY LOCATED STOCKPILES, AND SEDIMENT BASINS TO SUBDIVIDE DRAINAGE AREAS INTO SMALL, MANAGEABLE SUBAREAS, THEREBY MINIMIZING RUNOFF AND THE POTENTIAL FOR EROSION.

B. MAINTAIN BARRIER AT LIMIT OF WORK AND PROTECT EXISTING VEGETATION / FACILITIES OUTSIDE OF LIMIT OF WORK.

C. MAINTAIN SPARE MATERIAL STOCKPILES FOR IMMEDIATE EMPLOYMENT / REPAIR / EXPANSION OF CONTROL MEASURES. AT A MINIMUM, SUCH MATERIALS SHALL INCLUDE HAY BALES, Silt FENCE AND STAKES, AND CRUSHED STONE.

D. INSPECT AND MAINTAIN EFFECTIVENESS OF CONTROL MEASURES BY REPAIRING AS NECESSARY TO ENSURE INTENDED FUNCTION; BY SUPPLEMENTING AS NECESSARY FOR ADEQUATE EXTENT; BY REMOVING TRAPPED PRODUCTS OF EROSION AS NECESSARY TO MAINTAIN EFFECTIVE TRAP VOLUME.

E. LIMIT EXTENT OF WORK AREA SO THAT ALL DISTURBED AREAS CAN BE STABILIZED WITH CONTROL MEASURES WITHIN A 24-HOUR PERIOD.

F. INSTALL CONTROL MEASURES AS SOON AS PRACTICABLE AFTER EACH MANAGEABLE PORTION OF EARTHWORK IS COMPLETE. EMPLOY TEMPORARY MEASURES AS NECESSARY TO STABILIZE DISTURBED AREAS, EVEN WHERE SUBSEQUENT CONSTRUCTION OPERATIONS MAY REQUIRE RE-DISTURBANCE.

PART 3 - CONTINUED

G. WHEN INTENSE RAINFALL IS EXPECTED, CONSIDER, DEVISE, AND EMPLOY REINFORCING CONTROL MEASURES PRIOR TO THE RAINFALL EVENT TO MEET THE REQUIREMENTS DESCRIBED IN 1.01.A. IF NECESSARY, EMPLOY TEMPORARY CONTROL MEASURES ON MATERIAL STOCKPILES TO COUNTERACT POTENTIAL SEDIMENT TRANSPORT DURING INTENSE RAINFALL.

H. WHEN VEHICLE REFUELING IS REQUIRED ON SITE, CONDUCT REFUELING OPERATIONS OUTSIDE OF ENVIRONMENTALLY SENSITIVE AREAS.

I. PROPERLY DISPOSE OF DEBRIS, SOLID WASTE, TRASH, AND CONSTRUCTION WASTE / BYPRODUCTS OFF SITE.

J. SWEEP ON-SITE PAVED AREAS AND OFF-SITE STREETS AS NECESSARY TO PREVENT Silt AND DEBRIS ORIGINATING ON SITE FROM ENTERING CLOSED DRAINAGE SYSTEMS AND / OR ENVIRONMENTALLY SENSITIVE AREAS. WHEN NECESSARY UTILIZE WATER SPRAYING, SURFACE ROUGHENING AND/OR APPLY POLYMERS, SPRAY-ON TACKIFIERS, CHLORIDES OR BARRIERS FOR DUST CONTROL.

K. INSPECT EROSION CONTROLS DAILY THROUGHOUT CONSTRUCTION REPAIR DAMAGED CONTROLS IMMEDIATELY.

3.02 SITE PREPARATION AND ACCESS

A. WALK SITE AND IDENTIFY LOCATIONS OF LIMIT OF WORK AND ENVIRONMENTALLY SENSITIVE AREAS. ESTABLISH CONSTRUCTION STAGING AREA, LOCATED BEYOND ENVIRONMENTALLY SENSITIVE AREAS.

B. INSTALL CONTROL MEASURES AS SHOWN ON THE DRAWINGS, INCLUDING THOSE DEFINING THE LIMIT OF WORK.

C. LIMIT VEHICULAR TRAFFIC TO AND FROM SITE TO MINIMIZE TRANSPORT OF SEDIMENT.

3.03 CLEARING, GRUBBING, AND STRIPPING

A. SCHEDULE GRUBBING AND STRIPPING TO OCCUR IMMEDIATELY PRIOR TO EARTH DISTURBANCE. DEPENDING ON SITE AREA, CONSIDER MULTIPLE GRUBBING PHASES, SEQUENCED TO TAKE ADVANTAGE OF THE EROSION PREVENTION POTENTIAL OF EXISTING VEGETATIVE COVER.

B. MINIMIZE THE AREA OF EXISTING VEGETATION REMOVED WHEREVER POSSIBLE. NO GREATER THAN FIVE (5) ACRES SHALL BE UNSTABLE AT ANY TIME.

C. LOCATE AND SIZE STOCKPILES TO MINIMIZE EROSION POTENTIAL, TAKING ADVANTAGE OF TERRAIN SLOPE AND ASPECT, WHERE APPROPRIATE.

D. PROTECT VEGETATION, INCLUDING ROOT SYSTEMS, BEYOND LIMIT OF CLEARING.

E. PROCESS TIMBER, STUMPS, SLASH, AND BRUSH SO AS TO PROTECT ENVIRONMENTALLY SENSITIVE AREAS AND INSTALLED CONTROL MEASURES. PROPERLY DISPOSE OF EXCESS OFF SITE. BURIAL OF STUMPS ON SITE IS PROHIBITED.

3.04 EXCAVATION FOR BUILDING FOUNDATIONS AND UTILITIES

A. DEVISE AND INSTALL CONTROL MEASURES ADEQUATE TO HANDLE DISCHARGES AND TRAP SEDIMENT FROM FOOTING SUMP AND WELL POINT PUMPS PRIOR TO EXCAVATION.

B. ARMOR SUMP PUMP DISCHARGE LOCATIONS TO PREVENT EROSION AT POINT OF DISCHARGE AND AREAS DOWNSTREAM.

C. IF FOUNDATION EXCAVATIONS GRADE TO DAYLIGHT ON THE LOW SIDE, DEVISE AND INSTALL CONTROL MEASURES TO HANDLE SURFACE AND GROUNDWATER FLOW FROM EXCAVATION LOW POINT.

D. STOCKPILE EXCAVATED MATERIALS TO BAFFLE OVERLAND RUNOFF, AVOIDING THE CREATION OF LENGTHY PATHS OF CONCENTRATED RUNOFF. STOCKPILE SLOPES SHALL NOT EXCEED 2:1.

E. BACKFILL UTILITY TRENCHES AS SOON AS PRACTICABLE TO PREVENT FLOODING, SLOUGHING, POTENTIAL OVERFLOW, AND REPETITIVE EARTH DISTURBANCE.

3.05 SITE GRADING

A. WHERE APPLICABLE, FOLLOW EXCAVATION AND FILL PRACTICES SHOWN ON DRAWINGS TO LOCALIZE AND MINIMIZE EROSION.

B. MONITOR SEDIMENT VOLUME IN TEMPORARY SEDIMENT BASINS AND AT DIVERSION BERMS AND CHECK DAMS. IN ALL AREAS EXCEPT THOSE THAT DO NOT PRESENT POTENTIAL PROBLEMS WITH REGARD TO FUTURE SOIL STABILITY, DRAINAGE, OR BEARING CAPACITY, REMOVE AND PROPERLY DISPOSE OF TRAPPED SEDIMENT BEFORE BRINGING SITE TO FINAL SUBGRADE.

C. EXPOSED SOILS SHALL BE PERMANENTLY STABILIZED WITHIN FIVE (5) BUSINESS DAYS OF COMPLETION OF CONSTRUCTION OF A GIVEN AREA. EXPOSED AREAS WHERE NO WORK HAS OCCURRED FOR FOURTEEN (14) DAYS SHALL BE TEMPORARILY STABILIZED WITH HYDROSEED OR OTHER APPROVED METHOD.

D. SLOPES STEEPER THAN 3:1 SHALL BE STABILIZED IMMEDIATELY AFTER COMPLETION.

3.06 LANDSCAPING

A. COMPLETE LANDSCAPING AS SOON AS POSSIBLE AFTER COMPLETION OF FINAL SUBGRADE.

B. IMMEDIATELY AFTER PLACEMENT OF TOPSOIL, STABILIZE WITH CONTROL MEASURES INCLUDING, BUT NOT NECESSARILY LIMITED TO, SEED MIX, MULCH, AND / OR BLANKET.

C. PERMANENT SEEDING MAY BE PERFORMED IN THE SPRING PRIOR TO JULY 1 AND IN BETWEEN AUGUST 1 AND OCTOBER 15. PERMANENT SEEDING AT OTHER TIMES SHALL BE APPROVED AND SHALL ONLY BE ALLOWED WITH AN APPROVED MULCHING AND IRRIGATION PROGRAM.

GENERAL SEQUENCE OF CONSTRUCTION

THE INTENDED CONCEPTUAL SEQUENCE OF CONSTRUCTION ACTIVITIES FOR SPRING STREET RENEWABLES, LLC ARE AS FOLLOWS. IT IS ANTICIPATED THAT A SUMMER OF 2019 START TO THIS SEQUENCE WOULD REQUIRE SIX MONTHS TO COMPLETE:

A. CONTACT DIG SAFE (800-344-7233) AND OBTAIN CLEARANCE AT LEAST 72 HOURS BEFORE INITIATING ANY EXCAVATION.

B. NOTIFY THE FRANKLIN CONSERVATION COMMISSION/ AGENT A MINIMUM OF 72 HOURS PRIOR TO THE START OF ANY CONSTRUCTION ACTIVITIES.

C. STAKE SILTATION FENCE AND/OR HAYBALE LINES THAT SHALL ALSO SERVE AS THE LIMIT OF ACTIVITY FOR WORK. AREAS, ALSO, INSTALL THE EROSION AND SEDIMENTATION CONTROL MEASURES AROUND PROPOSED AREAS OF DISTURBANCE AND MAINTAIN THROUGHOUT CONSTRUCTION IN ACCORDANCE WITH THE ORDER OF CONDITIONS.

D. COORDINATE ON-SITE PRE-CONSTRUCTION MEETING WITH THE SITE CONTRACTOR, THE APPLICANT, THE APPLICANT'S ENGINEER, THE FRANKLIN CONSERVATION COMMISSION AGENT, AND ANY OTHER INTERESTED CITY OFFICIALS TO REVIEW THE SEDIMENTATION AND EROSION CONTROL MEASURES PRIOR TO ANY TREE CLEARING IN THE MODULE AREA.

E. PRIOR TO CONSTRUCTION, THE CONTRACTOR SHALL CONSTRUCT A TEMPORARY GRAVEL CONSTRUCTION ENTRANCE/EXIT PAD AT THE END OF THE EXISTING GRAVEL DRIVE AT SPRING STREET PRIOR TO CLEARING AND GRUBBING FOR SPRING STREET EXTENSION. IN ADDITION, INSTALL THE APPROVED WETLAND CROSSING PER THE ORDER OF CONDITIONS PRIOR TO ACCESS INTO THE SITE WITH ANY CONSTRUCTION EQUIPMENT.

F. LIMITED SITE PREPARATION IN THE AREAS OF THE PROPOSED SPRING STREET EXTENSION IMPROVEMENTS, THE GRAVEL ACCESS DRIVE WITHIN THE SITE AND UP TO THE PROPOSED SOLAR ARRAY AND THE DETENTION BASINS SHALL INCLUDE CLEARING, GRUBBING AND REMOVAL OF EXISTING TREES, VEGETATION, AND DEBRIS.

G. LIMITED ROUGH GRADING AND STABILIZATION IN AREAS WHERE CONSTRUCTION ACCESS IS RESTRICTED DUE TO EXISTING CONDITIONS.

H. CLEAR AND ESTABLISH LAYDOWN AREAS FOR CONSTRUCTION.

I. CONSTRUCT ALL SWALES, TEMPORARY DETENTION BASINS, AND DRAINAGE SYSTEMS AS SHOWN ON THE APPROVED PLANS.

J. ON THE EXTERIOR FACE OF THE DETENTION BASINS, FOR AREAS OF SLOPE WITHOUT SWALE, VEGETATION SHALL CONSIST OF 3:1 MAX SLOPE TO BE SEED. IN THE EVENT THAT THE SEEDING FALLS OUTSIDE OF THE RECOMMENDED SEEDING DATES, THE EXTERIOR SLOPES OF THE PONDS SHALL BE STABILIZED.

K. SITE PREPARATION SHALL INCLUDE CLEARING, GRUBBING AND REMOVAL OF EXISTING VEGETATION AND DEBRIS. ALL TREES, STUMPS, BRUSH, SHRUBS, ROOTS, GRASS, WEEDS, RUBBISH, AND OTHER OBJECTIONABLE MATERIAL SHALL BE REMOVED AND DISPOSED OF FROM THE PROJECT AREA (GRUBBING OF STUMPS SHALL NOT OCCUR IN THE NO-GRUB STUMP ZONES SHOWN ON THE PLANS). AREAS OUTSIDE OF THE LIMITS OF WORK SHALL BE PROTECTED FROM DAMAGE AND NO EQUIPMENT OR MATERIALS SHALL BE STORED IN THESE AREAS. NO STUMPS, TREES, LIMBS, OR BRUSH SHALL BE BURIED IN ANY FILLS OR EMBANKMENTS.

L. UPON SIGNS OF CONCENTRATED FLOW BY EVIDENCE OF GULLYING OR RILLING IN DISTURBED AREAS, HAYBALES OR STONE CHECK DAMS SHALL BE PLACED IN THESE AREAS.

M. CONSTRUCT GRAVEL ACCESS ROAD FROM THE END OF THE EXISTING GRAVEL SPRING STREET ROAD UP TO THE PERIMETER OF THE PROPOSED SOLAR ARRAY, AS SHOWN ON THE PLANS.

N. ESTABLISH A TEMPORARY CONSTRUCTION SUPPORT AREA AND MATERIAL STAGING AREA PRIOR TO THE DELIVERY OF MODULAR UNITS.

O. RECEIVE AND STAGE MATERIALS. RELOCATE COMPONENTS (E.G., CONDUIT, WIRING AND FRAME) TO SOLAR DEVELOPMENT AREA AS THEY ARE REQUIRED.

P. INSTALL PHOTOVOLTAIC (PV) FRAMING POSTS (TYPICALLY SIZES), MODULE RACKING, TRENCHING, AND INSTALLING UNDERGROUND CONDUIT AND CABLE.

Q. MOUNT THE PV PANELS ON FRAME AT THE SPECIFIED ORIENTATION AND EXPOSURE AND ADJUST AS NECESSARY.

R. ALL DISTURBED AREAS WITHIN THE SOLAR ARRAY AREA SHALL BE RE-ESTABLISHED WITH TOPSOIL AND LOAM WITH MEADOW OR POLLINATOR SEED MIX, AS SHOWN ON THE PLANS. IN THE EVENT THAT THE SEEDING FALLS OUTSIDE OF THE RECOMMENDED SEEDING DATES, DISTURBED AREAS SHALL BE RE-ESTABLISHED USING ALTERNATIVE METHODS AS APPROVED BY THE PROJECT SITE ENGINEER.

S. RUN ABOVE GROUND ELECTRICAL CONDUIT TO PV FRAMES AND INSTALL PANEL WIRING.

T. CONSTRUCT CONCRETE PADS FOR INVERTERS, TRANSFORMERS, ETC. INSTALL AND CONNECT GROUND MOUNTED INVERTERS. A DISCONNECT LOCATION WILL BE ON THE OUTSIDE OF THE NARROWEST SIDE OF THE PLATFORM.


U. CONSTRUCT ALL 7-FOOT-HIGH CHAIN LINK FENCE AND GATES, AS SHOWN ON THE PLANS.

V. INSTALL UTILITY OVERHEAD POLES (SHOWN ON PLANS) AT INTERCONNECTION POINT. INSTALL OVERHEAD WIRING.

W. CONFIRM ESTABLISHMENT OF ALL VEGETATIVE COVER AND PROPOSED TREE PLANTINGS AS SHOWN ON THE APPROVED PLANS.


X. OBTAIN CERTIFICATE OF COMPLIANCE FROM THE FRANKLIN CONSERVATION COMMISSION. AN INTERIM APPROVAL MAY BE ISSUED UNTIL VEGETATIVE COVER HAS SURVIVED A FULL GROWING SEASON TO ENSURE LONG-TERM VIABILITY.

Y. REMOVE AND PROPERLY DISPOSE OF THE PERIMETER EROSION AND SEDIMENTATION CONTROLS.

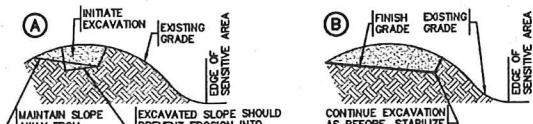


1 EXCAVATION PROCEDURE

SCALE: N.T.S.

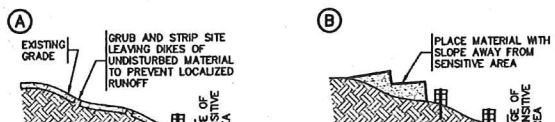

3 FILL PROCEDURE



SCALE: N.T.S.

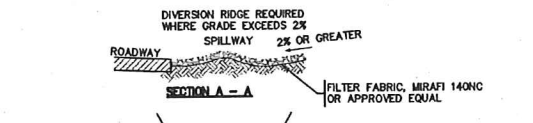

NOTES:
[1] THE ENTRANCE SHALL BE MAINTAINED IN A CONDITION THAT WILL PREVENT TRACKING OR FLOWING OF SEDIMENT ONTO PUBLIC RIGHT-OF-WAYS. THIS MAY REQUIRE TOP DRESSING, REPAIR AND/OR CLEANOUT OF ANY MEASURES USED TO TRAP SEDIMENT.
[2] WHEN NECESSARY, WHEELS SHALL BE CLEANED PRIOR TO ENTRANCE ONTO PUBLIC RIGHT-OF-WAY.
[3] WHEN WASHING IS REQUIRED, IT SHALL BE DONE ON AREA STABILIZED WITH CRUSHED STONE THAT DRAINS INTO AN APPROVED SEDIMENT TRAP OR SEDIMENT BASIN.
[4] USE SANDBAGS, STRAW BALES OR OTHER APPROVED METHODS TO CHANNELIZE RUNOFF TO BASIN AS REQUIRED.


5 CONSTRUCTION ENTRANCE

SCALE: N.T.S.

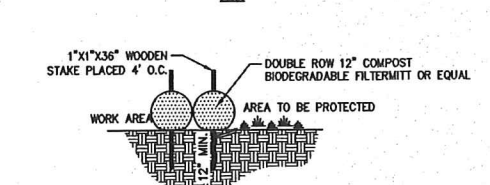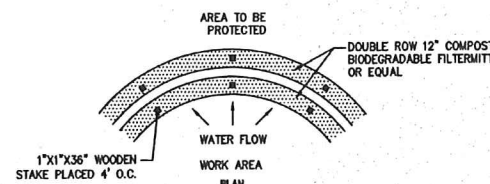



2 EROSION CONTROL BARRIER (ECB)

SCALE: N.T.S.

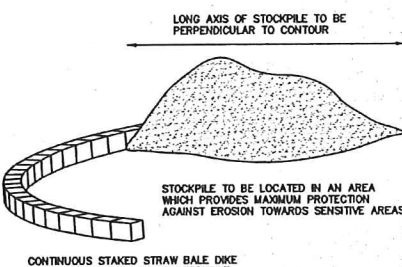

4 TEMPORARY STOCKPILE

SCALE: N.T.S.

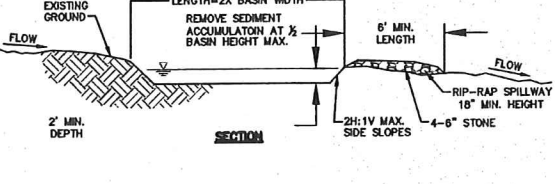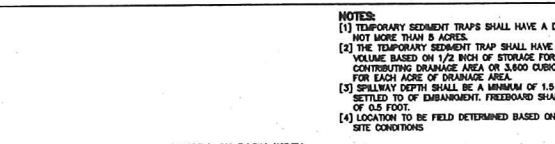

6 TEMPORARY SEDIMENT TRAP

SCALE: N.T.S.



Andrews Survey & Engineering, Inc.
Land Surveying - Civil Engineering - Site Planning

P.O. Box 312, 104 Mendon Street
Uxbridge, Massachusetts 01569
P: 508-278-3897 F: 508-278-2289

590 East Washington Street
North Attleboro, Massachusetts 02760
P: 508-316-0452 F: 508-316-4963

APPROVAL UNDER SITE PLAN REVIEW.
FRANKLIN PLANNING BOARD

BEING A MAJORITY DATE:

THIS CERTIFIES THAT THE NOTICE OF APPROVAL OF THIS PLAN BY THE FRANKLIN PLANNING BOARD HAS BEEN RECEIVED AND RECORDED ON AT
AND NO APPEAL WAS RECEIVED DURING THE 20 DAYS NEXT AFTER SUCH RECEIPT OF SAID NOTICE.

FRANKLIN TOWN CLERK DATE

PROJECT:
LARGE-CAPACITY GROUND MOUNTED SOLAR ENERGY SYSTEM
SPRING STREET
FRANKLIN, MA


APPLICANT:
SPRING ST. RENEWABLES, LLC
101 SUMMER STREET
BOSTON, MA 02110

REVISIONS		
NO.	DATE	DESCRIPTION
1	02/1/19	PEER REVIEW COMMENTS
2	03/11/19	DEP COMMENTS
3	03/28/19	PER 3/28/19 WSI REVIEW
4	04/08/19	PER TOWN/PEER REVIEW COMMENTS


GRAPHIC SCALE

SHEET TITLE

EROSION & SEDIMENT CONTROL
NOTES & DETAILS

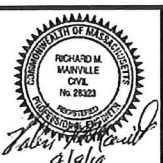

DES BY: KNP DATE: NOVEMBER 21, 2018
CHK BY: RJM PROJECT NO: 2018-101
P.E. 4/19/19
C3.4

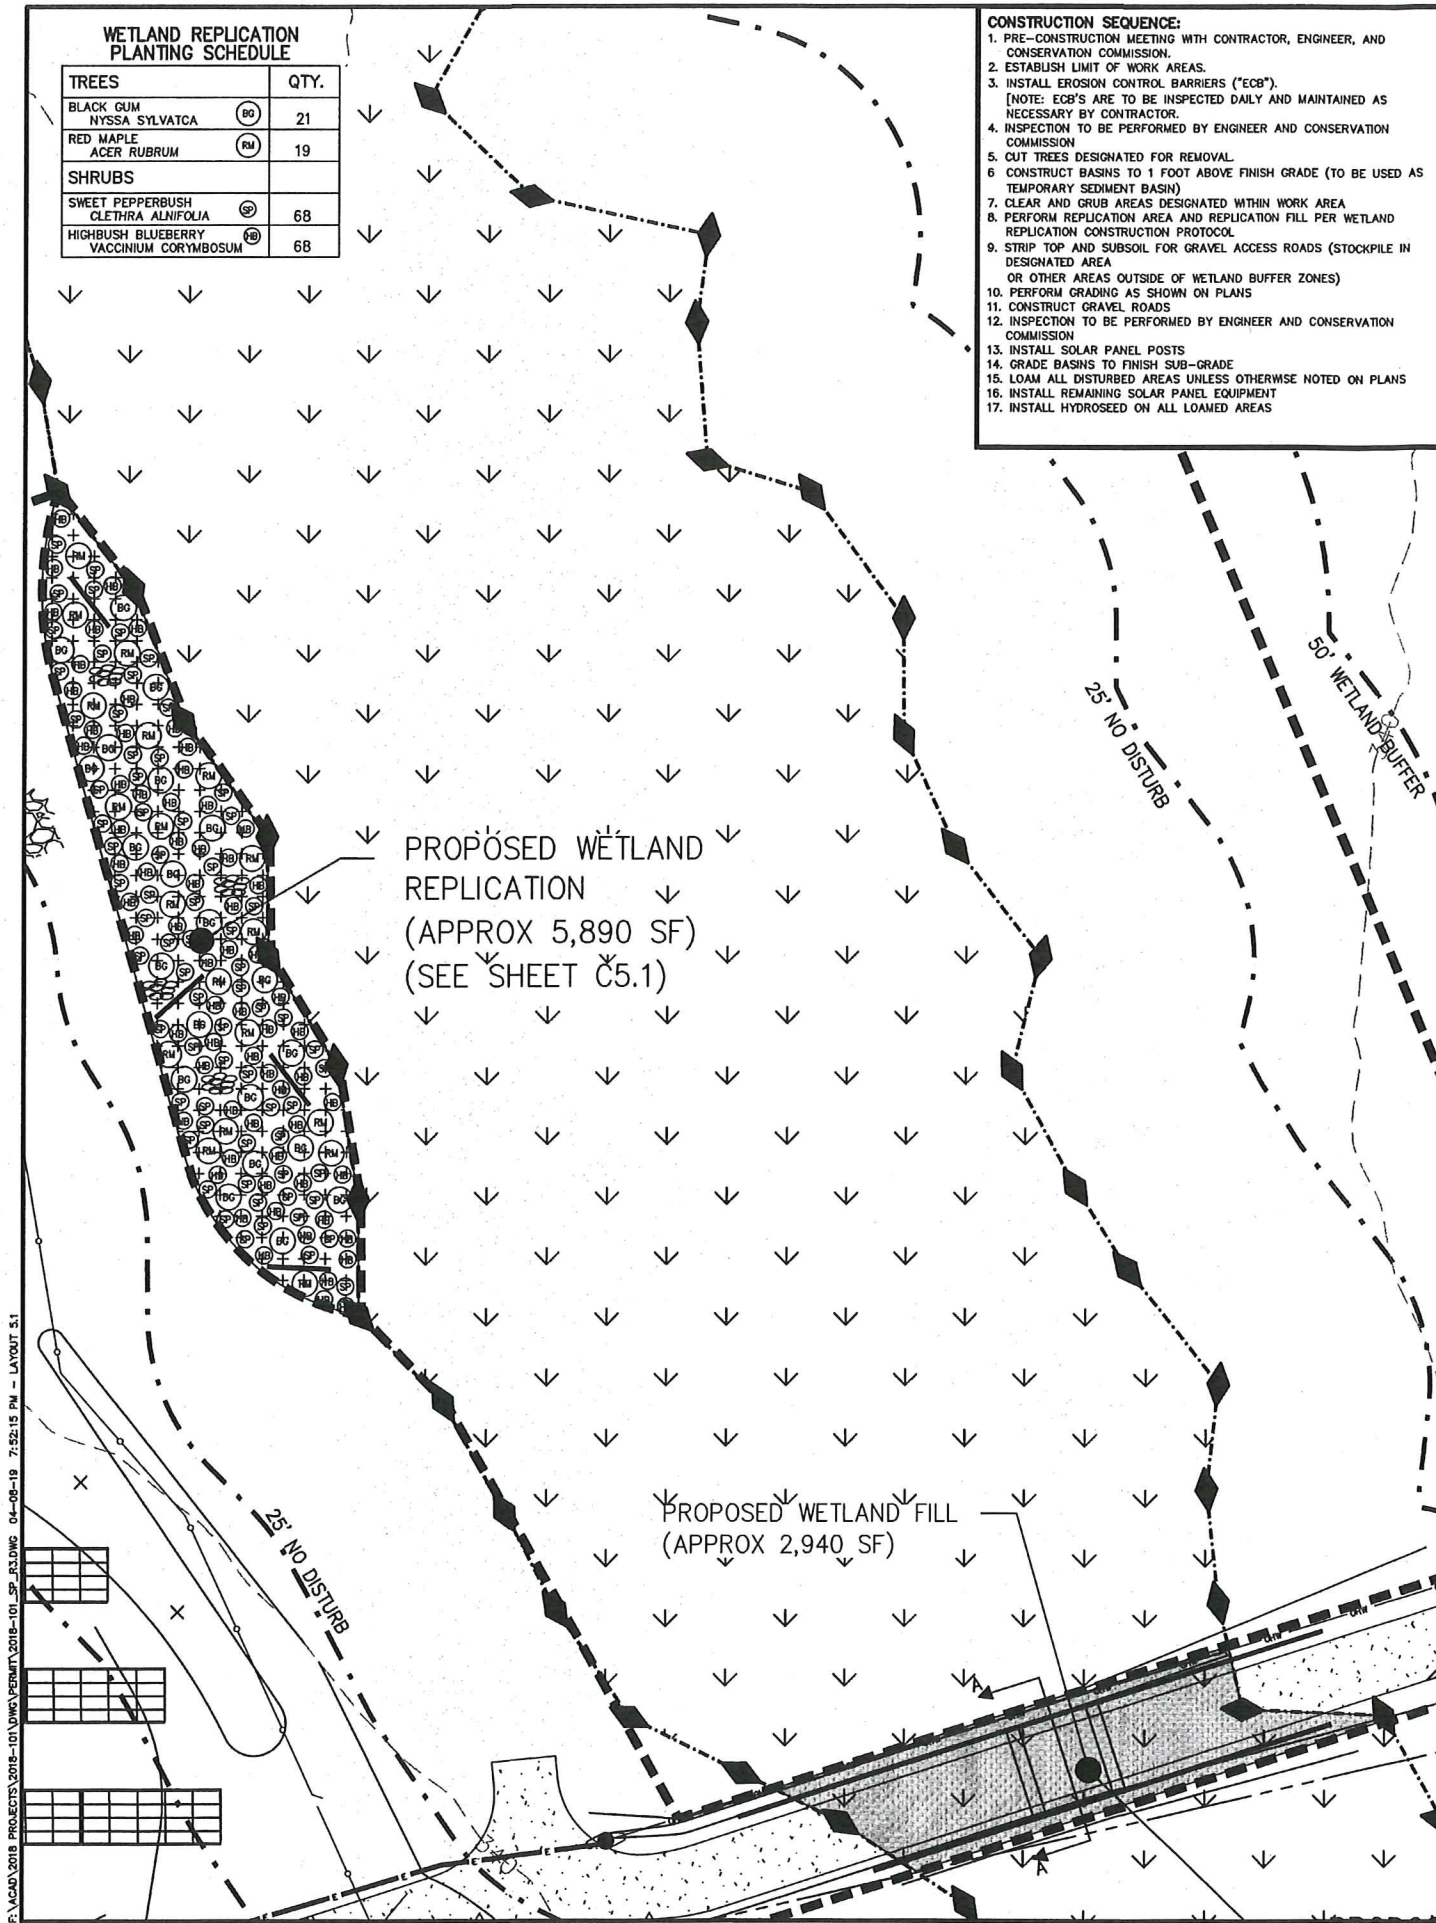




WETLAND REPLICATION PLANTING SCHEDULE		
TREES		QTY.
BLACK OUN NYSSA SYLVATICA	(BO)	21
RED MAPLE ACER RUBRUM	(RM)	19
SHRUBS		
SWEET PEPPERBUSH CLETHRA ALNIFOLIA	(SP)	68
HIGHBUSH BLUEBERRY VACCINIUM CORYMBOSUM	(EB)	68

- CONSTRUCTION SEQUENCE:**
1. PRE-CONSTRUCTION MEETING WITH CONTRACTOR, ENGINEER, AND CONSERVATION COMMISSION.
 2. ESTABLISH LIMIT OF WORK AREAS.
 3. INSTALL EROSION CONTROL BARRIERS ("ECB").
[NOTE: ECB'S ARE TO BE INSPECTED DAILY AND MAINTAINED AS NECESSARY BY CONTRACTOR.]
 4. INSPECTION TO BE PERFORMED BY ENGINEER AND CONSERVATION COMMISSION.
 5. CUT TREES DESIGNATED FOR REMOVAL.
 6. CONSTRUCT BASINS TO 1 FOOT ABOVE FINISH GRADE (TO BE USED AS TEMPORARY SEDIMENT BASIN).
 7. CLEAR AND GRUB AREAS DESIGNATED WITHIN WORK AREA.
 8. PERFORM REPLICATION AREA AND REPLICATION FILL PER WETLAND REPLICATION CONSTRUCTION PROTOCOL.
 9. STRIP TOP AND SUBSOIL FOR GRAVEL ACCESS ROADS (STOCKPILE IN DESIGNATED AREA OR OTHER AREAS OUTSIDE OF WETLAND BUFFER ZONES).
 10. PERFORM GRADING AS SHOWN ON PLANS.
 11. CONSTRUCT GRAVEL ROADS.
 12. INSPECTION TO BE PERFORMED BY ENGINEER AND CONSERVATION COMMISSION.
 13. INSTALL SOLAR PANEL POSTS.
 14. GRADE BASINS TO FINISH SUB-GRADE.
 15. LOAM ALL DISTURBED AREAS UNLESS OTHERWISE NOTED ON PLANS.
 16. INSTALL REMAINING SOLAR PANEL EQUIPMENT.
 17. INSTALL HYDROSEED ON ALL LOAMED AREAS.

- WETLAND REPLICATION CONSTRUCTION PROTOCOL:**
1. THE FOLLOWING PROTOCOL CONFORMS TO THE GENERAL PERFORMANCE STANDARDS IN THE MA WETLANDS PROTECTION ACT REGULATIONS AT 310 CMR 10.55(4)(b) AS SUMMARIZED IN TABLE 2. PLEASE NOTE THAT THE REPLICATION AREA WILL BE BROUGHT TO SUB-GRADE PRIOR TO INITIATING WORK AT THE WETLAND CROSSING.
 2. THE WETLAND BOUNDARIES (I.E., DOWN GRADIENT EDGES OF THE WETLAND REPLICATION AREA) WILL BE MARKED IN THE FIELD.
 3. PRIOR TO THE START OF EARTH-MOVING ACTIVITIES IN THE REPLICATION AREA, AN EROSION CONTROL BARRIER OF PROPERLY INSTALLED SILTATION FENCE (I.E., THE BOTTOM FEW INCHES OF THE SILTATION FENCE INSTALLED IN A NARROW TRENCH AND THE TRENCH FILLED WITH SOIL AROUND THE SILTATION FENCE) WILL BE INSTALLED ALONG THE WETLAND BOUNDARIES BETWEEN THE WETLAND AND THE WETLAND REPLICATION AREA. THE WETLAND REPLICATION AREA WILL THEN BE CLEARED AND GRUBBED, WITH THE EXCEPTION OF THE TREES THAT HAVE BEEN MARKED TO BE SAVED.
 4. THE PROPOSED FINAL GRADE FOR THE REPLICATION AREA SHOULD APPROXIMATE THE ELEVATION OF THE ADJACENT WETLAND AREAS, AS NOTED ON THE SITE PLANS. THE REPLICATION AREA WILL BE EXCAVATED TO A DEPTH OF 12 INCHES BELOW THE PROPOSED FINAL GRADE. THE EXCAVATION AND PLANTING WORK WILL BE CLOSELY SUPERVISED BY A QUALIFIED WETLAND SCIENTIST. MINOR MODIFICATIONS TO THE PROPOSED GRADING MAY BE MADE IN THE FIELD BY THE WETLAND SCIENTIST IN RESPONSE TO DESERVED SUBSURFACE HYDROLOGIC CONDITIONS. ALL EXCAVATED MATERIAL WILL BE DISPOSED OF AWAY FROM ALL WETLAND RESOURCE AREAS. EIGHT TO TEN BOULDERS (1 TO 2 FOOT DIAMETER) WILL BE PLACED IN TWO PILES, AT SUBGRADE, WITHIN THE REPLICATION AREA TO PROVIDE WILDLIFE SHELTERS. TWO TREE TRUNKS, APPROXIMATELY 20 FEET IN LENGTH, WILL BE "PLANTED" UPRIGHT, WITHIN THE REPLICATION AREA, TO PROVIDE NESTING CAVITIES AND FORAGE OPPORTUNITIES.
 5. EXISTING TOPSOILS WITHIN THE IMPACT AREA WILL BE EXCAVATED, STOCKPILED AND KEPT MOIST BY WATERING AND/OR COVERING.
 6. RELOCATED WETLAND TOPSOILS WILL BE SUPPLEMENTED WITH A 1:1 MIXTURE OF HIGH QUALITY, LOAMY TOPSOIL AND LEAF MOLD COMPOST, AS NECESSARY, TO APPROXIMATE 12 INCHES IN THICKNESS THROUGHOUT THE REPLICATION AREA. THE SUBSTRATE WILL BE ROUGHLY GRADED TO PROVIDE AN APPROPRIATE MICROTOPOGRAPHY. A MINIMUM OF 4 INCHES OF LOAMY TOPSOIL WILL BE APPLIED TO THE SIDE-SLOPES OF THE WETLAND REPLICATION AREA. THE SIDE SLOPES SHOULD BE STABILIZED AS NECESSARY TO PREVENT EROSION.
 7. WILDLIFE ENHANCEMENT MEASURES INCLUDING FOUR TREE TRUNKS AND FOUR PILES WILL BE INSTALLED WITHIN EACH REPLICATION AREA. THE TREE TRUNKS WILL CONSIST OF 15 TO 20 FOOT LOGS PLACED RANDOMLY ON THE FINISHED SURFACE. THE TREE TRUNKS WILL PROVIDE FOOD, FORAGE AND CAVITY NESTING OPPORTUNITIES. THE ROCK PILES WILL CONSIST OF FOUR OR FIVE BOULDER EACH (APPROXIMATELY 24 INCHES IN DIAMETER) PLACED AT SUB-GRADES SO AS TO CREATE CREEVES AND CAVITIES FOR SHELTER AND NESTING.
 8. AN EROSION CONTROL BARRIER COMPRISING ONLY TIED-IN SILTATION FENCE WILL BE PROPERLY INSTALLED BETWEEN THE COMPLETED REPLICATION AREA AND THE ADJACENT UPLAND SLOPES.
 9. PLANTING WILL BE DONE ONLY DURING THE BEGINNING (APRIL 15 THROUGH JUNE) OR END (SEPTEMBER 1 TO NOVEMBER 15) OF THE GROWING SEASON. PLANTING IN THE MID-GROWING SEASON IS ONLY ACCEPTABLE IF IRRIGATION IS PROVIDED. THE PLANT SPECIES IDENTIFIED IN THE TABLE BELOW WILL BE PLANTED IN THE REPLICATION AREA EITHER BY TRANSPLANT OR FROM NURSERY STOCK. THE SAPLINGS WILL BE DISTRIBUTED THROUGHOUT THE AREA. THE SHRUBS WILL BE PLANTED RANDOMLY THROUGHOUT THE AREA WITH THE AVERAGE SPACING BETWEEN SHRUBS APPROXIMATELY 5 FEET ON-CENTER. THE WOODY VEGETATION SHOULD NOT BE PLANTED IN ROWS.
 10. THE REPLICATION AREA WILL BE SEED WITH "NEW ENGLAND WETMIX" AS PER NEW ENGLAND WETLAND PLANTS, INC SPECIFICATIONS OR APPROVED EQUAL TO PROVIDE FOR TEMPORARY EROSION CONTROL AND MOISTURE RETENTION.
 11. THE REPLICATION AREAS WILL BE INSPECTED, BY A QUALIFIED WETLAND SCIENTIST, AT THE END OF EACH GROWING SEASON FOR A MINIMUM OF TWO YEARS OR UNTIL SUCH TIME AS THE REQUIRED 75% OF VEGETATIVE COVER WITH WETLAND SPECIES HAS BEEN ESTABLISHED. WRITTEN RESULTS OF THESE INSPECTIONS WILL BE SUBMITTED TO THE CONSERVATION COMMISSION.
 12. AFTER THE WETLAND REPLICATION AREA HAS BECOME VEGETATIVELY STABILIZED, AND FOLLOWING APPROVAL OF THE ISSUING AUTHORITY, THE SILTATION FENCE AND ALL WOODEN STAKES WILL BE REMOVED AND DISPOSED OF PROPERLY.

WETLANDS FILL AREA
TOTAL WETLAND FILL AREA FROM CROSSING: 2,940 SQ. FT. ±
TOTAL REPLICATION AREA: 5,890 SQ. FT. ±

TABLE 1.		
PUBLIC INTERESTS:	VALUE OF AREAS TO BE ALTERED:	VALUE OF REPLICATION AREAS:
PUBLIC AND PRIVATE WATER SUPPLY, GROUNDWATER SUPPLY	YES. RECHARGES GROUNDWATER THROUGH INFILTRATION. SEASONALLY RECHARGES SURFACE WATER THROUGH OVERLAND FLOW. OVERLAND FLOW WILL BE MAINTAINED THROUGH CULVERTS.	YES. WILL ALSO RECHARGE GROUNDWATER THROUGH INFILTRATION IN FRAGILE SUBSOIL AND SUBSTRATE.
FLOOD CONTROL AND STORM DAMAGE PREVENTION	YES. SOME STORAGE OF RUNOFF IN SEASONALLY SATURATED SOILS.	YES. SEASONALLY SATURATED SOILS WILL STORE EQUAL OR GREATER VOLUMES OF RUNOFF.
PREVENTION OF POLLUTION	YES. CONTAMINANTS AND EXCESS NUTRIENTS RETAINED IN AND DEGRADED BY MINERAL AND ORGANIC COMPONENTS OF HYDRIC SOILS.	YES. CONTAMINANTS AND EXCESS NUTRIENTS RETAINED IN AND DEGRADED BY MINERAL AND ORGANIC COMPONENTS OF HYDRIC SOILS.
FISHERIES	N/A. NO PERENNIAL WATERWAY OR WATERBODY.	N/A. NO PERENNIAL WATERWAY OR WATERBODY.
WILDLIFE HABITAT	YES. EXISTING VEGETATIVE LAYERS, SOIL STRUCTURE, DEADWOOD AND SURFACE STONES PROVIDE FORAGING AND SHELTER OPPORTUNITIES.	YES. REPLICATED SOIL STRUCTURE, PLANTING, BOULDER PLACEMENT AND TREE SNAGS WILL PROVIDE OPPORTUNITIES FOR WILDLIFE SHELTER AND FORAGE.

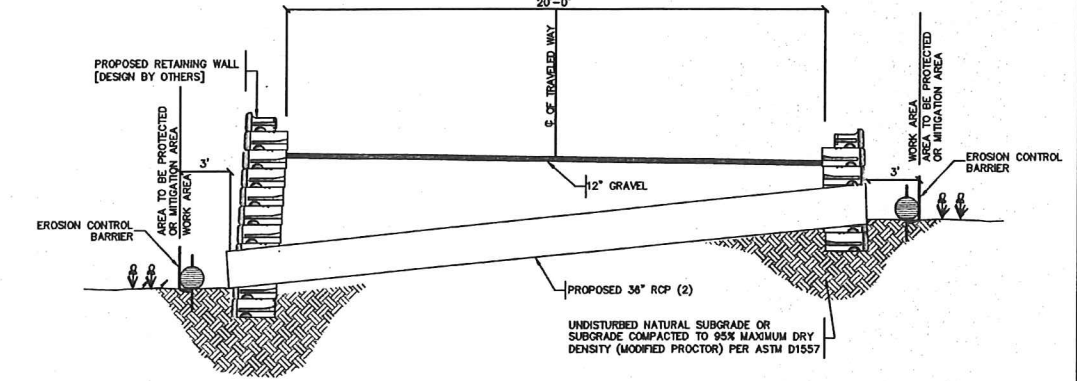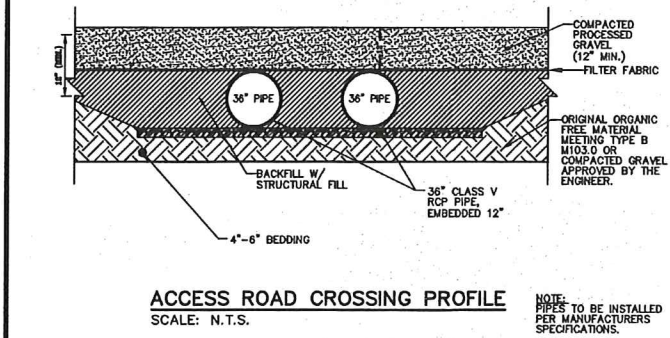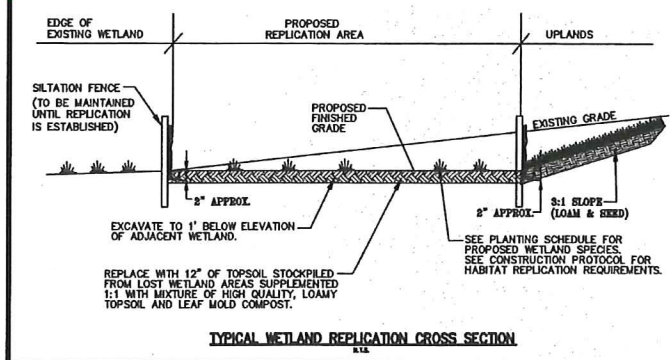

CROSS SECTION A-A
N.T.S.

ASE
Andrews Survey & Engineering, Inc.
Land Surveying - Civil Engineering - Site Planning
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P: 508-278-3897 F: 508-278-2289
500 East Waukegan Street
North Attleboro, Massachusetts 02760
P: 508-316-0452 F: 508-316-8963

APPROVAL UNDER SITE PLAN REVIEW.
FRANKLIN PLANNING BOARD

BEING A MAJORITY DATE: _____

THIS CERTIFIES THAT THE NOTICE OF APPROVAL OF THIS PLAN BY THE FRANKLIN PLANNING BOARD HAS BEEN RECEIVED AND RECORDED ON _____ AT _____ AND NO APPEAL WAS RECEIVED DURING THE 20 DAYS NEXT AFTER SUCH RECEIPT OF SAID NOTICE.

FRANKLIN TOWN CLERK DATE: _____

PROJECT: LARGE-CAPACITY GROUND MOUNTED SOLAR ENERGY SYSTEM
APPLICANT: SPRING ST. RENEWABLES, LLC
101 SUMMER STREET
BOSTON, MA 02110

REVISIONS

NO.	DATE	DESCRIPTION
1	02/1/19	PEER REVIEW COMMENTS
2	03/11/19	DEP COMMENTS
3	03/28/19	PER 3/28/19 WSI REVIEW
4	04/08/19	PER TOWN/PEER REVIEW COMMENTS


GRAPHIC SCALE
1 inch = 20 feet

SHEET TITLE
WETLAND CROSSING & REPLICATION PLAN

DES BY: KMP DATE: NOVEMBER 21, 2018
CHK BY: RUM PROJECT NO: 2018-101

C5.1
PLAN NO. C-5891

F:\MAD\2018 PROJECTS\2018-101\DWG\PERMIT\2018-101_SP_53.DWG 04-06-19 7:51:38 PM - LAYOUT 5.3

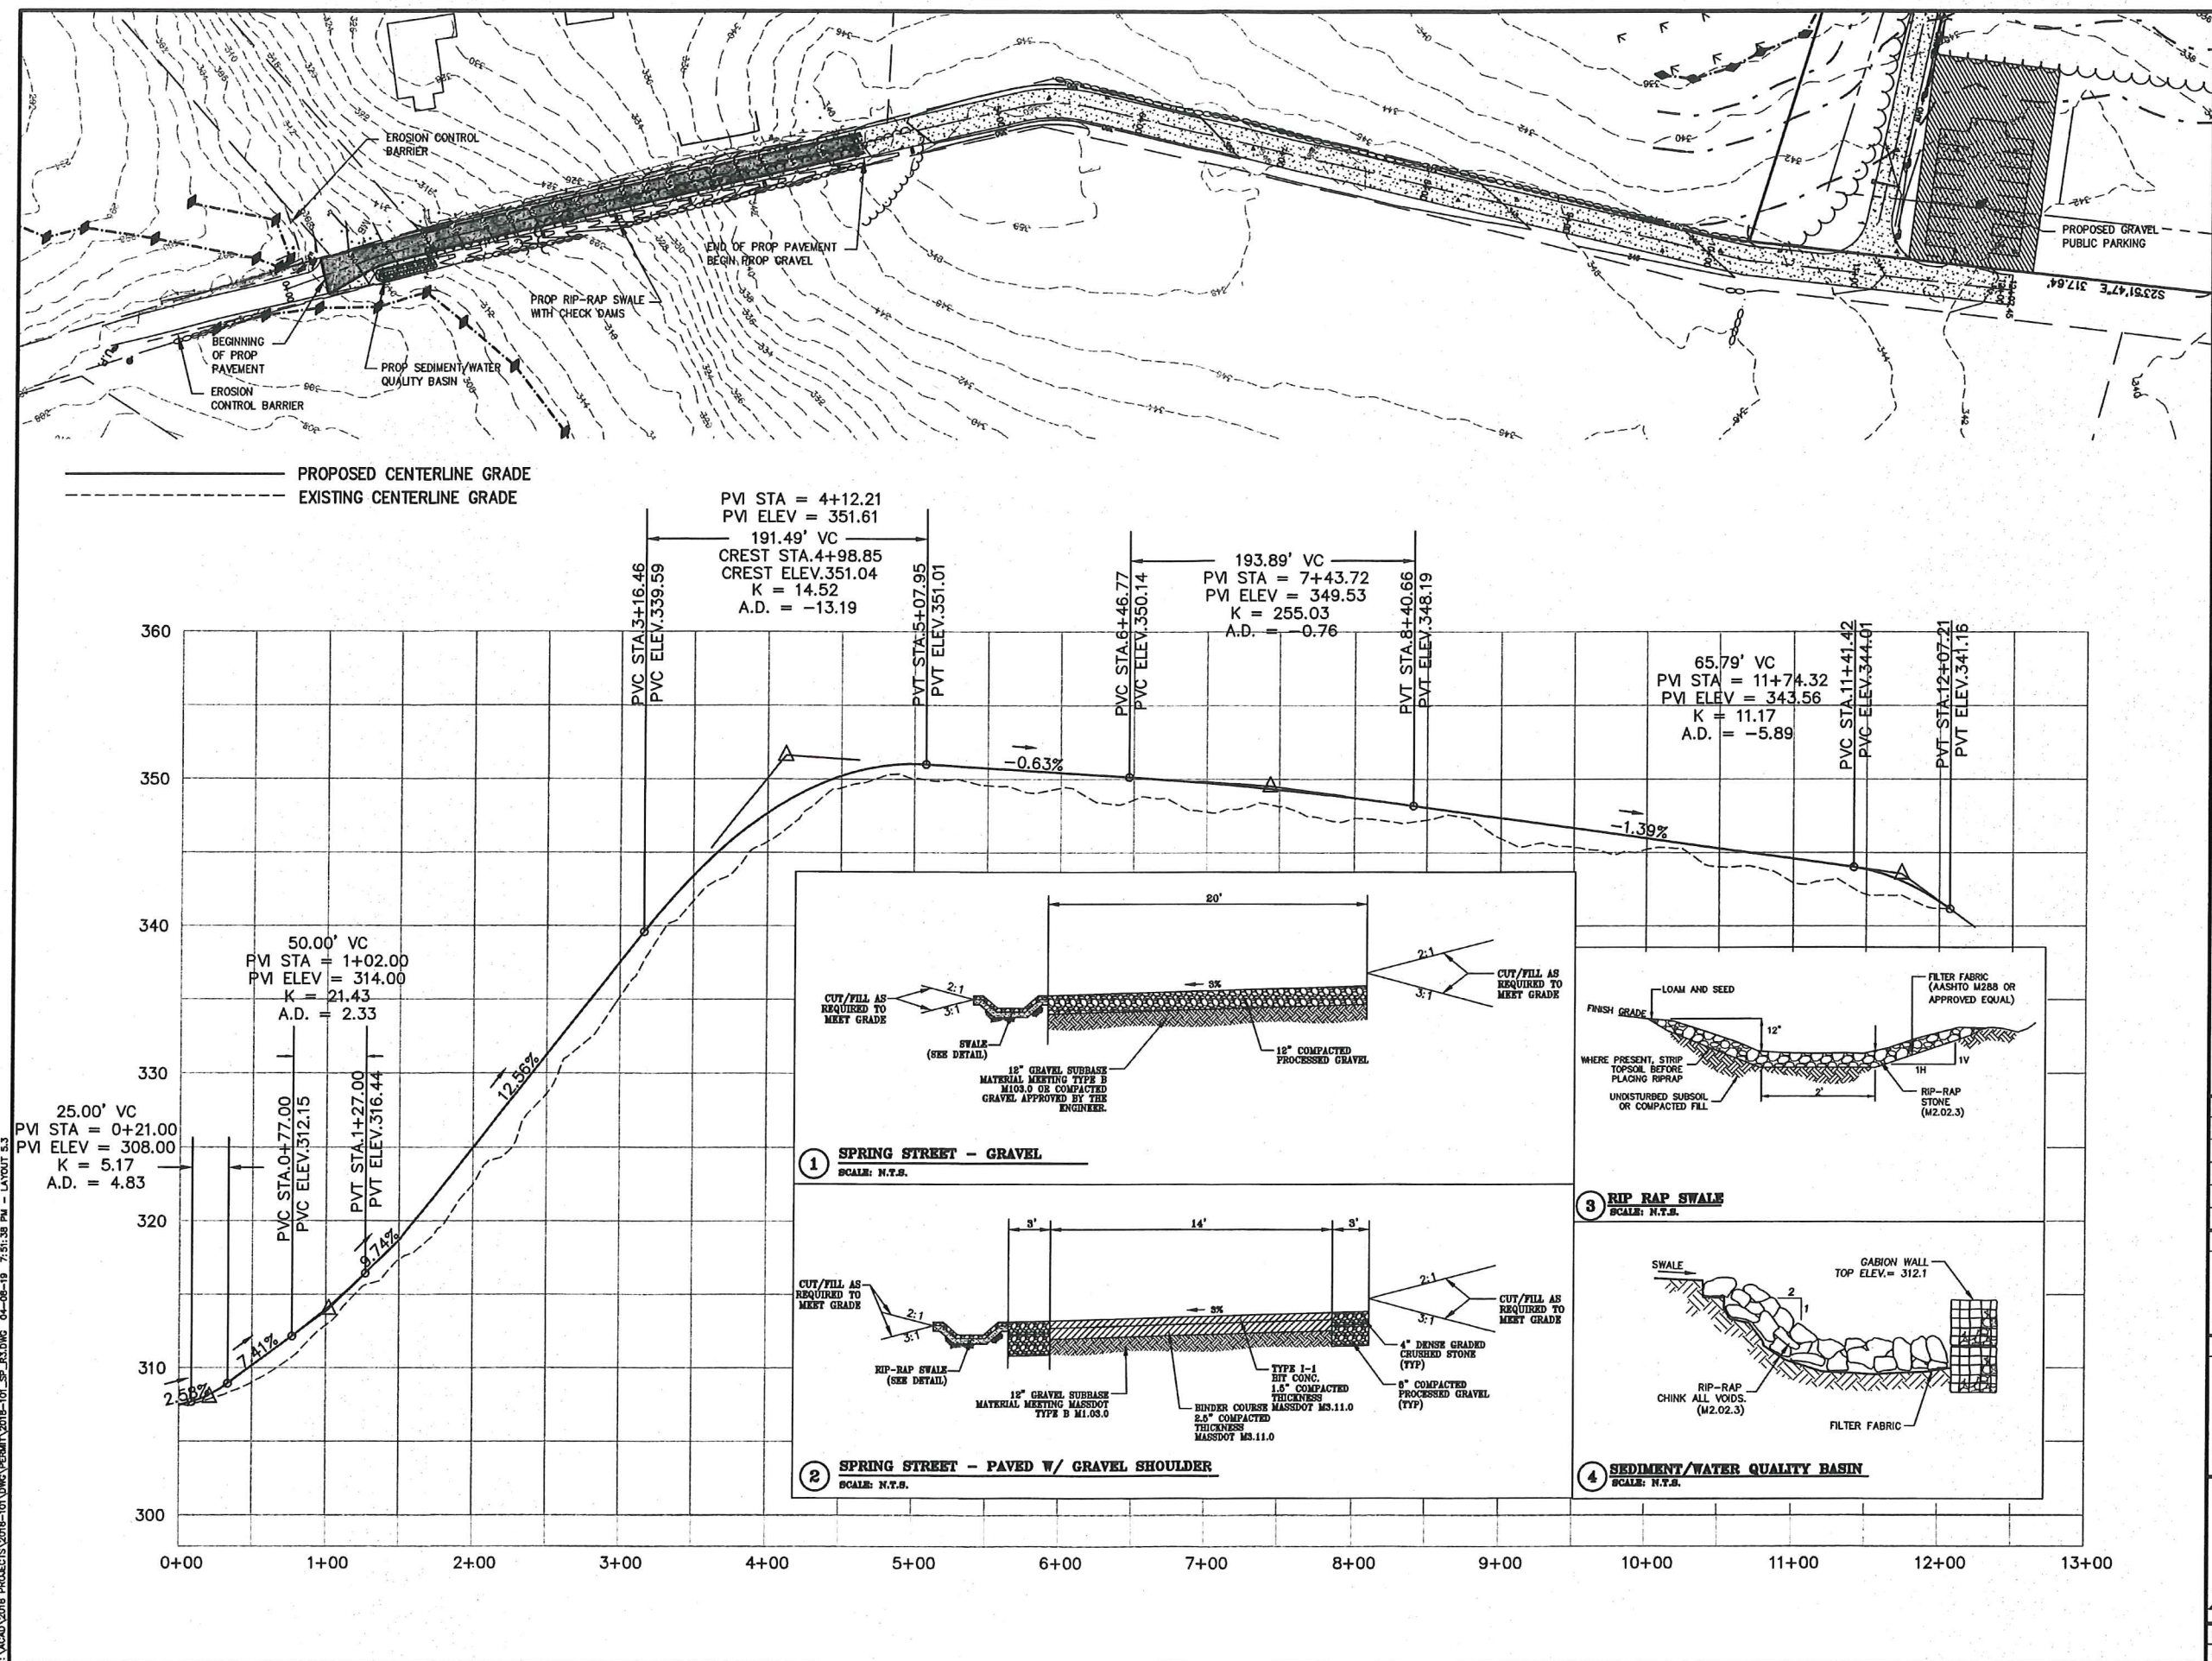

Andrews Survey & Engineering, Inc.
Land Surveying - Civil Engineering - Site Planning
P.O. Box 312, 104 Mendon Street
Uxbridge, Massachusetts 01569
P: 508-278-3897 F: 508-278-2289
500 East Washington Street
North Attleboro, Massachusetts 02760
P: 508-316-0452 F: 508-316-0963


APPROVAL UNDER SITE PLAN REVIEW.
FRANKLIN PLANNING BOARD.

BEING A MAJORITY DATE:
THIS CERTIFIES THAT THE NOTICE OF APPROVAL
OF THIS PLAN BY THE FRANKLIN PLANNING
BOARD HAS BEEN RECEIVED AND RECORDED ON
AT
AND NO APPEAL WAS RECEIVED DURING THE 20
DAYS NEXT AFTER SUCH RECEIPT OF SAID
NOTICE.

FRANKLIN TOWN CLERK DATE

PROJECT: LARGE-CAPACITY GROUND
MOUNTED SOLAR ENERGY SYSTEM
SPRING STREET
FRANKLIN, MA
APPLICANT: SPRING ST. RENEWABLES, LLC
101 SUMMER STREET
BOSTON, MA 02110

REVISIONS		
NO.	DATE	DESCRIPTION
1	02/1/19	PEER REVIEW COMMENTS
2	03/11/19	DEP COMMENTS
3	03/28/19	PER 3/28/19 WSI REVIEW
4	04/08/19	PER TOWN/PEER REVIEW COMMENTS

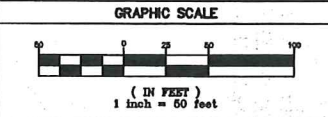

SHEET TITLE
SPRING STREET
IMPROVEMENTS
PLAN AND PROFILE




DES BY: KHP DATE: NOVEMBER 21, 2018
CHK BY: RMA PROJECT NO. 2018-101

C5.3
PLAN NO. L-5691

* ALL CONDUCTORS SHALL BE COPPER UNLESS OTHERWISE NOTED.

* VOLTAGE SETTING VALUES ARE 1-5.

* ALL TRIP TIMES ARE INCLUSIVE OF

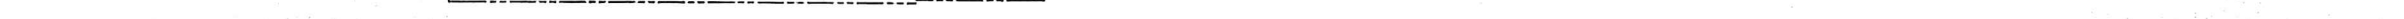

4 Liberty Square, Boston, MA 02109
Tel: (617) 431-1440 Fax: (978) 416-2325 Web: nextamp.com

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