
SITE PLAN 100 AND 110 EAST CENTRAL STREET

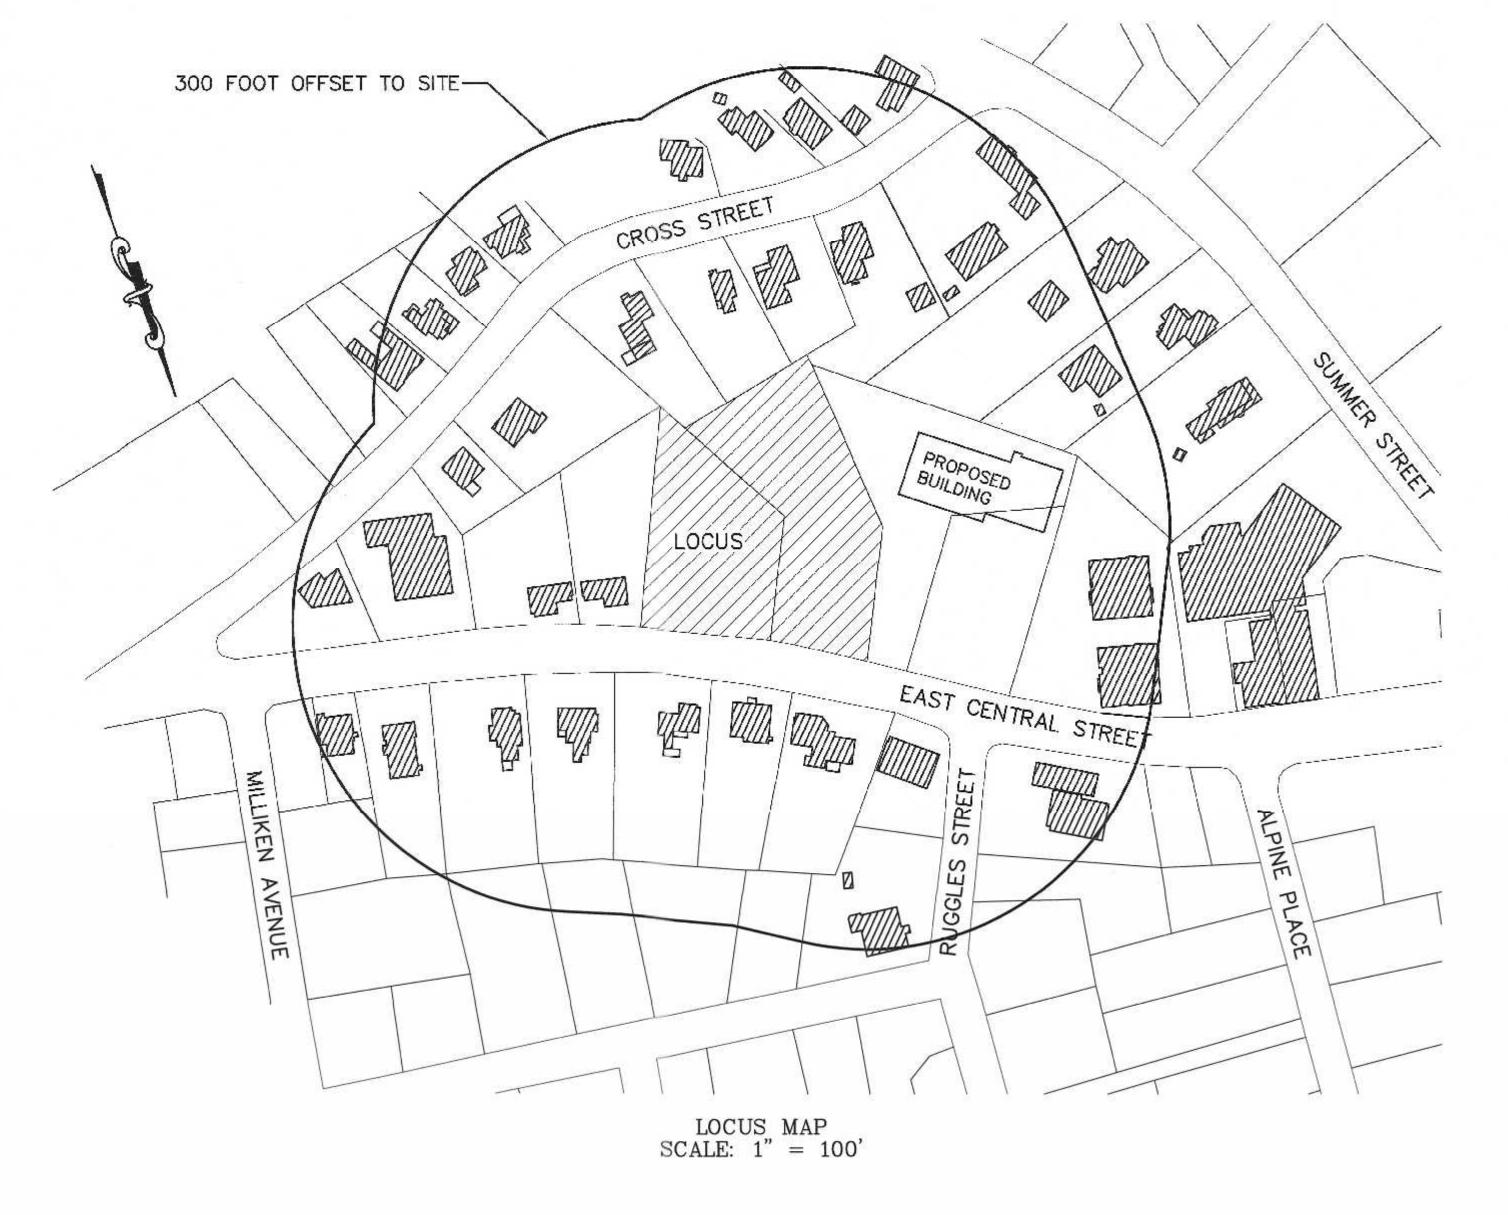

DRAWING INDEX:

1. COVER SHEET

2. EXISTING CONDITIONS PLAN 3. SITE LAYOUT PLAN

4. SITE GRADING AND UTILITY PLAN

5. PLANTING PLAN

6. EROSION CONTROL PLAN

7. CONSTRUCTION DETAILS - 1

8. CONSTRUCTION DETAILS - 2

9. CONSTRUCTION DETAILS

10. CONSTRUCTION DETAILS - 4 SITE LIGHTING LIGHTING PLAN.

PHOTOMETRICS AND SCHEDULES

BY SK & ACCOCIATES

THE 100 AND 110 EAST CENTRAL STREET PROPERTIES ARE LOCATED WITHIN A COMMERCIAL I ZONE.

POSED 9± S.F.
9± S.F.
5.1'
3.7'
IES < 40'**
5'
).5'
5.0'
0.4'
0.4
.2%
4.9%

LOT COVERAGE BASED ON UPLAND AREA.

**REFER TO ARCHITECTURAL PLANS FOR BUILDING HEIGHT.

*1 - BUT NO NEW STRUCTURE SHALL BE REQUIRED TO PROVIDE A DEEPER YARD THAN EXISTED ON THAT PARCEL UPON ADOPTION OF THIS AMENDMENT. *14 - THE 10-FOOT SIDE SETBACK IS ONLY REQUIRED ON ONE SIDE OF THE LOT; IF LOT ABUTS A RESIDENTIAL DISTRICT, A 20-FOOT SETBACK IS REQUIRED ON THE

*15 - BUILDINGS UP TO 50 FEET IN HEIGHT, REGARDLESS OF THE NUMBER OF STORIES, MAY BE PERMITTED BY A SPECIAL PERMIT FROM THE PLANNING BOARD.

REQUIREMENTS FOR 100 AND 110 EAST CENTRAL STREET ZONE COMMERCIAL 1 EXISTING AND PROPOSED LOT AREA, FRONTAGE, DEPTH, WIDTH AND COVERAGE BASED ON THE LOTS BEING COMBINED.

BUILDING HEIGHT, AND SETBACKS BASED ON EXISTING AND PROPOSED BUILDINGS LOCATED ON 100 AND 110 EAST CENTRAL STREET. PROPERTY IS NOT LOCATED WITHIN A FRANKLIN WATER RESOURCE DISTRICT. THE PROPERTY IS LOCATED IN A ZONE C BASED ON FEMA FIRM MAP 25021C0309E

DATED JULY 17, 2012.

100 EAST CENTRAL STREET

	REQUIREMENTS:	EXISTING	PROPOSED
AREA:	5,000 S.F.	33,061± S.F.	33,061± S.F.
FRONTAGE:	50'	109.78	109.78
DEPTH:	50'	278.1	278.1"
HEIGHT:	3 STORIES - 40' *15	2 STORIES	2 STORIES < 40'**
WIDTH:	45'	> 45'	> 45'
SETBACKS			
FRONT:	20' *1	70.6'	70.6'
SIDE WEST:	10' *14	15.0'	15.0'
SIDE EAST:	10' *14	15.2'	15.2"
REAR:	15'	127.8'	127.8'
COVERAGE			
STRUCTURES:	80%	13.3%	13.3%
STRUC. & PAVI	NG: 90%	66.1%	71.8%

LOT COVERAGE BASED ON UPLAND AREA.

110 EAST CENTRAL STREET

	REQUIREMENTS:	EXISTING	PROPOSED
AREA:	5,000 S.F.	22,268± S.F.	22,268± S.F.
FRONTAGE:	50'	135.32'	135.32
DEPTH:	50'	220.9"	220.9
HEIGHT:	3 STORIES - 40' *15	2 STORIES	3 STORIES < 40'**
WIDTH:	45'	> 45'	> 45'
SETBACKS			
FRONT:	20' *1	29.4'	20.5
SIDE WEST:	10' *14	62.0'	14.4
SIDE EAST:	10' *14	14.7'	10.4
REAR:	15'	85.1'	120.4*
COVERAGE			
STRUCTURES:	80%	9.1%	25.7%
STRUC. & PAVI	NG: 90%	14.7%	56.0%

LOT COVERAGE BASED ON UPLAND AREA.

REFERENCES: ASSESSORS MAP 286 PARCELS 30 AND 31 DEED BOOK 38897 PAGE 557 CERTIFICATE NUMBER 209218

PLAN 19290B PLAN IN BOOK 1091 PAGE 108 PLAN 3334 OF 1913

100 EAST CENTRAL STREET RE, LLC 110 EAST CENTRAL STREET RE, LLC 37 EAST CENTRAL STREET FRANKLIN, MASSACHUSETTS

APPLICANT: 110 EAST CENTRAL STREET RE, LLC 37 EAST CENTRAL STREET FRANKLIN, MASSACHUSETTS

SITE PLAN COVER SHEET

100 & 110 EAST CENTRAL STREET FRANKLIN, MASSACHUSETTS

PREPARED FOR 110 EAST CENTRAL STREET RE, LLC


37 EAST CENTRAL STREET FRANKLIN, MASSACHUSETTS JANÚARY 5, 2024 SCALE: 1" = 100'

1 of 10

- ALL EROSION CONTROL MITIGATION MEASURES SHALL BE IN PLACE PRIOR TO MAJOR CONSTRUCTION OR SOIL DISTURBANCE COMMENCING ON THE SITE.

> SITE PLAN APPROVAL REQUIRED FRANKLIN PLANNING BOARD

> > DATE

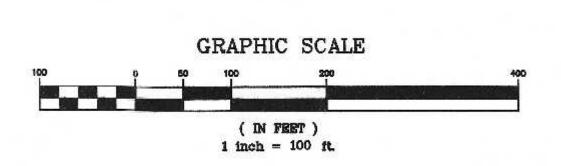

				1
				1
				1/
li de la	0 /05 /04	DEVIEW CONSENTS	RRG	
110	2/26/24	REVIEW COMMENTS	BY	CAF
NO.	DATE	DESCRIPTION	101	UA

1. TO ALLOW THE USE OF PVC AND HPDE PIPE FOR THE ROOF

DRAINS AND UNDERGROUND STORMWATER STORAGE AREA.

2. TO ALLOW SITE LIGHTING TO EXTEND PAST THE PROPERTY


WAIVER REQUESTS:




CARGOS A. CONTROL	DATE		INT.
THE POWER OF THE	7/23	FIELD BY:	BL
	BK#	FIELD BOOK	PG#
11/12/2017	1/24	CALCS BY:	RRG
0/00	1/24	DESIGNED BY:	RRG
Ju 201	1/24	DRAWN BY:	СОМР
ARLOS A. QUINTAL P.E. #30812	1/24	CHECKED BY:	CAQ

T T NITED	JAN. 5, 2024
UCONSULTANTS	1" = 100'
INC. 850 FRANKLIN STREET SUITE 11D	PROJECT UC1587
WRENTHAM, MASSACHUSETTS 02093	SHEET

508-384-6560 FAX 508-384-6566

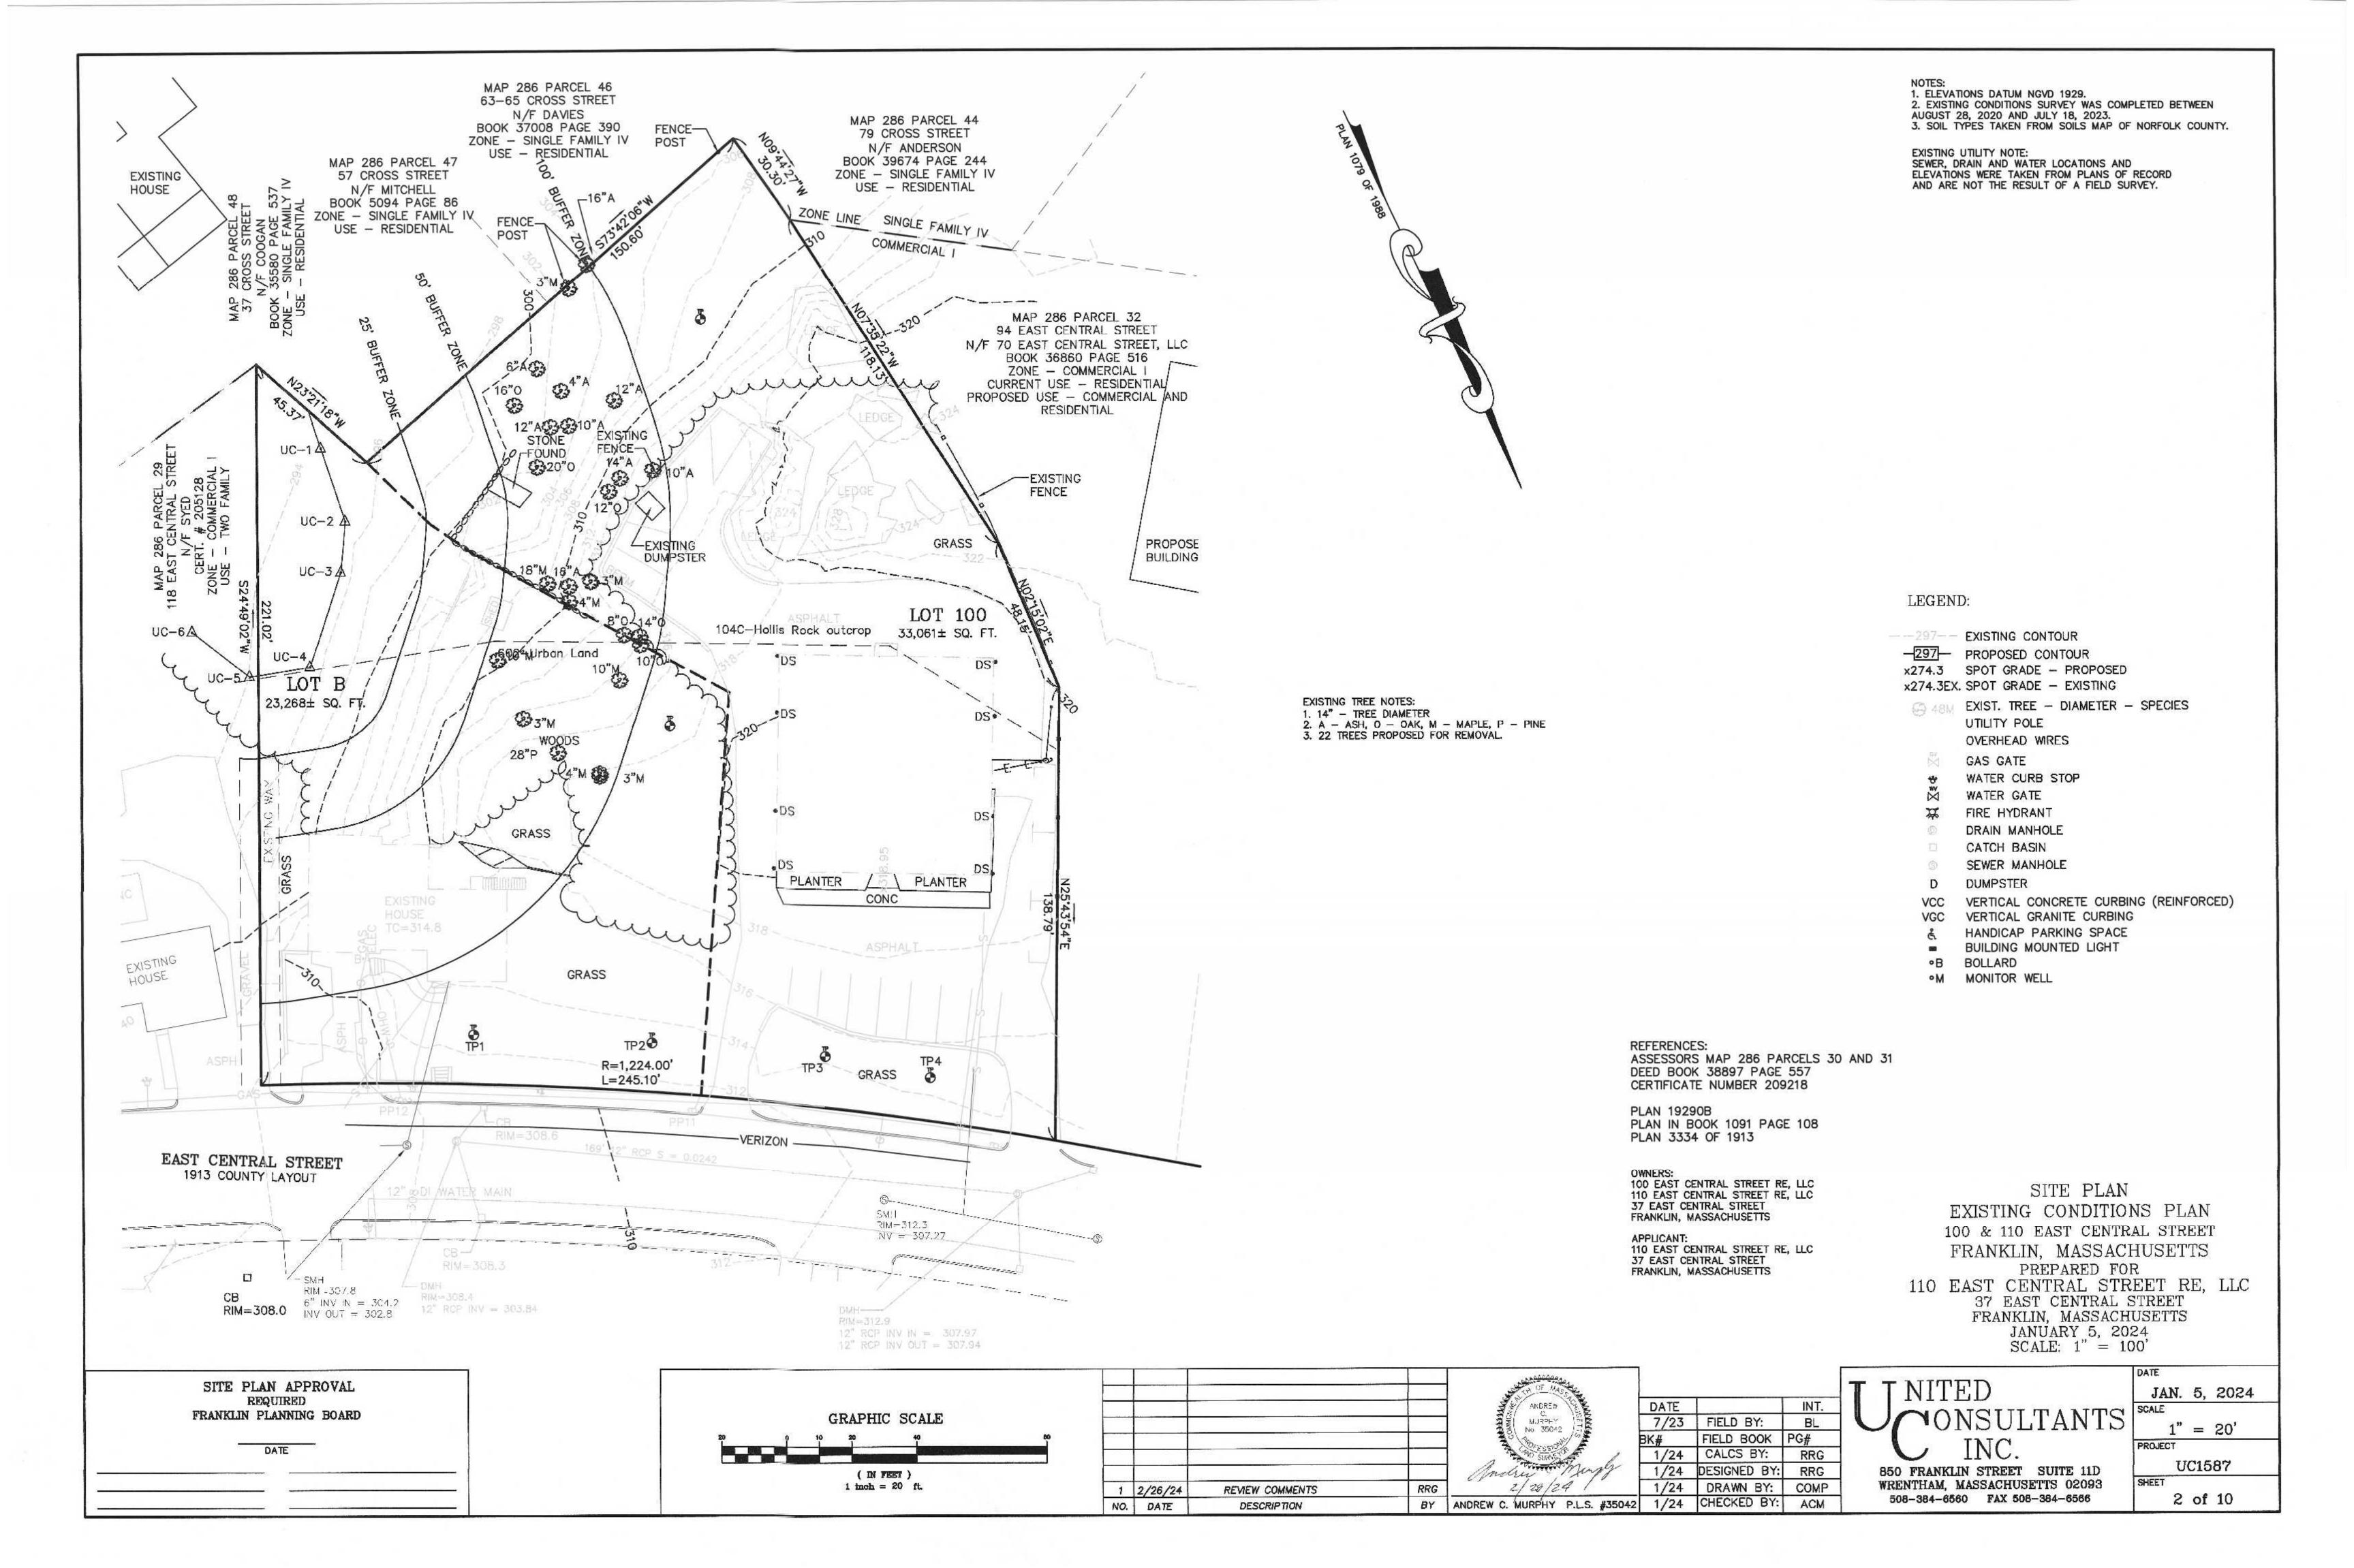

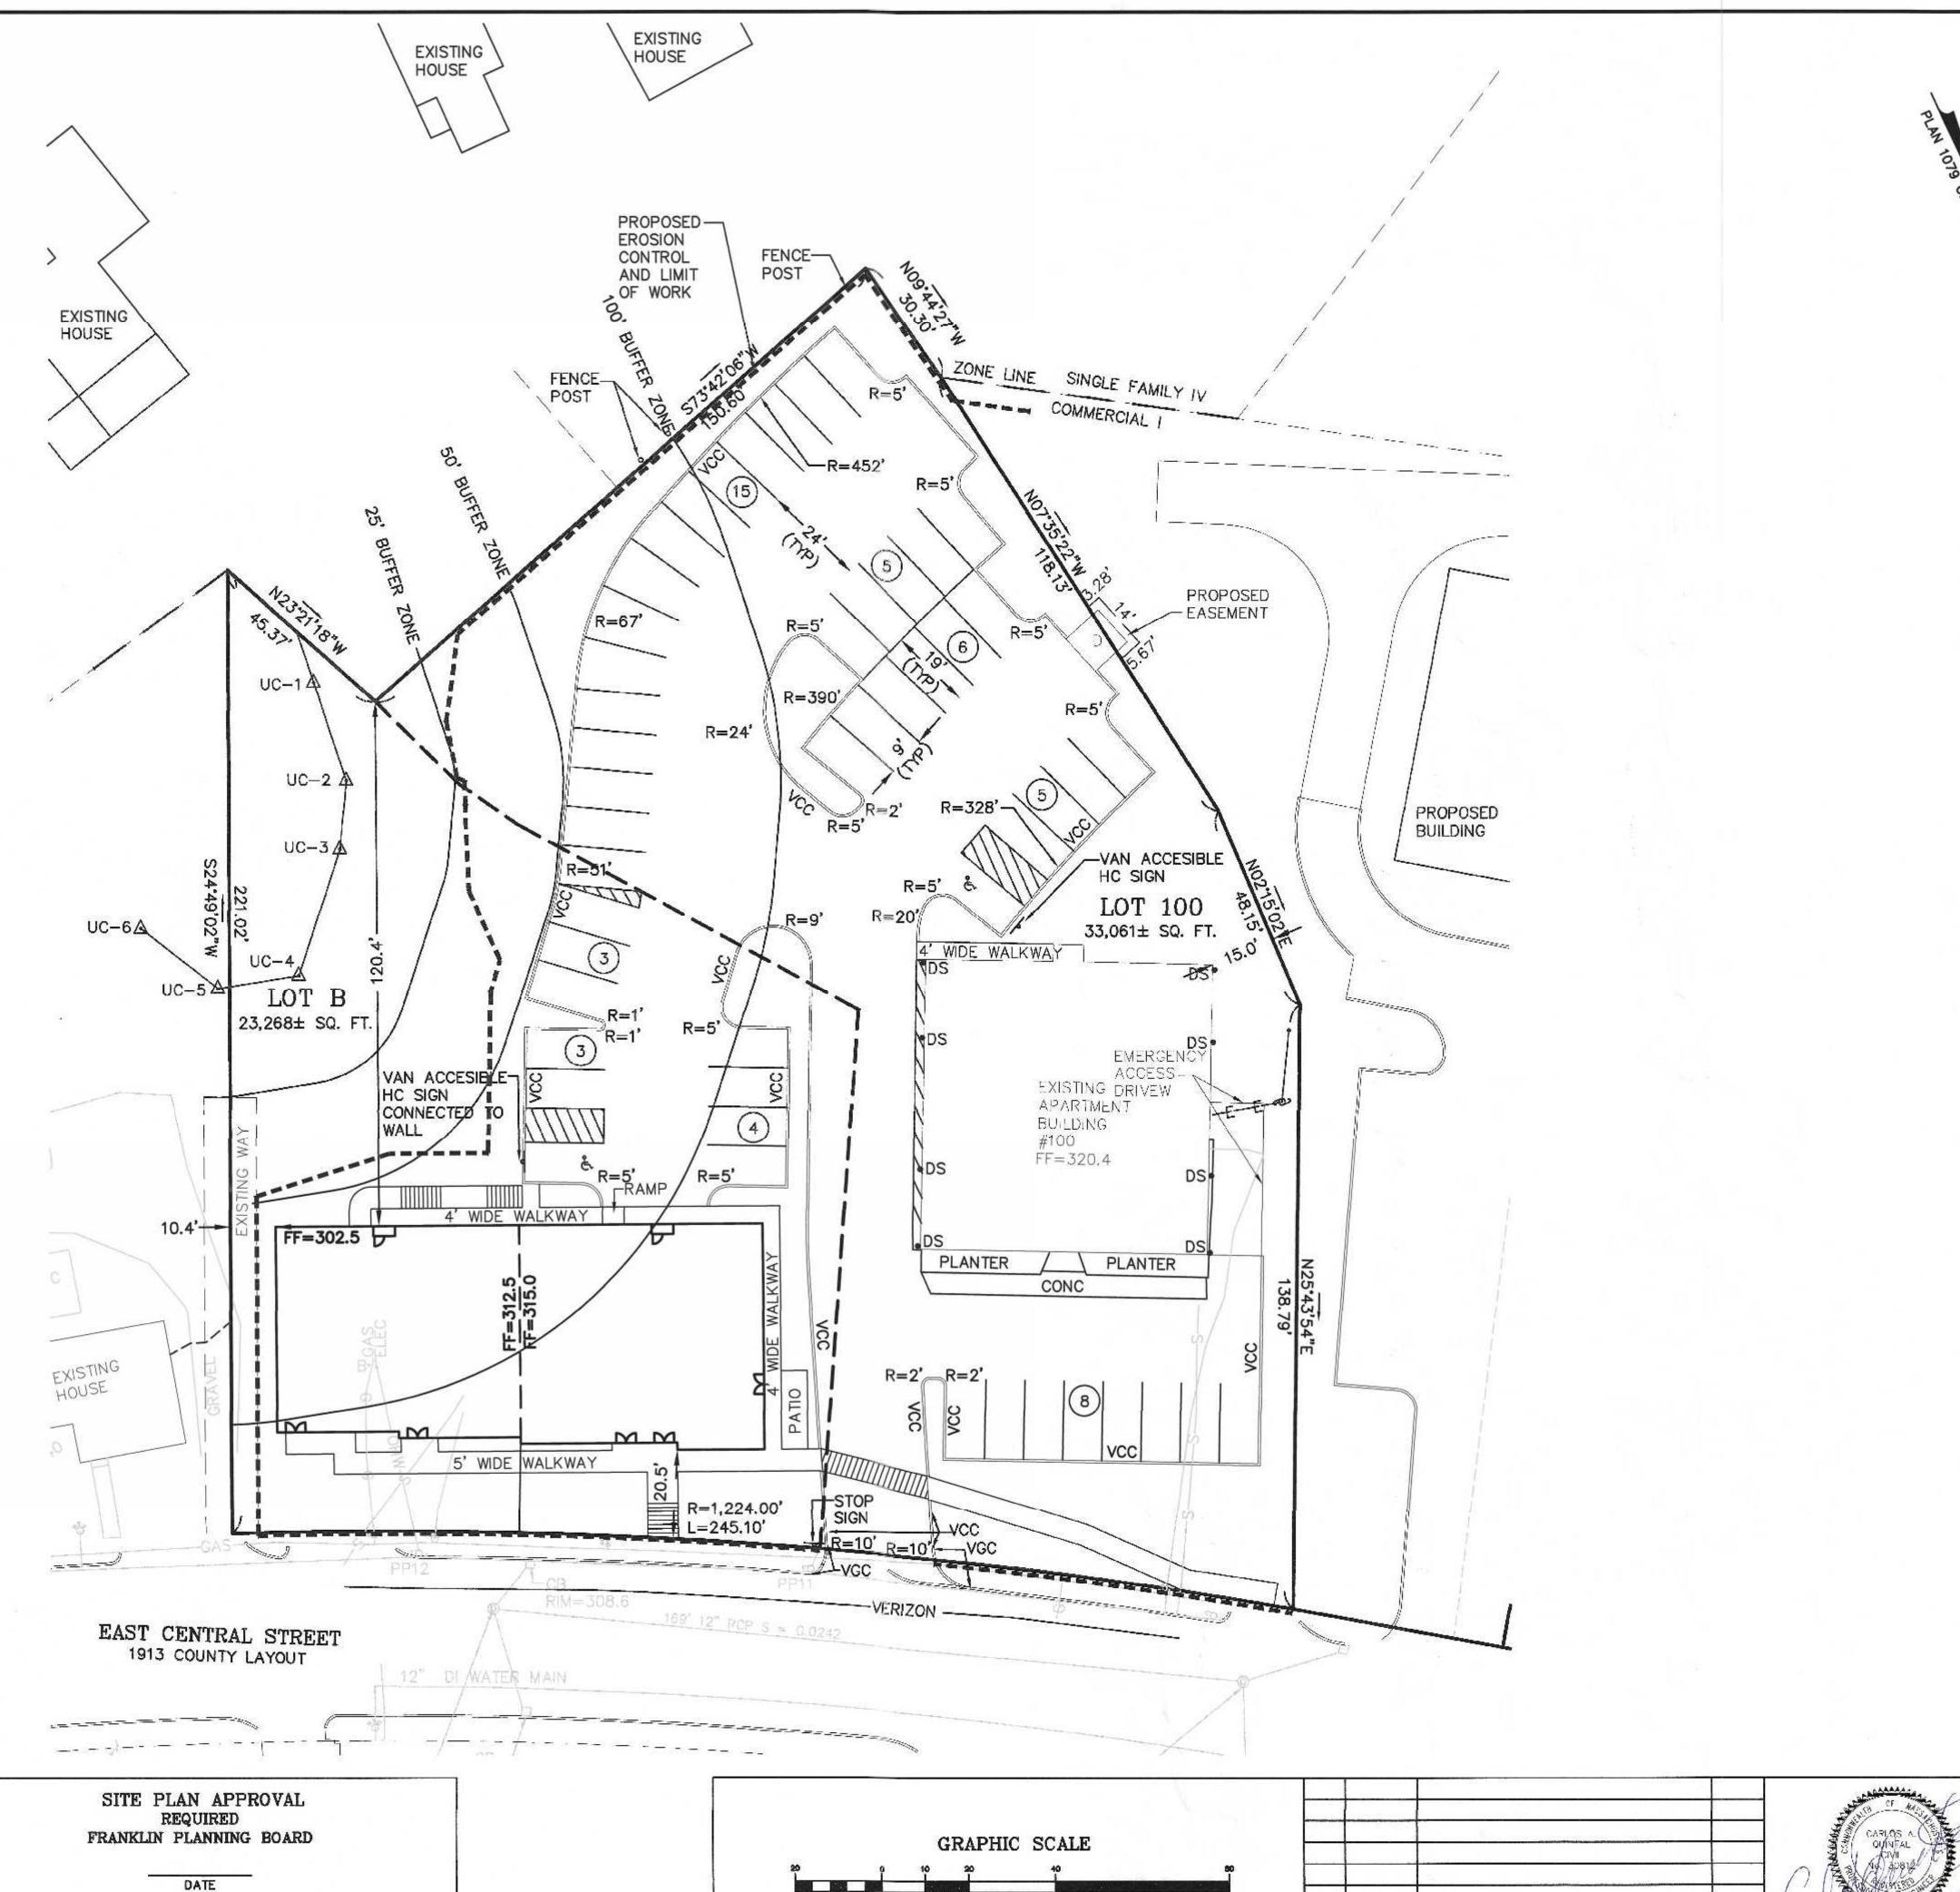

PARKING CALCULATIONS: #100 - #110 EAST CENTRAL STREET COMMERCIAL I REQUIREMENTS (SECTIONS 185-21B.(2)(a) 1.5 SPACES PER DWELLING UNIT RESIDENTIAL DWELLINGS $-30 \times 1.5 = 45$

COMMERCIAL I REQUIREMENTS (SECTIONS 185-21B.(2)(b) COMMERCIAL SPACE (NON RESIDENTIAL USE) 1 SPACE PER 500 SQ. FT. = 949 SQ. FT. / 500 = 2 SPACE REQUIRED

47 SPACES REQUIRED

49 TOTAL SPACES PROVIDED INCLUDING 2 HANDICAP SPACES.

RESIDENTIAL UNIT DENSITY:

1 UNIT PER 2,250 SQ. FT. 56,329 SQ. FT. / 2,250 = 25.03 UNITS SEE 185 ATTACHMENT 7 NOTE 3. 30 DWELLING UNITS PROPOSED (INCLUDING 10 EXISTING UNITS) SPECIAL PERMIT REQUIRED.

LEGEND:

--- 297-- EXISTING CONTOUR -297 PROPOSED CONTOUR x274.3 SPOT GRADE - PROPOSED x274.3EX. SPOT GRADE - EXISTING

ABM EXIST. TREE - DIAMETER - SPECIES UTILITY POLE OVERHEAD WIRES

GAS GATE

WATER CURB STOP

WATER GATE FIRE HYDRANT

DRAIN MANHOLE

CATCH BASIN SEWER MANHOLE

DUMPSTER

VERTICAL CONCRETE CURBING (REINFORCED) VERTICAL GRANITE CURBING

HANDICAP PARKING SPACE

BUILDING MOUNTED LIGHT

B BOLLARD

M MONITOR WELL

REFERENCES: ASSESSORS MAP 286 PARCELS 30 AND 31 DEED BOOK 38897 PAGE 557 CERTIFICATE NUMBER 209218

PLAN 19290B PLAN IN BOOK 1091 PAGE 108 PLAN 3334 OF 1913

OWNERS: 100 EAST CENTRAL STREET RE, LLC 110 EAST CENTRAL STREET RE, LLC 37 EAST CENTRAL STREET FRANKLIN, MASSACHUSETTS

APPLICANT: 110 EAST CENTRAL STREET RE, LLC 37 EAST CENTRAL STREET FRANKLIN, MASSACHUSETTS

SITE PLAN SITE LAYOUT PLAN 100 & 110 EAST CENTRAL STREET FRANKLIN, MASSACHUSETTS PREPARED FOR 110 EAST CENTRAL STREET RE, LLC 37 EAST CENTRAL STREET
FRANKLIN, MASSACHUSETTS
JANUARY 5, 2024
SCALE: 1" = 100'

(IN FEET) 1 inch = 20 ft.

REVIEW COMMENTS

DESCRIPTION

RRG

BY CARLOS A. QUINTAL P.E. #30812

1 2/26/24


NO. DATE

DATE INT. 7/23 | FIELD BY: FIELD BOOK PG# 1/24 CALCS BY: 1/24 DESIGNED BY: 1/24 DRAWN BY: 1/24 CHECKED BY:

T NITED INC. 850 FRANKLIN STREET SUITE 11D

508-384-6560 FAX 508-384-6566

JAN. 5, 2024 SCALE 1" = 20'PROJECT UC1587 SHEET WRENTHAM, MASSACHUSETTS 02093 3 of 10

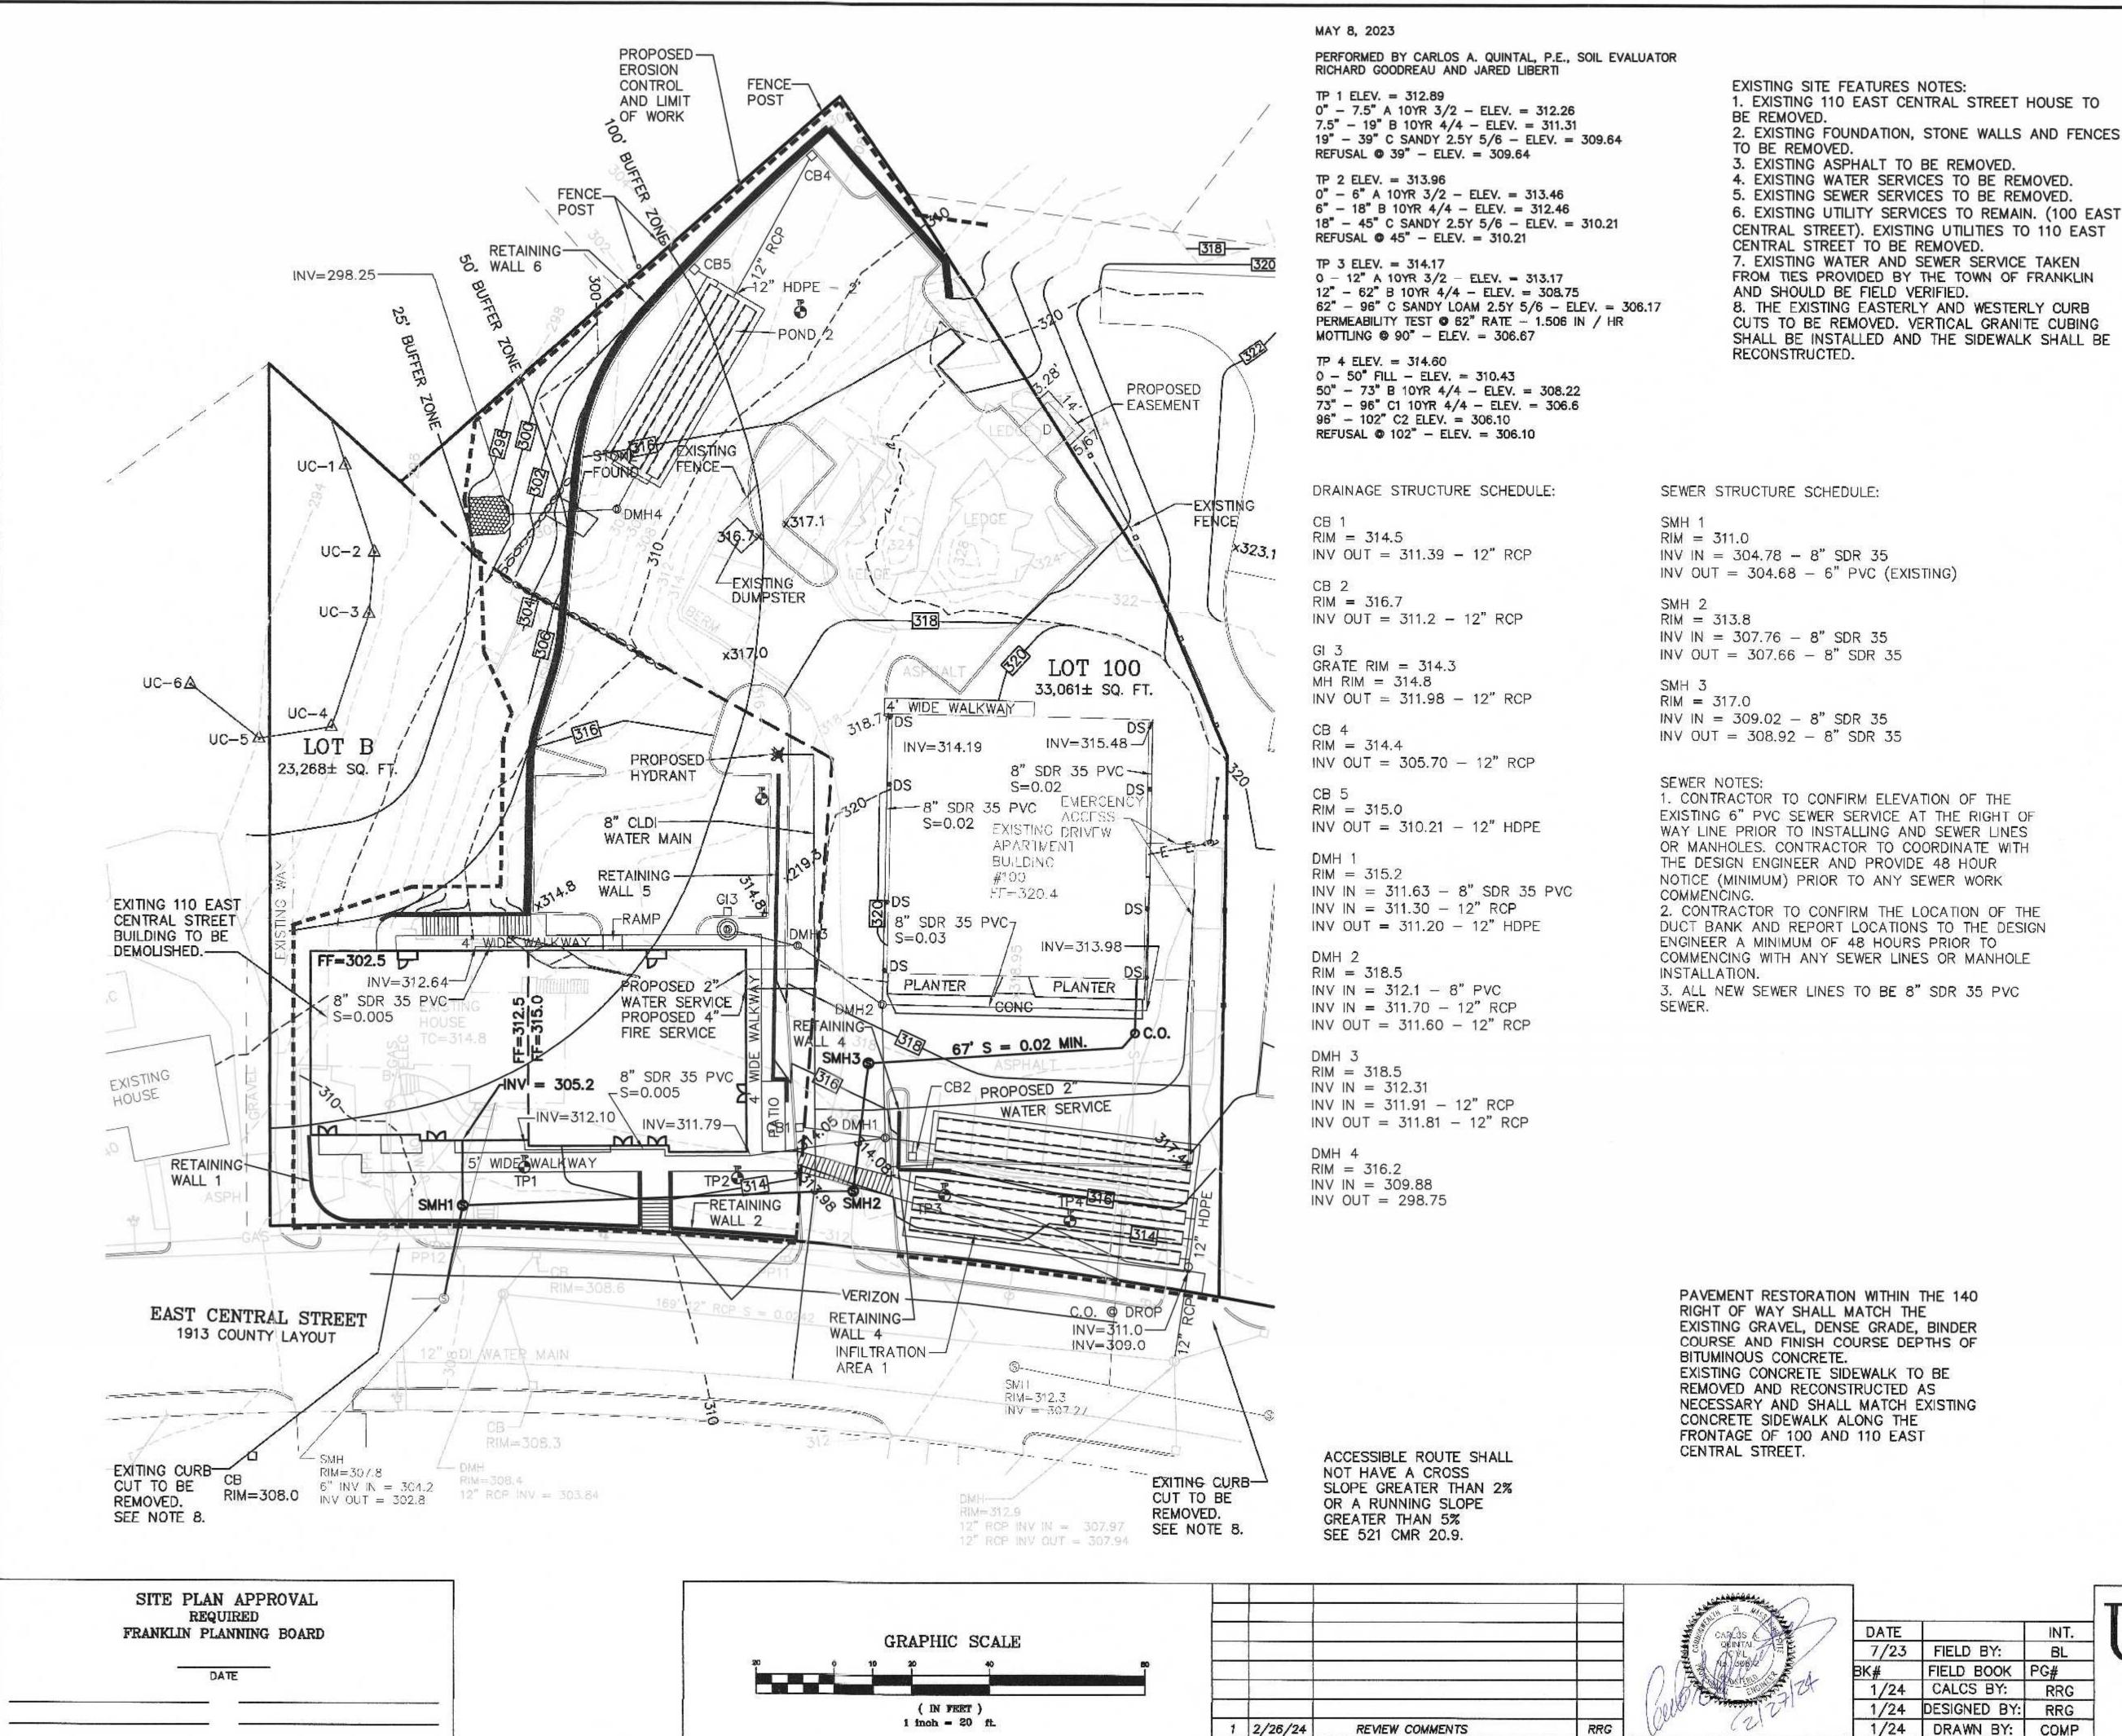

LEGEND:

EXISTING CONTOUR -297 → PROPOSED CONTOUR x274.3 SPOT GRADE - PROPOSED x274.3EX. SPOT GRADE - EXISTING

ABM EXIST. TREE - DIAMETER - SPECIES UTILITY POLE

> OVERHEAD WIRES GAS GATE

WATER CURB STOP WATER GATE FIRE HYDRANT

DRAIN MANHOLE CATCH BASIN SEWER MANHOLE

DUMPSTER

VERTICAL CONCRETE CURBING (REINFORCED) VERTICAL GRANITE CURBING

HANDICAP PARKING SPACE

BUILDING MOUNTED LIGHT

BOLLARD

MONITOR WELL

INV OUT = 304.68 - 6" PVC (EXISTING)

 CONTRACTOR TO CONFIRM ELEVATION OF THE EXISTING 6" PVC SEWER SERVICE AT THE RIGHT OF WAY LINE PRIOR TO INSTALLING AND SEWER LINES OR MANHOLES. CONTRACTOR TO COORDINATE WITH THE DESIGN ENGINEER AND PROVIDE 48 HOUR NOTICE (MINIMUM) PRIOR TO ANY SEWER WORK 2. CONTRACTOR TO CONFIRM THE LOCATION OF THE DUCT BANK AND REPORT LOCATIONS TO THE DESIGN

3. ALL NEW SEWER LINES TO BE 8" SDR 35 PVC

BUFFER ZONE DISTURBANCES:

0 - 25' BUFFER ZONE 0 - SQ. FT.

25' - 50' BUFFER ZONE 1,852 SQ. FT.

50' - 100' BUFFER ZONE 13,652, SQ. FT.

EXISTING WETLAND FLAGS WERE CONFIRMED BY UNITED CONSULTANTS, INC. AND WERE FIELD LOCATED ON JULY 17 AND 18 2023.

PAVEMENT RESTORATION WITHIN THE 140 RIGHT OF WAY SHALL MATCH THE EXISTING GRAVEL, DENSE GRADE, BINDER COURSE AND FINISH COURSE DEPTHS OF EXISTING CONCRETE SIDEWALK TO BE REMOVED AND RECONSTRUCTED AS NECESSARY AND SHALL MATCH EXISTING CONCRETE SIDEWALK ALONG THE FRONTAGE OF 100 AND 110 EAST

CARLOS A. QUINTAL P.E. #30812

NO. DATE

DESCRIPTION

SITE PLAN SITE GRADING AND UTILITY PLAN 100 & 110 EAST CENTRAL STREET FRANKLIN, MASSACHUSETTS PREPARED FOR

110 EAST CENTRAL STREET RE, LLC 37 EAST CENTRAL STREET FRANKLIN, MASSACHUSETTS JANUARY 5, 2024 SCALE: 1" = 100'

NITED ONSULTANTS INC.

INT.

BL


RRG


COMP

FIELD BOOK PG#

1/24 CHECKED BY:

JAN. 5, 2024 1" = 20'PROJECT UC1587 850 FRANKLIN STREET SUITE 11D SHEET WRENTHAM, MASSACHUSETTS 02093 508-384-6560 FAX 508-384-6566 4 of 10

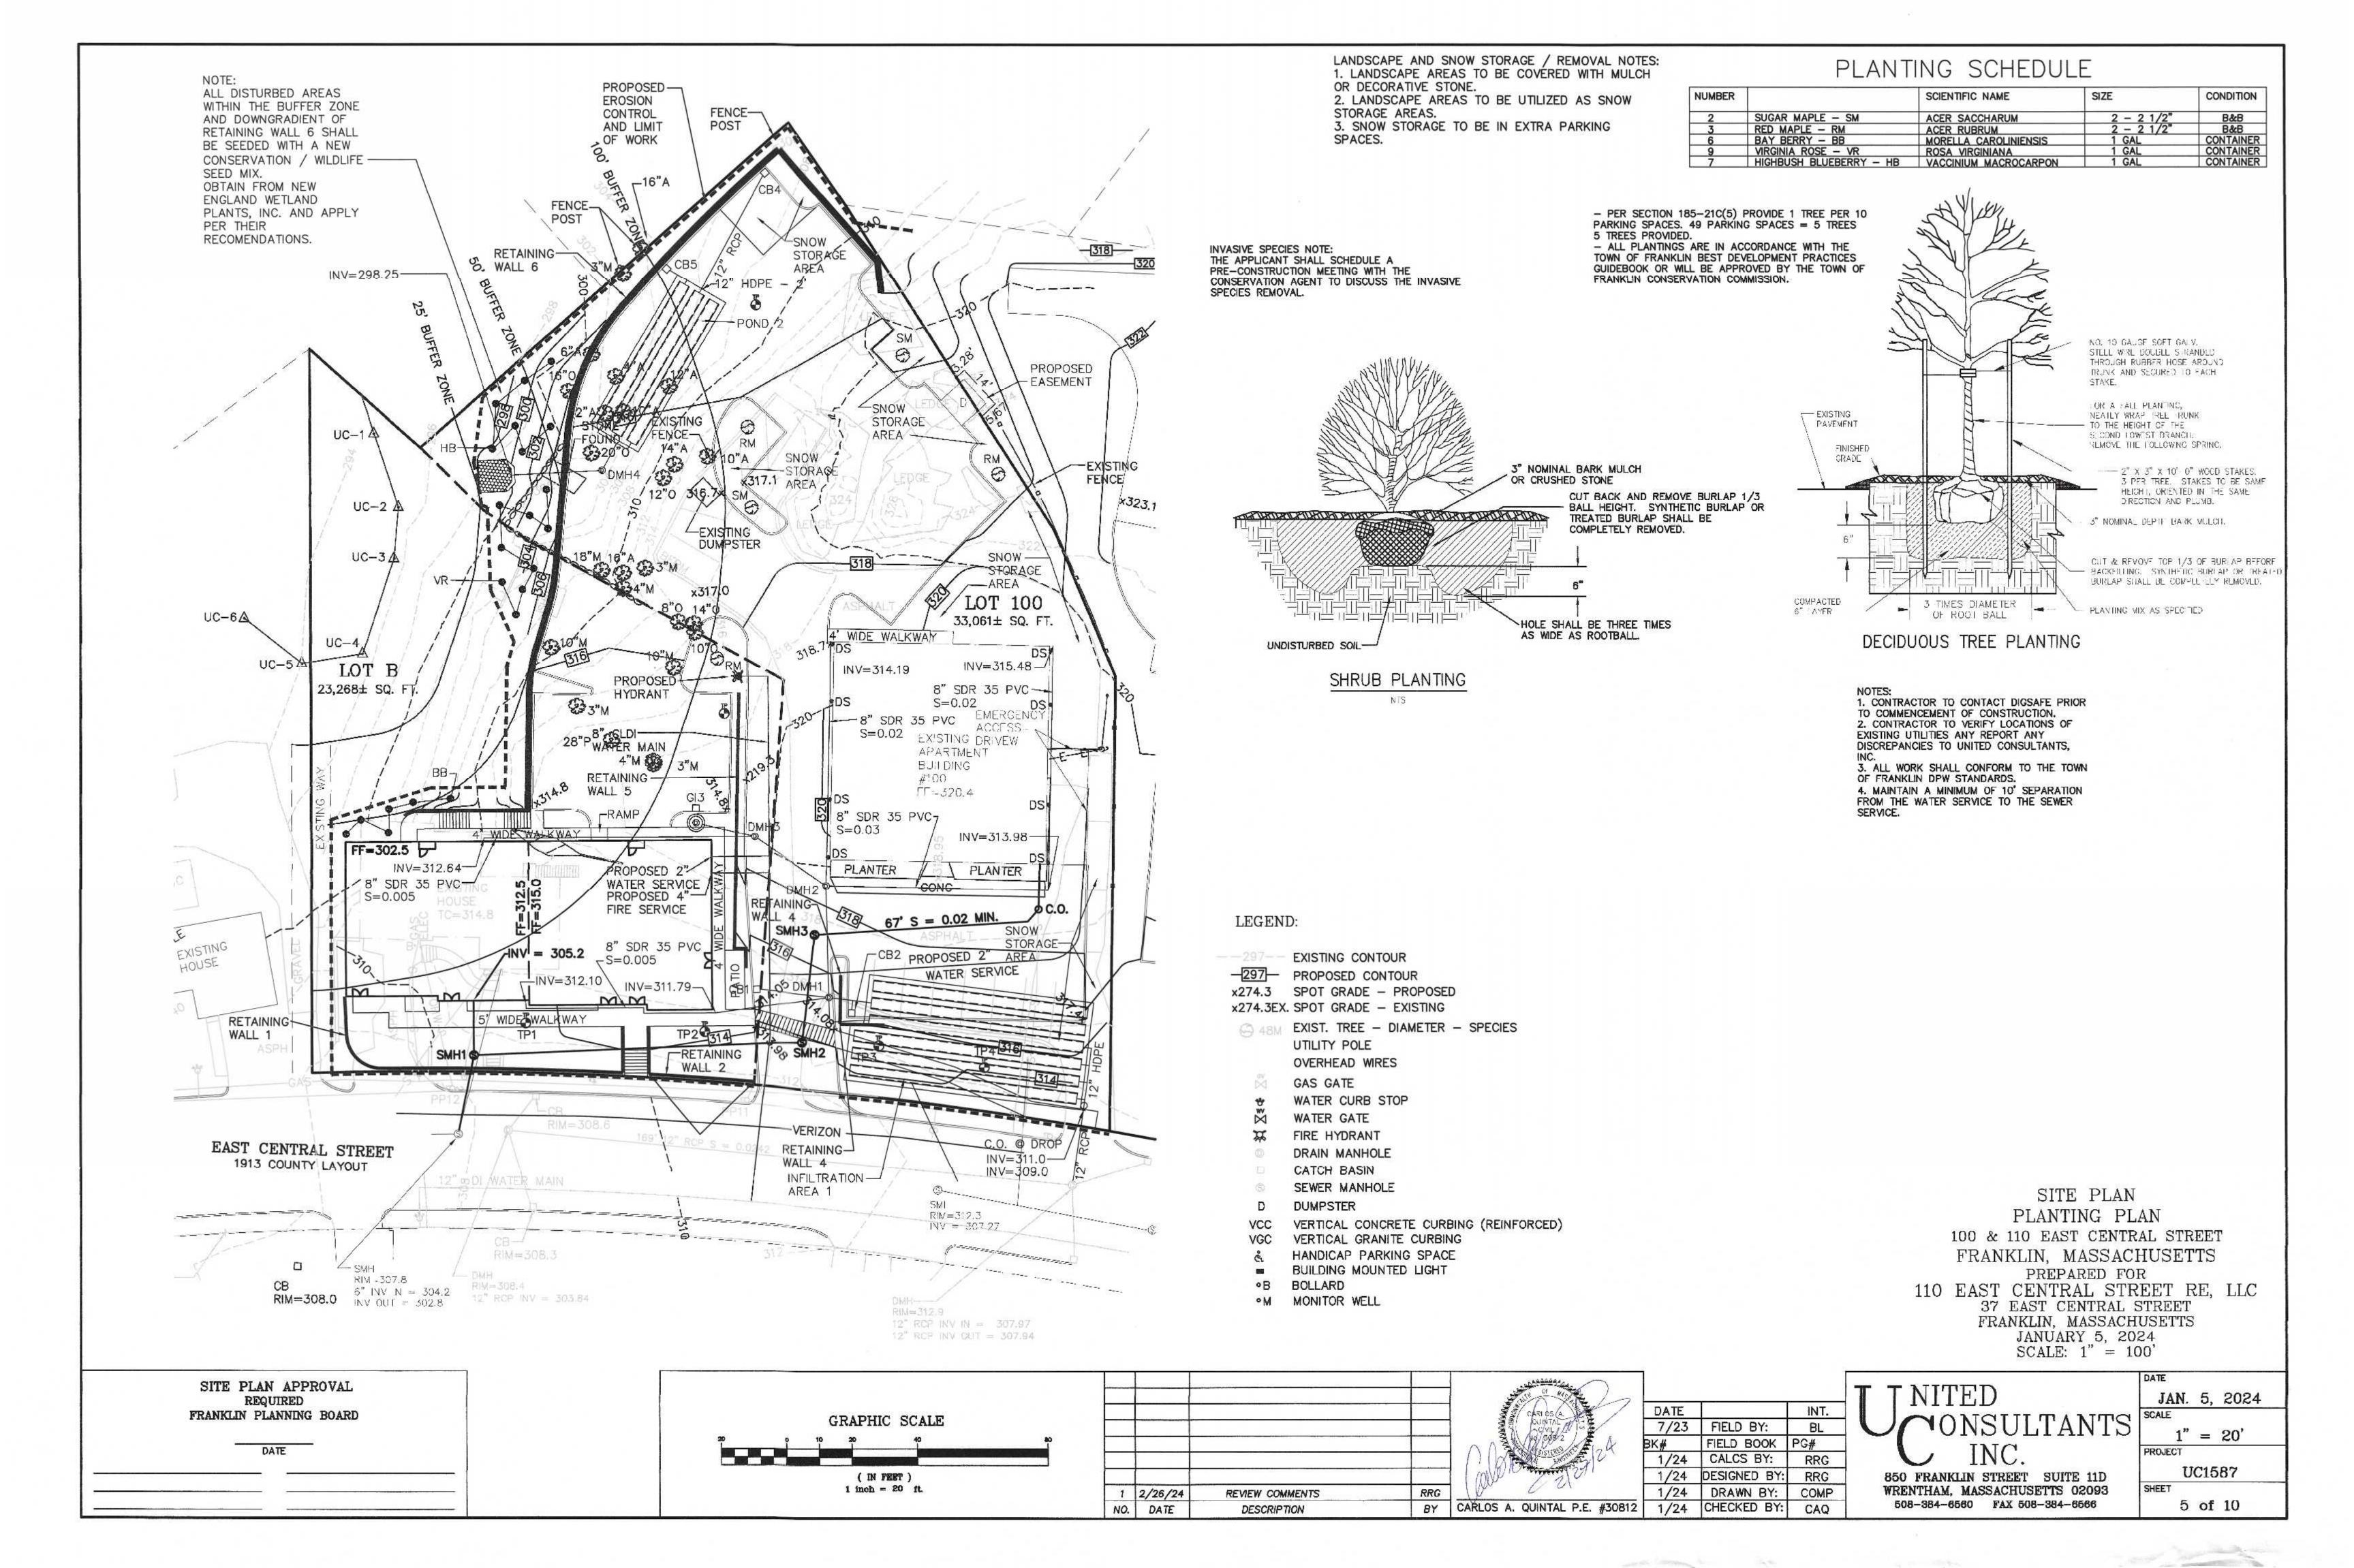

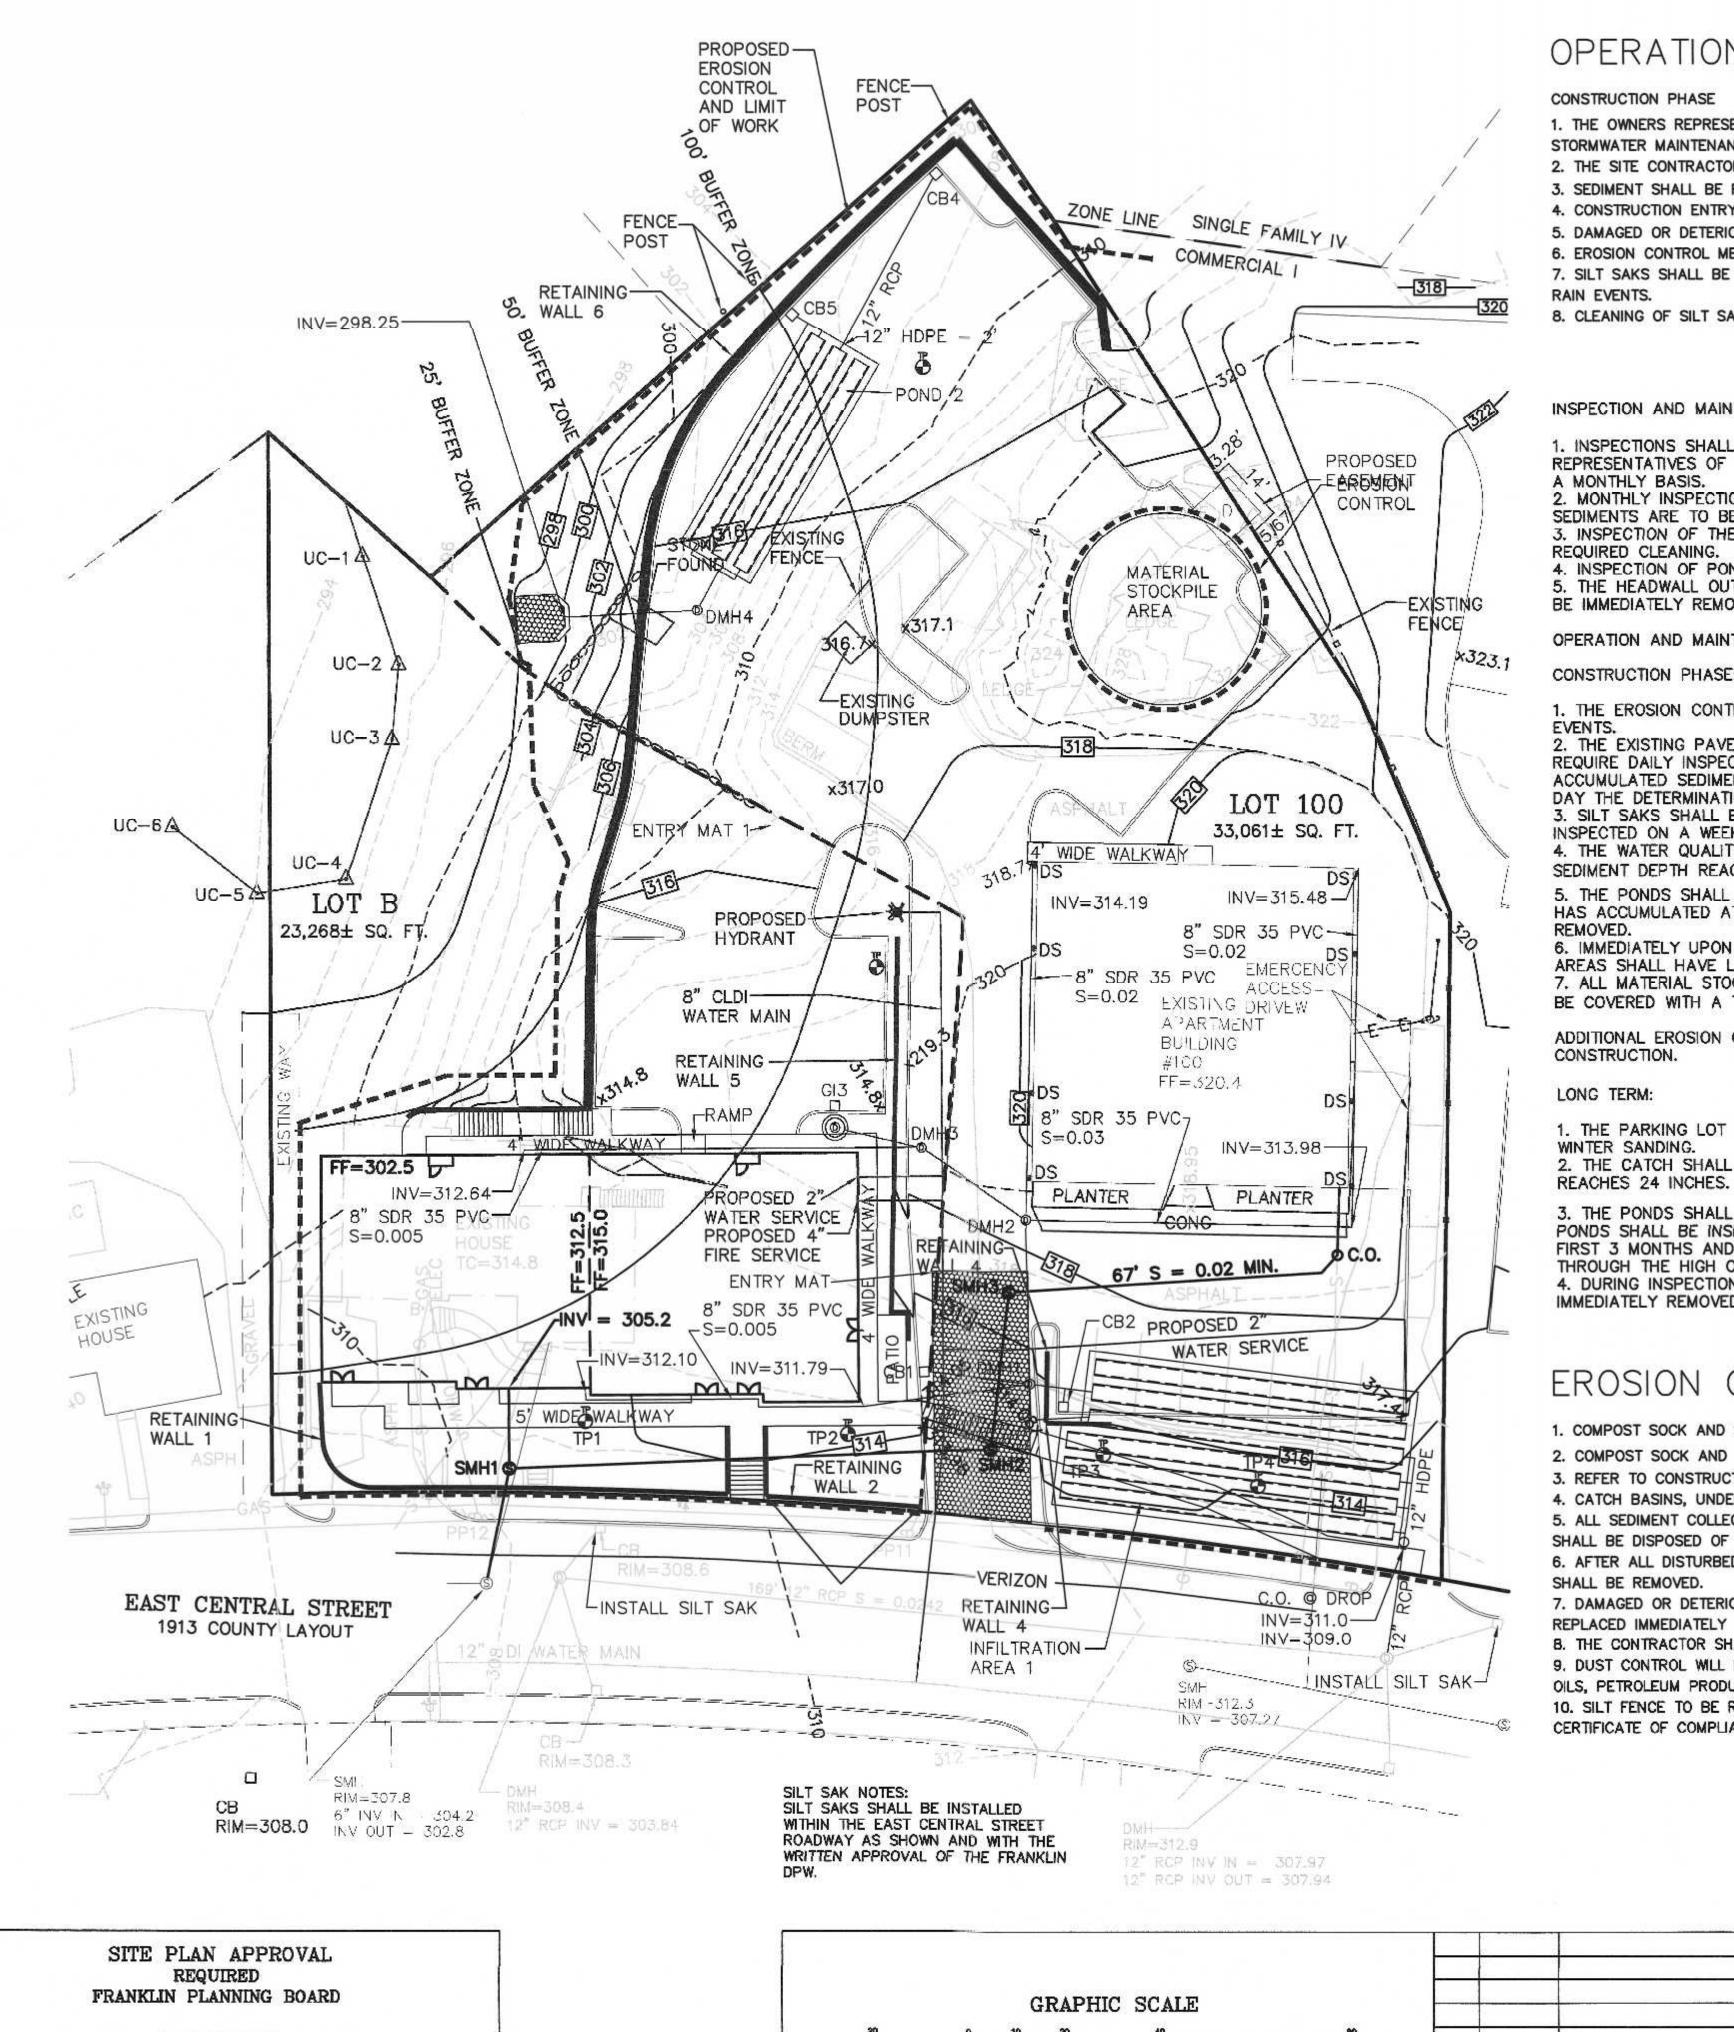

(IN FEET)

1 inch = 20 ft.

DATE

OPERATION AND MAINTENANCE PLAN

CONSTRUCTION PHASE

- 1. THE OWNERS REPRESENTATIVE, 110 EAST CENTRAL STREET RE, LLC 1-508-507-9020 SHALL BE THE RESPONSIBLE PARTY FOR THE STORMWATER MAINTENANCE PLAN.
- 2. THE SITE CONTRACTOR SHALL INSPECT ALL EROSION CONTROL MEASURES WEEKLY AND AFTER ALL RAIN EVENTS.
- 3. SEDIMENT SHALL BE REMOVED FROM COMPOST SOCK WHEN A MAXIMUM DEPTH OF 6" IS OBSERVED OR AS NEEDED.
- 4. CONSTRUCTION ENTRY MAT SHALL BE INSPECTED WEEKLY AND AFTER ALL RAIN EVENTS. SEE DETAIL FOR MAINTENANCE REQUIREMENTS.
- 5. DAMAGED OR DETERIORATED COMPOST SOCK AND/OR SILT FENCE AREAS SHALL BE REPLACED IMMEDIATELY. 6. EROSION CONTROL MEASURES SHALL REMAIN IN PLACE UNTIL CONSTRUCTION IS COMPLETED AND ALL DISTURBED AREAS ARE STABILIZED.
- 7. SILT SAKS SHALL BE INSTALLED AT ALL CATCH BASINS EXISTING AND PROPOSED AND SHALL BE INSPECTED WEEKLY AND AFTER ALL RAIN EVENTS.
- 8. CLEANING OF SILT SAKS SHALL BE COMPLETED AS NECESSARY.

INSPECTION AND MAINTENANCE SCHEDULE:

- 1. INSPECTIONS SHALL BE CONDUCTED BY THE APPLICANTS ENGINEER, CONTRACTOR AND / OR REPRESENTATIVES OF THE TOWN AS NECESSARY. AT A MINIMUM INSPECTIONS SHALL BE CONDUCTED ON A MONTHLY BASIS.
- 2. MONTHLY INSPECTIONS SHALL INCLUDE THE PARKING LOT SURFACE TO DETERMINE IF ACCUMULATED SEDIMENTS ARE TO BE REMOVED.
- 3. INSPECTION OF THE PROPOSED CATCH BASINS TO DETERMINE THE DEPTH OF SEDIMENT AND REQUIRED CLEANING.
- 4. INSPECTION OF PONDS 1 AND 2 TO DETERMINE IF CLEANING IS NECESSARY. 5. THE HEADWALL OUTLET RIPRAP SHALL BE INSPECTED WEEKLY AND ANY SEDIMENT OBSERVED SHALL BE IMMEDIATELY REMOVED.

OPERATION AND MAINTENANCE SCHEDULE

CONSTRUCTION PHASE:

- 1. THE EROSION CONTROL BARRIERS SHALL BE INSPECTED ON A WEEKLY BASIS AND AFTER ALL STORM
- 2. THE EXISTING PAVED PARKING AREAS AS WELL THE PROPOSED PARKING AREA ONCE PAVED WILL REQUIRE DAILY INSPECTIONS TO BE CONDUCTED TO DETERMINE THE NECESSITY TO REMOVE ANY ACCUMULATED SEDIMENT. THE REMOVAL OF THE ACCUMULATED SEDIMENT SHALL BE COMPLETED ON THE DAY THE DETERMINATION IS MADE.
- 3. SILT SAKS SHALL BE INSTALLED AT ALL CATCH BASINS. SILT SAKS, ONCE INSTALLED SHALL BE INSPECTED ON A WEEKLY BASIS AND CLEANED AS NECESSARY.
- 4. THE WATER QUALITY UNIT SHALL BE INSPECTED ON A WEEKLY BASIS AND CLEANED WHEN THE SEDIMENT DEPTH REACHES 8"
- 5. THE PONDS SHALL BE INSPECTED AFTER EACH STORM EVENT AND CLEANED WHEN 2" OF SEDIMENT HAS ACCUMULATED AT THE INLET. ANY TRASH OR CONSTRUCTION DEBRIS SHALL BE IMMEDIATELY
- 6. IMMEDIATELY UPON COMPLETION OF SITE GRADING ACTIVITIES OF PROPOSED LANDSCAPED AREA, THE AREAS SHALL HAVE LOAM APPLIED AND SHALL BE SEEDED. 7. ALL MATERIAL STOCKPILES THAT ARE NOT BEING ACTIVELY USED FOR A PERIOD OF 2 WEEKS SHALL BE COVERED WITH A TARP(S) OR VEGETATED.

ADDITIONAL EROSION CONTROLS MAY BE REQUIRED DEPENDING ON ACTUAL FIELD CONDITIONS DURING CONSTRUCTION.

LONG TERM:

- 1. THE PARKING LOT SHALL BE SWEPT FOUR TIMES PER YEAR WITH ONE BEING AFTER THE LAST WINTER SANDING. 2. THE CATCH SHALL BE INSPECTED 4 TIMES PER YEAR AND SEDIMENT REMOVED WHEN THE DEPTH
- 3. THE PONDS SHALL BE INSPECTED AND PREVENTIVE MAINTENANCE PERFORMED TWICE PER YEAR. THE PONDS SHALL BE INSPECTED AFTER EVERY STORM EVENT EXCEEDING 1 INCH OF RAINFALL FOR THE FIRST 3 MONTHS AND THEN TWICE PER YEAR THEREAFTER AND WHEN THERE ARE DISCHARGES THROUGH THE HIGH OUTLET.
- 4. DURING INSPECTIONS OF STORM-WATER FACILITIES ANY TRASH OR DEBRIS DISCOVERED SHALL BE IMMEDIATELY REMOVED.

EROSION CONTROL NOTES:

- 1. COMPOST SOCK AND SILT FENCE SHALL BE INSTALLED PRIOR TO TREE CLEARING OR SITE WORK COMMENCING.
- 2. COMPOST SOCK AND SILT FENCE TO REMAIN IN CONTACT WITH THE EARTH. REPAIR OR RESET AS NECESSARY.
- 3. REFER TO CONSTRUCTION SEQUENCE FOR SLOPE GREATER THAN 3' HORIZONTAL TO 1' VERTICAL.
- 4. CATCH BASINS, UNDERGROUND POND AND PARKING AREA TO BE CLEANED ONCE CONSTRUCTION IS COMPLETED. 5. ALL SEDIMENT COLLECTED DURING THE CONSTRUCTION PHASE OR POST CONSTRUCTION PHASE
- SHALL BE DISPOSED OF TO AN APPROVED LOCATION.
- 6. AFTER ALL DISTURBED AREAS HAVE BEEN STABILIZED THE EROSION CONTROL MEASURES SHALL BE REMOVED.

RRG

CARLOS A. QUINTAL P.E. #30812

REVIEW COMMENTS

DESCRIPTION

1 2/26/24

NO. DATE

- 7. DAMAGED OR DETERIORATED EROSION CONTROL MEASURES SHALL BE REPAIRED OR
- REPLACED IMMEDIATELY AFTER THEY HAVE BEEN IDENTIFIED. B. THE CONTRACTOR SHALL BE RESPONSIBLE FOR ALL INSPECTIONS.
- 9, DUST CONTROL WILL BE BY SPRAYING WATER AS NECESSARY. THE USE OF
- OILS, PETROLEUM PRODUCTS OR TOXIC LIQUIDS FOR DUST CONTROL IS PROHIBITED.
- 10. SILT FENCE TO BE REMOVED AT THE APPROVAL OF THE CONSERVATION AGENT, PRIOR TO THE ISSUANCE OF A CERTIFICATE OF COMPLIANCE.

LEGEND:

297 EXISTING CONTOUR

-297- PROPOSED CONTOUR

x274.3 SPOT GRADE - PROPOSED x274.3EX. SPOT GRADE - EXISTING

ABM EXIST. TREE - DIAMETER - SPECIES

UTILITY POLE

OVERHEAD WIRES

GAS GATE

WATER CURB STOP

WATER GATE

FIRE HYDRANT

DRAIN MANHOLE

CATCH BASIN

SEWER MANHOLE

DUMPSTER VERTICAL CONCRETE CURBING (REINFORCED)

VERTICAL GRANITE CURBING

HANDICAP PARKING SPACE


BUILDING MOUNTED LIGHT

BOLLARD

MONITOR WELL

CONSTRUCTION SEQUENCE:

- INSTALL EROSION CONTROL AND SIGN.
- 2. COMPLETE TREE CLEARING, STUMP REMOVAL AND REMOVE LOAM AND
- 3.REMOVE EXISTING UTILITIES AND RAZE EXISTING 110 EAST CENTRAL
- STREET BUILDING.
- 4. EXCAVATE THE FOUNDATION HOLE, FORM AND POUR THE FOUNDATION AND THEN BACKFILL FOUNDATION.
- 5. INSTALL SITE UTILITIES. THE STORMWATER SYSTEM SHALL BE INSTALLED WITH EXCESS MATERIAL BEING REMOVED FROM THE SITE AND NECESSARY CONSTRUCTION MATERIALS DELIVERED TO THE SITE. MINIMIZE THE USE OF THE MATERIAL STOCKPILE AREA.
- CONSTRUCT RETAINING WALLS.
- 7. BRING THE SITE TO SUB GRADE.
- 8. INSTALL A BINDER COURSE OF PAVING. CONSTRUCT THE SITE WALKWAYS. 9. CURBING SHALL BE INSTALLED.
- 10. LANDSCAPING SHALL BE PLANTED AND ALL REMAINING DISTURBED
- AREAS SHALL BE LOAMED AND SEEDED.

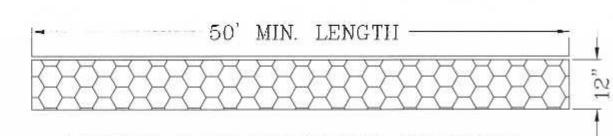

ENTRY SEDIMENTATION CONTROL MAT SECTION

N.T.S.

1. PAD SHALL BE A MINIMUM OF 20 FEET IN WIDTH. EXISTING ASPHALT DRIVE TO REMAIN IN PLACE UNTIL FINAL PAVEMENT IS TO 2. PAD SHALL CONSIST OF 4" STONE 8" MIN. DEPTH AND THEN TOP DRESSED WITH 4" OF 1" - 2" WASHED STONE.

> SITE PLAN EROSION CONTROL PLAN 100 & 110 EAST CENTRAL STREET FRANKLIN, MASSACHUSETTS PREPARED FOR 110 EAST CENTRAL STREET RE, LLC

37 EAST CENTRAL STREET FRANKLIN, MASSACHUSETTS JANUARY 5, 2024 SCALE: 1" = 100'

NITED ONSULTANTS INC.

INT.

RRG

DATE

7/23 | FIELD BY:

1/24 CALCS BY:

1/24 DESIGNED BY: RRG

1/24 | DRAWN BY: | COMP

1/24 | CHECKED BY: | CAQ

| FIELD BOOK | PG#

JAN. 5, 2024 1" = 20'PROJECT UC1587 SHEET

6 of 10

850 FRANKLIN STREET SUITE 11D WRENTHAM, MASSACHUSETTS 02093 508-384-6560 FAX 508-384-6566

