TOWN OF FRANKLIN TOWN CLERK

SITE PLAN 100 AND 110 EAST CENTRAL STREET

2024 JAN 16 A 11: 13

RECEIVED



WAIVER REQUESTS:


1. TO ALLOW THE USE OF PVC AND HPDE PIPE FOR THE ROOF DRAINS AND UNDERGROUND STORMWATER STORAGE AREA.


2. TO ALLOW SITE LIGHTING TO EXTEND PAST THE PROPERTY

- ALL EROSION CONTROL MITIGATION MEASURES SHALL BE IN PLACE PRIOR TO MAJOR CONSTRUCTION OR SOIL DISTURBANCE COMMENCING ON THE SITE.

SITE PLAN APPROVAL REQUIRED FRANKLIN PLANNING BOARD

DATE

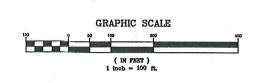

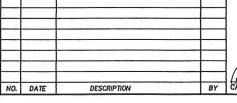



	INT.		TE
1	BL	FIELD BY:	23
	PG#	FIELD BOOK	
	RRG	CALCS BY:	24
	RRG	DESIGNED BY:	24
	COMP	DRAWN BY:	24
	CAQ	CHECKED BY:	24

THE 122 AND 138 EAST CENTRAL STREET PROPERTIES ARE LOCATED WITHIN A COMMERCIAL I ZONE.

	REQUIREMENTS:	EXISTING	PROPOSED
AREA:	5.000 S.F.	56,329± S.F.	56,329± S.F.
FRONTAGE:	50'	245.1	245.1
DEPTH:	50'	176.5'	176.5'
HEIGHT:	3 STORIES - 40' *15	2 STORIES	3 STORIES < 40'
WDTH: SETBACKS	45'	> 45'	> 45'
FRONT:	20' *1	31.3'	20.5'
SIDE WEST:	10' *14	15.0'	15.0'
SIDE EAST:	10' *14	14.7'	10.4
REAR: COVERAGE	15'	114.5'	120.4
STRUCTURES:	80%	11.7%	18.2%
STRUC. & PAVI	IG: 90%	34.1%	64.9%

LOT COVERAGE BASED ON UPLAND AREA. **REFER TO ARCHITECTURAL PLANS FOR BUILDING HEIGHT.

***I - BUT NO NEW STRUCTURE SHALL BE REQUIRED TO PROVIDE A DEEPER YARD THAN EXISTED ON THAT PARCEL UPON ADOPTION OF THIS AMENDMENT.
*14 - THE 10-FOOT SIDE SETBACK IS ONLY REQUIRED ON ONE SIDE OF THE LOT; IF LOT ABUTS A RESIDENTIAL DISTRICT, A 20-FOOT SETBACK IS REQUIRED ON THE ABUTTING SIDE.
*15 - BUILDINGS UP TO 50 FEET IN HEIGHT, REGARDLESS OF THE NUMBER OF STORIES, MAY BE PERMITTED BY A SPECIAL PERMIT FROM THE PLANNING BOARD.

REQUIREMENTS FOR 100 AND 110 EAST CENTRAL STREET ZONE COMMERCIAL 1
EXISTING AND PROPOSED LOT AREA, FRONTAGE, DEPTH, WIDTH AND COVERAGE BASED
ON THE LOTS BEING COMBINED.
BUILDING HEIGHT, AND SETBACKS BASED ON EXISTING AND PROPOSED BUILDINGS
LOCATED ON 100 AND 110 EAST CENTRAL STREET.
PROPERTY IS NOT LOCATED WITHIN A FRANKLIN WATER RESOURCE DISTRICT.
THE PROPERTY IS LOCATED IN A ZONE C BASED ON FEMA FIRM MAP 2502100309E
DATED JULY 17, 2012.

DRAWING INDEX:

- 1. COVER SHEET
- 2. EXISTING CONDITIONS PLAN
 3. SITE LAYOUT PLAN
- 4. SITE GRADING AND UTILITY PLAN
- 5. PLANTING PLAN
- 6. EROSION CONTROL PLAN
 7. CONSTRUCTION DETAILS 1
 8. CONSTRUCTION DETAILS 2
- 9. CONSTRUCTION DETAILS 3 10. CONSTRUCTION DETAILS - 4 SITE LIGHTING-LIGHTING PLAN, PHOTOMETRICS AND SCHEDULES

BY SK & ACCOCIATES

REFERENCES:
ASSESSORS MAP 286 PARCELS 30 AND 31
DEED BOOK 38897 PAGE 557
CERTIFICATE NUMBER 209218

PLAN 19290B PLAN IN BOOK 1091 PAGE 108 PLAN 3334 OF 1913

OWNERS: 100 EAST CENTRAL STREET RE, LLC 110 EAST CENTRAL STREET RE, LLC 37 EAST CENTRAL STREET FRANKLIN, MASSACHUSETTS

APPLICANT: 110 EAST CENTRAL STREET RE, LLC 37 EAST CENTRAL STREET FRANKLIN, MASSACHUSETTS


SITE PLAN COVER SHEET 100 & 110 EAST CENTRAL STREET FRANKLIN, MASSACHUSETTS PRANKLIN, MASSACHUSETTS
PREPARED FOR


110 EAST CENTRAL STREET RE, LLC
37 EAST CENTRAL STREET
FRANKLIN, MASSACHUSETTS
JANUARY 5, 2024
SCALE: 1" = 100'


T NITED ONSULTANTS INC.

850 FRANKLIN STREET SUITE 11D WRENTHAM, MASSACHUSETTS 02093 508-384-6560 FAX 508-384-6566

JAN. 5, 2024 1" = 100' PROJECT UC1587 1 of 10

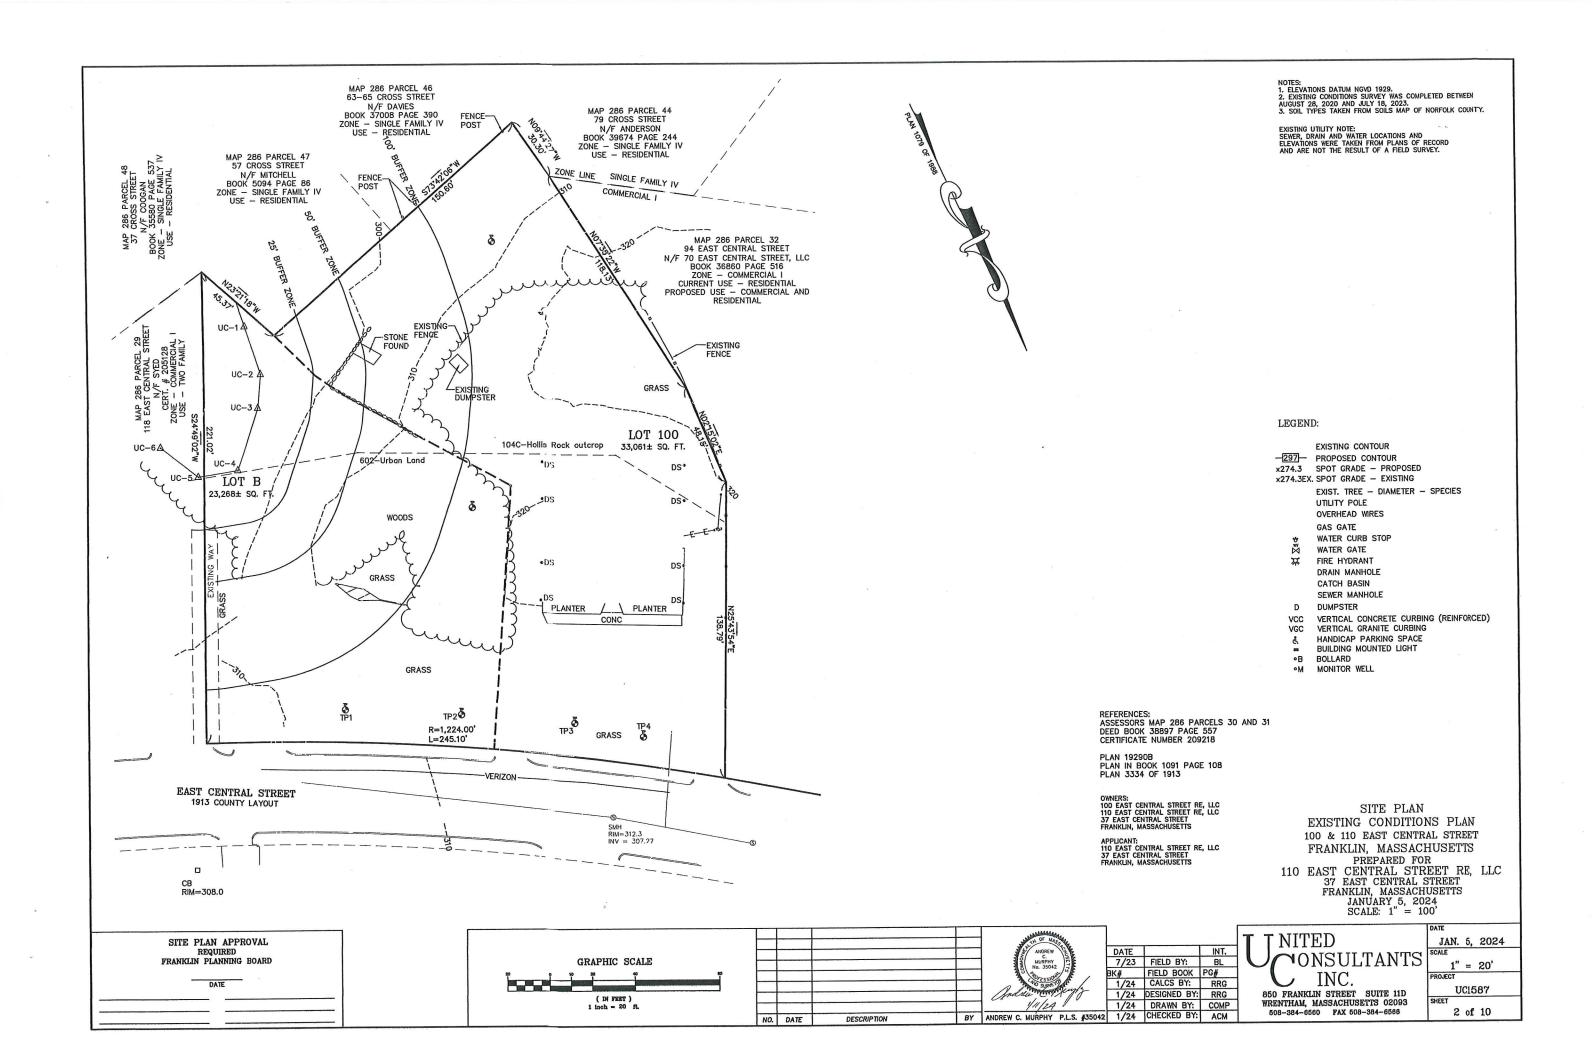

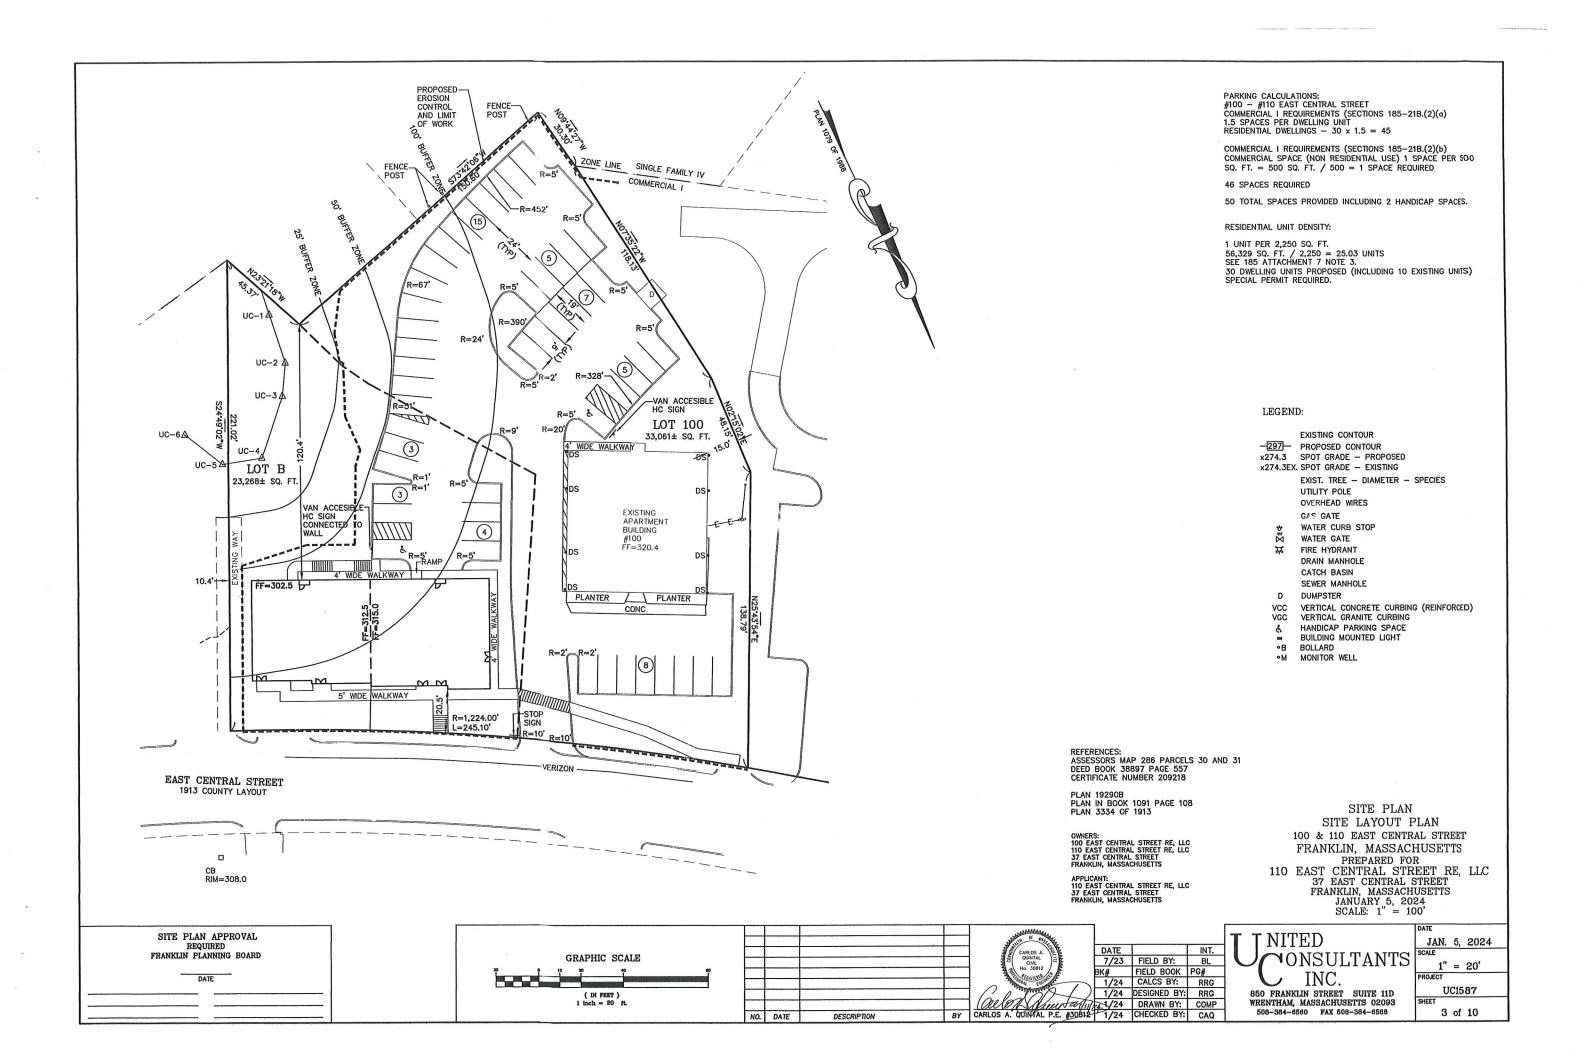


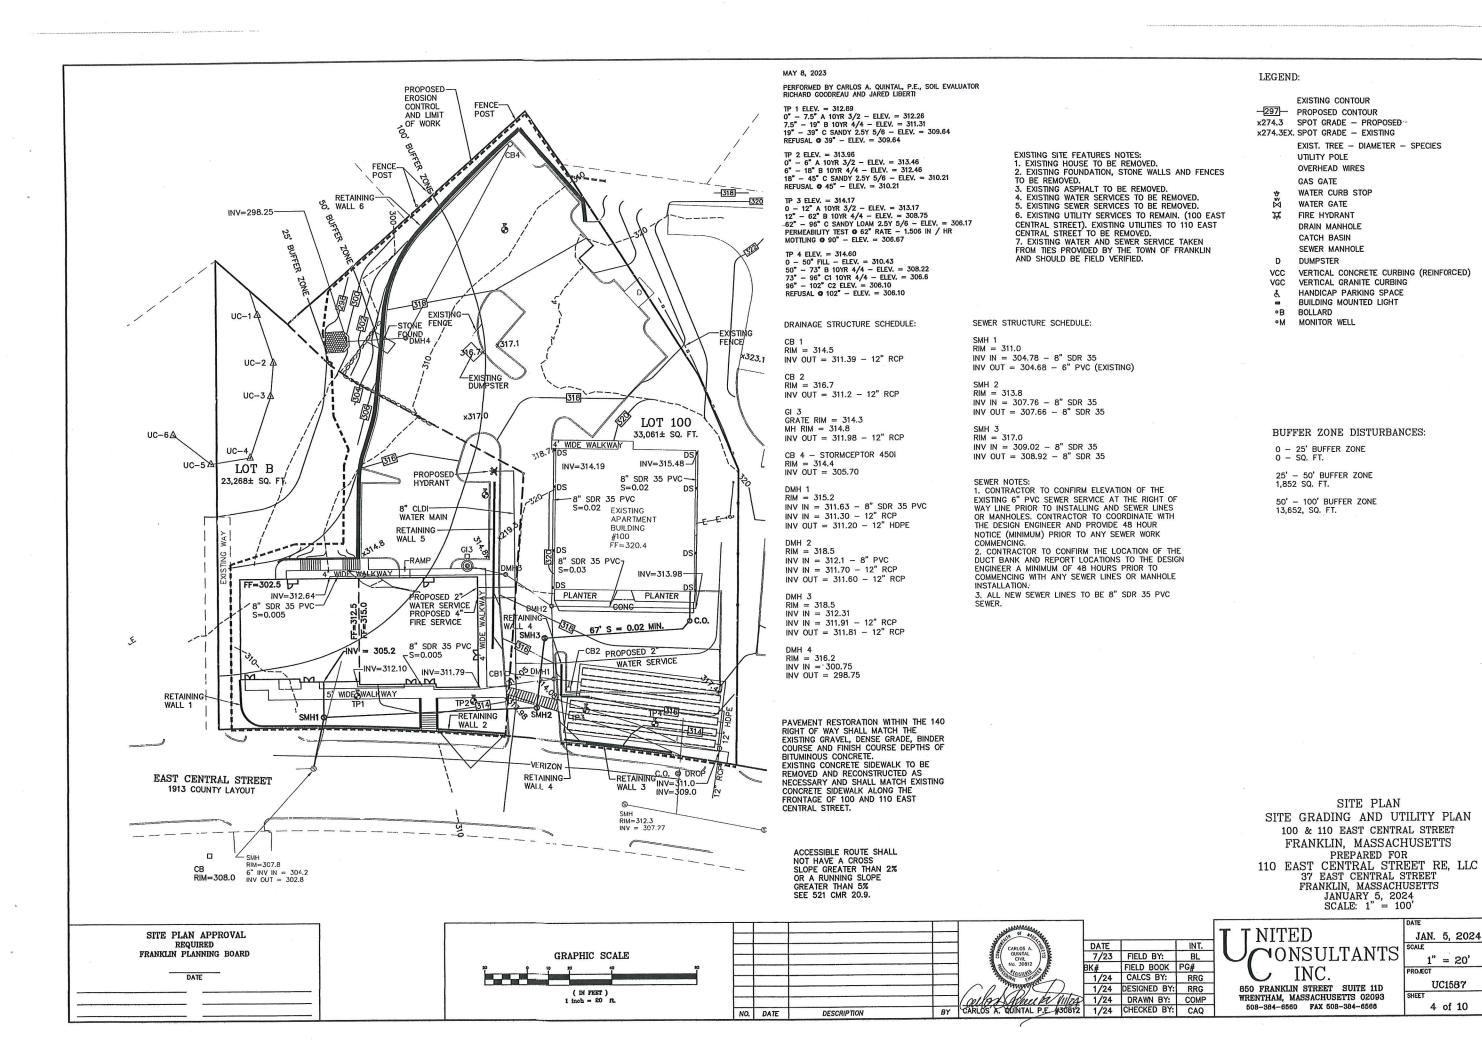

JAN. 5, 2024

UC1587

4 of 10

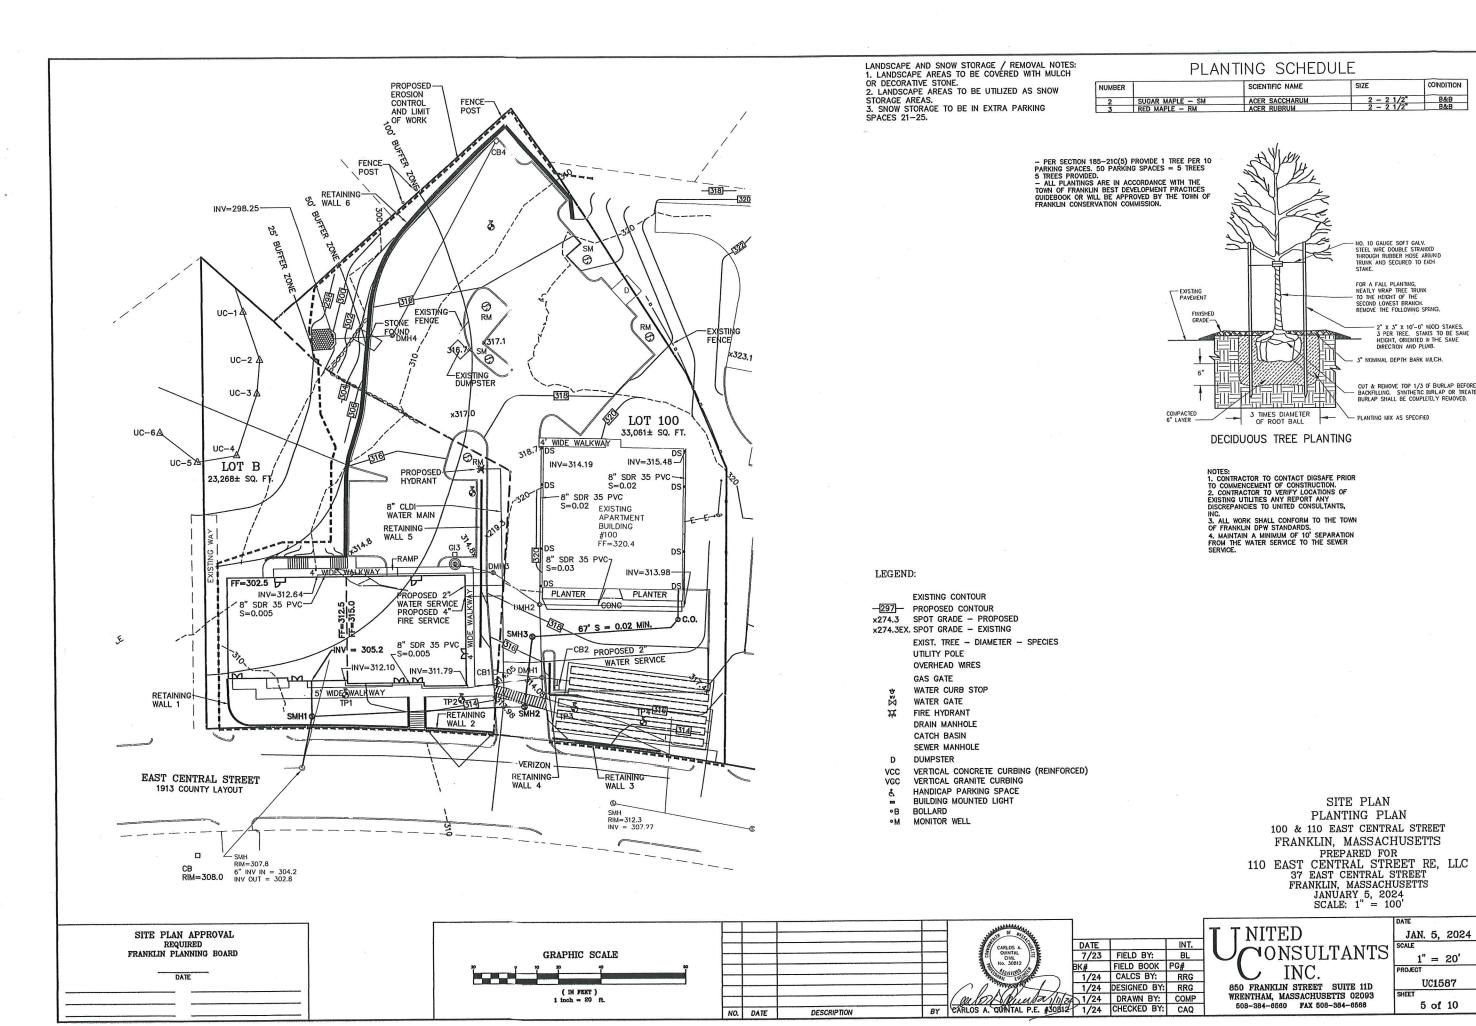


MOLLIGMON

1" = 20'

UC1587

5 of 10

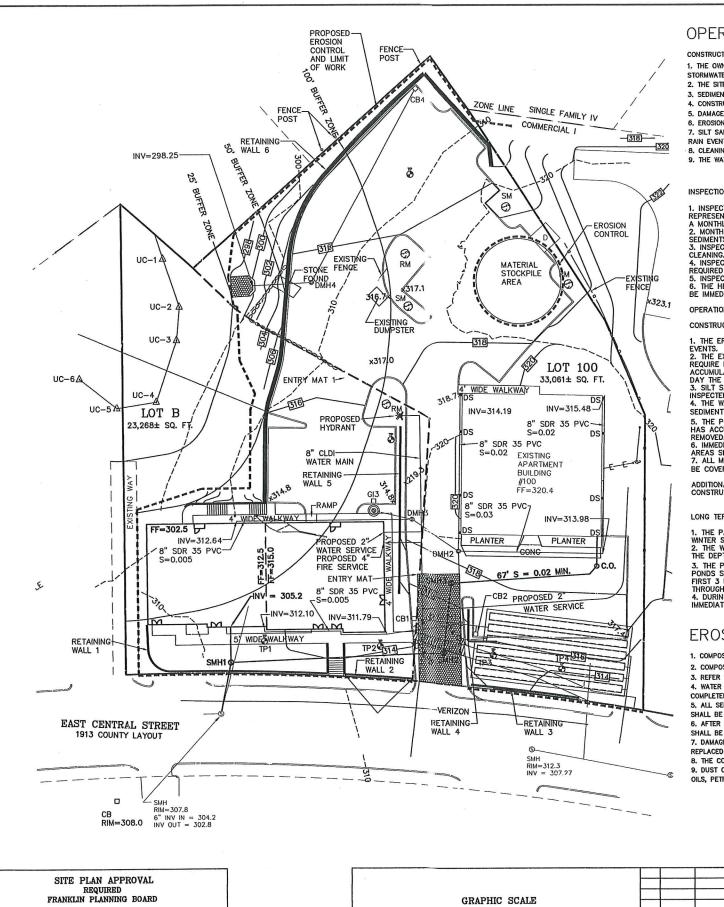

(IN FEET) 1 inch = 20 ft.

DATE

OPERATION AND MAINTENANCE PLAN

CONSTRUCTION PHASE

- 1. THE OWNERS REPRESENTATIVE, 110 EAST CENTRAL STREET RE, LLC 1-508-507-9020 SHALL BE THE RESPONSIBLE PARTY FOR THE STORMWATER MAINTENANCE PLAN.
- 2. THE SITE CONTRACTOR SHALL INSPECT ALL EROSION CONTROL MEASURES WEEKLY AND AFTER ALL RAIN EVENTS.
- 3. SEDIMENT SHALL BE REMOVED FROM COMPOST SOCK WHEN A MAXIMUM DEPTH OF 6" IS OBSERVED OR AS NEEDED.
- 4. CONSTRUCTION ENTRY MAT SHALL BE INSPECTED WEEKLY AND AFTER ALL RAIN EVENTS. SEE DETAIL FOR MAINTENANCE REQUIREMENTS. 5. DAMAGED OR DETERIORATED COMPOST SOCK AND/OR SILT FENCE AREAS SHALL BE REPLACED IMMEDIATELY.
- 6. EROSION CONTROL MEASURES SHALL REMAIN IN PLACE UNTIL CONSTRUCTION IS COMPLETED AND ALL DISTURBED AREAS ARE STABILIZED. 7. SILT SAKS SHALL BE INSTALLED AT ALL CATCH BASINS EXISTING AND PROPOSED AND SHALL BE INSPECTED WEEKLY AND AFTER ALL
- RAIN EVENTS.
- 8. CLEANING OF SILT SAKS SHALL BE COMPLETED AS NECESSARY.
- 9. THE WATER QUALITY UNIT SHALL BE CLEANED WITH A VACUUM TRUCK.

INSPECTION AND MAINTENANCE SCHEDULE:

- 1. INSPECTIONS SHALL BE CONDUCTED BY THE APPLICANTS ENGINEER, CONTRACTOR AND / OR REPRESENTATIVES OF THE TOWN AS NECESSARY. AT A MINIMUM INSPECTIONS SHALL BE CONDUCTED ON
- A MONTHLY BASIS.

 2. MONTHLY INSPECTIONS SHALL INCLUDE THE PARKING LOT SURFACE TO DETERMINE IF ACCUMULATED SEDIMENTS ARE TO BE REMOVED.

 3. INSPECTIONS OF THE WATER QUALITY UNIT TO DETERMINE DEPTH OF SEDIMENT AND REQUIRED

- CLEANING.
 4. INSPECTION OF THE PROPOSED CATCH BASINS TO DETERMINE THE DEPTH OF SEDIMENT AND REQUIRED CLEANING.
 5. INSPECTION OF POND 1 TO DETERMINE IF CLEANING IS NECESSARY.
 6. THE HEADWALL OUTLET RIPRAP SHALL BE INSPECTED WEEKLY AND ANY SEDIMENT OBSERVED SHALL.

BE IMMEDIATELY REMOVED.

OPERATION AND MAINTENANCE SCHEDULE

CONSTRUCTION PHASE:

- . THE EROSION CONTROL BARRIERS SHALL BE INSPECTED ON A WEEKLY BASIS AND AFTER ALL STORM
- EVENTS.
 2. THE EXISTING PAVED PARKING AREAS AS WELL THE PROPOSED PARKING AREA ONCE PAVED WILL REQUIRE DAILY INSPECTIONS TO BE CONDUCTED TO DETERMINE THE NECESSITY TO REMOVE ANY ACCUMULATED SEDIMENT. THE REMOVAL OF THE ACCUMULATED SEDIMENT SHALL BE COMPLETED ON THE DAY THE DETERMINATION IS MADE.

 3. SILT SAKS SHALL BE INSTALLED AT ALL CATCH BASINS. SILT SAKS, ONCE INSTALLED SHALL BE INSPECTED ON A WEEKLY BASIS AND CLEANED AS NECESSARY.

 4. THE WATER QUALITY UNIT SHALL BE INSPECTED ON A WEEKLY BASIS AND CLEANED THE REPORTS OF THE WATER QUALITY UNIT SHALL BE INSPECTED ON A WEEKLY BASIS AND CLEANED AS NECESSARY.

- 5. THE POND SHALL BE INSPECTED AFTER EACH STORM EVENT AND CLEANED WHEN 2" OF SEDIMENT HAS ACCUMULATED AT THE INLET. ANY TRASH OR CONSTRUCTION DEBRIS SHALL BE IMMEDIATELY
- REMOVED.

 6. IMMEDIATELY UPON COMPLETION OF SITE GRADING ACTIVITIES OF PROPOSED LANDSCAPED AREA, THE AREAS SHALL HAVE LOAM APPLIED AND SHALL BE SEEDED.

 7. ALL MATERIAL STOCKPILES THAT ARE NOT BEING ACTIVELY USED FOR A PERIOD OF 2 WEEKS SHALL BE COVERED WITH A TARP(S) OR VEGETATED.

ADDITIONAL EROSION CONTROLS MAY BE REQUIRED DEPENDING ON ACTUAL FIELD CONDITIONS DURING CONSTRUCTION.

- 1. THE PARKING LOT SHALL BE SWEPT FOUR TIMES PER YEAR WITH ONE BEING AFTER THE LAST
- 2. THE WATER QUALITY UNITS SHALL BE INSPECTED 4 TIMES PER YEAR AND SEDIMENT REMOVED WHEN 3. THE PONDS SHALL BE INSPECTED AND PREVENTIVE MAINTENANCE PERFORMED TMCE PER YEAR. THE
- 3. THE PONDS SHALL BE INSPECTED AFTER EVERY STORM EVENT EXCEEDING 1 INCH OF RAINFALL FOR THE FIRST 3 MONTHS AND THEN TWICE PER YEAR THEREAFTER AND WHEN THERE ARE DISCHARGES THROUGH THE HIGH OUTLET. 4. DURING INSPECTIONS OF STORM-WATER FACILITIES ANY TRASH OR DEBRIS DISCOVERED SHALL BE

EROSION CONTROL NOTES:

- 1. COMPOST SOCK AND SILT FENCE SHALL BE INSTALLED PRIOR TO TREE CLEARING OR SITE WORK COMMENCING.
- 2. COMPOST SOCK AND SILT FENCE TO REMAIN IN CONTACT WITH THE EARTH. REPAIR OR RESET AS NECESSARY.
- 3. REFER TO CONSTRUCTION SEQUENCE FOR SLOPE GREATER THAN 3' HORIZONTAL TO 1' VERTICAL.
- 4. WATER QUALITY UNITS, CATCH BASINS, UNDERGROUND POND AND PARKING AREA TO BE CLEANED ONCE CONSTRUCTION IS
- 5. ALL SEDIMENT COLLECTED DURING THE CONSTRUCTION PHASE OR POST CONSTRUCTION PHASE SHALL BE DISPOSED OF TO AN APPROVED LOCATION.
- 6. AFTER ALL DISTURBED AREAS HAVE BEEN STABILIZED THE EROSION CONTROL MEASURES
- SHALL BE REMOVED. 7. DAMAGED OR DETERIORATED EROSION CONTROL MEASURES SHALL BE REPAIRED OR

DESCRIPTION

NO. DATE

- REPLACED IMMEDIATELY AFTER THEY HAVE BEEN IDENTIFIED.
- B. THE CONTRACTOR SHALL BE RESPONSIBLE FOR ALL INSPECTIONS.
- 9. DUST CONTROL WILL BE BY SPRAYING WATER AS NECESSARY. THE USE OF
- OILS, PETROLEUM PRODUCTS OR TOXIC LIQUIDS FOR DUST CONTROL IS PROHIBITED.

LEGEND:

EXISTING CONTOUR

-297- PROPOSED CONTOUR x274.3 SPOT GRADE - PROPOSED x274.3EX. SPOT GRADE - EXISTING

> EXIST. TREE - DIAMETER - SPECIES UTILITY POLE


OVERHEAD WIRES

GAS GATE

- WATER CURB STOP
- WATER GATE FIRE HYDRANT
- DRAIN MANHOLE
- CATCH BASIN SEWER MANHOLE
- DUMPSTER
- VERTICAL CONCRETE CURBING (REINFORCED)
 VERTICAL GRANITE CURBING VCC
- HANDICAP PARKING SPACE
- BUILDING MOUNTED LIGHT
- BOLLARD
- MONITOR WELL

CONSTRUCTION SEQUENCE:

- 1. INSTALL EROSION CONTROL AND SIGN.
- 2. COMPLETE TREE CLEARING, STUMP REMOVAL AND REMOVE LOAM AND
- 3 REMOVE EXISTING UTILITIES AND RAZE EXISTING BUILDING.
- 4. EXCAVATE THE FOUNDATION HOLE, FORM AND POUR THE FOUNDATION AND THEN BACKFILL FOUNDATION.
- 5. INSTALL SITE UTILITIES. THE STORMWATER SYSTEM SHALL BE INSTALLED WITH EXCESS MATERIAL BEING REMOVED FROM THE SITE AND NECESSARY CONSTRUCTION MATERIALS DELIVERED TO THE SITE, MINIMIZE THE USE OF THE MATERIAL STOCKPILE AREA.
- 6. CONSTRUCT RETAINING WALLS.
- 7. BRING THE SITE TO SUB GRADE.
- 8. INSTALL A BINDER COURSE OF PAVING. CONSTRUCT THE SITE WALKWAYS. 9. CURRING SHALL BE INSTALLED.
- 10. LANDSCAPING SHALL BE PLANTED AND ALL REMAINING DISTURBED AREAS SHALL BE LOAMED AND SEEDED.

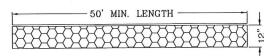

ENTRY SEDIMENTATION CONTROL MAT SECTION N.T.S.

NOTES: 1. PAD SHALL BE A MINIMUM OF 20 FEET IN WIDTH, EXISTING ASPHALT DRIVE TO REMAIN IN PLACE UNTIL FINAL PAVEMENT IS TO BE INSTALLED. 2. PAD SHALL CONSIST OF 4" STONE 8" MIN. DEPTH AND THEN TOP DRESSED WITH 4" OF 1" — 2" WASHED STONE.

> SITE PLAN EROSION CONTROL PLAN 100 & 110 EAST CENTRAL STREET FRANKLIN, MASSACHUSETTS PREPARED FOR
>
> 110 EAST CENTRAL STREET RE, LLC
>
> 37 EAST CENTRAL STREET
> FRANKLIN, MASSACHUSETTS JANUARY 5, 2024 SCALE: 1" = 100'

T NITED INT. 7/23 FIELD BY: BL 1/24 CALCS BY: RRG RRG

ONSULTANTS 850 FRANKLIN STREET SUITE 11D

WRENTHAM, MASSACHUSETTS 02093 508-384-6560 FAX 508-384-6566

1/24 DESIGNED BY:


Meuta III/2 1/24 DRAWN BY: COMP


CARLOS A. QUINTAL P.E. #30812 1/24 CHECKED BY:


UC1587 6 of 10


JAN. 5, 2024


1" = 20'

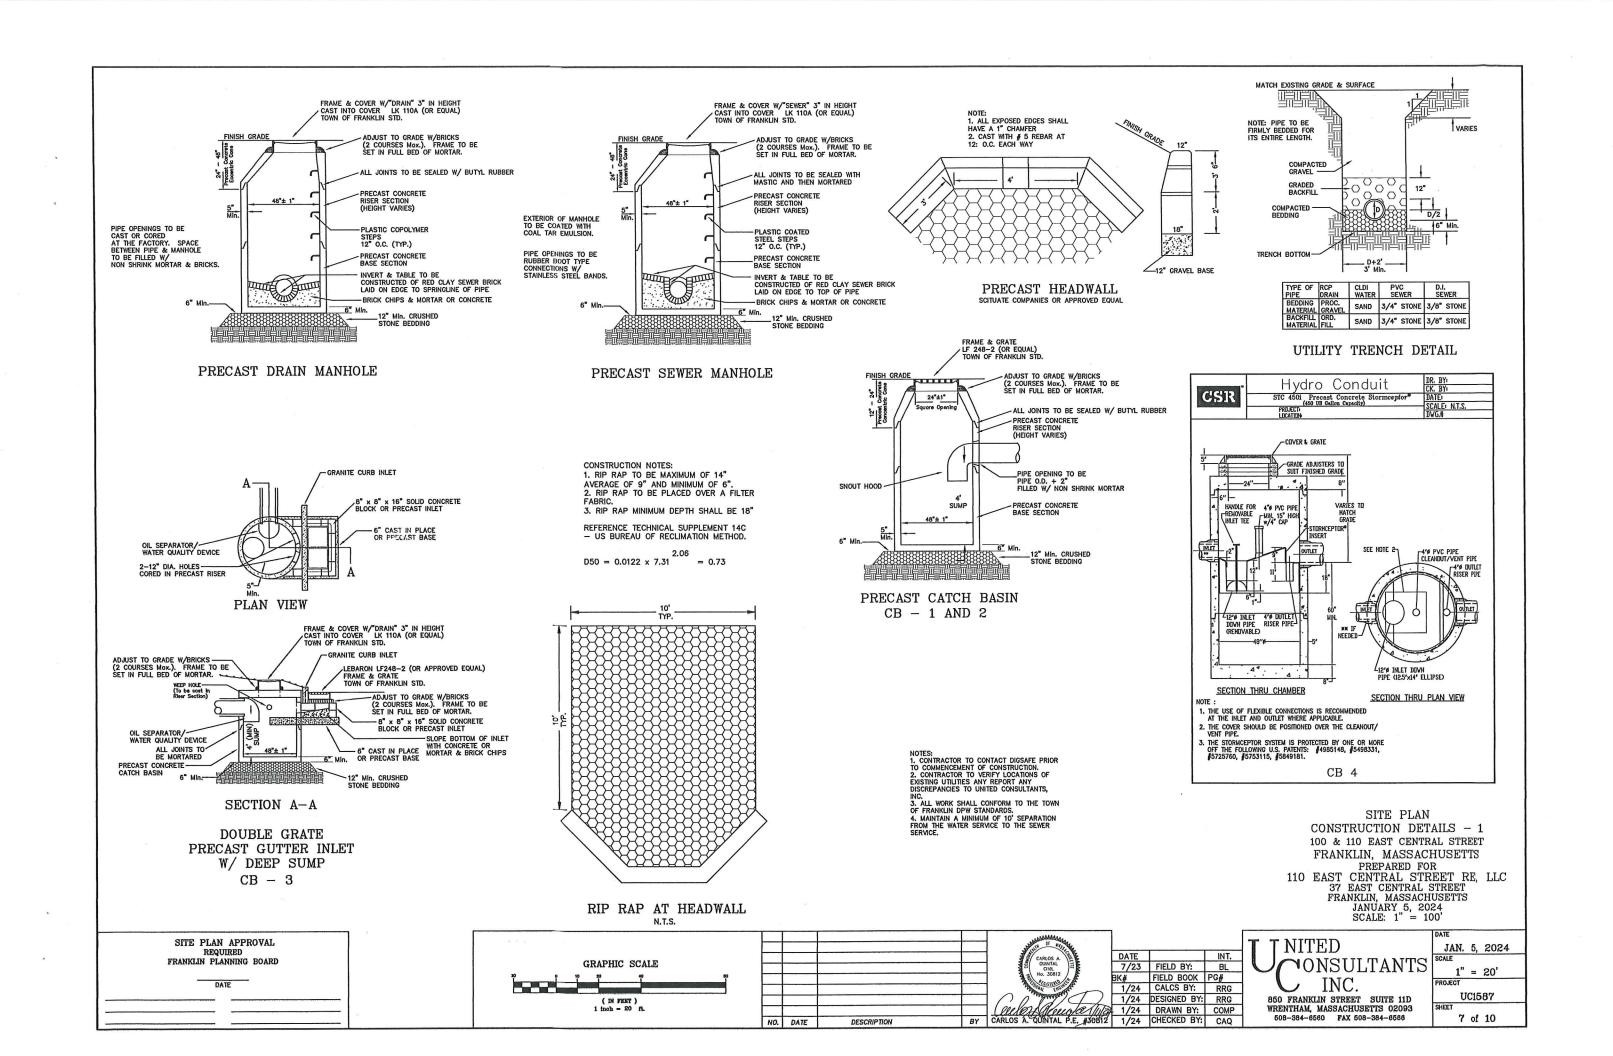

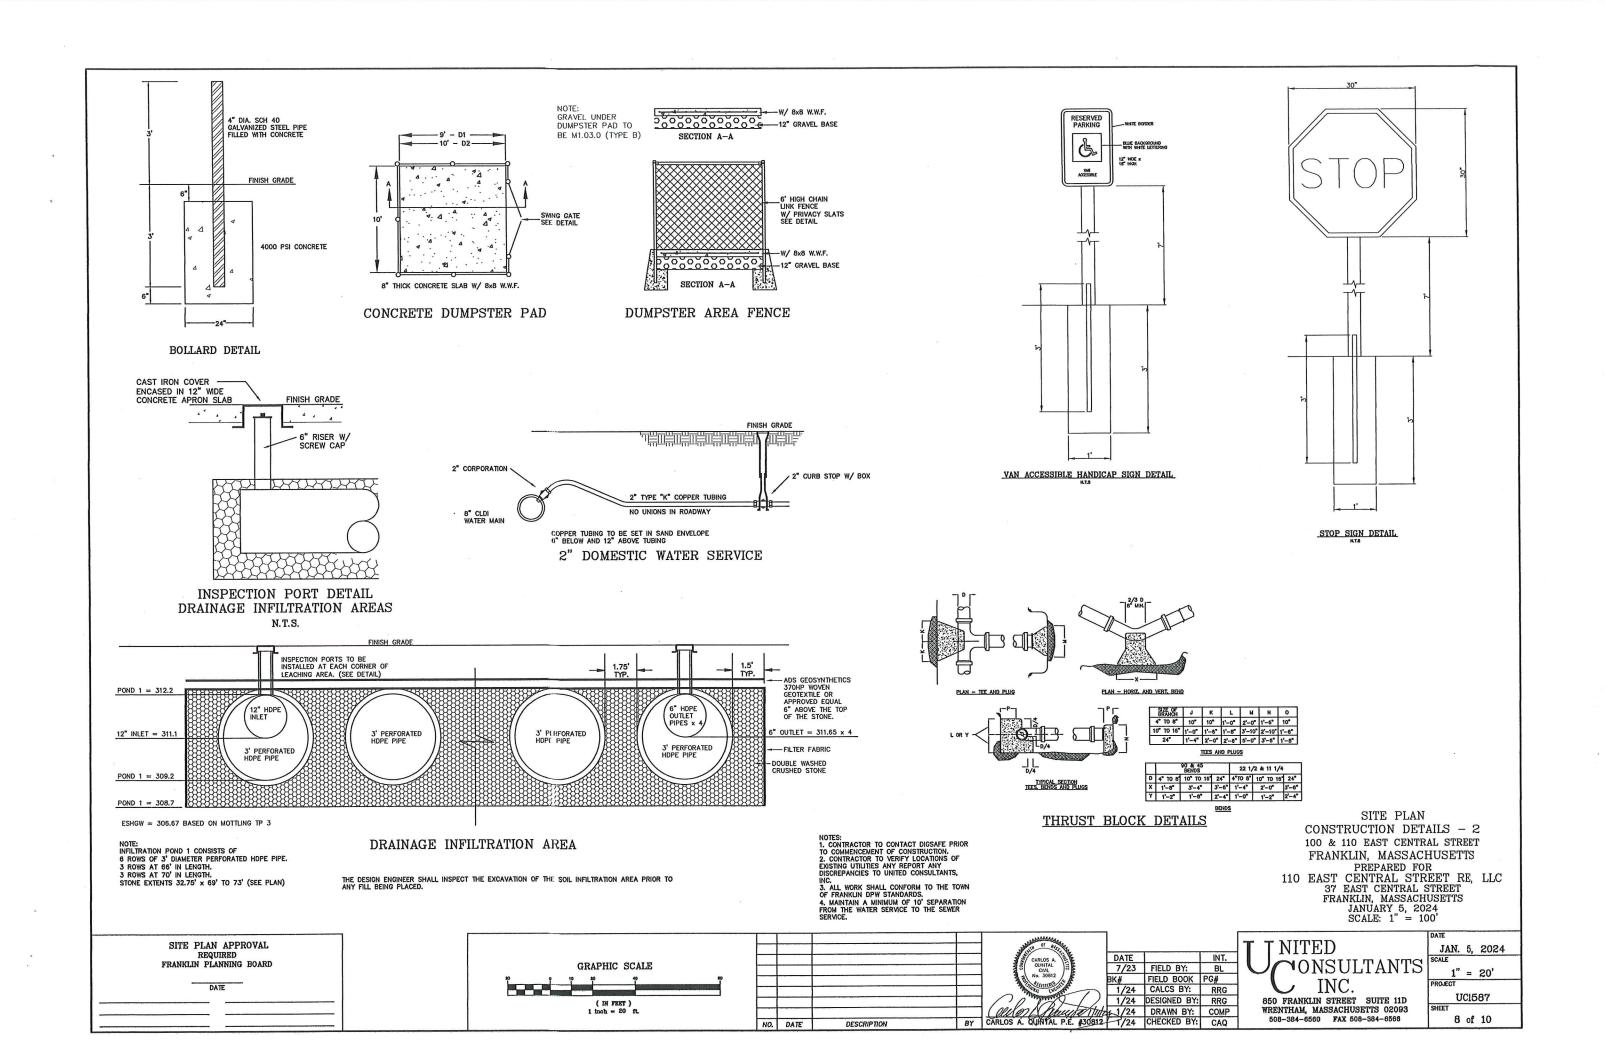

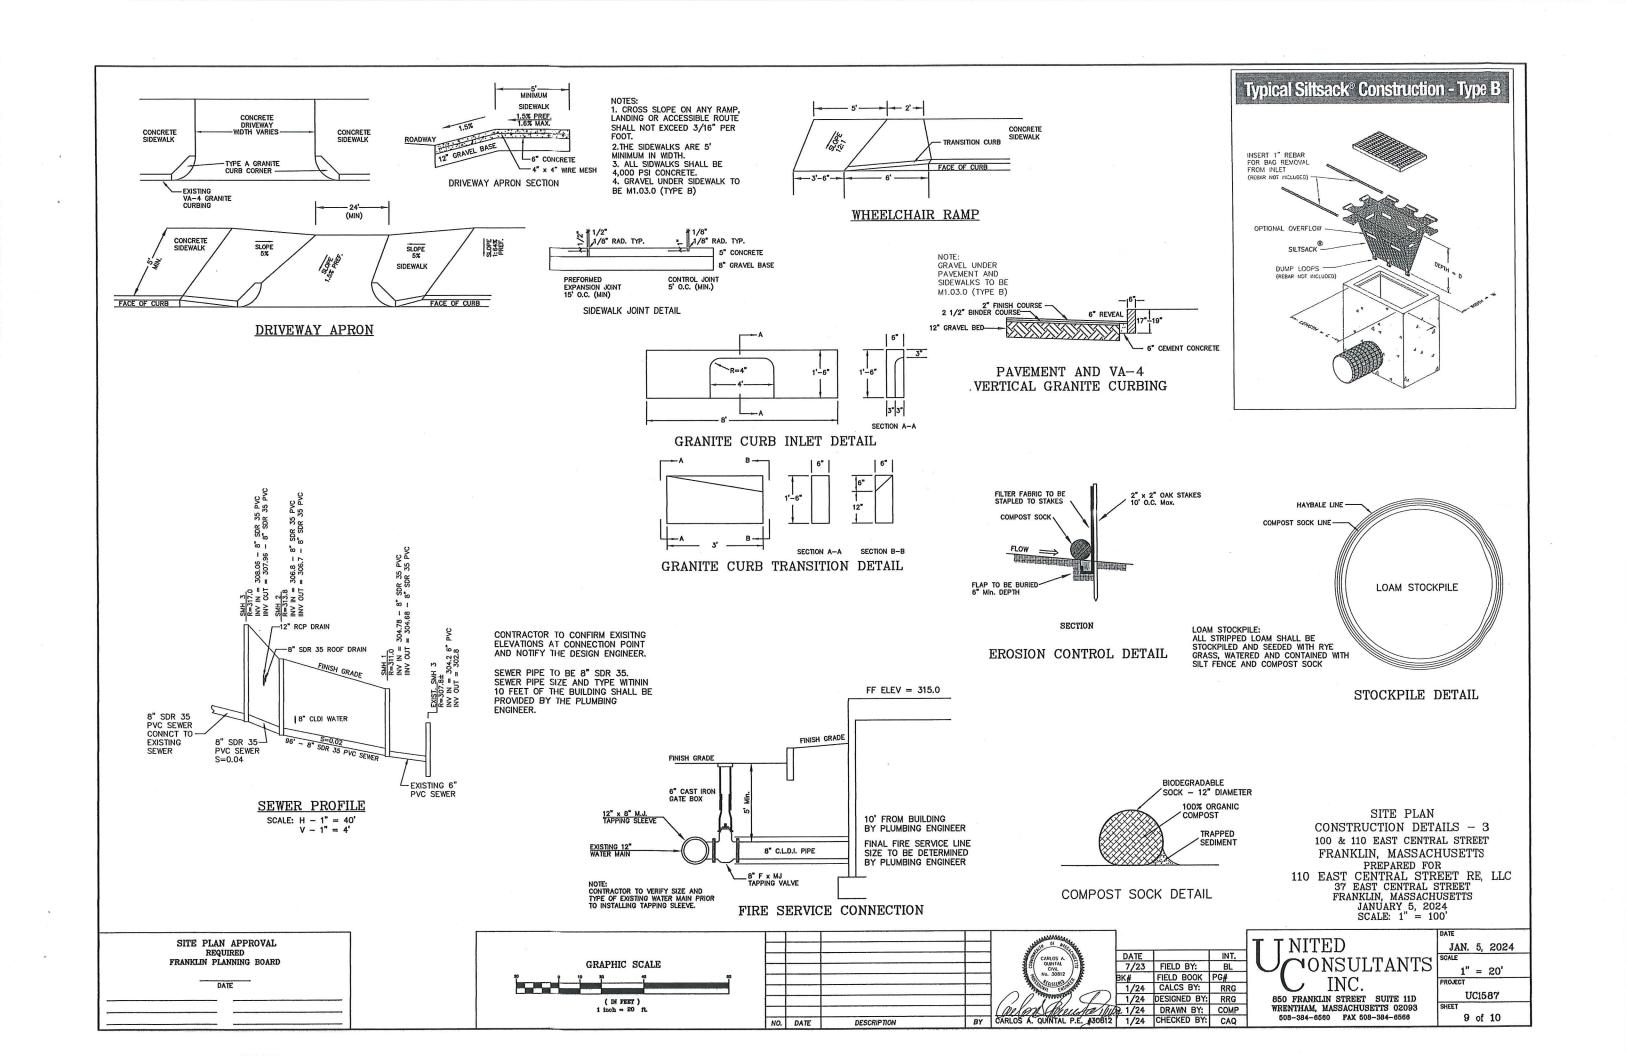

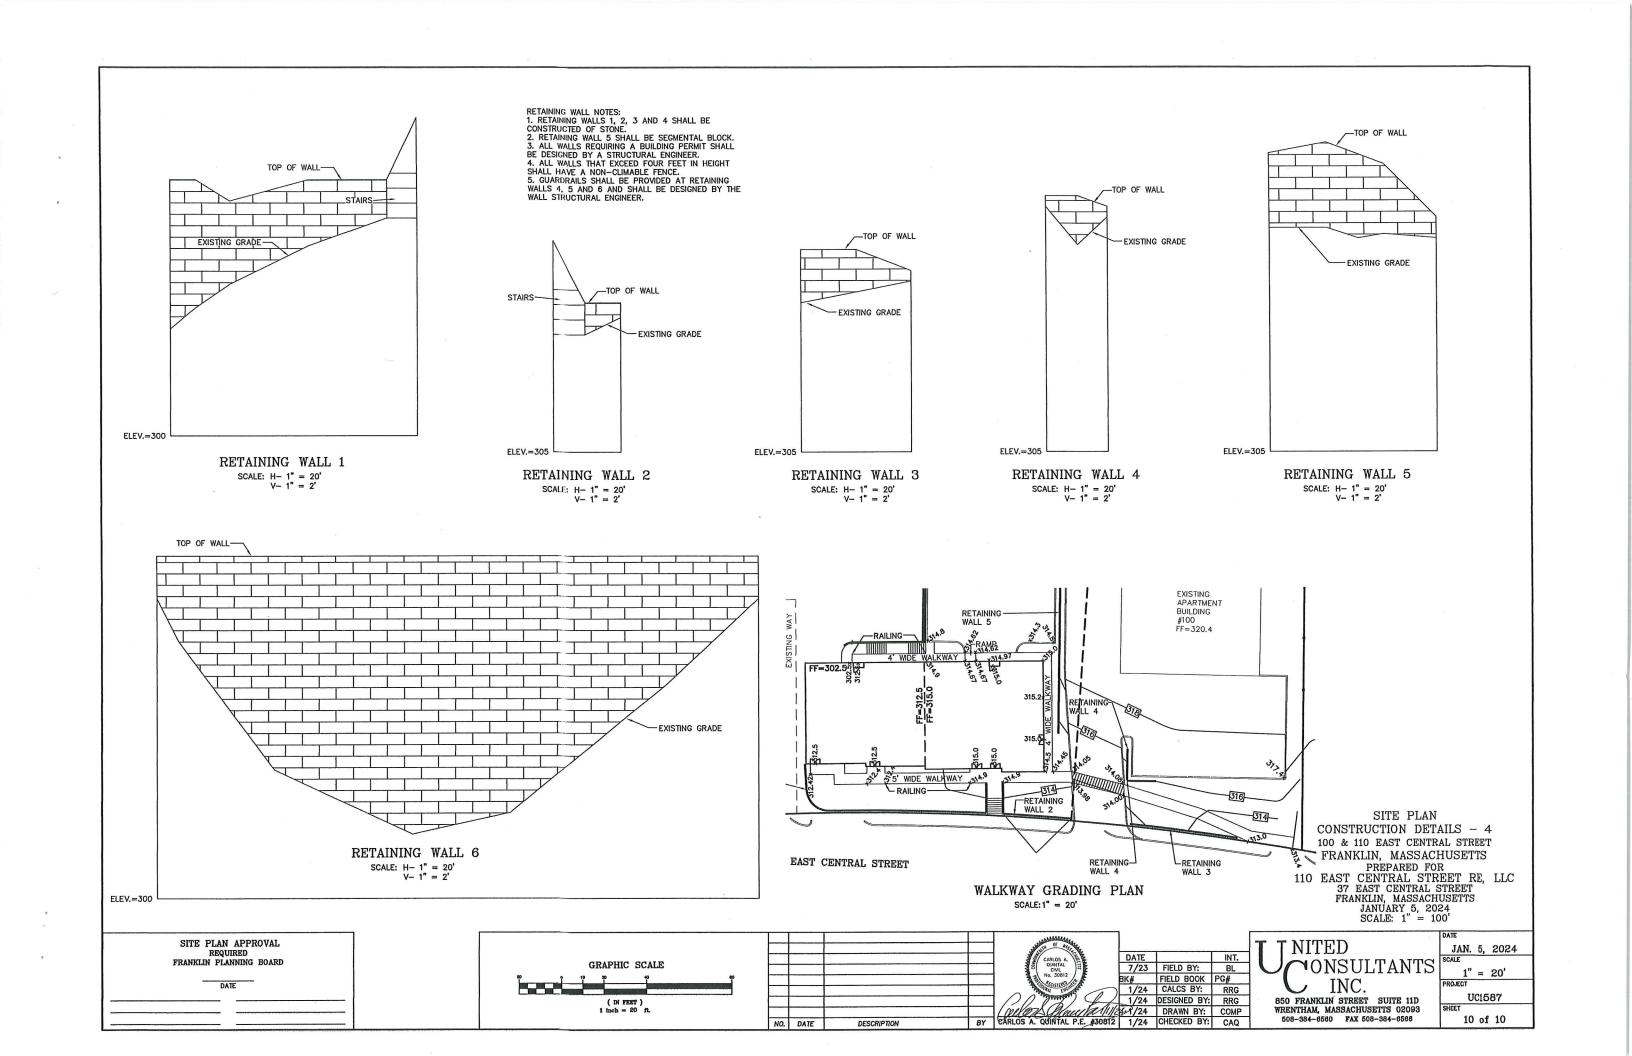

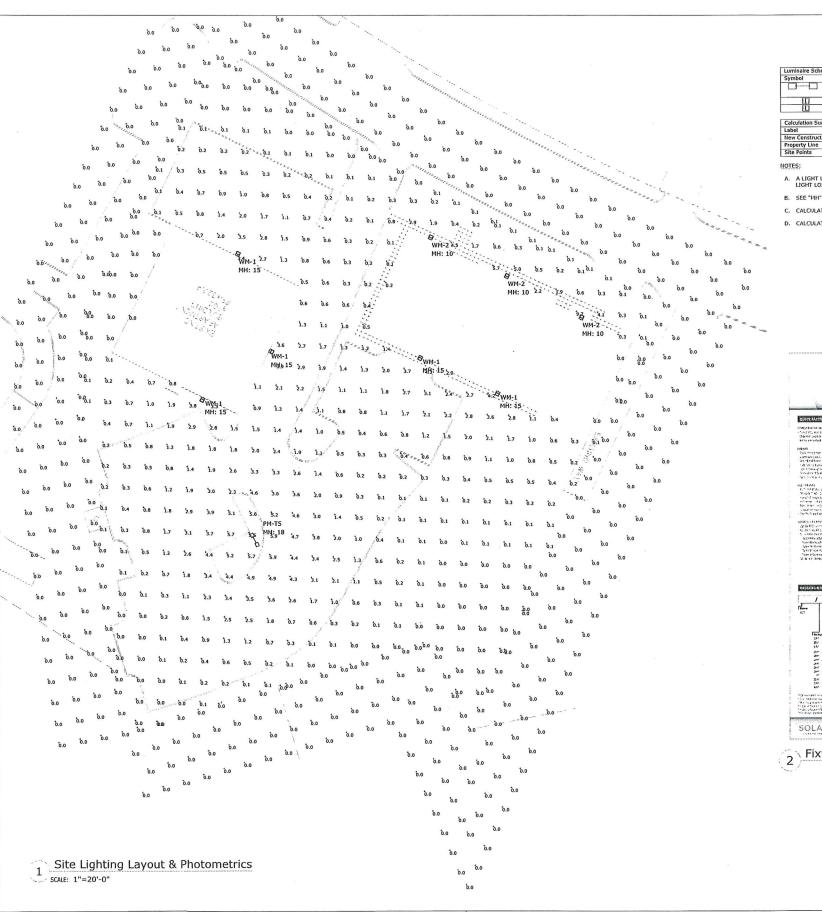



2 Fixture Specification - Solais Lighting GridLite 3









100- 110 East Central Steet

Site Lighting Layout, Schedules & Specifications

DATE: January 11, 2024	REVISIONS DESCRIPTION	DATE	1
PROJECT NUMBER: 24-0028	1		
DRAWN BY: AD	2		7,
CHECKED BY:HD	3		7 (
APPROVED BY:HD	4		Π.
SCALE: AS NOTED	5		7
	6		
	7		

SL1