


**REVIEWED BY:** BJM REVISED PER CONCOM PEER REVIEW COMMENTS SCALE: 1" = 40' REVISED PER CONCOM PEER REVIEW COMMENTS 03/28/2024 DATE REVISION DATE REVISION

30 BRAINTREE HILL OFFICE PARK SUITE 105 BRAINTREE, MA 02184



GROVE STREET RESIDENCES FRANKLIN, MA

03/28/2024 PROJECT NO.: 22016

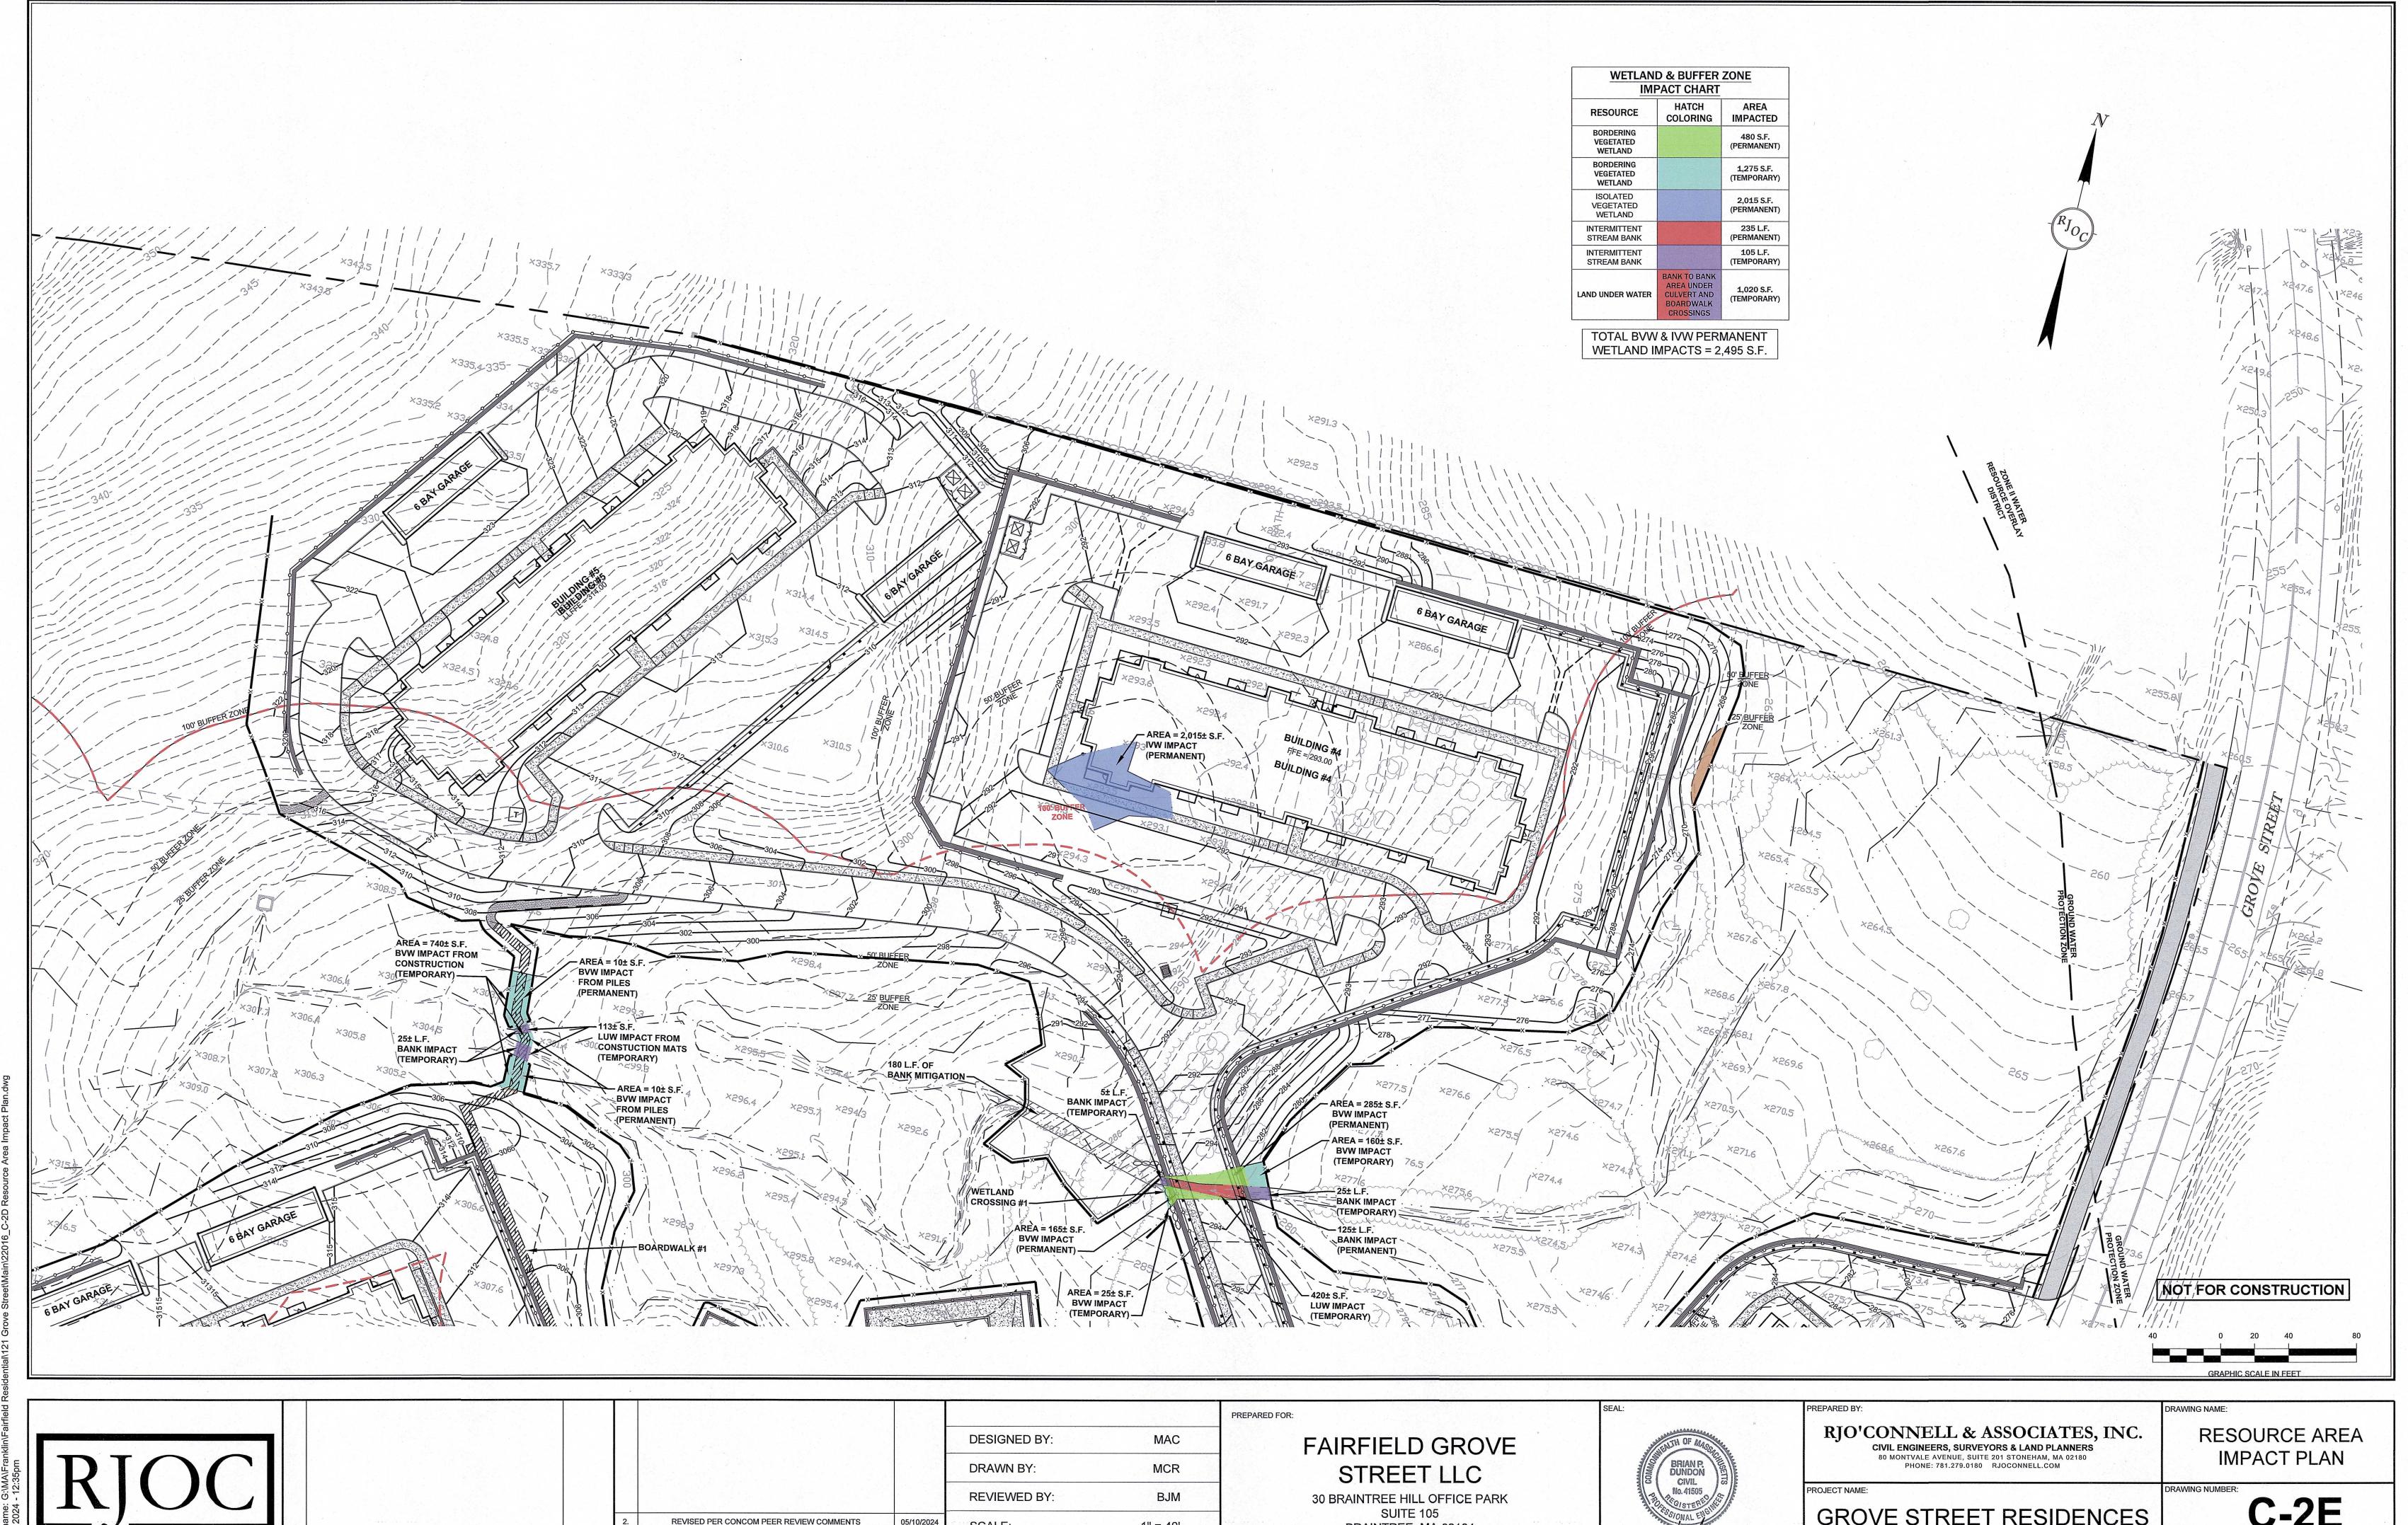

DATE REVISION


REVISED PER CONCOM PEER REVIEW COMMENTS 05/10/2024 SCALE: 1" = 40' REVISED PER CONCOM PEER REVIEW COMMENTS 03/28/2024 DATE REVISION

BRAINTREE, MA 02184



GROVE STREET RESIDENCES FRANKLIN, MA

PROJECT NO.: 22016 03/28/2024

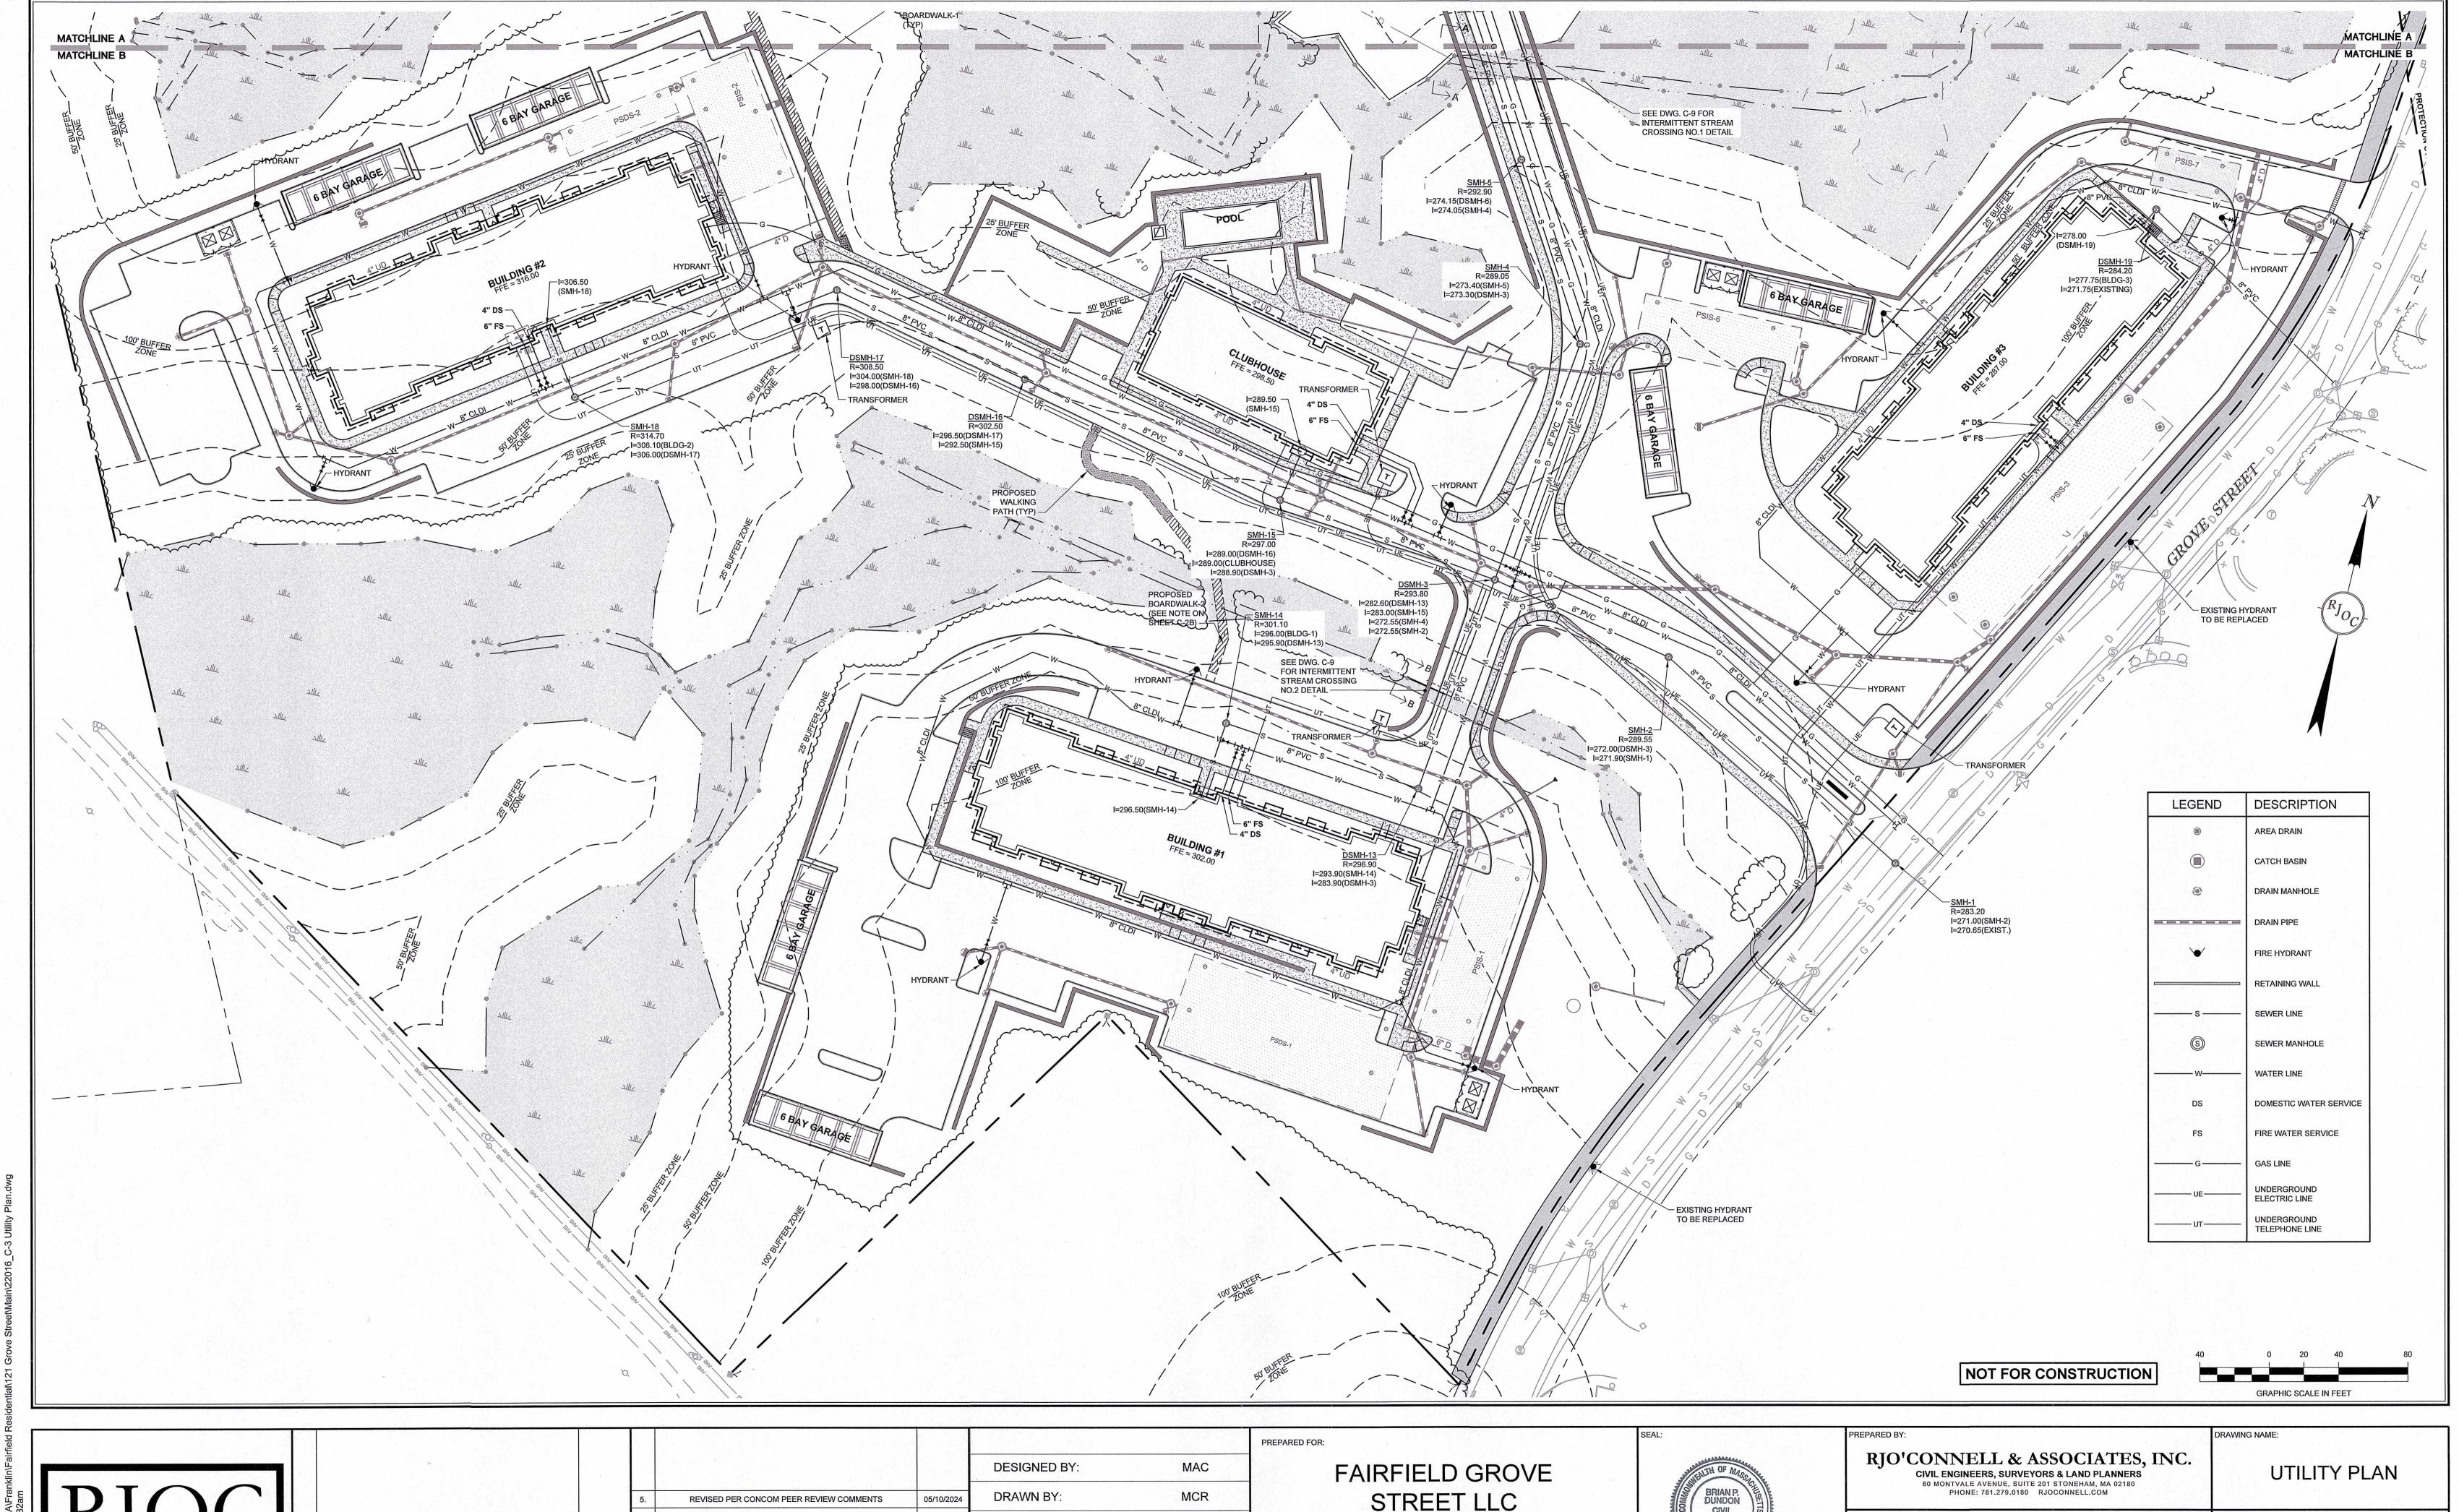

REVISION

REVIEWED BY: BJM REVISED PER ZBA PEER REVIEW COMMENTS REVISED PER ZBA PEER REVIEW COMMENTS SCALE: 1" = 40' REVISED PER ONSITE SOIL TESTING RESULTS/NOI SUBMISSION DATE REVISION


STREET LLC 30 BRAINTREE HILL OFFICE PARK SUITE 105

BRAINTREE, MA 02184

Br. Numb 5-10-2009

GROVE STREET RESIDENCES FRANKLIN, MA

PROJECT NO.: 22016 10/30/2023 Copyright © 2023 by R.J. O'Connell & Associates, Inc.

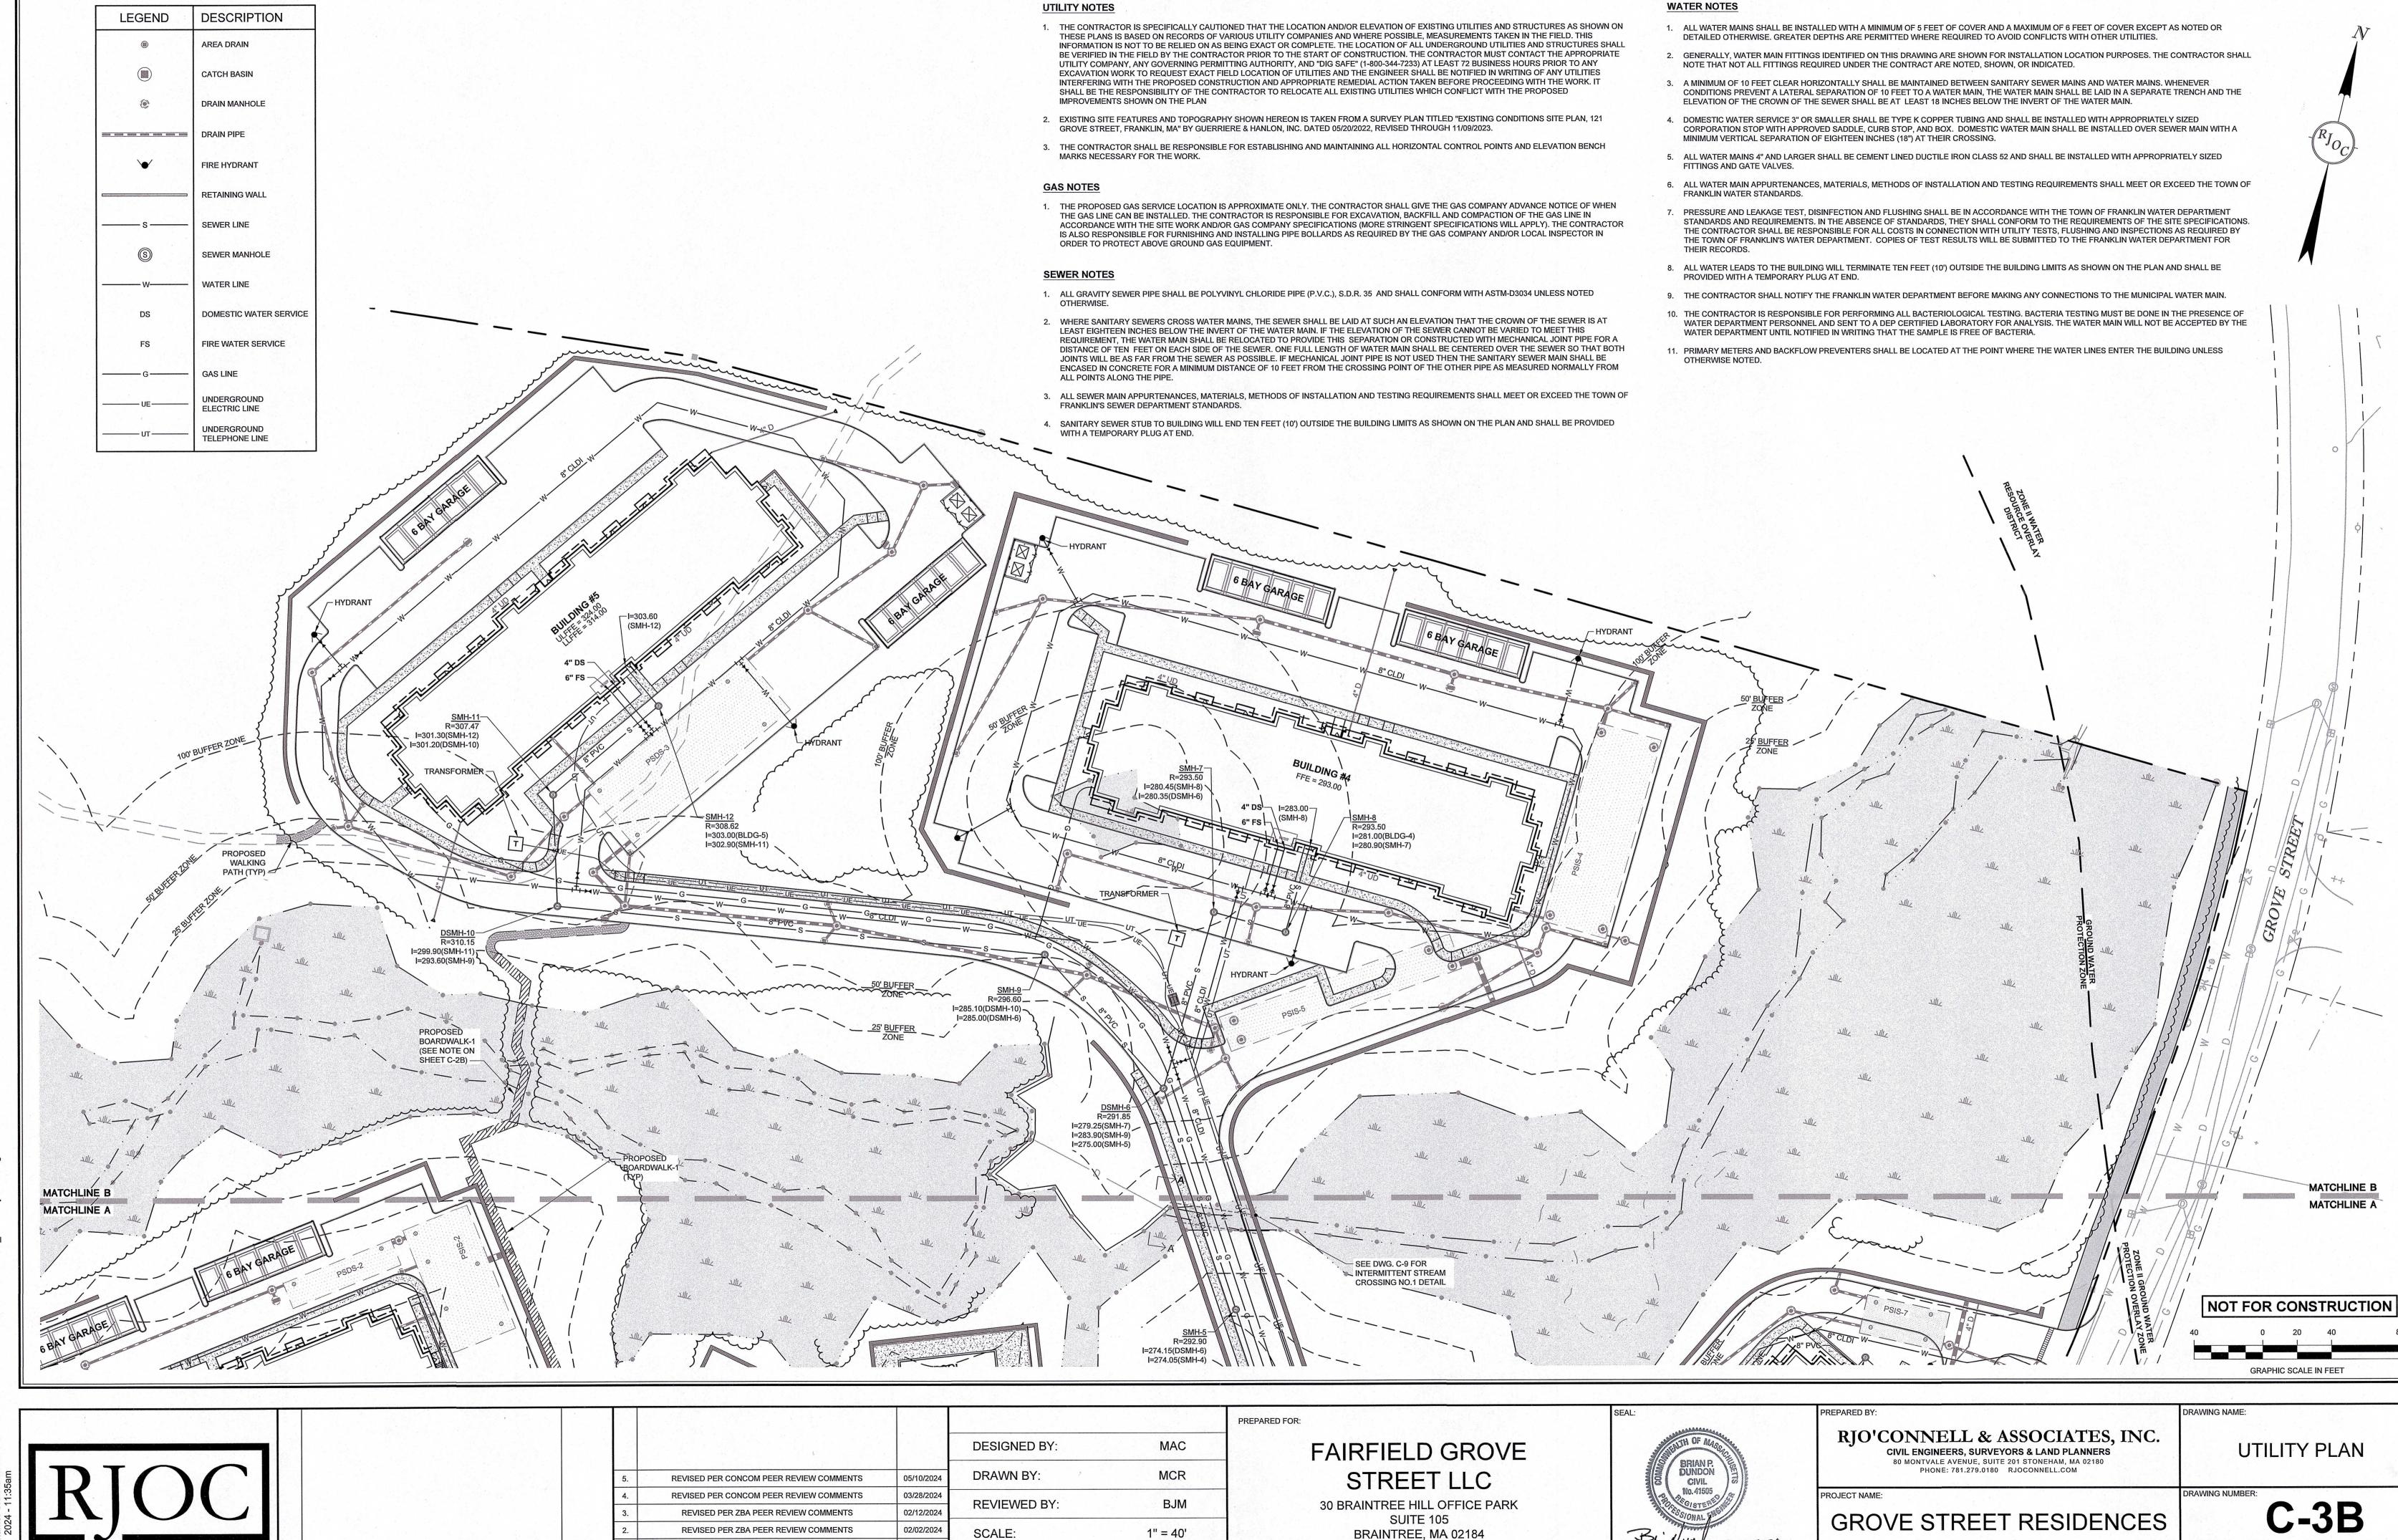

REVISED PER ONSITE SOIL TESTING RESULTS/NOI SUBMISSION

REVISION

DATE

REVISION


Drawing name: G:\MA\Fran

Copyright © 2021 R.J. O'Connell & Associates, Inc.

Copyright © 2023 by R.J. O'Connell & Associates, Inc.

PROJECT NO.: 22016

FRANKLIN, MA

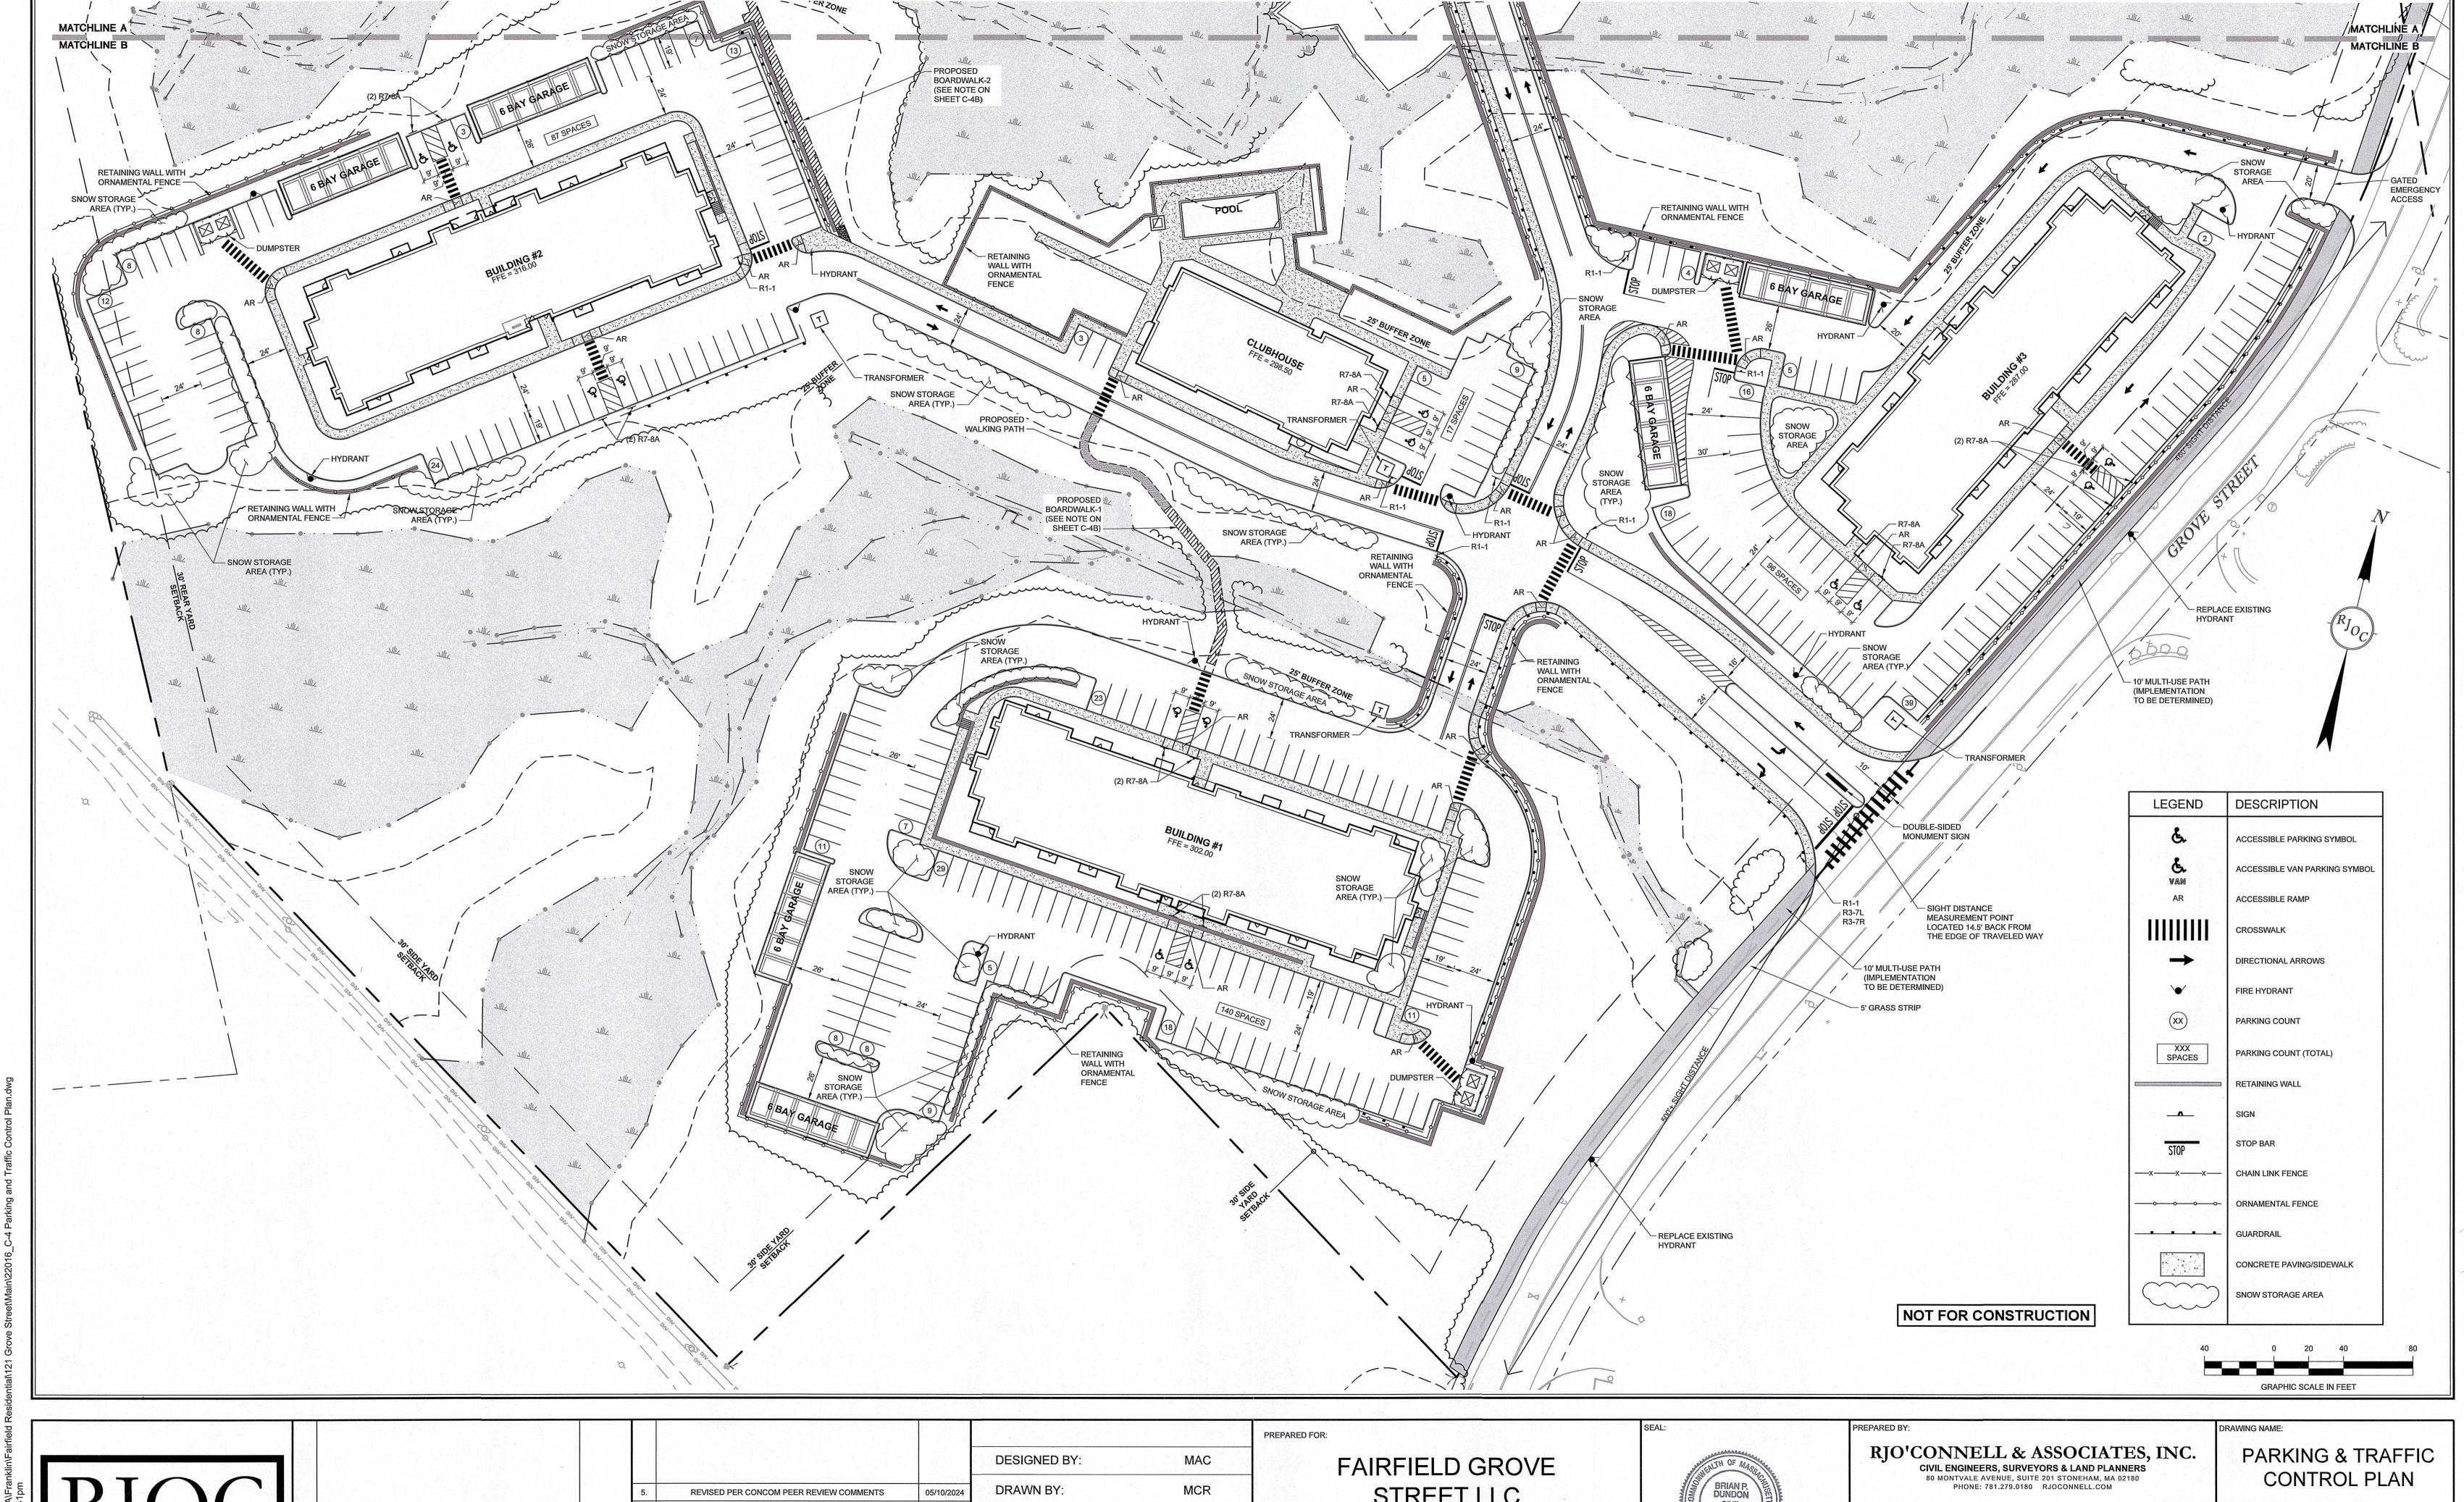

REVISED PER CONCOM PEER REVIEW COMMENTS 03/28/2024 **REVIEWED BY:** BJM REVISED PER ZBA PEER REVIEW COMMENTS 02/12/2024 REVISED PER ZBA PEER REVIEW COMMENTS 02/02/2024 SCALE: 1" = 40' REVISED PER ONSITE SOIL TESTING RESULTS/NOI SUBMISSION | 12/18/2023 DATE


STREET LLC


30 BRAINTREE HILL OFFICE PARK SUITE 105 BRAINTREE, MA 02184





PROJECT NAME: GROVE STREET RESIDENCES FRANKLIN, MA


10/30/2023 PROJECT NO.: 22016

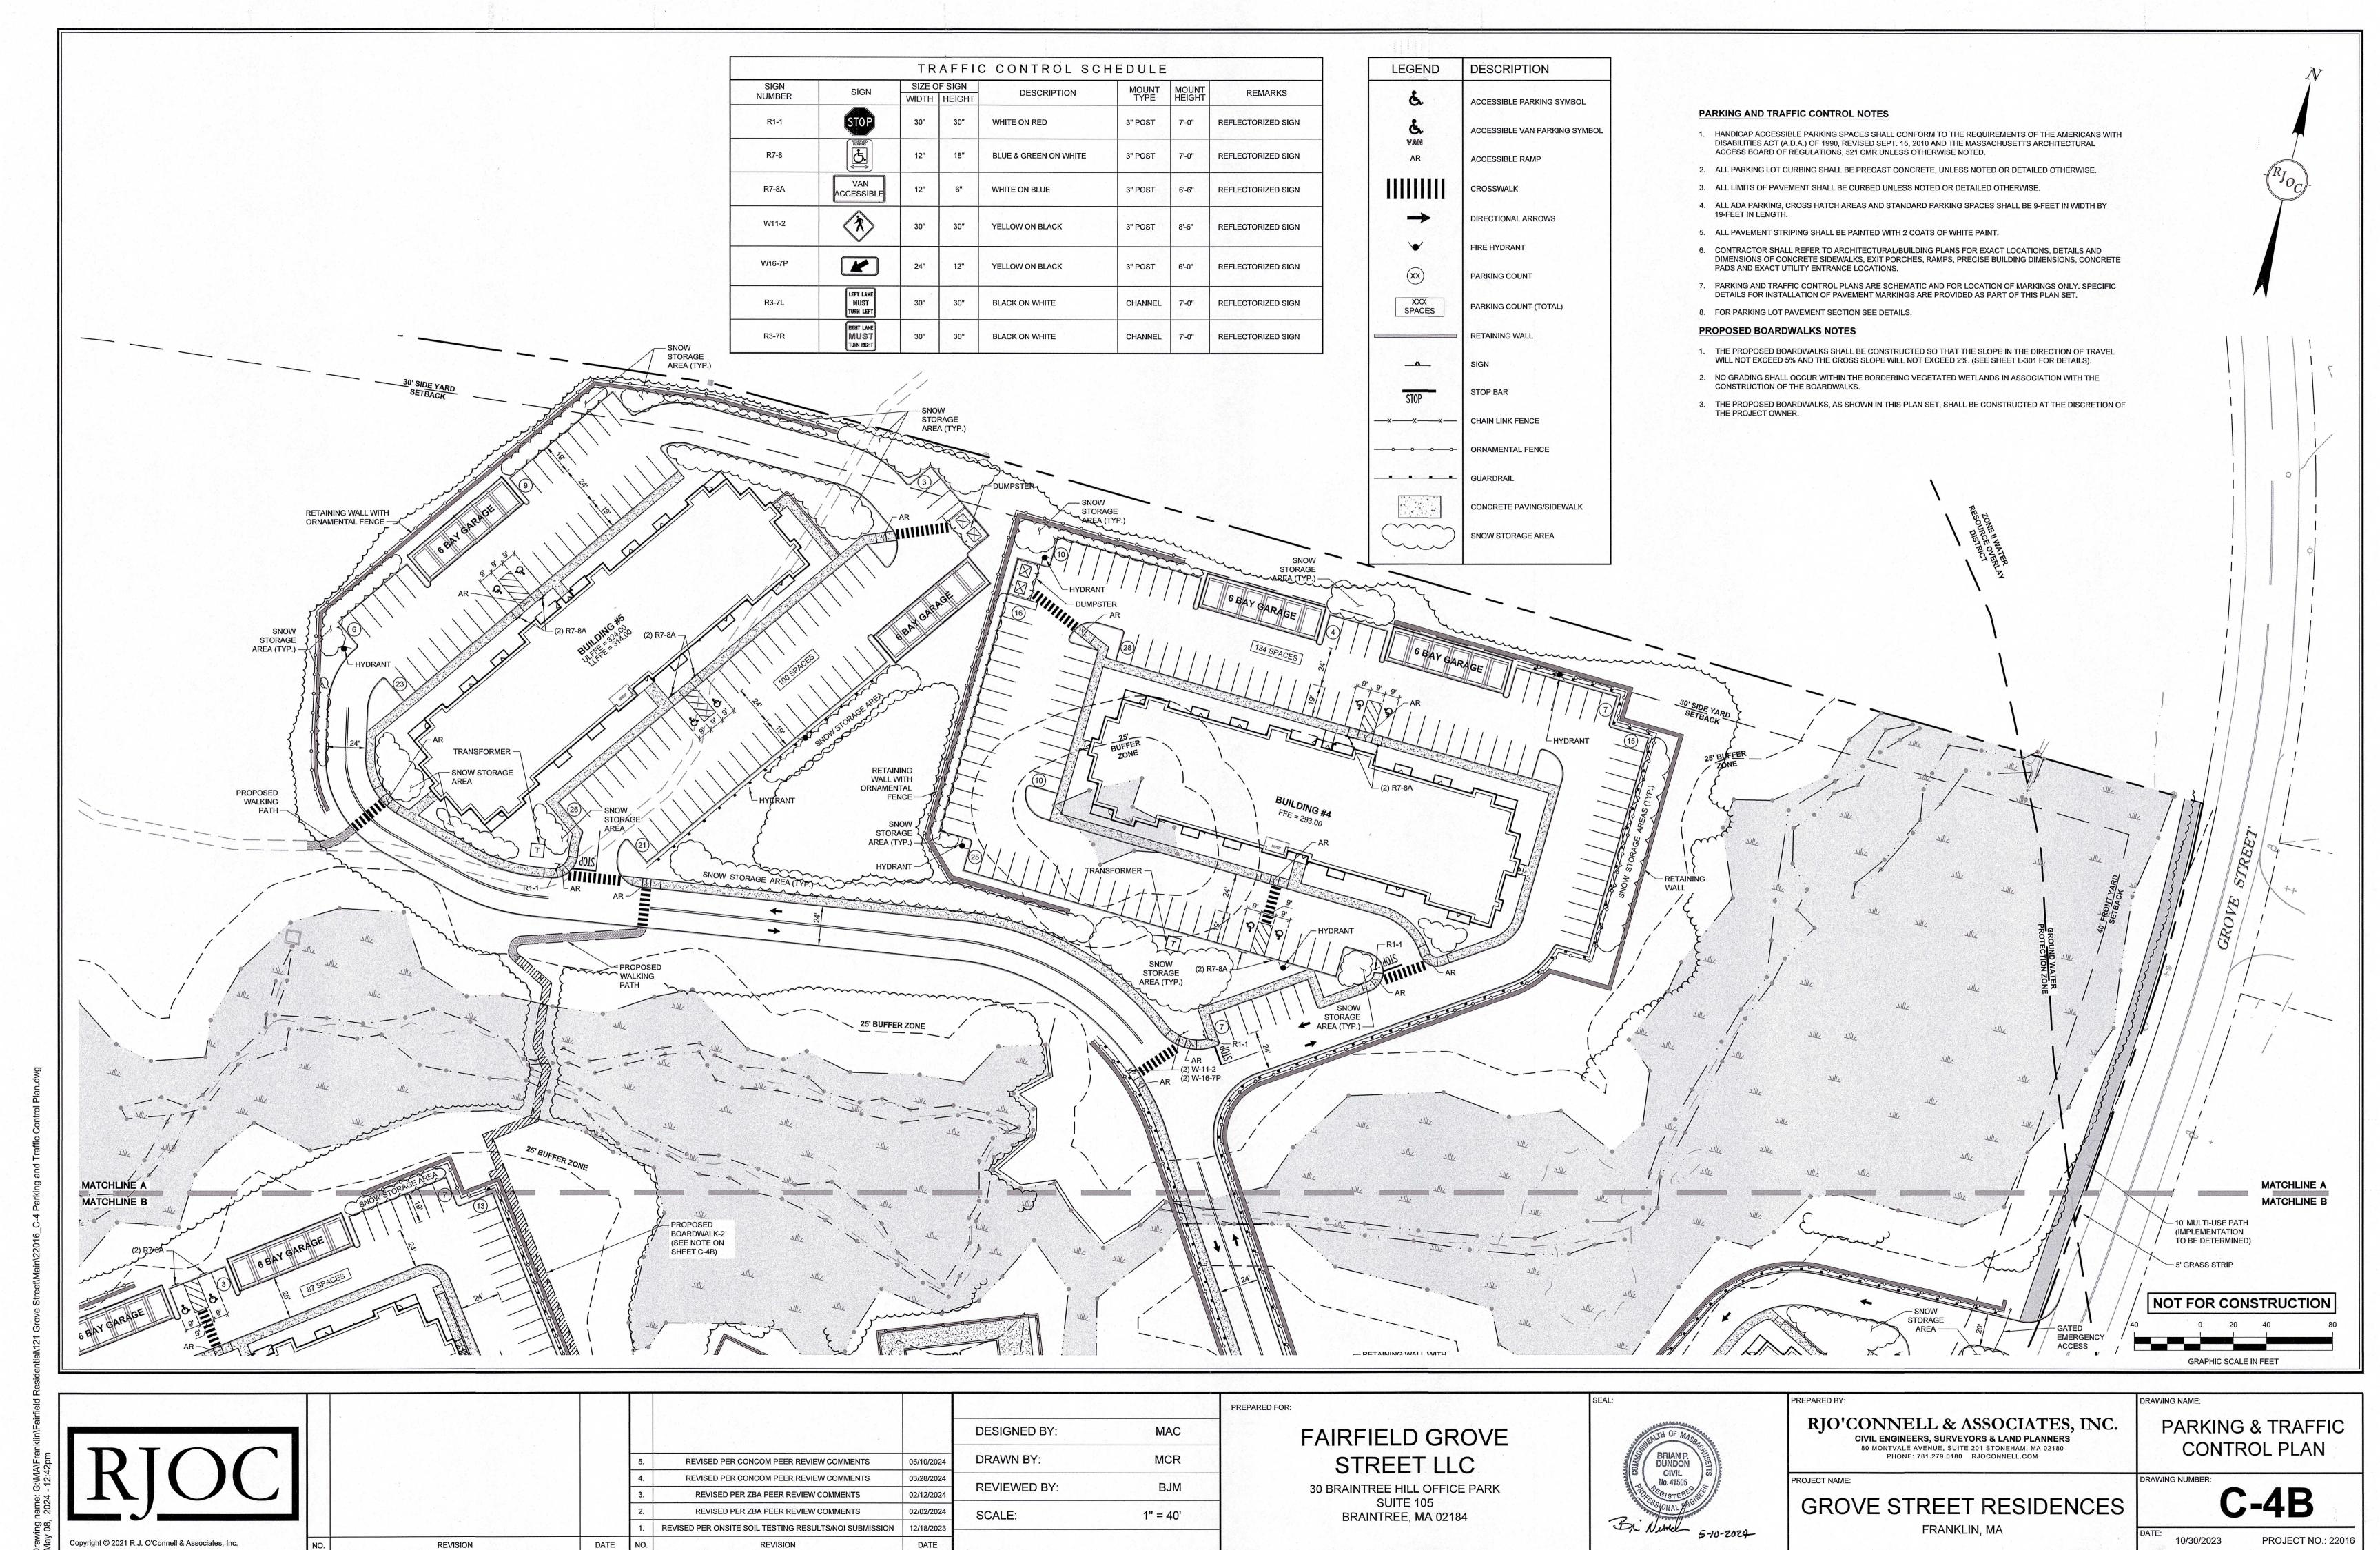


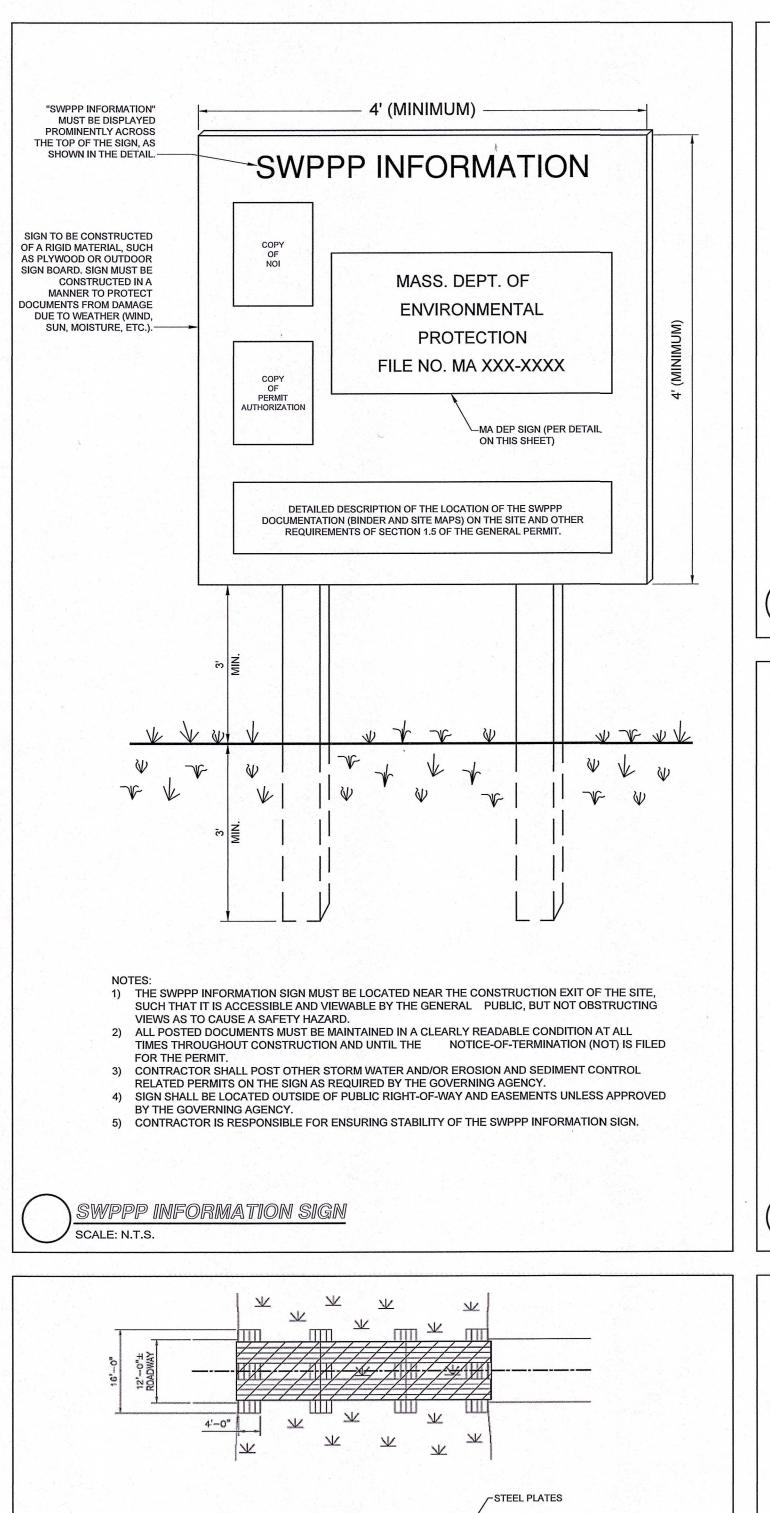


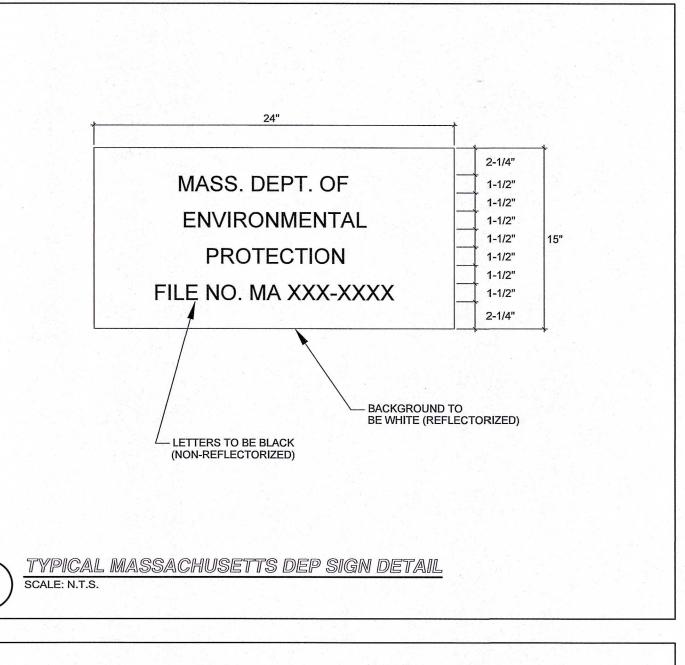


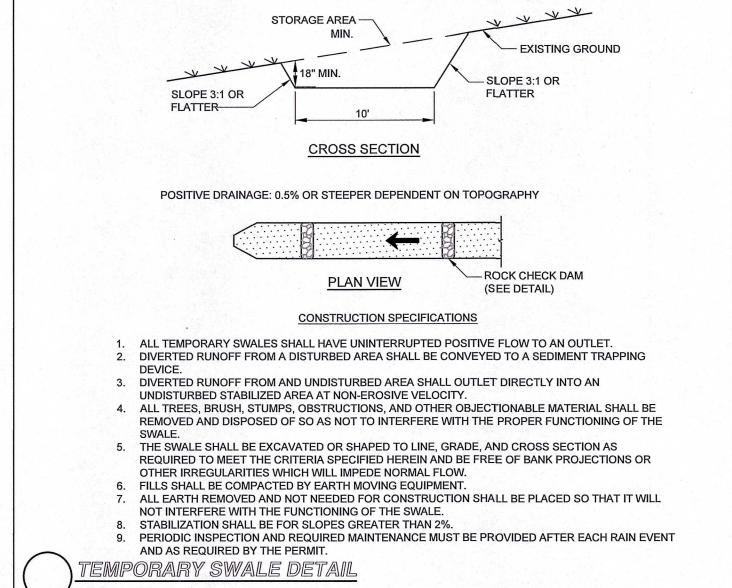


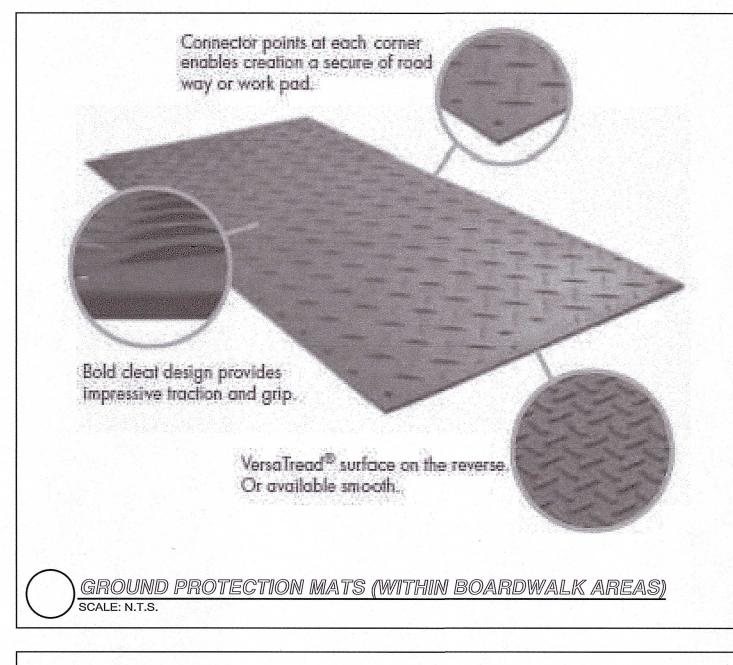

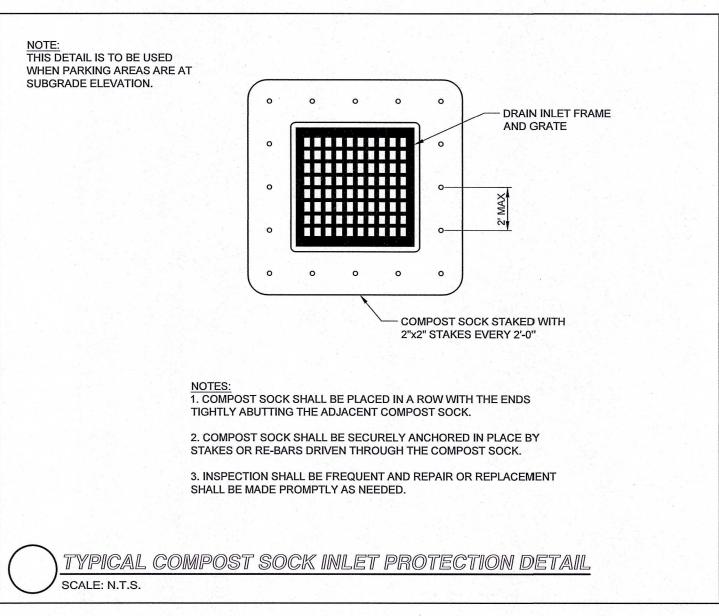

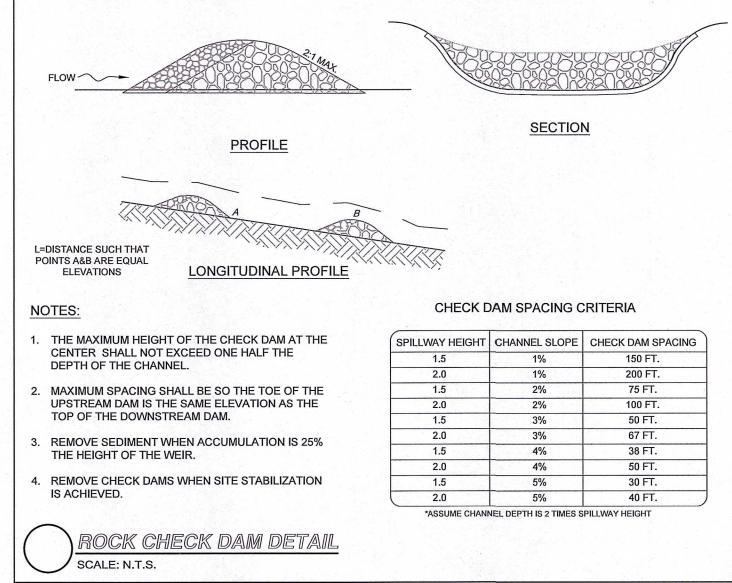

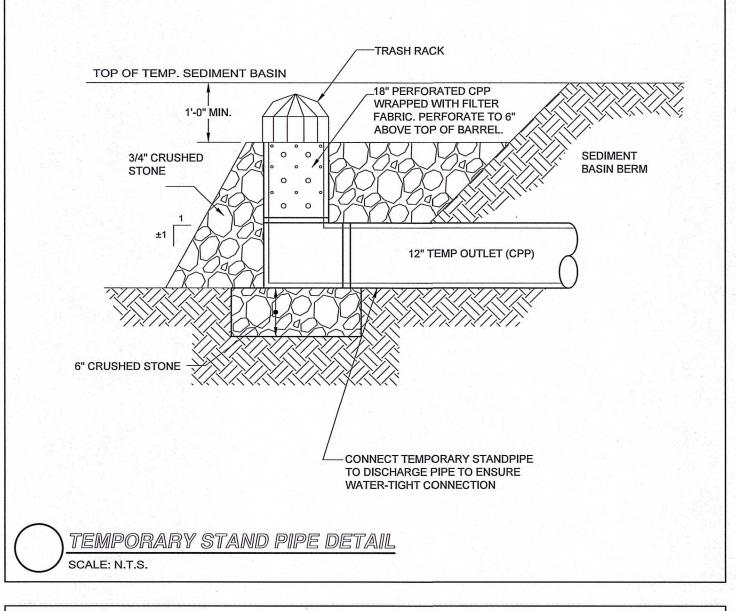

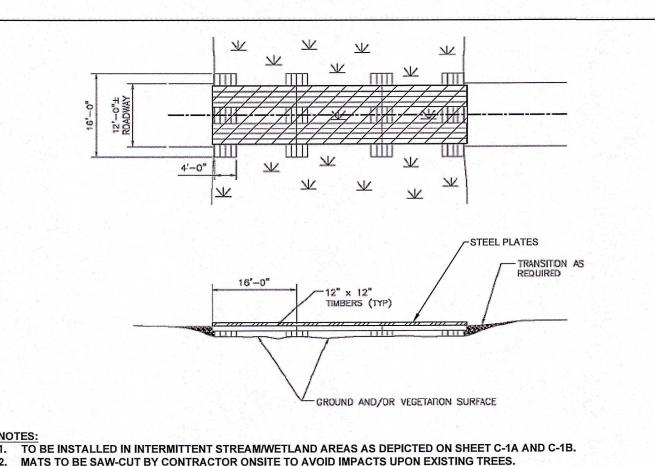

MORE THAN ONLY LAYER OF MATS MAY BE NECESSARY IN AREAS WHICH ARE INUNDATED OR HAVE DEEP ORGANIC WETLAND

MATTED STREAM CROSSING SHOULD BE MONITORED TO ASSURE CORRECTION FUNCTIONING OF THE MATS. INSPECT MATS

CONSTRUCTION DEBRIS SHOULD BE CLEANED AND THE MATERIALS REMOVED AND DISPOSED OF IN AN UPLAND LOCATION.


THE MATERIAL SHOULD NOT BE SCRAPED OR SHOVELED INTO THE RESOURCE AREA. MATS WHICH BECOME IMBEDDED MUST


ONSTRUCTION SWAMP MAT (AT INTERMITTENT STREAM) DETAIL

REVISION


AFTER USE. LOOK FOR ANY DEFECTS OR STRUCTURAL PROBLEMS. MATS WHICH BECOME COVERED WITH SOILS OR

MATS SHOULD NOT BE PLACED SO THAT THEY RESTRICT THE NATURAL FLOW OF THE STREAM.

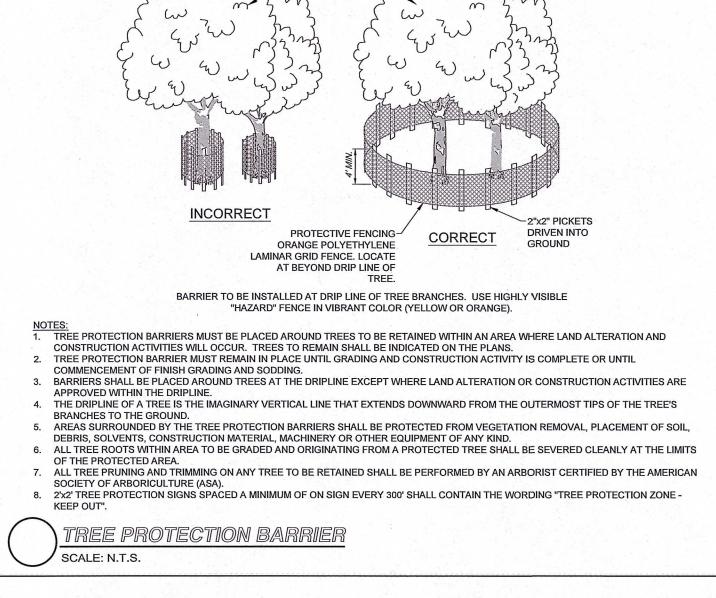

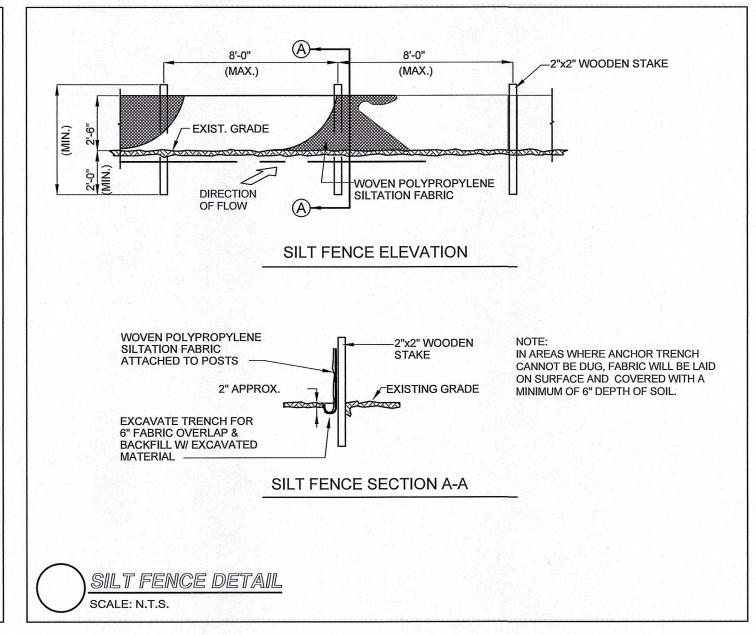

PREPARED FOR:

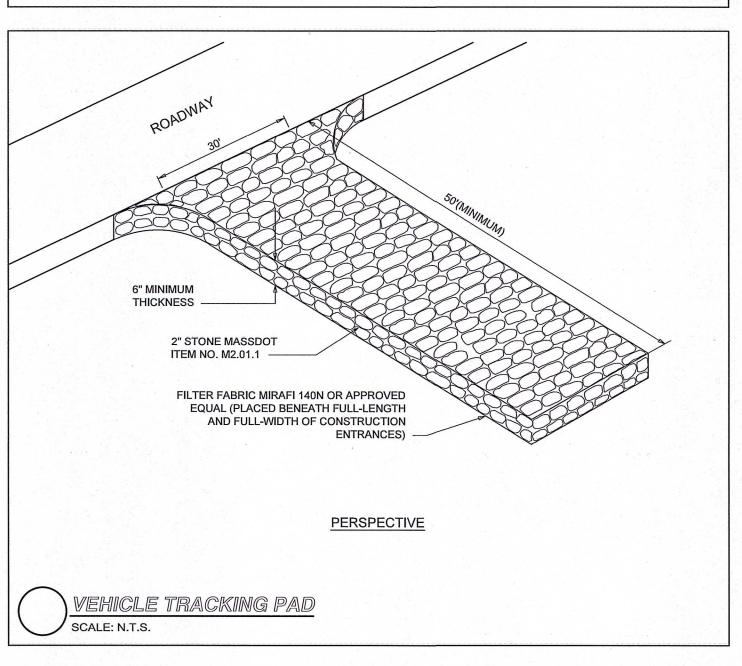

PROJECT NAME:

NOT FOR CONSTRUCTION



	5.	REVISED PER CONCOM PEER REVIEW COMMENTS	05/10/2024	
	4.	REVISED PER CONCOM PEER REVIEW COMMENTS	03/28/2024	
	3.	REVISED PER ZBA PEER REVIEW COMMENTS	02/12/2024	
	2.	REVISED PER ZBA PEER REVIEW COMMENTS	02/02/2024	
	1.	REVISED PER ONSITE SOIL TESTING RESULTS/NOI SUBMISSION	12/18/2023	
ATE	NO.	REVISION	DATE	

**DESIGNED BY:** MAC MCR DRAWN BY: BJM **REVIEWED BY:** SCALE: N.T.S.

FAIRFIELD GROVE STREET LLC 30 BRAINTREE HILL OFFICE PARK SUITE 105 BRAINTREE, MA 02184



PREPARED BY:						
RIO'CC	NNELI	& AS	SOCIA	TES.	INC	

COMMELL & ASSOCIATES, INC. **CIVIL ENGINEERS, SURVEYORS & LAND PLANNERS** 80 MONTVALE AVENUE, SUITE 201 STONEHAM, MA 02180 PHONE: 781.279.0180 RJOCONNELL.COM

SITE **DETAILS - I** 

DRAWING NAME:


DRAWING NUMBER


**GROVE STREET RESIDENCES** FRANKLIN, MA

10/30/2023

Copyright © 2023 by R.J. O'Connell & Associates, Inc.

PROJECT NO.: 22016

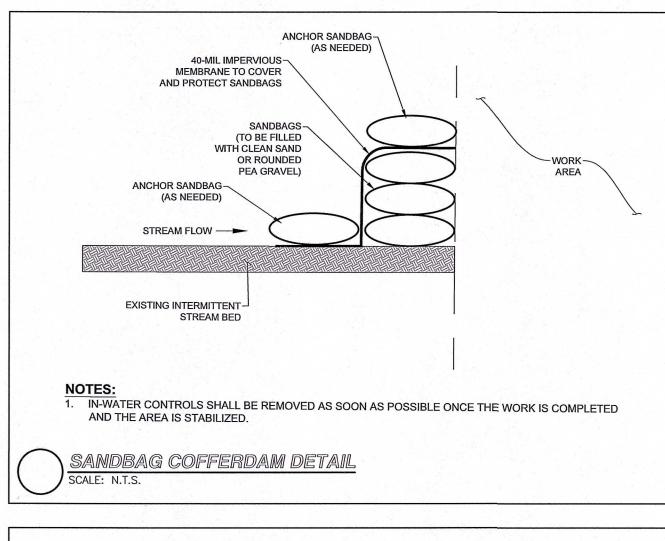

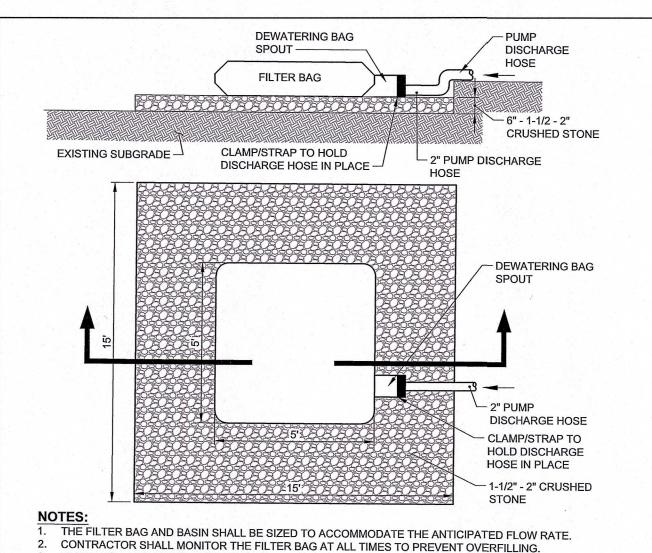


3. FILTER BAG TO BE REPLACED WHEN BAG IS HALF FULL OF SEDIMENT OR WHEN SEDIMENT HAS REDUCED


THE PUMP DISCHARGE FLOW RATE TO AN IMPRACTICAL RATE

SCALE: N.T.S.

PUMPED WATER FILTER BAG DETAIL

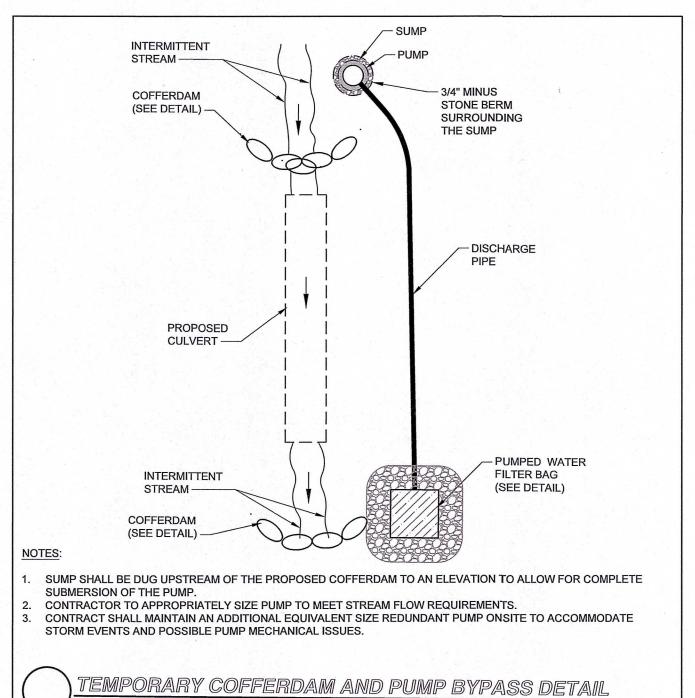



REVISION

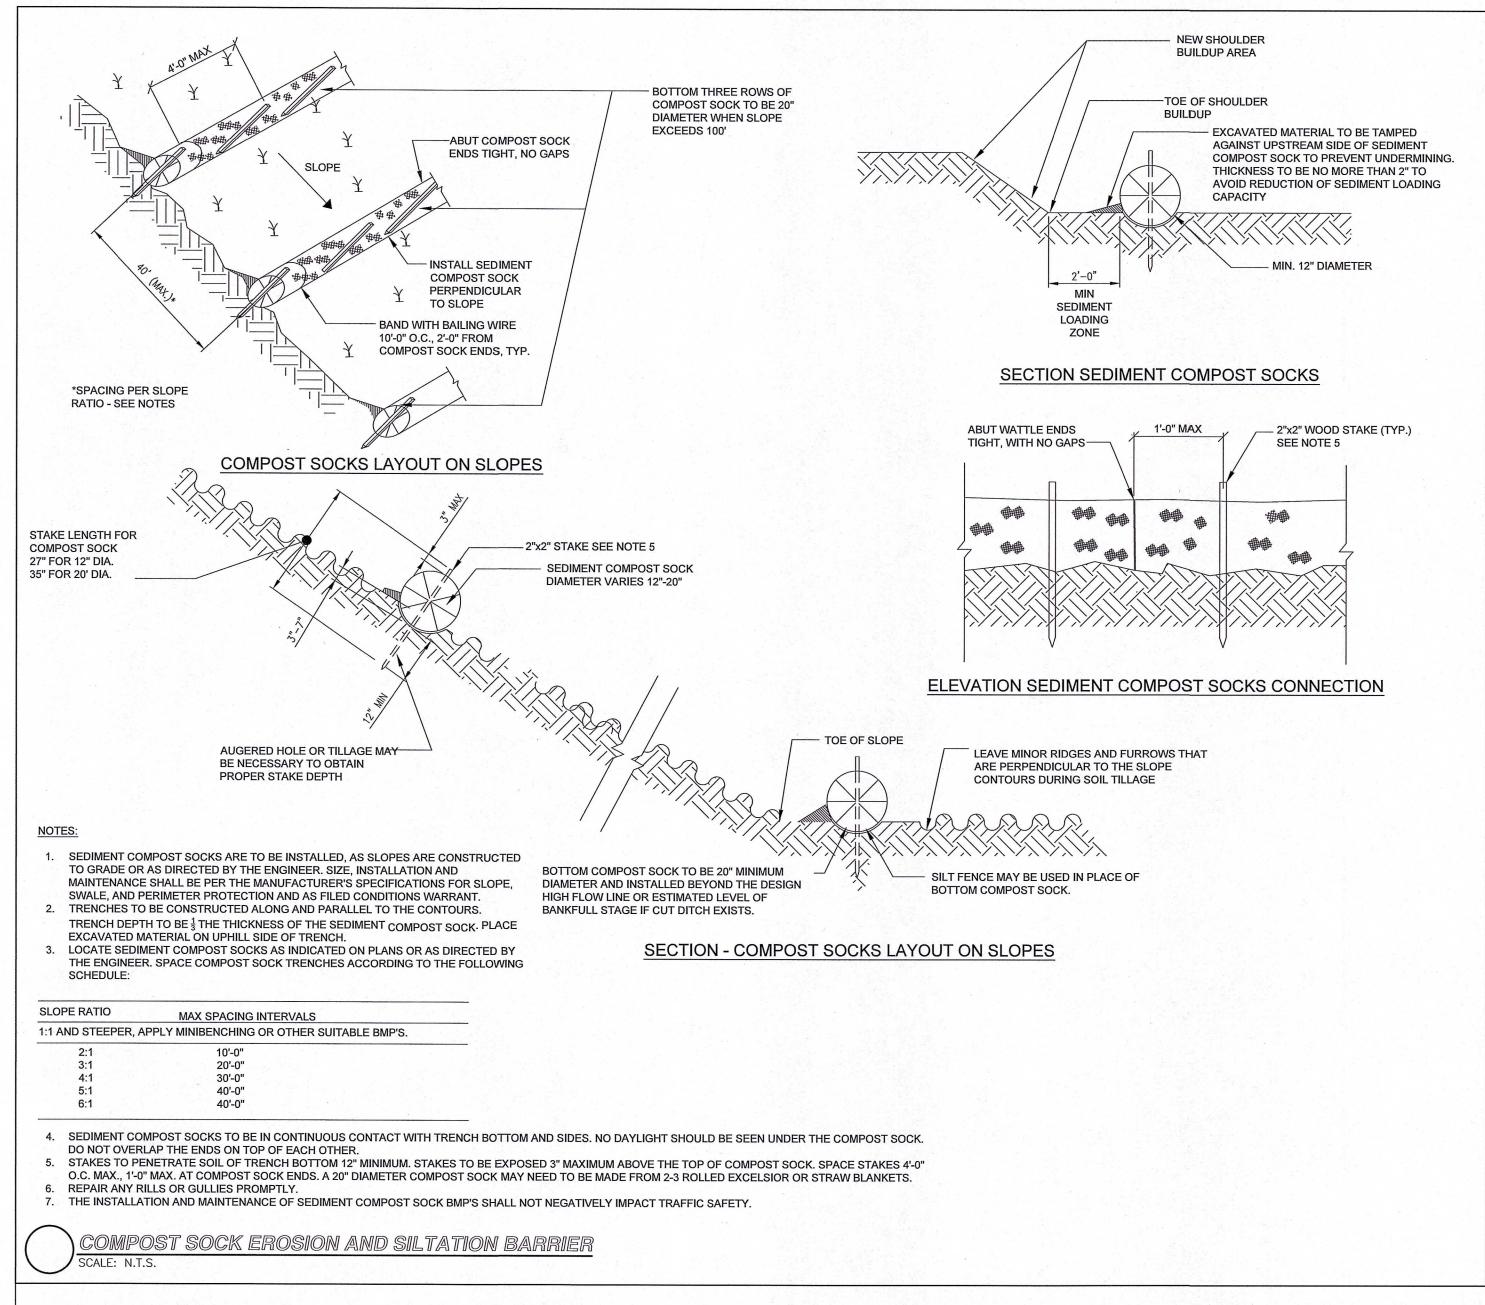

-WOOD STAKE (2"x2", (2) PER BALE) -3/4" WASHED STONE, 3/4" WASHED STONE -10 MIL PLASTIC 10 MIL PLASTIC LINING 3. FACILITY MUST HOLD SUFFICIENT VOLUME TO CONTAIN CONCRETE WASTE WITH A **ALTERNATE SECTION** 3/4" WASHED STON USE WHERE MORE THAN ONE ACCESSIBLE 6" THICK SIDE IS NEEDED 4. FACILITY SHALL NOT BE FILLED BEYOND 75% CAPACITY UNLESS A NEW FACILITY IS SECTION A-A LIMITS OF 10MIL 5. SAW CUT PORTLAND CEMENT CONCRETE, RESIDUE FROM SAWCUT & GRINDING TO ALL CONCRETE PLASTIC LINING TRUCKS SHALL WASHOUT HERE -3/4" WASHED STONE. 6. CONCRETE WASHOUTS SHALL BE LOCATED A MINIMUM OF 100' FROM DRAINAGE 5" THICK -LIMITS OF 10MIL MANUFACTURED CONCRETE WASHOUT DEVICES MAY BE USED IF REMOVED FROM PLASTIC LINING LSTAKE (TYP.) WASHOUT SIGN SLOPE 2.5% MIN. -SUMP-LIMITS OF 10MIL PLASTIC LINING

PREPARED FOR:

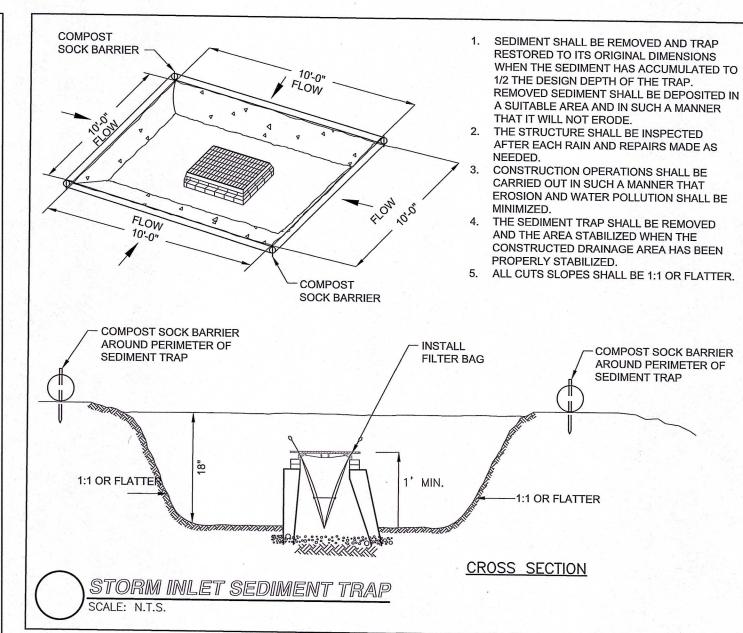

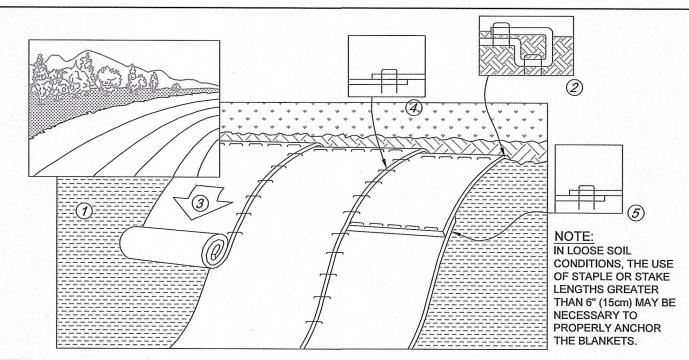

PREPARE SOIL BEFORE INSTALLING BLANKETS, INCLUDING ANY NECESSARY APPLICATION OF LIME, FERTILIZER, AND SEED. NOTE: WHEN USING CELL-O-SEED DO NOT SEED PREPARED AREA. CELL-O-SEED MUST BE INSTALLED WITH PAPER

BEGIN AT THE TOP OF THE SLOPE BY ANCHORING THE BLANKET IN A 6" (15cm) WIDE TRENCH WITH APPROXIMATELY 12" (30cm) OF BLANKET EXTENDED BEYOND THE UP-SLOPE PORTION OF THE TRENCH. ANCHOR THE BLANKET WITH A ROW OF STAPLES/STAKES APPROXIMATELY 12" (30cm) APART IN THE BOTTOM OF THE TRENCH. BACK FILL AND COMPACT THE TRENCH AFTER STAPLING. APPLY SEED TO PREPARED SOIL AND FOLD REMAINING 12" (30cm) PORTION OF THE BLANKET BACK OVER SEED AND SOIL. SECURE BLANKET OVER SOIL WITH A ROW OF STAPLES/STAKES SPACED APPROXIMATELY 12" (30cm) APART ACROSS THE WIDTH OF THE BLANKET.

ROLL THE BLANKETS DOWN ACROSS THE SLOPE. BLANKETS WILL UNROLL WITH THE APPROPRIATE SIDE AGAINST THE SOIL SURFACE. ALL BLANKETS MUST BE SECURELY FASTENED TO SOIL SURFACE BY PLACING STAPLES/STAKES IN APPROPRIATE LOCATIONS AS SHOWN IN THE STAPLE PATTERN GUIDE. WHEN USING OPTIONAL DOT SYSTEM, STAPLES/STAKES SHOULD BE PLACED THROUGH EACH OF THE COLORED


THE EDGES OF PARALLEL BLANKETS MUST BE STAPLED WITH APPROXIMATELY 2"-5" (5cm-12.5cm) OVERLAP DEPENDING ON BLANKET TYPE. TO ENSURE PROPER SEAM ALIGNMENT, PLACE THE EDGE OF THE OVERLAPPING BLANKET (BLANKET BEING INSTALLED ON TOP) EVEN WITH THE COLORED SEAM STITCH ON THE PREVIOUSLY INSTALLED BLANKET.

CONSECUTIVE BLANKETS SPLICED DOWN THE SLOPE MUST BE PLACED END OVER END (SHINGLE STYLE) WITH AN APPROXIMATE 3" (7.5cm) OVERLAP. STAPLE THROUGH OVERLAPPED AREA, APPROXIMATELY 12" (30cm) ÁPART ACROSS ENTIRE BLANKET WIDTH.

EROSION CONTROL BLANKETS SHALL BE INSTALLED FOLLOWING MANUFACTURERS SPECIFICATIONS.

DOTS CORRESPONDING TO THE APPROPRIATE STAPLE PATTERN.

EROSION CONTROL BLANKET DETAIL FOR SLOPE INSTALLATION SCALE: N.T.S.

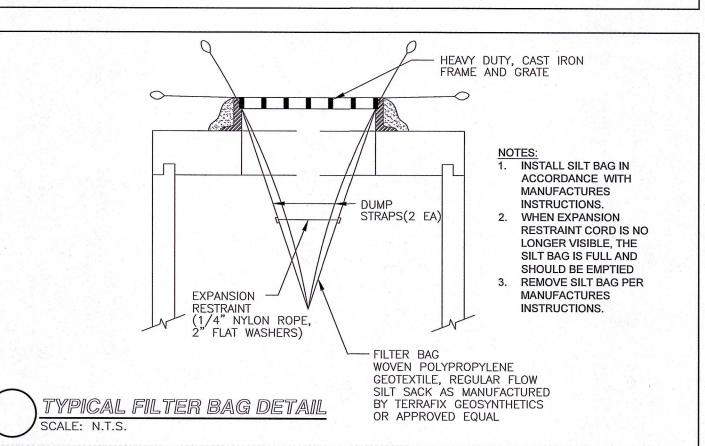

NOT FOR CONSTRUCTION

Copyright © 2021 R.J. O'Connell & Associates, Inc.

**DESIGNED BY:** MAC REVISED PER CONCOM PEER REVIEW COMMENTS 05/10/2024 DRAWN BY: MCR REVISED PER CONCOM PEER REVIEW COMMENTS 03/28/2024 BJM REVIEWED BY: REVISED PER ZBA PEER REVIEW COMMENTS 02/12/2024 REVISED PER ZBA PEER REVIEW COMMENTS 02/02/2024 SCALE: N.T.S. REVISED PER ONSITE SOIL TESTING RESULTS/NOI SUBMISSION 12/18/2023 DATE REVISION

1. PIT IS SPECIFICALLY DESIGNATED, DIKED AND IMPERVIOUS CONTAINMENT TO

PREVENT CONTACT BETWEEN CONCRETE WASH AND STORMWATER.

WASH WATER SHALL NOT BE ALLOWED TO FLOW TO SURFACE WATER.

MINIMUM FREEBOARD OF 12."

BE DISPOSED OF IN THE PIT.

WAYS, INLETS, & SURFACE WATERS.

THE SITE WHEN 95% FULL CAPACITY.

CONCRETE WASHOUT AREA

FAIRFIELD GROVE STREET LLC 30 BRAINTREE HILL OFFICE PARK

SUITE 105 BRAINTREE, MA 02184

BRIAN P. DUNDON CIVIL No. 41505 Br. Numb 5-10-2024

RJO'CONNELL & ASSOCIATES, INC.

PROJECT NAME:

**CIVIL ENGINEERS, SURVEYORS & LAND PLANNERS** 80 MONTVALE AVENUE, SUITE 201 STONEHAM, MA 02180 PHONE: 781.279.0180 RJOCONNELL.COM


SITE **DETAILS - II** 

DRAWING NAME:

RAWING NUMBER:

**GROVE STREET RESIDENCES** FRANKLIN, MA

10/30/2023 PROJECT NO.: 22016

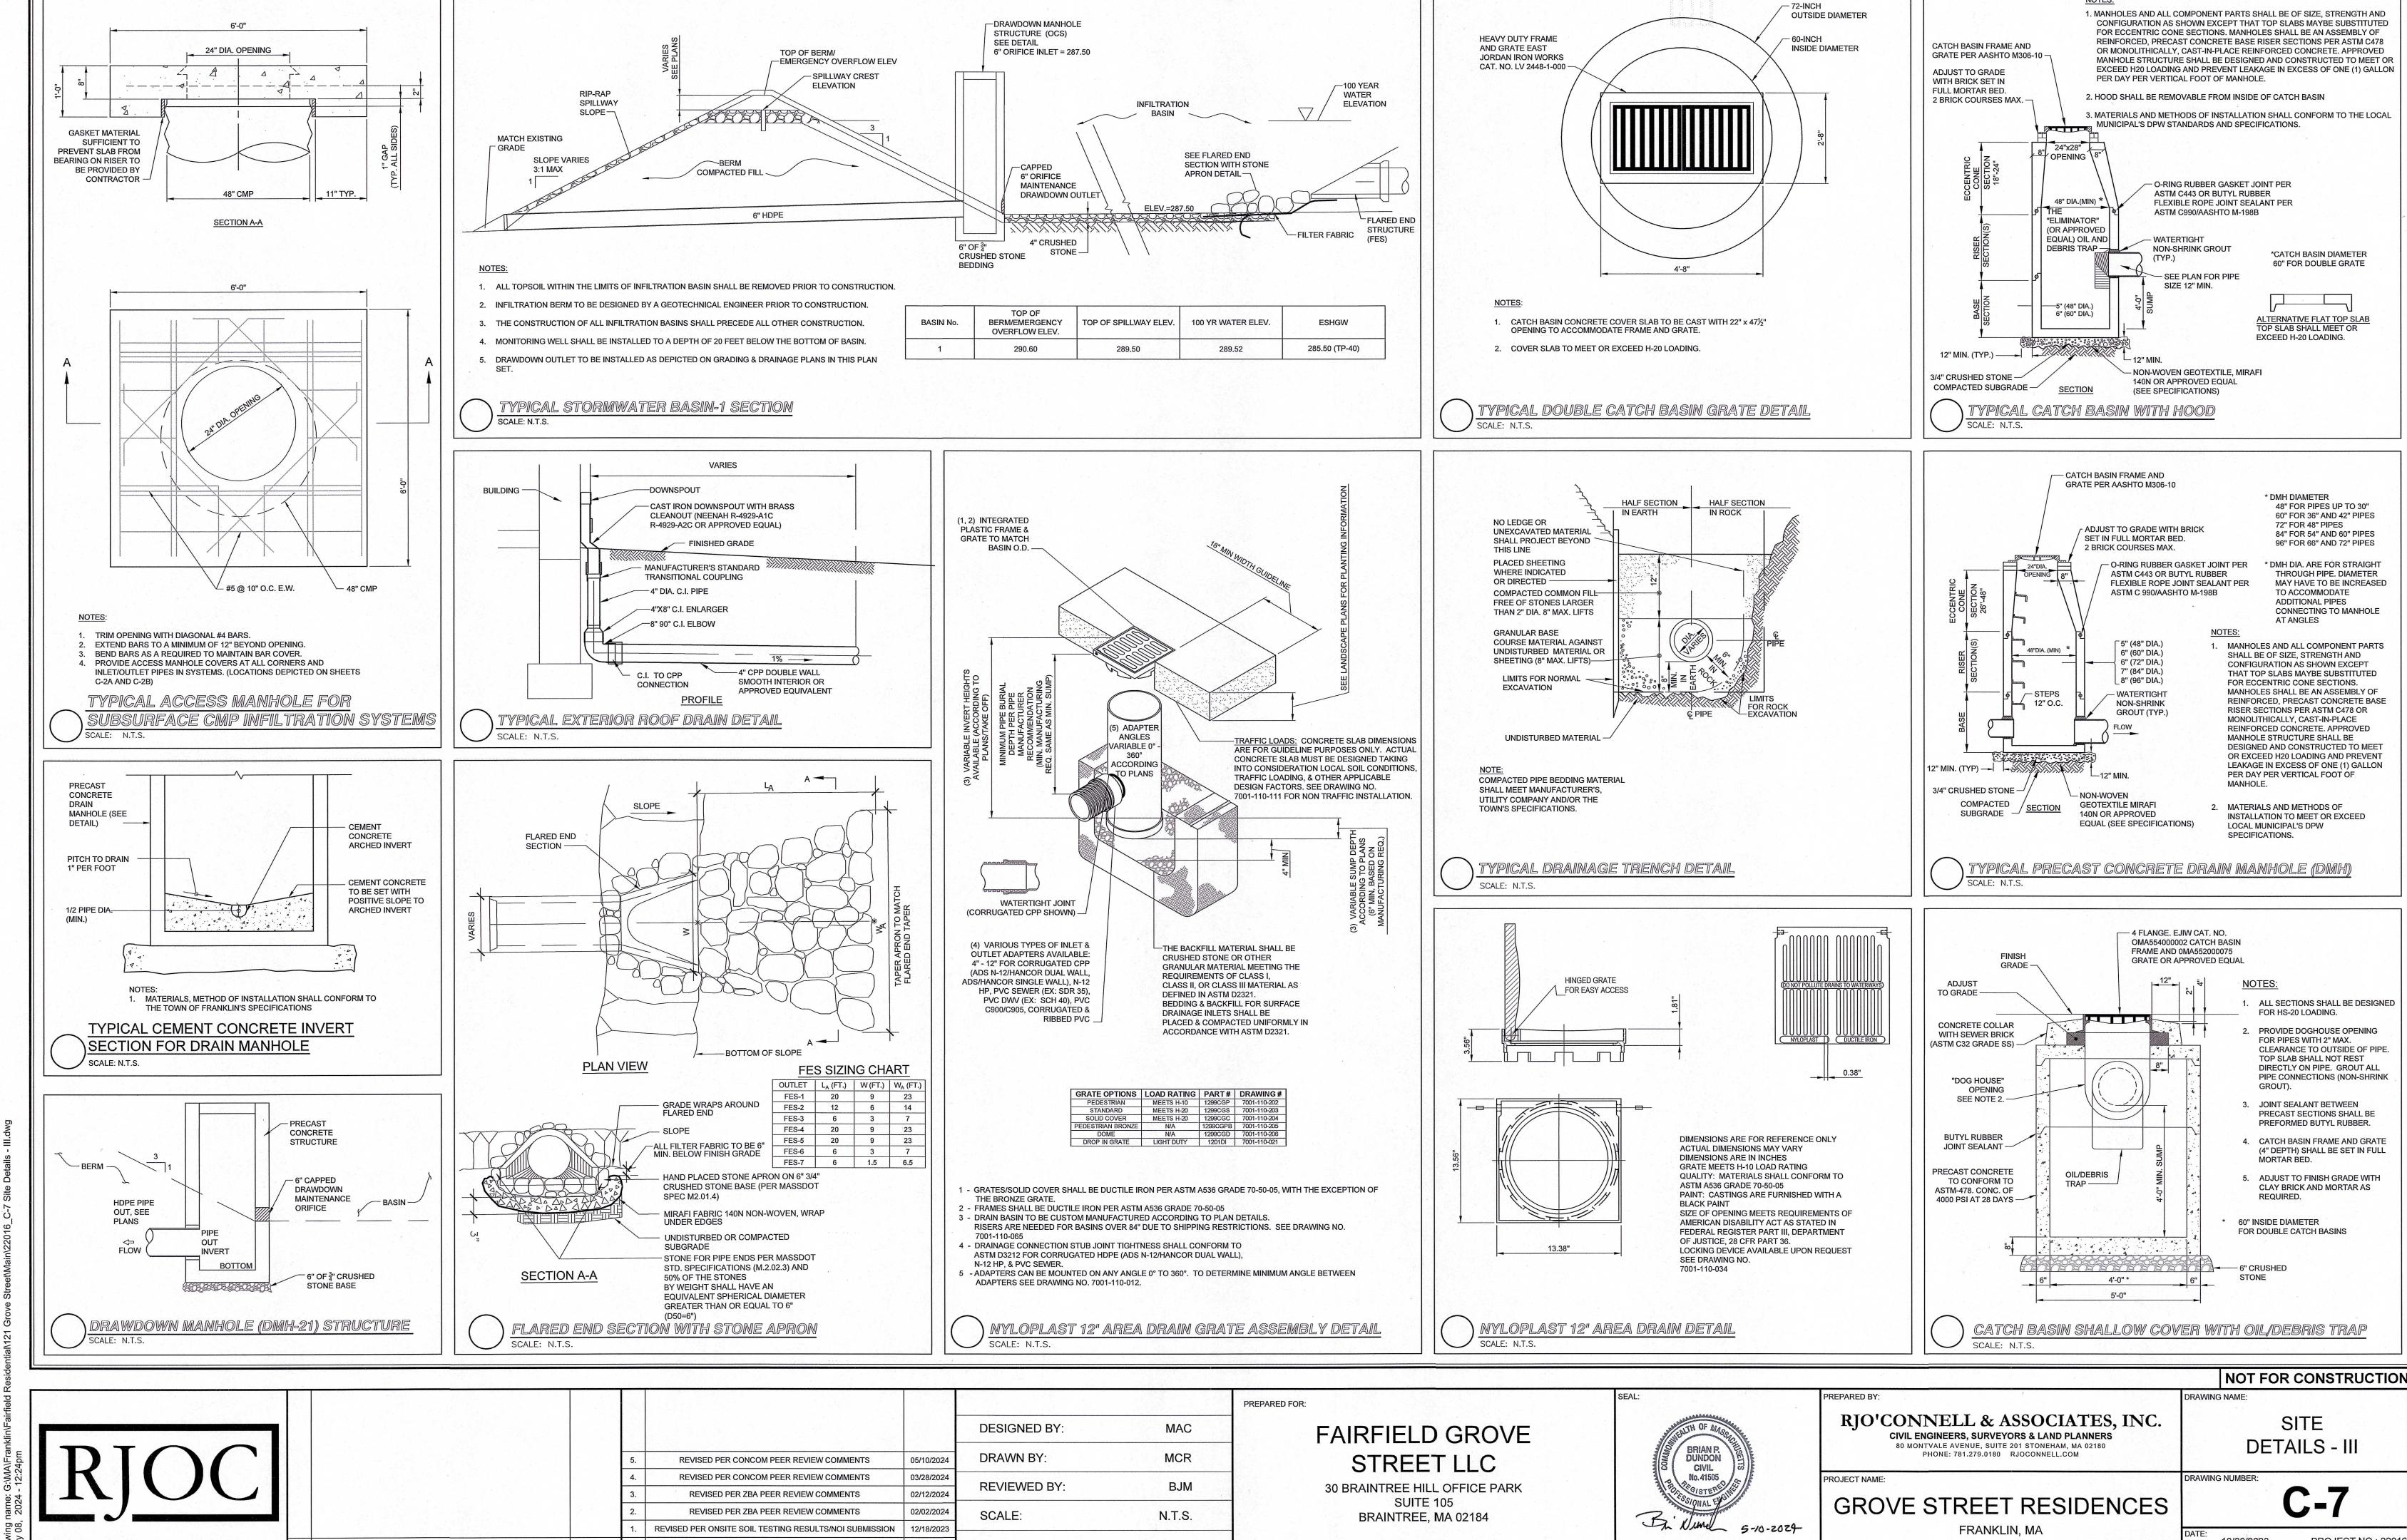

DATE


REVISION


PROJECT NO.: 22016


Copyright © 2023 by R.J. O'Connell & Associates, Inc.


Copyright © 2021 R.J. O'Connell & Associates, Inc.


REVISION

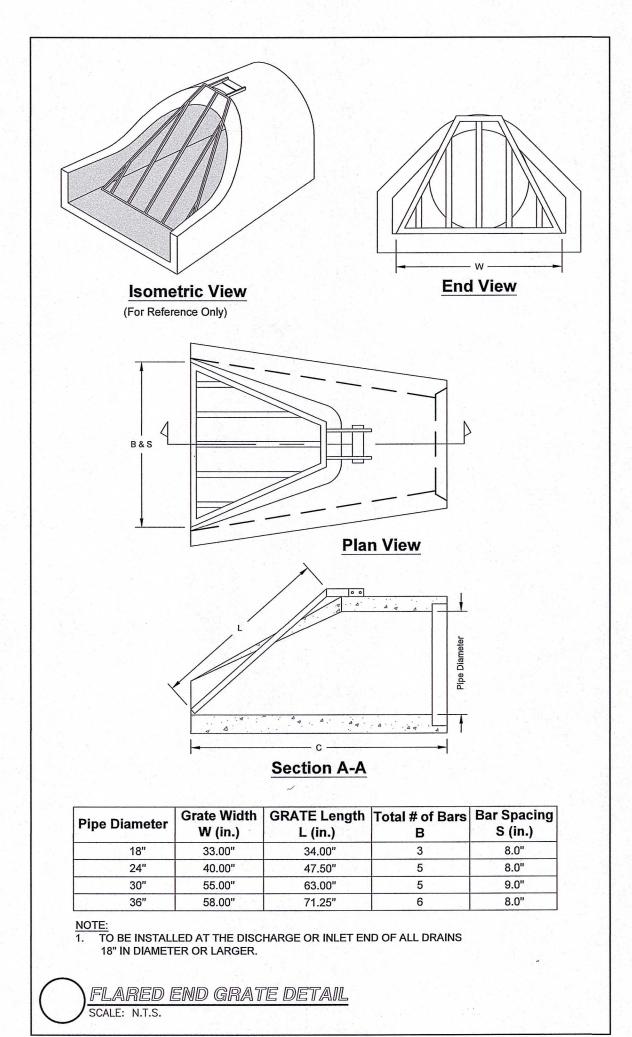


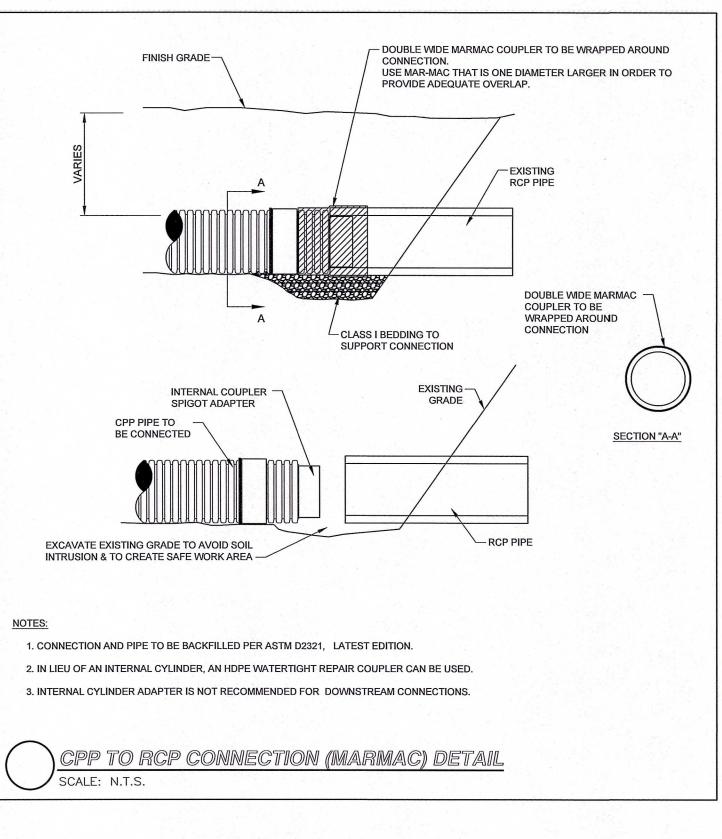


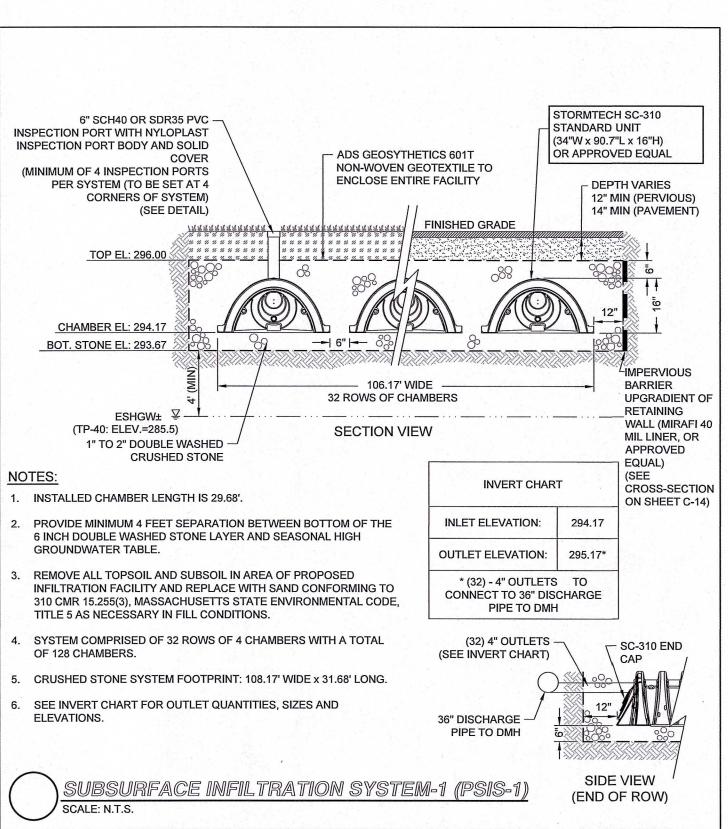


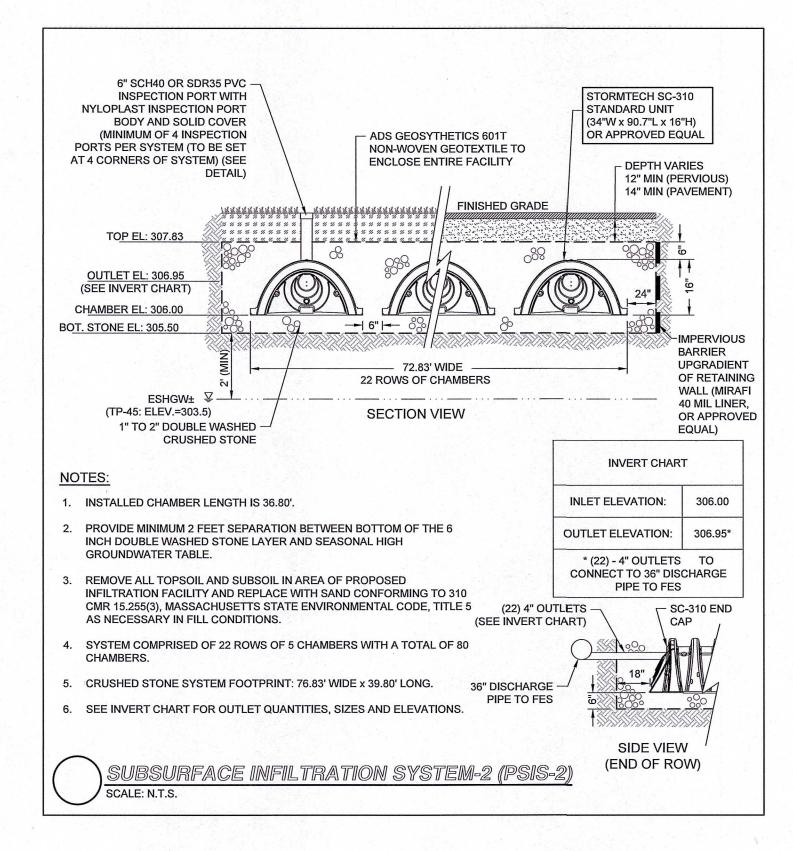

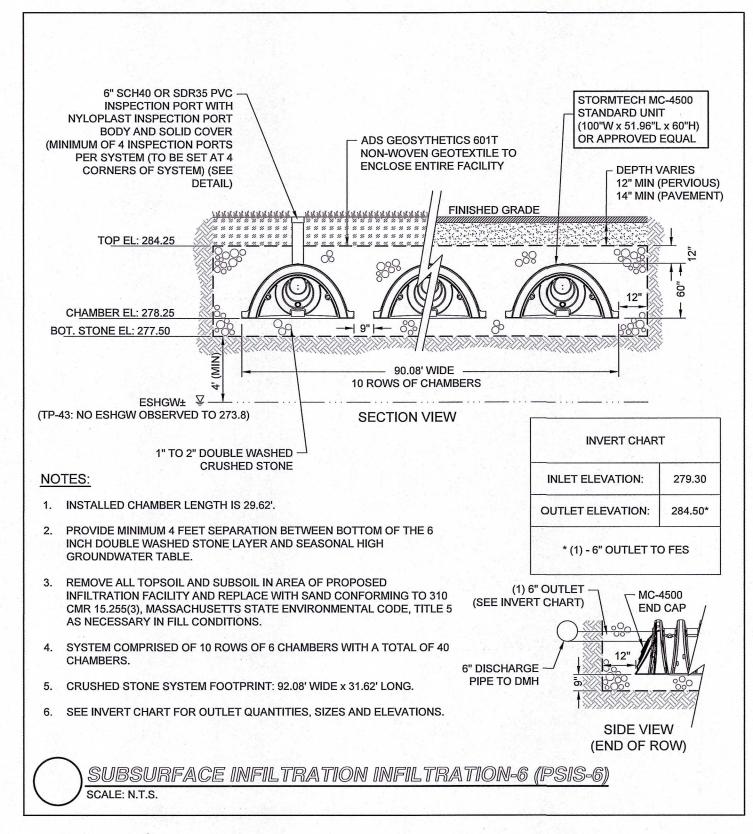

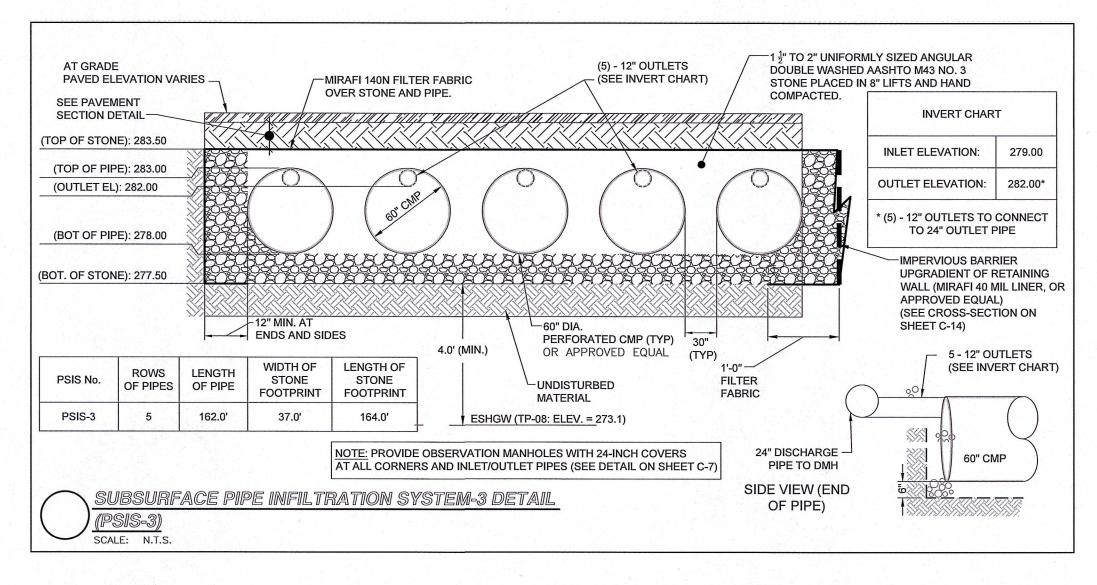

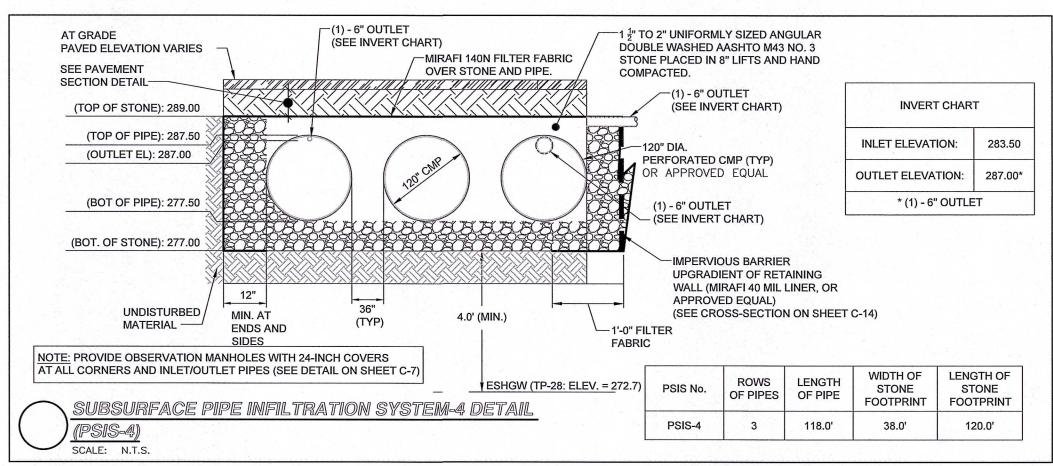

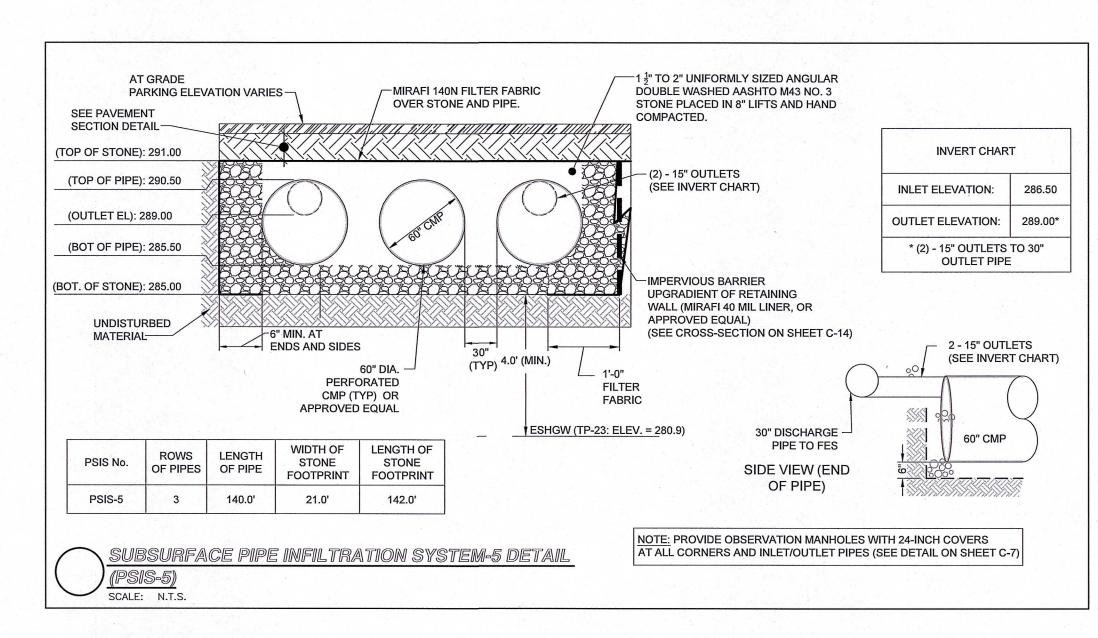

NOT FOR CONSTRUCTION



REVISION

REVISED PER CONCOM PEER REVIEW COMMENTS REVISED PER CONCOM PEER REVIEW COMMENTS REVISED PER ZBA PEER REVIEW COMMENTS REVISED PER ZBA PEER REVIEW COMMENTS REVISED PER ONSITE SOIL TESTING RESULTS/NOI SUBMISSION REVISION

**DESIGNED BY:** DRAWN BY: 05/10/2024 03/28/2024 REVIEWED BY 02/12/2024 02/02/2024 SCALE: N.T.S. 12/18/2023

FAIRFIELD GROVE STREET LLC 30 BRAINTREE HILL OFFICE PARK SUITE 105

BRAINTREE, MA 02184

PREPARED FOR:

MAC

MCR

BJM

DUNDON CIVIL No. 41505 5-10-2024

REPARED BY: RJO'CONNELL & ASSOCIATES, INC.

**CIVIL ENGINEERS, SURVEYORS & LAND PLANNERS** 80 MONTVALE AVENUE, SUITE 201 STONEHAM, MA 02180 PHONE: 781.279.0180 RJOCONNELL.COM

SITE **DETAILS - IV** 


DRAWING NAME:


PROJECT NAME: **GROVE STREET RESIDENCES** 

DRAWING NUMBER

PROJECT NO.: 22016 10/30/2023 Copyright © 2023 by R.J. O'Connell & Associates, Inc.

FRANKLIN, MA

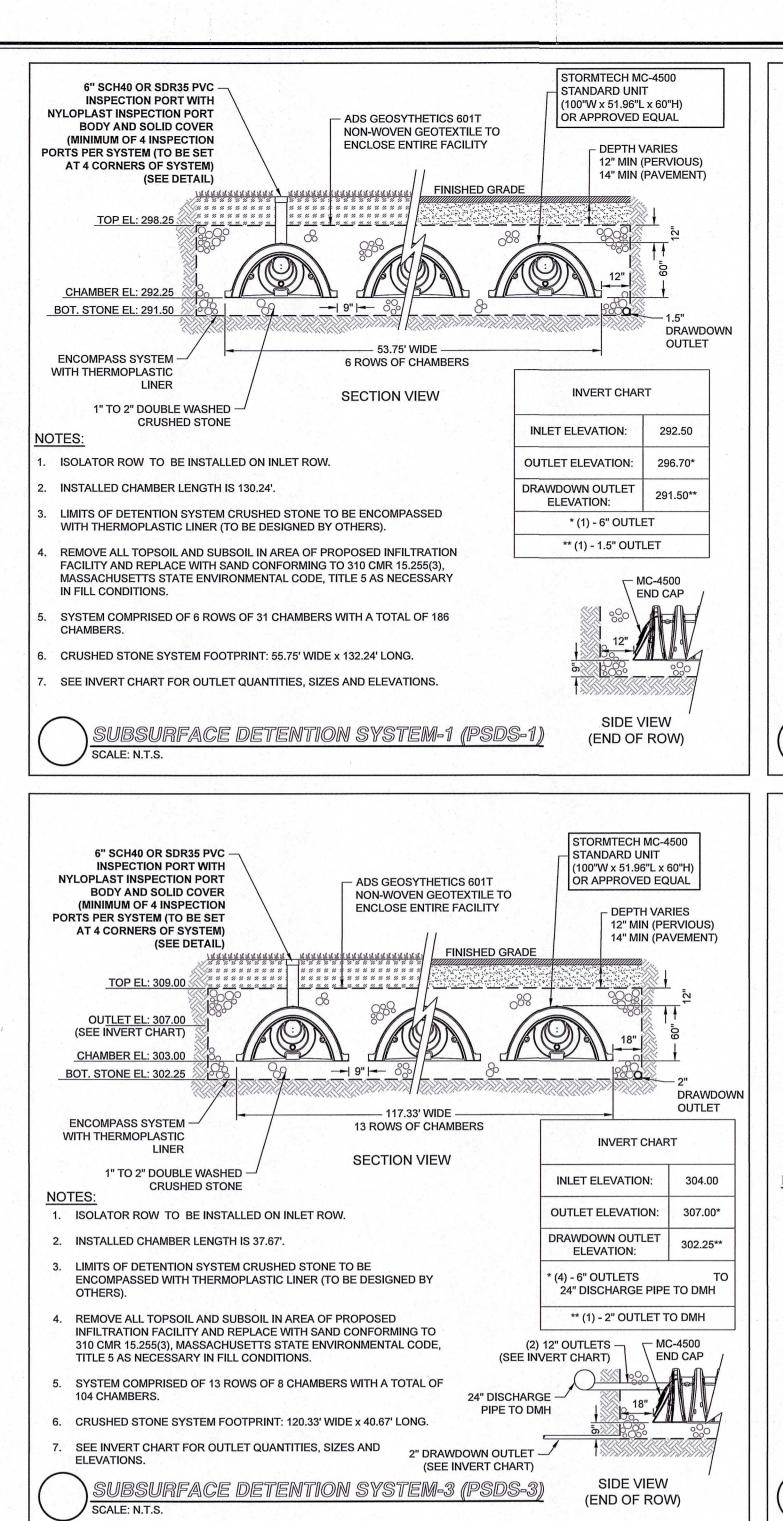

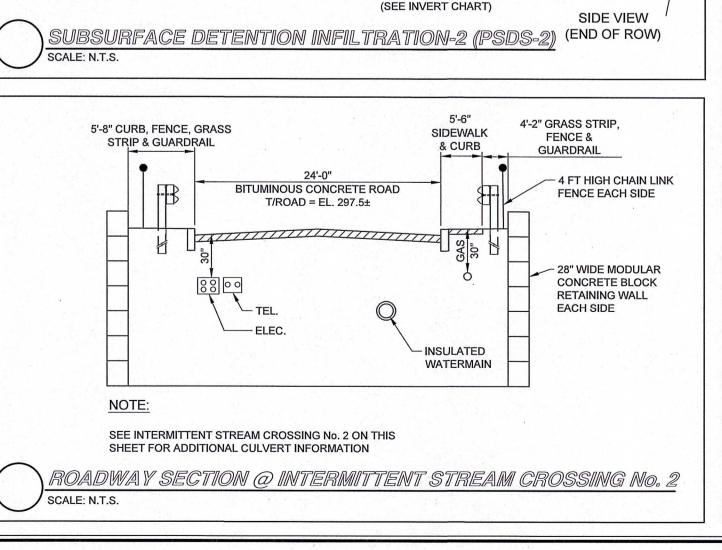

STORMTECH MC-3500

77"W x 90"L x 45"H)

OR APPROVED EQUAL

- DEPTH VARIES

12" MIN (PERVIOUS)

14" MIN (PAVEMENT)

-IMPERVIOUS

**UPGRADIENT** 

OF RETAINING

WALL (MIRAFI

40 MIL LINER,

EQUAL)

INVERT CHART

OUTLET ELEVATION: 276.00\*

\* (2) - 6" OUTLETS TO 12"

DISCHARGE PIPE TO FES

END CAP

SIDE VIEW

(END OF ROW)

STORMTECH SC-740

(51"W x 90.72"L x 30"H)

**INVERT CHART** 

\* (3) - 6" OUTLETS

TO 18" OUTLET PIPE

TO DMH

\*\* (1) - 2" OUTLET

TO DMH

(3) 6" OUTLETS - CSC-740 END

INLET ELEVATION:

**OUTLET ELEVATION:** 

DRAWDOWN OUTLET

**ELEVATION:** 

(SEE INVERT CHART)

18" DISCHARGE

2" DRAWDOWN OUTLET -

PIPE TO FES

DEPTH VARIES

12" MIN (PERVIOUS)

14" MIN (PAVEMENT)

OUTLET

CHART)

308.50\*

(SEE INVER

OR APPROVED EQUAL

INLET ELEVATION:

(2) 6" OUTLETS -

(SEE INVERT CHART)

12" DISCHARGE -

PIPE TO FES

OR APPROVED

STANDARD UNIT

- ADS GEOSYTHETICS 601T

**ENCLOSE ENTIRE FACILITY** 

3 ROWS OF CHAMBERS

ADS GEOSYTHETICS 601T

- 13.75' WIDE

3 ROWS OF CHAMBERS

**SECTION VIEW** 

NON-WOVEN GEOTEXTILE TO

**ENCLOSE ENTIRE FACILITY** 

**SECTION VIEW** 

NON-WOVEN GEOTEXTILE TO

FINISHED GRADE

6" SCH40 OR SDR35 PVC -

INSPECTION PORT WITH

(SEE DETAIL)

**BODY AND SOLID COVER** 

(MINIMUM OF 4 INSPECTION

NYLOPLAST INSPECTION PORT

PORTS PER SYSTEM (TO BE SET

CHAMBER EL: 272.75

CONDITIONS.

ELEVATIONS.

ESHGW± ¥-

1" TO 2" DOUBLE WASHED -

HIGH GROUNDWATER TABLE.

TOTAL OF 18 CHAMBERS.

6" SCH40 OR SDR35 PVC -

INSPECTION PORT WITH

**BODY AND SOLID COVER** 

(MINIMUM OF 4 INSPECTION

NYLOPLAST INSPECTION PORT

PORTS PER SYSTEM (TO BE SET

OUTLET EL: 311.0 (SEE INVERT CHART

CHAMBER EL: 309.00

BOT. STONE EL: 308.50

ENCOMPASS SYSTEM -

1" TO 2" DOUBLE WASHED -

INSTALLED CHAMBER LENGTH IS 65.70'.

TITLE 5 AS NECESSARY IN FILL CONDITIONS.

CRUSHED STONE

LIMITS OF DETENTION SYSTEM CRUSHED STONE TO BE

ENCOMPASSED WITH THERMOPLASTIC LINER (TO BE DESIGNED BY

INFILTRATION FACILITY AND REPLACE WITH SAND CONFORMING TO

310 CMR 15.255(3), MASSACHUSETTS STATE ENVIRONMENTAL CODE,

SYSTEM COMPRISED OF 3 ROWS OF 9 CHAMBERS WITH A TOTAL OF

CRUSHED STONE SYSTEM FOOTPRINT: 15.75' WIDE x 67.70' LONG.

SEE INVERT CHART FOR OUTLET QUANTITIES, SIZES AND

REMOVE ALL TOPSOIL AND SUBSOIL IN AREA OF PROPOSED

WITH THERMOPLASTIC

27 CHAMBERS.

ELEVATIONS.

5'-8" CURB, GRASS

STRIP, FENCE

& GUARDRAIL

4 FT HIGH CHAIN LINK

FENCE EACH SIDE

CONCRETE BLOCK **RETAINING WALL** 

- 28" WIDE

MODULAR

EACH SIDE

TEL.

- WATERMAIN

REVISION

ROADWAY SECTION @ INTERMITTENT STREAM CROSSING No. .

AT 4 CORNERS OF SYSTEM

CRUSHED STONE

1. INSTALLED CHAMBER LENGTH IS 46.72'.

PROVIDE MINIMUM 4 FEET SEPARATION BETWEEN BOTTOM OF

THE 6 INCH DOUBLE WASHED STONE LAYER AND SEASONAL

REMOVE ALL TOPSOIL AND SUBSOIL IN AREA OF PROPOSED

ENVIRONMENTAL CODE, TITLE 5 AS NECESSARY IN FILL

SYSTEM COMPRISED OF 3 ROWS OF 6 CHAMBERS WITH A

5. CRUSHED STONE SYSTEM FOOTPRINT: 22.75' WIDE x 48.72'

6. SEE INVERT CHART FOR OUTLET QUANTITIES, SIZES AND

UBSURFACE INFILTRATION SYSTEM-7 (PSIS-7)

<del>-</del>| 6" <del>|-</del>


CONFORMING TO 310 CMR 15.255(3), MASSACHUSETTS STATE


INFILTRATION FACILITY AND REPLACE WITH SAND


(TP-39: ELEV.=267.2)

BOT. STONE EL: 272.00

AT 4 CORNERS OF SYSTEM

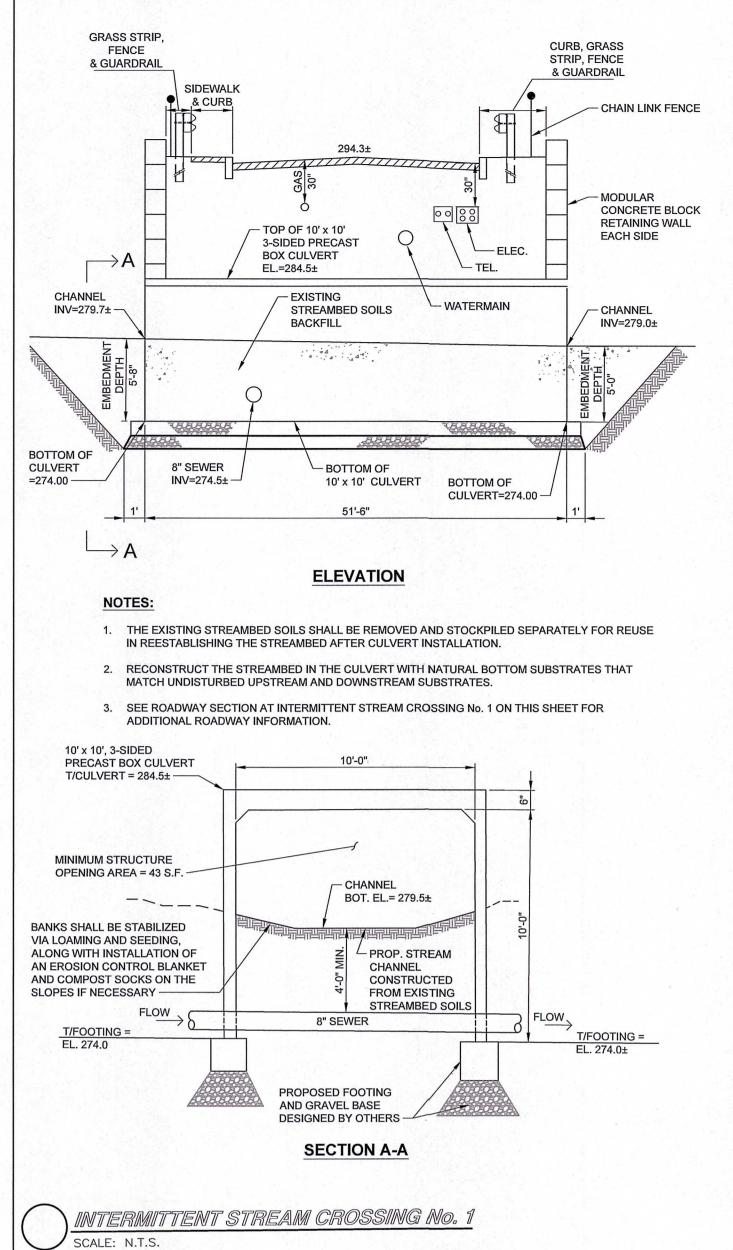

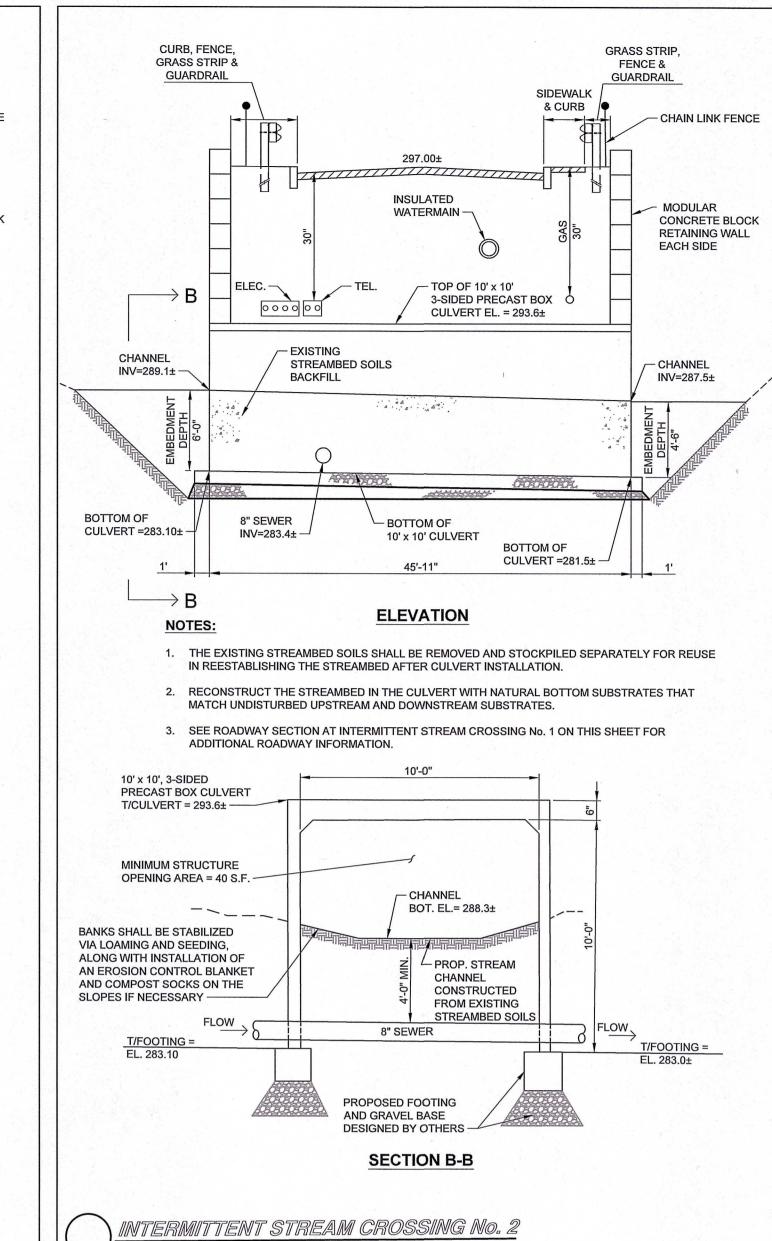

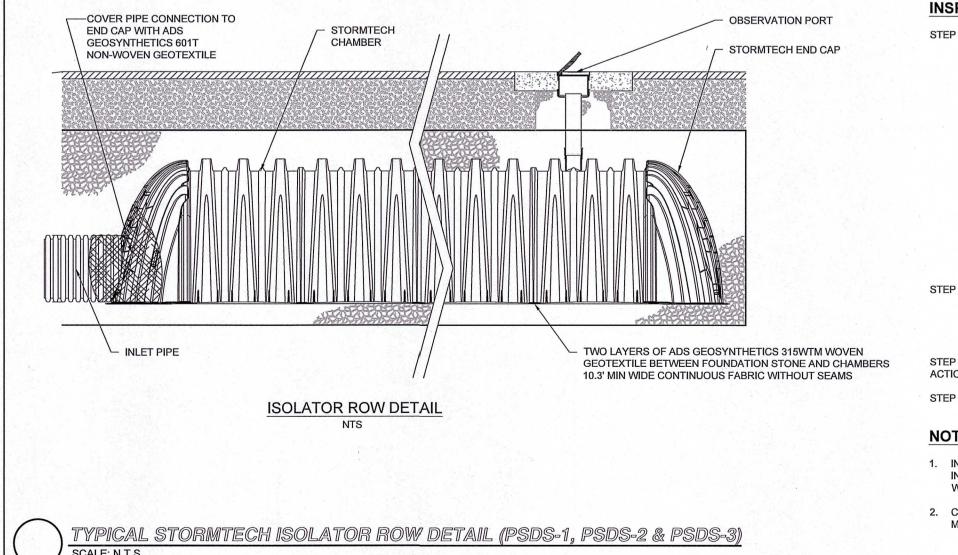

**INSPECTION & MAINTENANCE** 

STEP 1) INSPECT ISOLATOR ROW FOR SEDIMENT A. OBSERVATION PORTS

A.1. REMOVE/OPEN LID ON NYLOPLAST INLINE DRAIN

A.2. REMOVE AND CLEAN FLEXSTORM FILTER IF INSTALLED A.3. USING A FLASHLIGHT AND STADIA ROD, MEASURE DEPTH OF SEDIMENT AND

RECORD ON MAINTENANCE LOG A.4. LOWER A CAMERA INTO ISOLATOR ROW FOR VISUAL INSPECTION OF

SEDIMENT LEVELS (OPTIONAL) A.5. IF SEDIMENT IS AT, OR ABOVE, 3" PROCEED TO STEP 2. IF NOT, PROCEED TO

B. ALL ISOLATOR ROWS

B.1. REMOVE COVER FROM STRUCTURE AT UPSTREAM END OF ISOLATOR ROW B.2. USING A FLASHLIGHT, INSPECT DOWN THE ISOLATOR ROW THROUGH OUTLET i) MIRRORS ON POLES OR CAMERAS MAY BE USED TO AVOID A CONFINED SPACE ENTRY

ii) FOLLOW OSHA REGULATIONS FOR CONFINED SPACE ENTRY IF ENTERING B.3. IF SEDIMENT IS AT, OR ABOVE, 3" PROCEED TO STEP 2. IF NOT, PROCEED TO

STEP 2) CLEAN OUT ISOLATOR ROW USING THE JETVAC PROCESS A. A FIXED CULVERT CLEANING NOZZLE WITH REAR FACING SPREAD OF 45" OR MORE

APPLY MULTIPLE PASSES OF JETVAC UNTIL BACKFLUSH WATER IS CLEAN

VACUUM STRUCTURE SUMP AS REQUIRED

STEP 3) REPLACE ALL COVERS, GRATES, FILTERS, AND LIDS; RECORD OBSERVATIONS AND


STEP 4) INSPECT AND CLEAN BASINS AND MANHOLES UPSTREAM OF THE STORMTECH SYSTEM.

SCALE: N.T.S.

1. INSPECT EVERY 6 MONTHS DURING THE FIRST YEAR OF OPERATION. ADJUST THE INSPECTION INTERVAL BASED ON PREVIOUS OBSERVATIONS OF SEDIMENT ACCUMULATION AND HIGH

2. CONDUCT JETTING AND VACTORING ANNUALLY OR WHEN INSPECTION SHOWS THAT MAINTENANCE IS NECESSARY

NOT FOR CONSTRUCTION

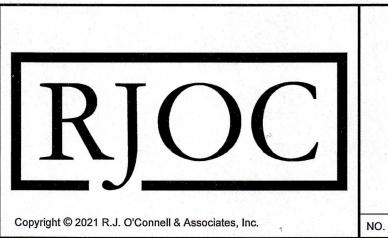

SCALE: N.T.S.

4'-2" GRASS

STRIP, FENCE

& GUARDRAIL

5'-6" SIDEWALK

& CURB

SEE INTERMITTENT STREAM CROSSING No. 1 ON THIS

SHEET FOR ADDITIONAL CULVERT INFORMATION

BITUMINOUS CONCRETE ROAD


T/ROAD = EL. 294.0±

				DESIGNED BY:	MAC
	5.	REVISED PER CONCOM PEER REVIEW COMMENTS	05/10/2024	DRAWN BY:	MCR
	4.	REVISED PER CONCOM PEER REVIEW COMMENTS	03/28/2024	DEMEMED DV	
	3.	REVISED PER ZBA PEER REVIEW COMMENTS	02/12/2024	REVIEWED BY:	BJM
	2.	REVISED PER ZBA PEER REVIEW COMMENTS	02/02/2024	SCALE:	N.T.S.
	1.	REVISED PER ONSITE SOIL TESTING RESULTS/NOI SUBMISSION	12/18/2023	OO/12L.	N.1.0.
ATE	NO.	REVISION	DATE		

FAIRFIELD GROVE STREET LLC

PREPARED FOR:

30 BRAINTREE HILL OFFICE PARK SUITE 105 BRAINTREE, MA 02184

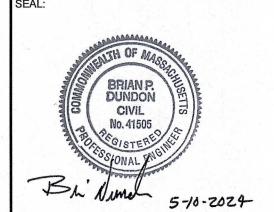

RJO'CONNELL & ASSOCIATES, INC.

**CIVIL ENGINEERS, SURVEYORS & LAND PLANNERS** 80 MONTVALE AVENUE, SUITE 201 STONEHAM, MA 02180

PHONE: 781.279.0180 RJOCONNELL.COM

SITE **DETAILS - V** 

DRAWING NAME:


DRAWING NUMBER

**GROVE STREET RESIDENCES** 

PROJECT NO.: 22016 10/30/2023

Copyright © 2023 by R.J. O'Connell & Associates, Inc.

FRANKLIN, MA

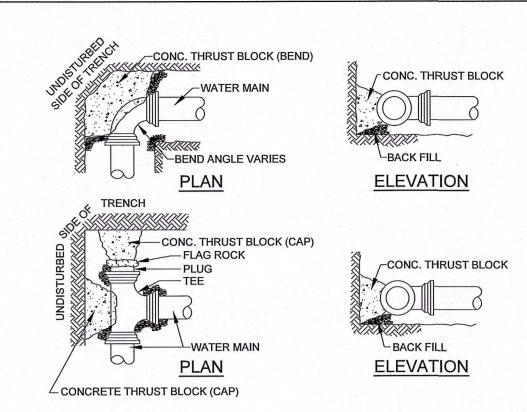

IVI	INIMUM THRUST B	LOOKING BE	311111071112	to into deprint	
PIPE DIA.	TEES/CAP/HYD	90° BEND	45° BEND	22.5° BEND	11.25° BEND
4"	2	2	2	2	1
6"	4	5	3	2	1
8"	6	8	5	2	1
10"	9	13	7	3	2
12"	13	18	10	4	3
14"	18	25	14	6	4
16"	23	32	18	8	6


1. ALL WATER MAIN FITTINGS, BENDS, TEES, PLUGS ETC. SHALL BE RESTRAINED W/ THRUST BLOCKS EXCEPT WHERE NOTED.

- 2. ALL THRUST BLOCKS & COLLARS SHALL BE INSTALLED SO THAT THEY BEAR AGAINST UNDISTURBED EARTH. 3. SIZE OF CONCRETE THRUST BLOCKS AS NOTED BELOW.
- 4. MINIMUM COMPRESSIVE STRENGTH OF THRUST BLOCK CONCRETE SHALL BE 4,000 P.S.I.


5. MINIMUM BEARING AREA BASED ON 2000 LB/SF ALLOWABLE SOIL BEARING PRESSURE WITH A 1.5 SAFETY FACTOR.


6. A MINIMUM OF 1/3 CUBIC YARD OF CONCRETE MUST BE USED FOR THRUST BLOCKS 7. MATERIALS, METHOD INSTALLATION SHALL CONFORM TO THE TOWN OF FRANKLIN'S WATER/SEWER DEPARTMENT'S SPECIFICATIONS.


## TYPICAL THRUST BLOCK DETAIL

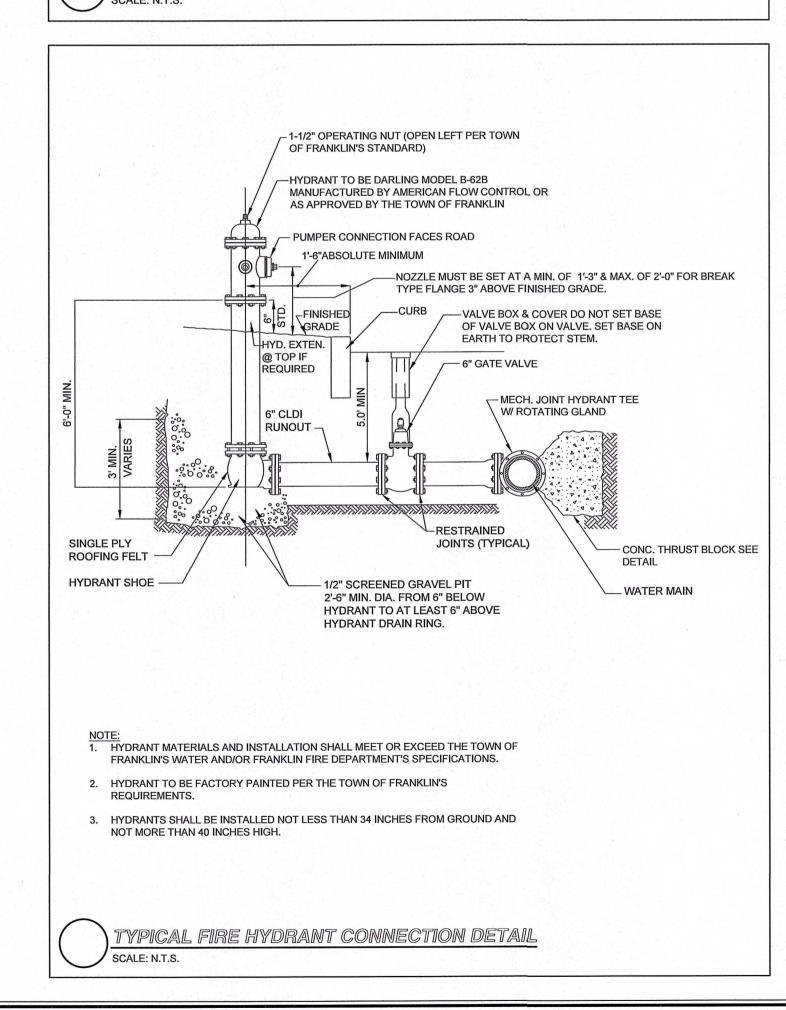



REVISION

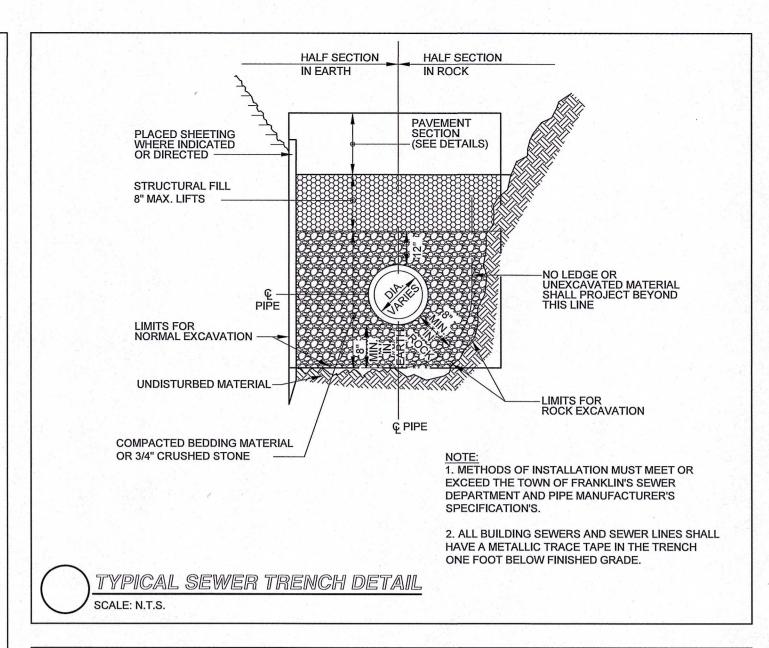

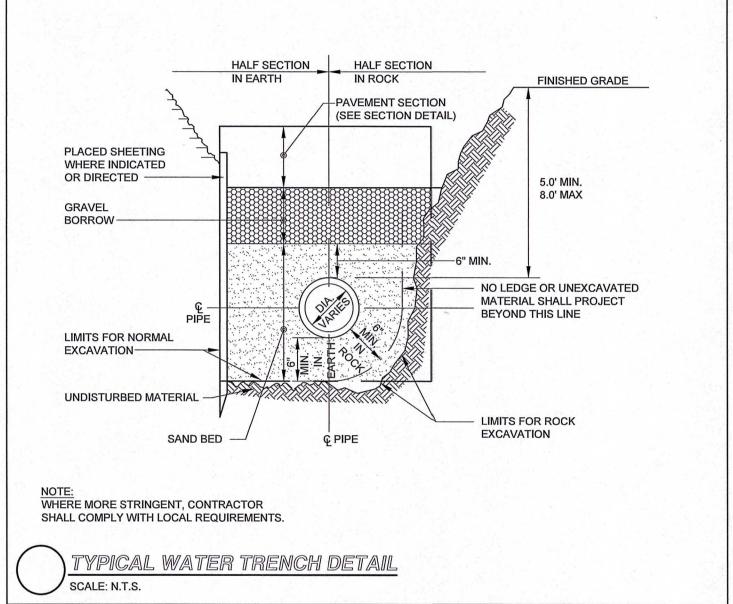

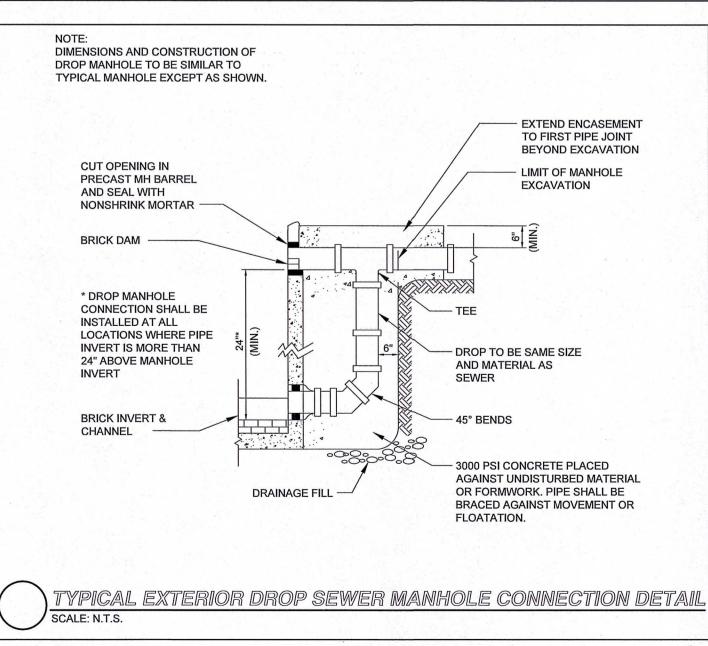

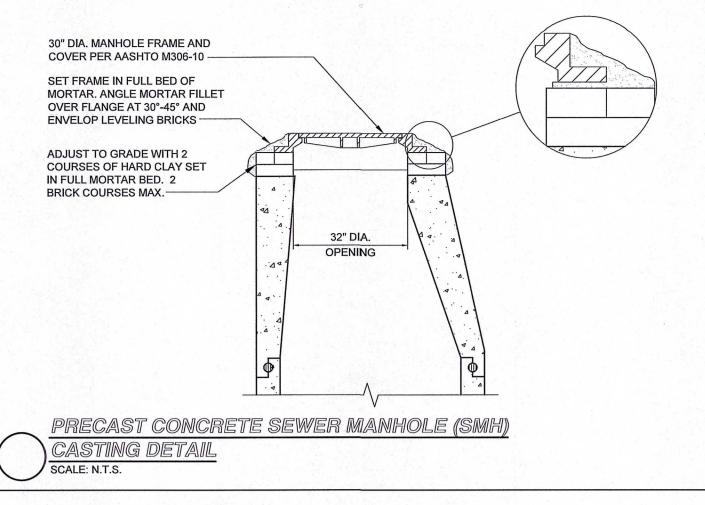

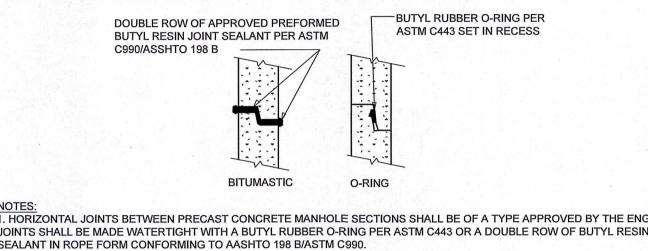



1. HORIZONTAL JOINTS BETWEEN PRECAST CONCRETE MANHOLE SECTIONS SHALL BE OF A TYPE APPROVED BY THE ENGINEER. JOINTS SHALL BE MADE WATERTIGHT WITH A BUTYL RUBBER O-RING PER ASTM C443 OR A DOUBLE ROW OF BUTYL RESIN JOINT SEALANT IN ROPE FORM CONFORMING TO AASHTO 198 B/ASTM C990.

2. ALL GASKETS AND SEALANTS SHALL BE INSTALLED IN ACCORDANCE WITH MANUFACTURER'S WRITTEN INSTRUCTIONS 3. FOR BITUMASTIC TYPE JOINTS THE AMOUNT OF SEALANT SHALL BE SUFFICIENT TO FILL AT LEAST 75% OF THE JOINT CAVITY.

4. MATERIALS AND METHOD OF INSTALLATION SHALL CONFORM TO THE TOWN OF FRANKLIN'S SPECIFICATIONS.


DETAIL 'A' SEWER MANHOLE JOINTING METHODS SCALE: N.T.S.

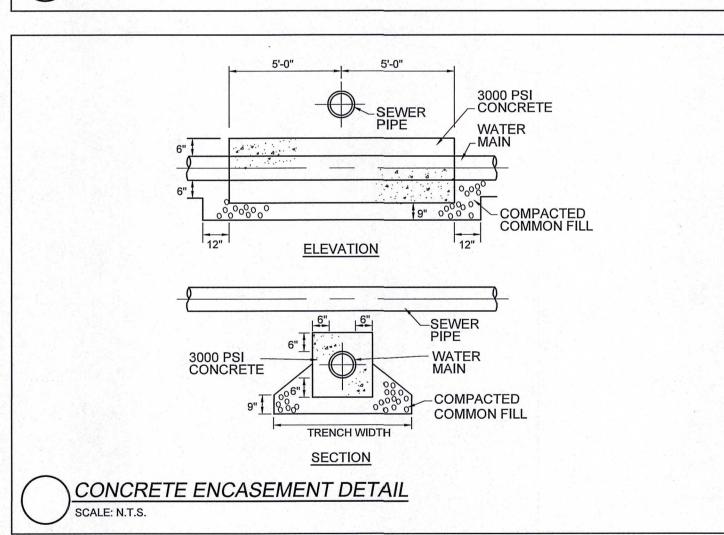


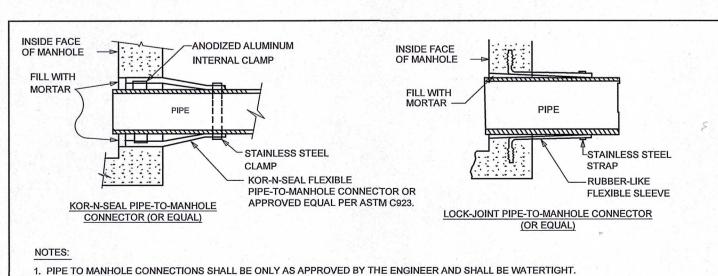


1. PIPE TO MANHOLE CONNECTIONS SHALL BE ONLY AS APPROVED BY THE ENGINEER AND SHALL BE WATERTIGHT. 2. MATERIALS, METHOD OF INSTALLATION SHALL CONFORM TO TOWN OF FRANKLIN'S SPECIFICATIONS.

PIPE CONNECTIONS TO SEWER MANHOLE DETAIL SCALE: N.T.S.

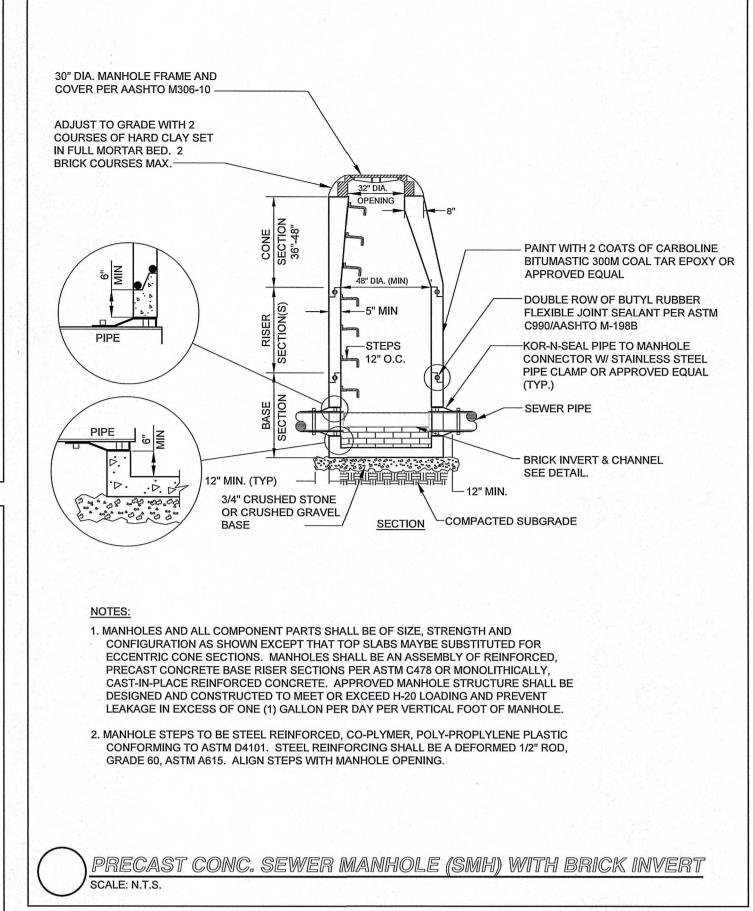

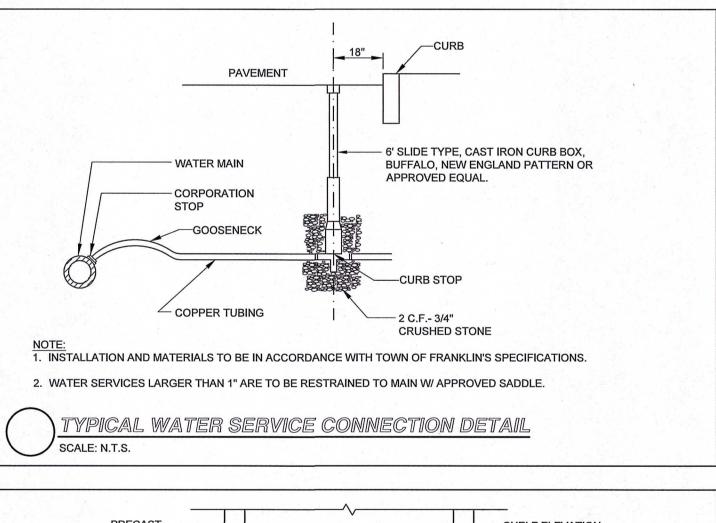

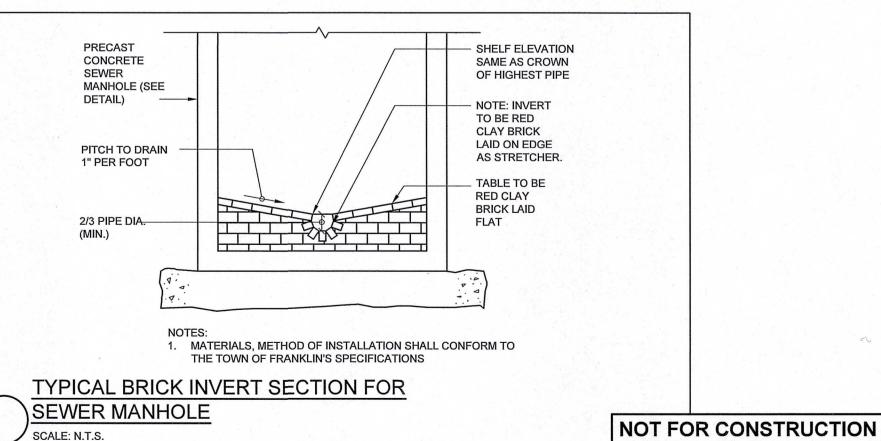



				DESIGNED BY:	MAC
	5.	REVISED PER CONCOM PEER REVIEW COMMENTS	05/10/2024	DRAWN BY:	MCR
	4.	REVISED PER CONCOM PEER REVIEW COMMENTS	03/28/2024		
	3.	REVISED PER ZBA PEER REVIEW COMMENTS	02/12/2024	REVIEWED BY:	ВЈМ
	2.	REVISED PER ZBA PEER REVIEW COMMENTS	02/02/2024	SCALE:	N.T.S.
	1.	REVISED PER ONSITE SOIL TESTING RESULTS/NOI SUBMISSION	12/18/2023	OOMEL.	11.1.0.
DATE	NO.	REVISION	DATE		

PREPARED FOR:

## FAIRFIELD GROVE STREET LLC

30 BRAINTREE HILL OFFICE PARK SUITE 105 BRAINTREE, MA 02184



PREPARED BY:
RJO'CONNELL & ASSOCIATES, INC.
CIVIL ENGINEERS, SURVEYORS & LAND PLANNERS

**GROVE STREET RESIDENCES** 

FRANKLIN, MA


PROJECT NAME:

80 MONTVALE AVENUE, SUITE 201 STONEHAM, MA 02180 PHONE: 781.279.0180 RJOCONNELL.COM


DRAWING NAME:


**DETAILS - VI** 

10/30/2023 PROJECT NO.: 22016 Copyright © 2023 by R.J. O'Connell & Associates, Inc.

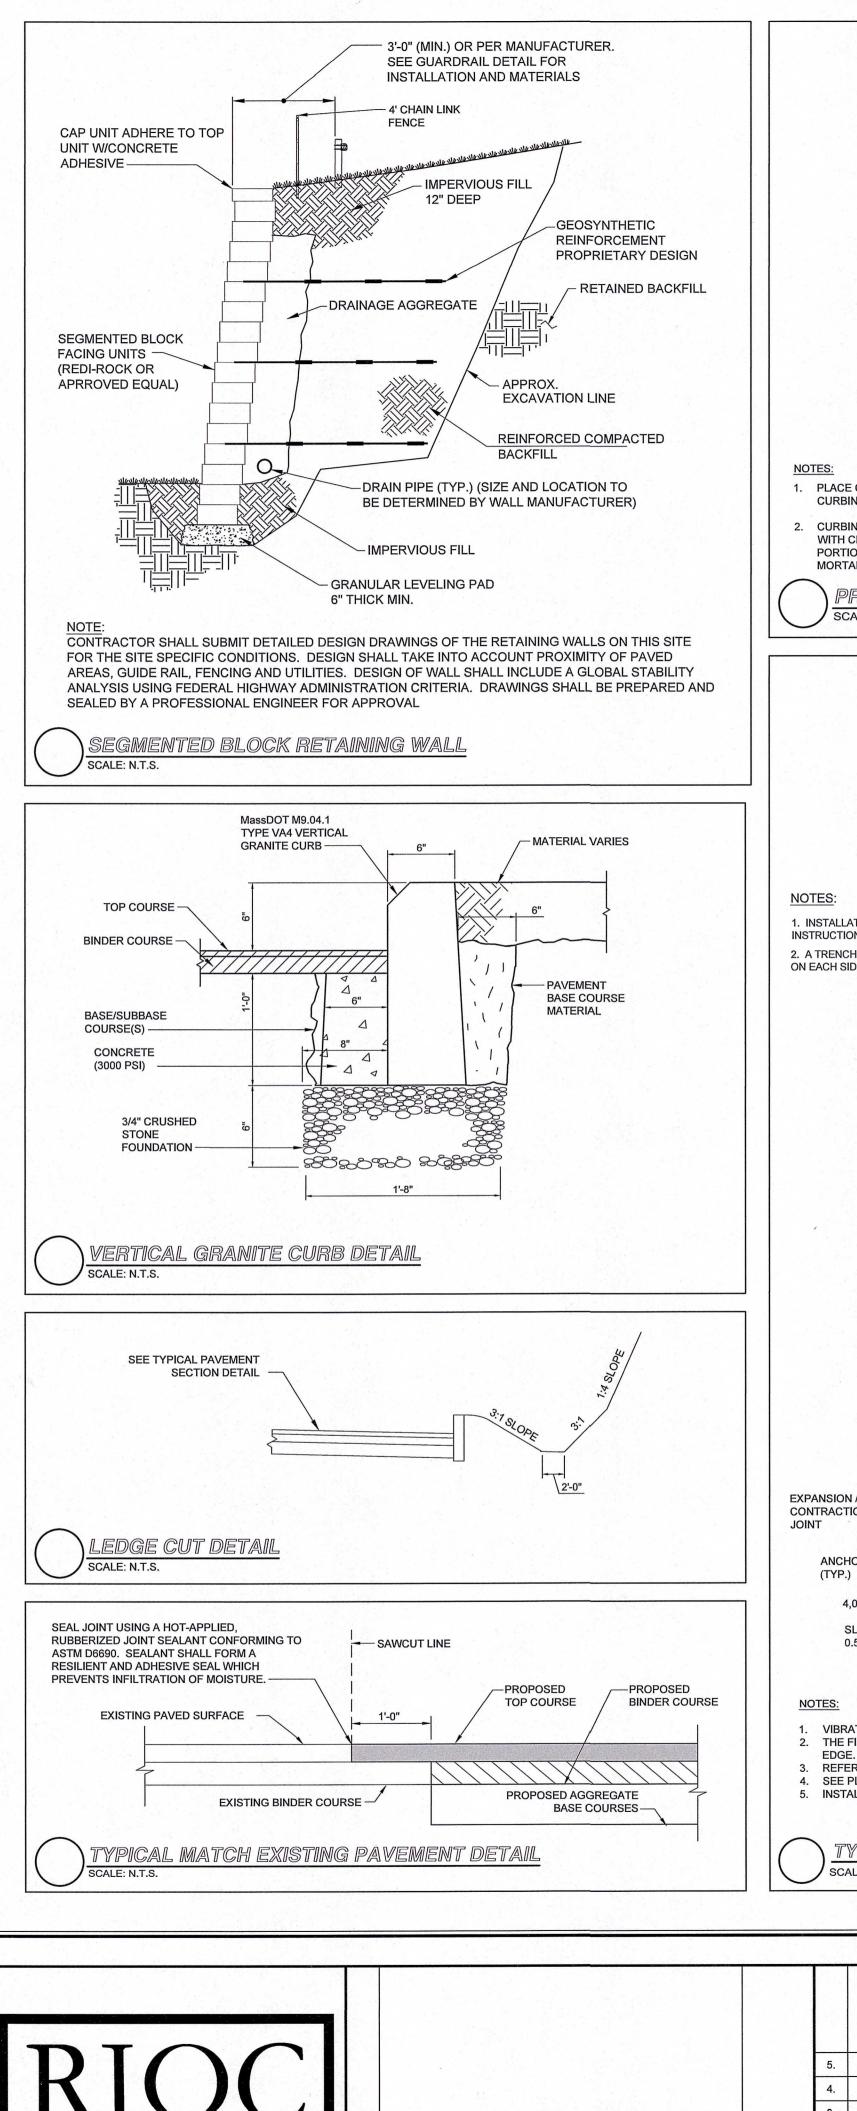

REVISION

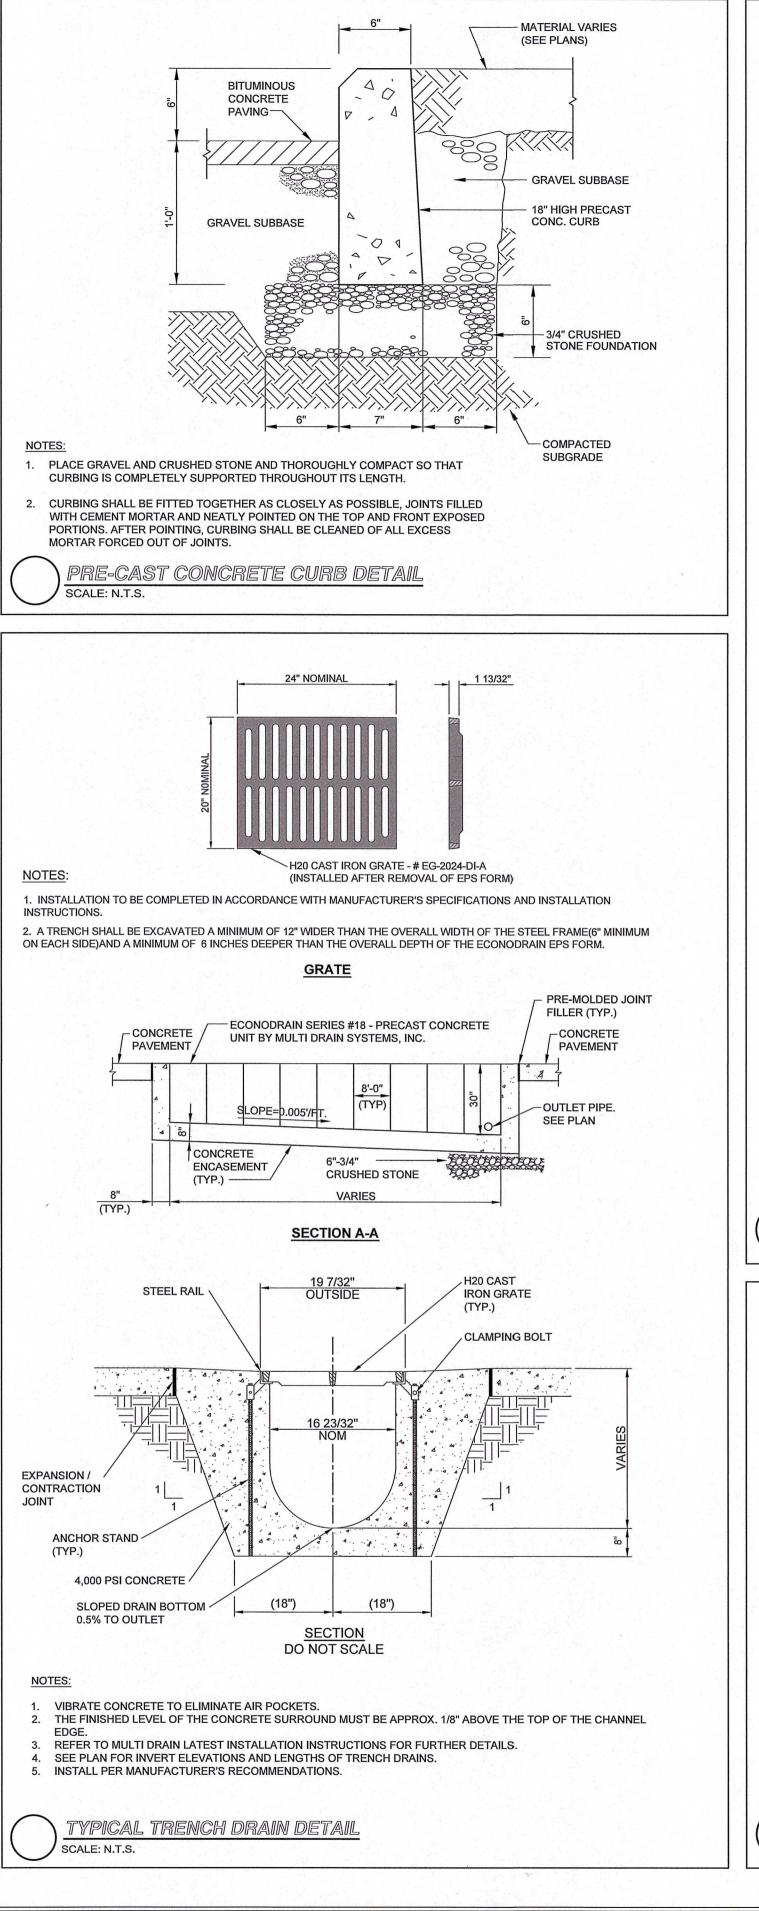

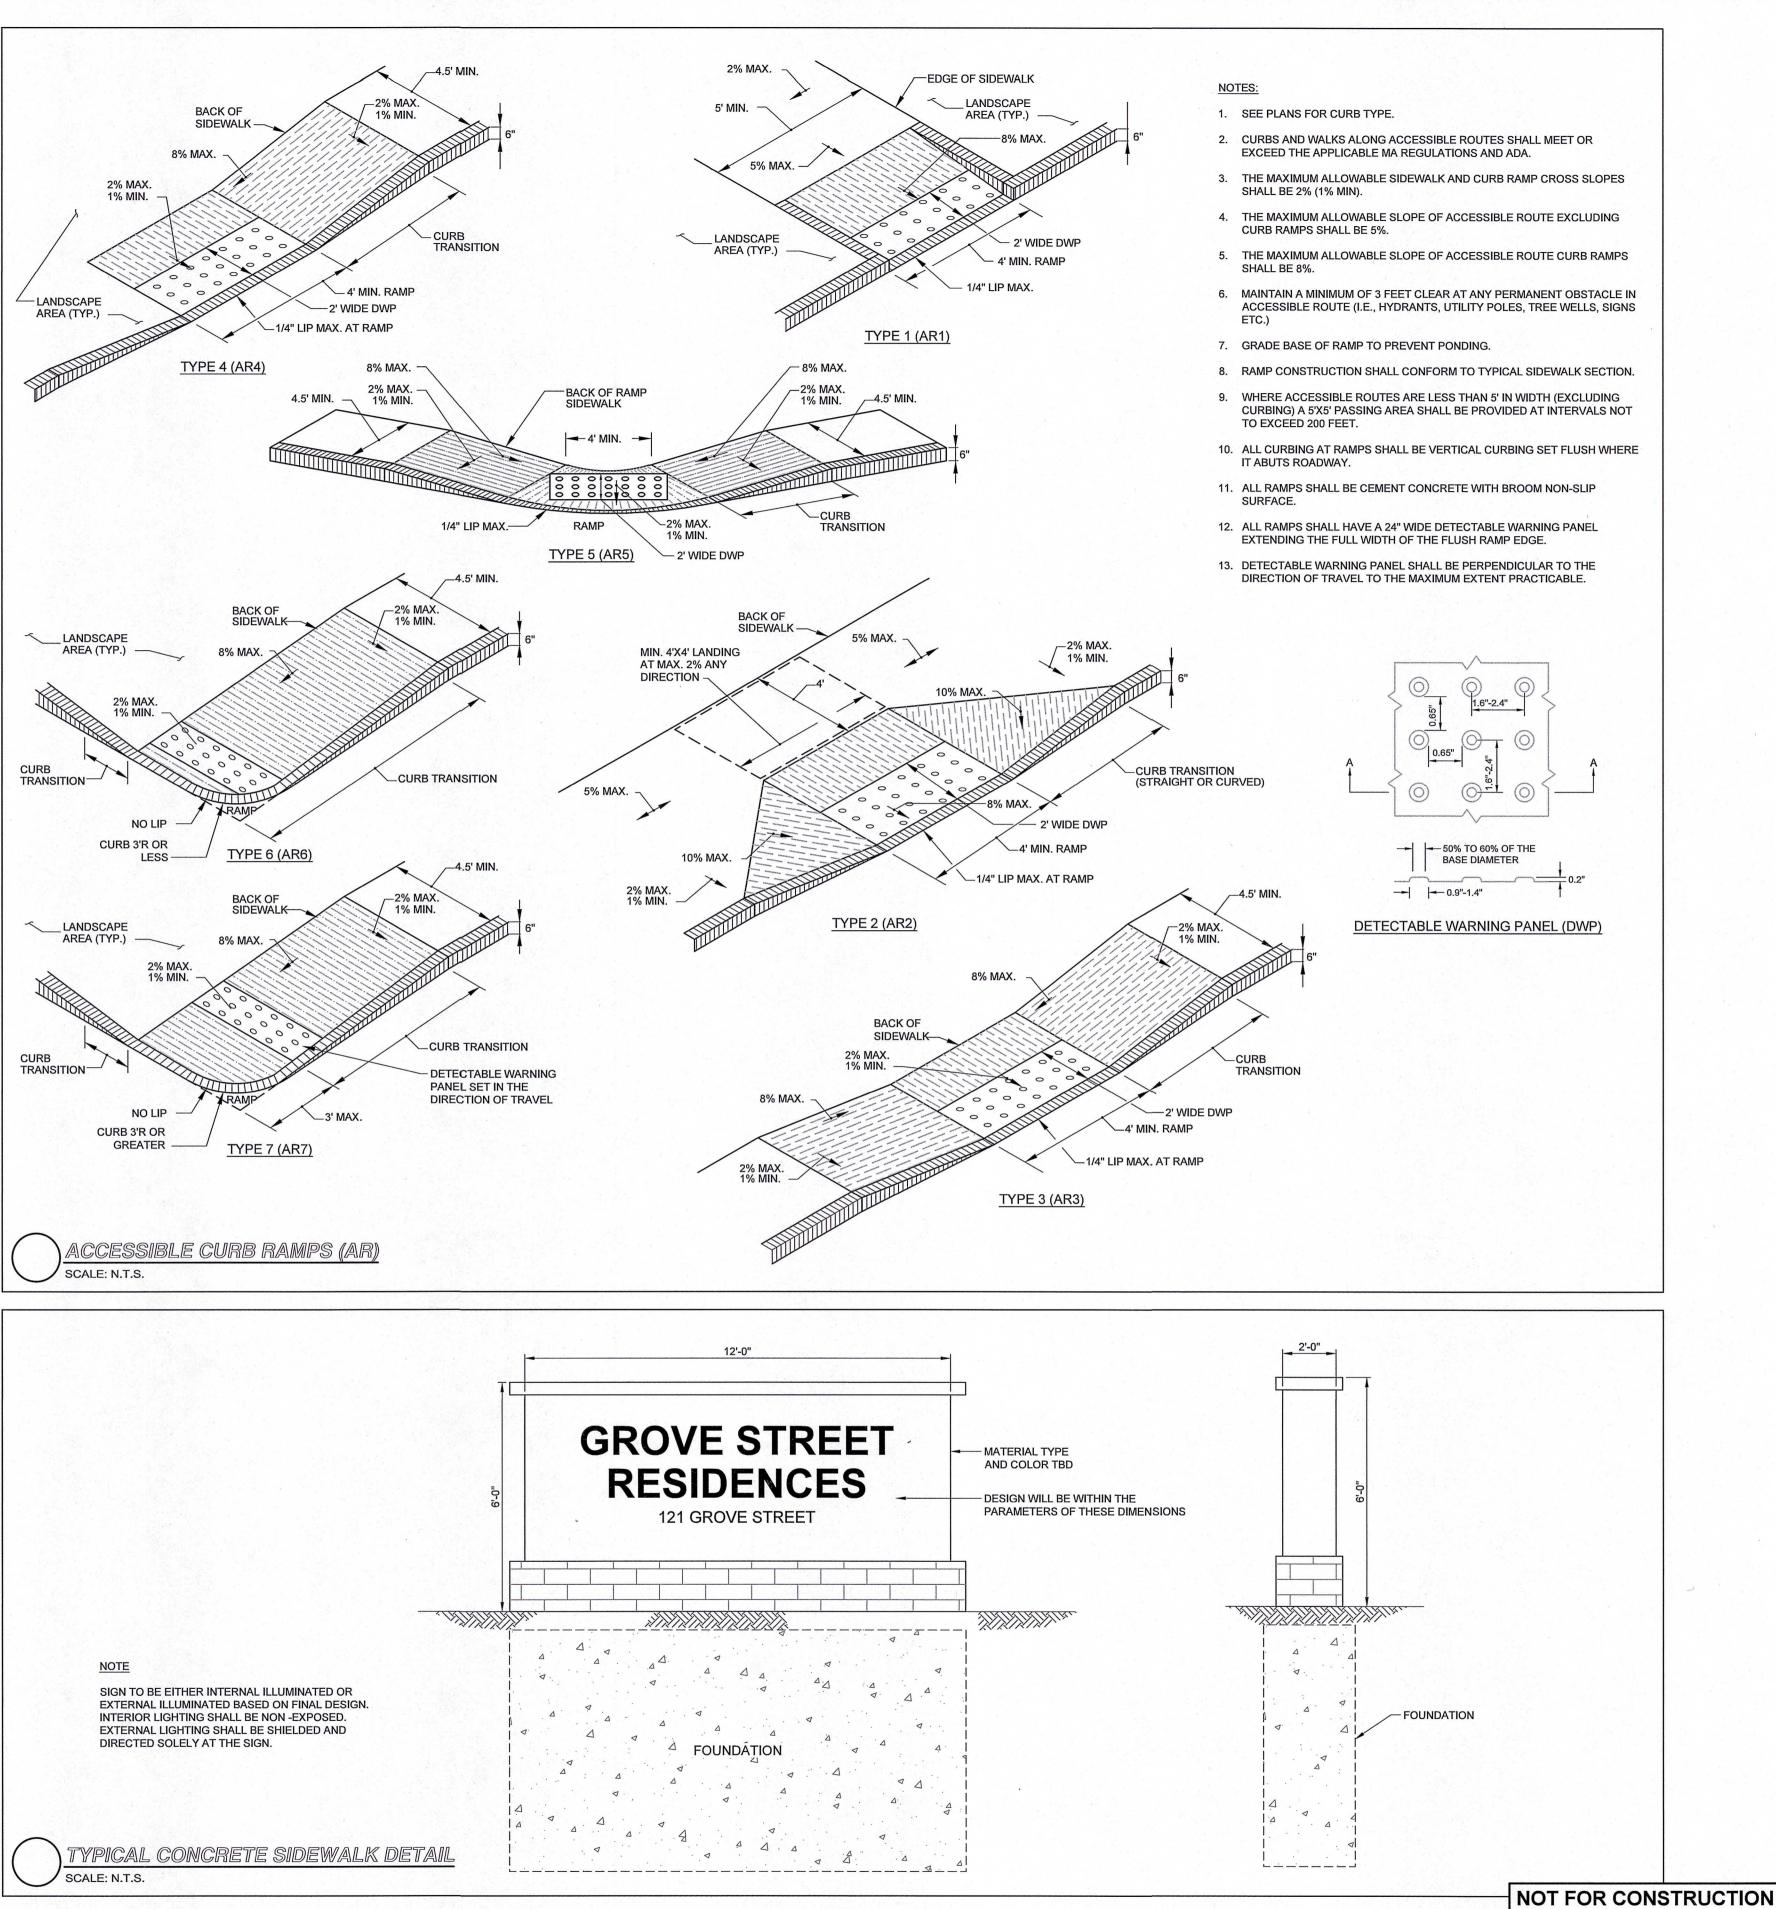




**DESIGNED BY:** MAC MCR DRAWN BY: REVISED PER CONCOM PEER REVIEW COMMENTS REVISED PER CONCOM PEER REVIEW COMMENTS **REVIEWED BY:** BJM REVISED PER ZBA PEER REVIEW COMMENTS REVISED PER ZBA PEER REVIEW COMMENTS SCALE: N.T.S. REVISED PER ONSITE SOIL TESTING RESULTS/NOI SUBMISSION 12/18/2023 REVISION DATE

FAIRFIELD GROVE STREET LLC

PREPARED FOR:

30 BRAINTREE HILL OFFICE PARK SUITE 105 BRAINTREE, MA 02184

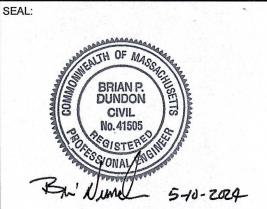

RJO'CONNELL & ASSOCIATES, INC.

**CIVIL ENGINEERS, SURVEYORS & LAND PLANNERS** 80 MONTVALE AVENUE, SUITE 201 STONEHAM, MA 02180 PHONE: 781.279.0180 RJOCONNELL.COM

SITE **DETAILS - VII** 


DRAWING NAME:

PROJECT NAME: **GROVE STREET RESIDENCES** FRANKLIN, MA

DRAWING NUMBER

10/30/2023 Copyright © 2023 by R.J. O'Connell & Associates, Inc.

PROJECT NO.: 22016

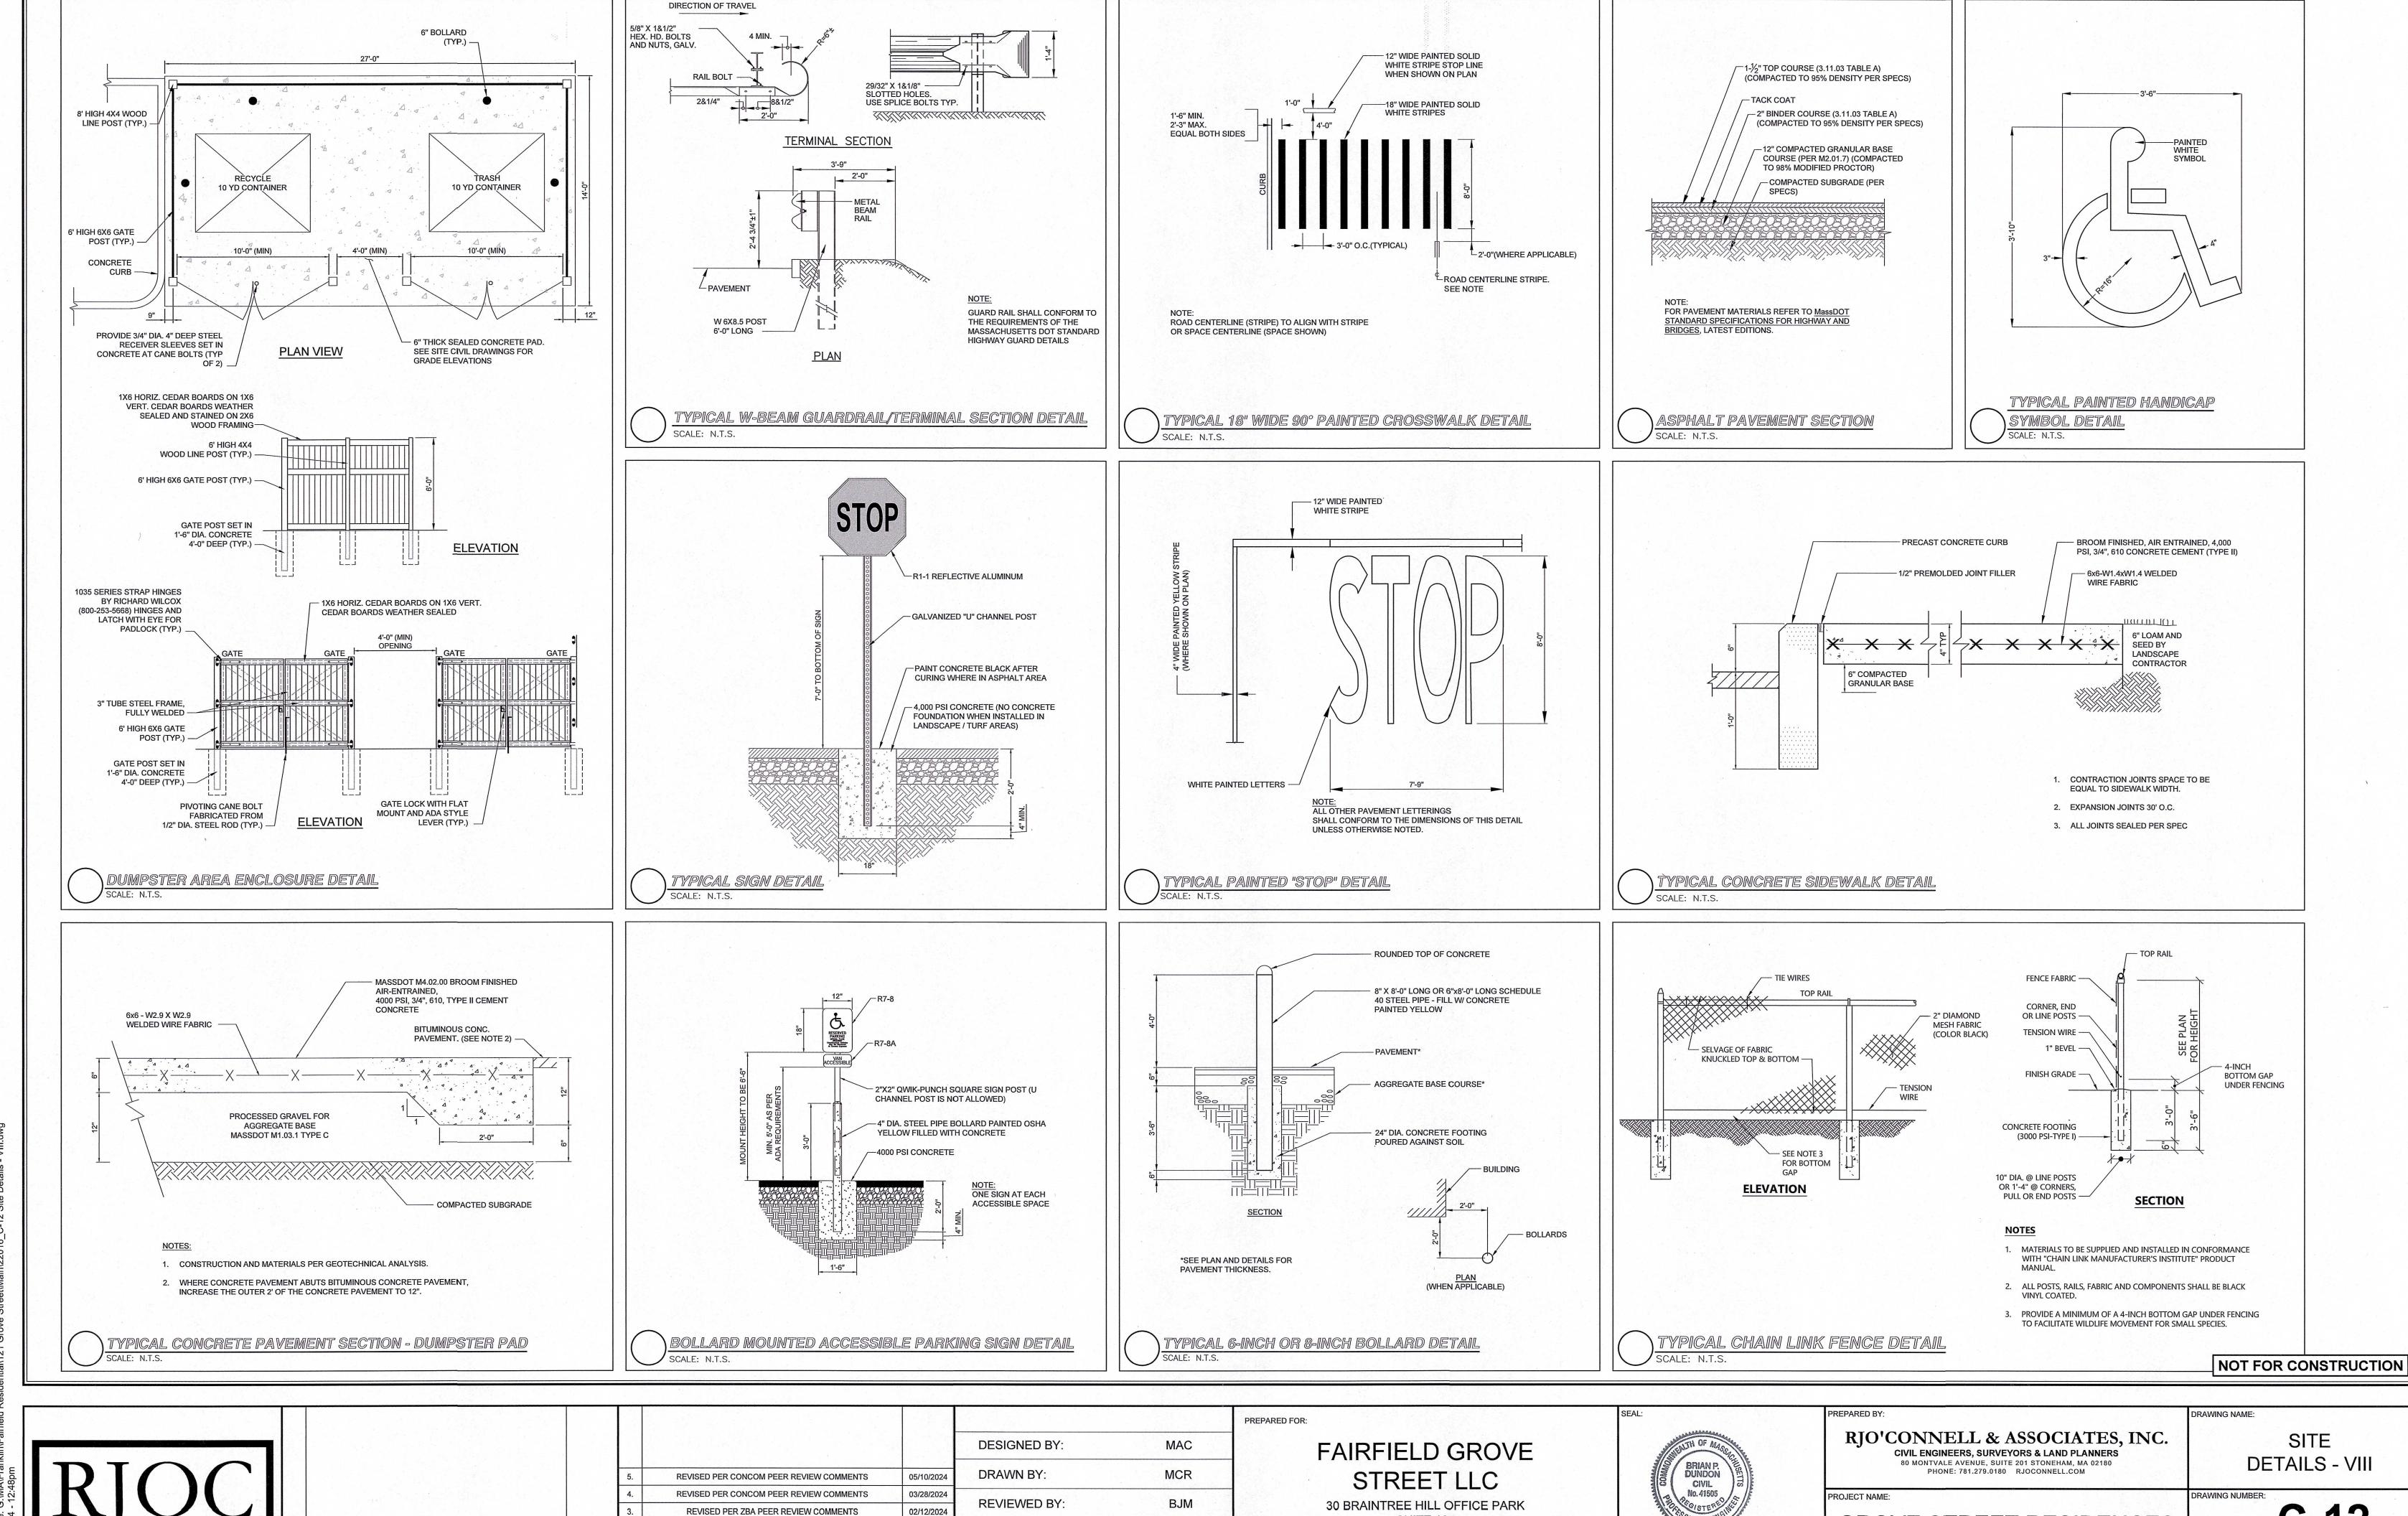

REVISED PER ZBA PEER REVIEW COMMENTS

REVISED PER ONSITE SOIL TESTING RESULTS/NOI SUBMISSION

REVISION

02/02/2024

12/18/2023

DATE

SCALE:

N.T.S.

SUITE 105

BRAINTREE, MA 02184

**GROVE STREET RESIDENCES** 

FRANKLIN, MA

PROJECT NO.: 22016

10/30/2023

Copyright © 2023 by R.J. O'Connell & Associates, Inc.


5-10-2024


Drawing name: G:\MA\Franklin\Fairfield Residentia\\121 Grove Stre

Copyright © 2021 R.J. O'Connell & Associates, Inc.

REVISION

DATE

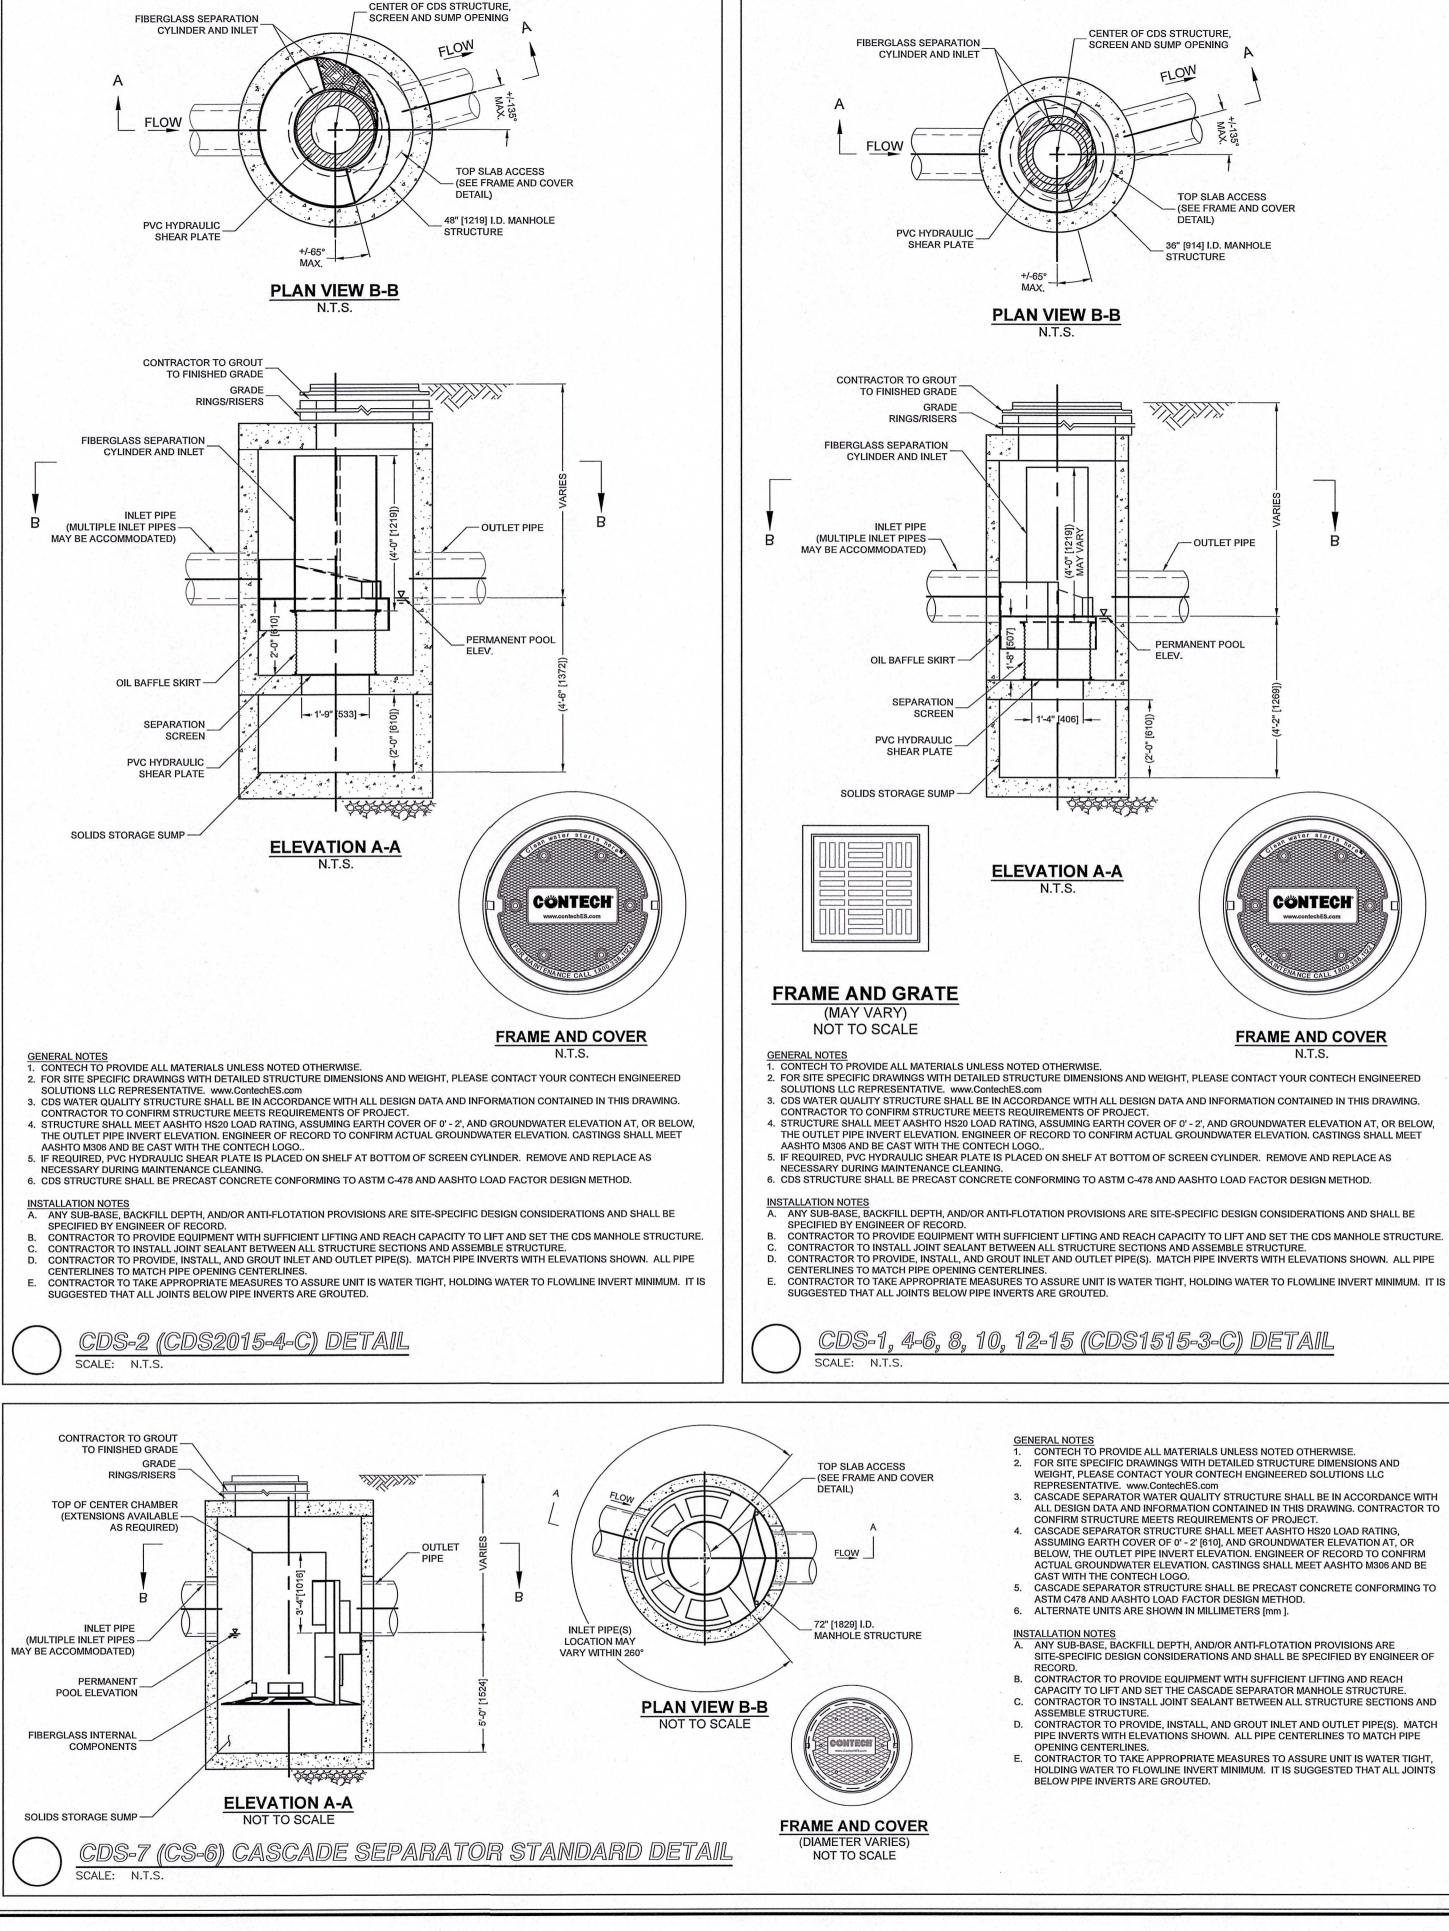


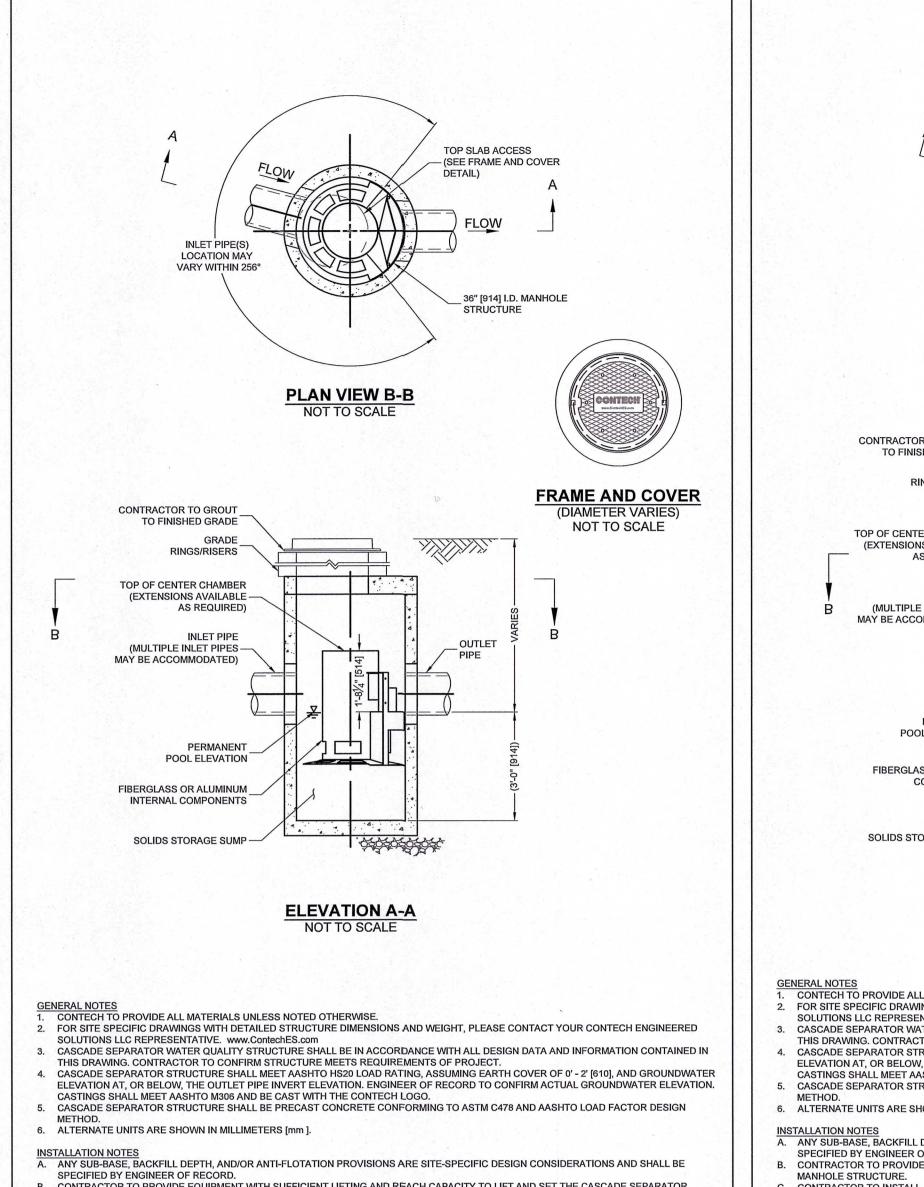

CONTRACTOR TO PROVIDE EQUIPMENT WITH SUFFICIENT LIFTING AND REACH CAPACITY TO LIFT AND SET THE CASCADE SEPARATOR

CONTRACTOR TO INSTALL JOINT SEALANT BETWEEN ALL STRUCTURE SECTIONS AND ASSEMBLE STRUCTURE. CONTRACTOR TO PROVIDE, INSTALL, AND GROUT INLET AND OUTLET PIPE(S). MATCH PIPE INVERTS WITH ELEVATIONS SHOWN. ALL PIPE CENTERLINES TO MATCH PIPE OPENING CENTERLINES. CONTRACTOR TO TAKE APPROPRIATE MEASURES TO ASSURE UNIT IS WATER TIGHT, HOLDING WATER TO FLOWLINE INVERT MINIMUM. IT IS SUGGESTED THAT ALL JOINTS BELOW PIPE INVERTS ARE GROUTED.

CDS-9 (CS-3) CASCADE SEPARATOR STANDARD DETAIL

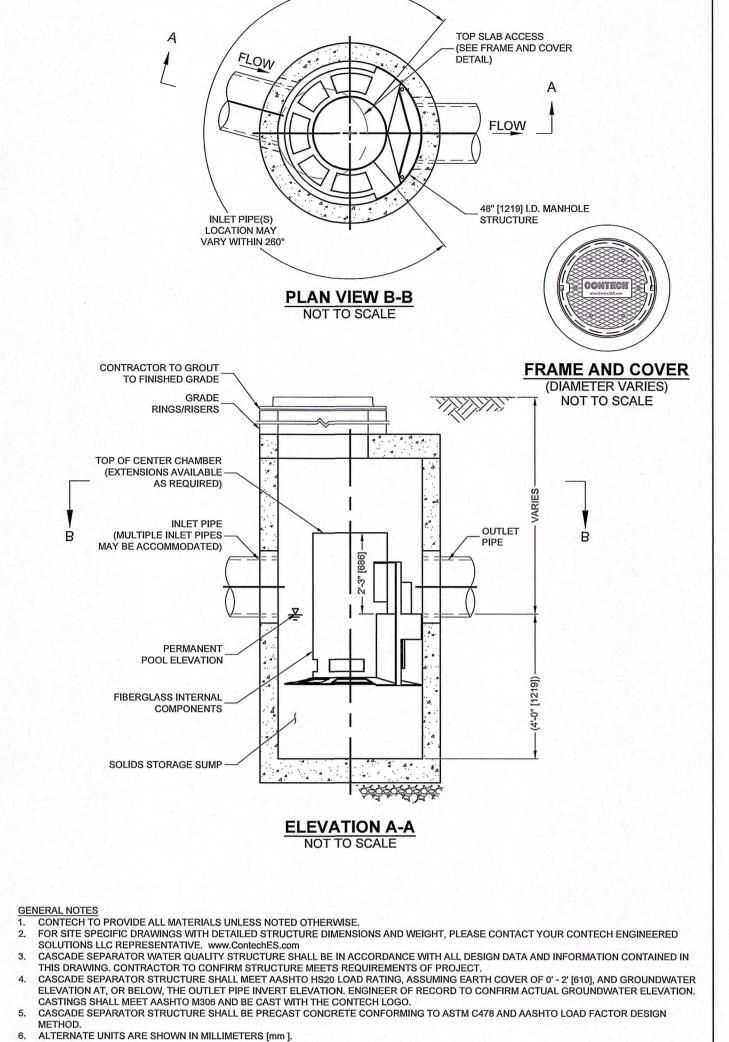


INSTALLATION NOTES

A. ANY SUB-BASE, BACKFILL DEPTH, AND/OR ANTI-FLOTATION PROVISIONS ARE SITE-SPECIFIC DESIGN CONSIDERATIONS AND SHALL BE SPECIFIED BY ENGINEER OF RECORD. B. CONTRACTOR TO PROVIDE EQUIPMENT WITH SUFFICIENT LIFTING AND REACH CAPACITY TO LIFT AND SET THE CASCADE SEPARATOR

CONTRACTOR TO INSTALL JOINT SEALANT BETWEEN ALL STRUCTURE SECTIONS AND ASSEMBLE STRUCTURE. CONTRACTOR TO PROVIDE, INSTALL, AND GROUT INLET AND OUTLET PIPE(S). MATCH PIPE INVERTS WITH ELEVATIONS SHOWN. ALL PIPE CENTERLINES TO MATCH PIPE OPENING CENTERLINES. CONTRACTOR TO TAKE APPROPRIATE MEASURES TO ASSURE UNIT IS WATER TIGHT, HOLDING WATER TO FLOWLINE INVERT MINIMUM. IT IS SUGGESTED THAT ALL JOINTS BELOW PIPE INVERTS ARE GROUTED

CDS-11 (CS-4) CASCADE SEPARATOR

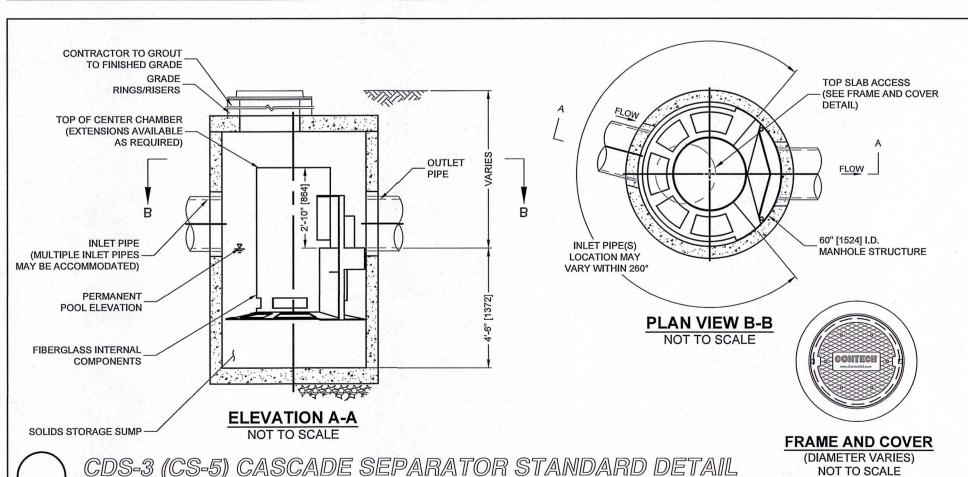

GENERAL NOTES

1. CONTECH TO PROVIDE ALL MATERIALS UNLESS NOTED OTHERWISE. 2. FOR SITE SPECIFIC DRAWINGS WITH DETAILED STRUCTURE DIMENSIONS AND WEIGHT PLEASE CONTACT YOUR CONTECH ENGINEERED SOLUTIONS LLC REPRESENTATIVE. www.ContechES.com

3. CASCADE SEPARATOR WATER QUALITY STRUCTURE SHALL BE IN ACCORDANCE WITH ALL DESIGN DATA AND INFORMATION CONTAINED IN THIS DRAWING. CONTRACTOR TO CONFIRM STRUCTURE MEETS REQUIREMENTS OF PROJECT. 4. CASCADE SEPARATOR STRUCTURE SHALL MEET AASHTO HS20 LOAD RATING, ASSUMING EARTH COVER OF 0' - 2' [610]. AND GROUNDWATER ELEVATION AT, OR BELOW, THE OUTLET PIPE INVERT ELEVATION. ENGINEER OF RECORD TO CONFIRM ACTUAL GROUNDWATER

ELEVATION. CASTINGS SHALL MEET AASHTO M306 AND BE CAST WITH THE CONTECH 5. CASCADE SEPARATOR STRUCTURE SHALL BE PRECAST CONCRETE CONFORMING TO ASTM C478 AND AASHTO LOAD FACTOR DESIGN METHOD.

6. ALTERNATE UNITS ARE SHOWN IN MILLIMETERS [mm].

A. ANY SUB-BASE, BACKFILL DEPTH, AND/OR ANTI-FLOTATION PROVISIONS ARE SITE-SPECIFIC DESIGN CONSIDERATIONS AND SHALL BE SPECIFIED BY ENGINEER OF


B. CONTRACTOR TO PROVIDE EQUIPMENT WITH SUFFICIENT LIFTING AND REACH CAPACITY TO LIFT AND SET THE CASCADE SEPARATOR MANHOLE STRUCTURE.

C. CONTRACTOR TO INSTALL JOINT SEALANT BETWEEN ALL STRUCTURE SECTIONS AND ASSEMBLE STRUCTURE. D. CONTRACTOR TO PROVIDE, INSTALL, AND GROUT INLET AND OUTLET PIPE(S). MATCH PIPE INVERTS WITH ELEVATIONS SHOWN. ALL PIPE CENTERLINES TO MATCH PIPE OPENING

CENTERLINES. E. CONTRACTOR TO TAKE APPROPRIATE MEASURES TO ASSURE UNIT IS WATER TIGHT.

HOLDING WATER TO FLOWLINE INVERT MINIMUM. IT IS SUGGESTED THAT ALL JOINTS BELOW PIPE INVERTS ARE GROUTED.

> **NOT FOR** CONSTRUCTION

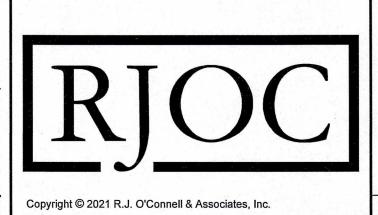

REVISION

**DESIGNED BY:** MAC DRAWN BY: MCR REVISED PER CONCOM PEER REVIEW COMMENTS 05/10/2024 **REVIEWED BY:** BJM REVISED PER CONCOM PEER REVIEW COMMENTS 03/28/2024 REVISED PER ZBA PEER REVIEW COMMENTS 02/12/2024 SCALE: N.T.S. REVISED PER ZBA PEER REVIEW COMMENTS 02/02/2024 DATE REVISION DATE

FAIRFIELD GROVE STREET LLC

PREPARED FOR:

30 BRAINTREE HILL OFFICE PARK SUITE 105 BRAINTREE, MA 02184

BRIAN P. DUNDON CIVIL No. 41505 5-10-2024

RJO'CONNELL & ASSOCIATES, INC. CIVIL ENGINEERS, SURVEYORS & LAND PLANNERS

DRAWING NAME:


DETAILS - IX

PROJECT NAME: **GROVE STREET RESIDENCES** 

80 MONTVALE AVENUE, SUITE 201 STONEHAM, MA 02180 PHONE: 781.279.0180 RJOCONNELL.COM

FRANKLIN, MA

02/02/2024 PROJECT NO.: 22016 Copyright © 2023 by R.J. O'Connell & Associates, Inc.

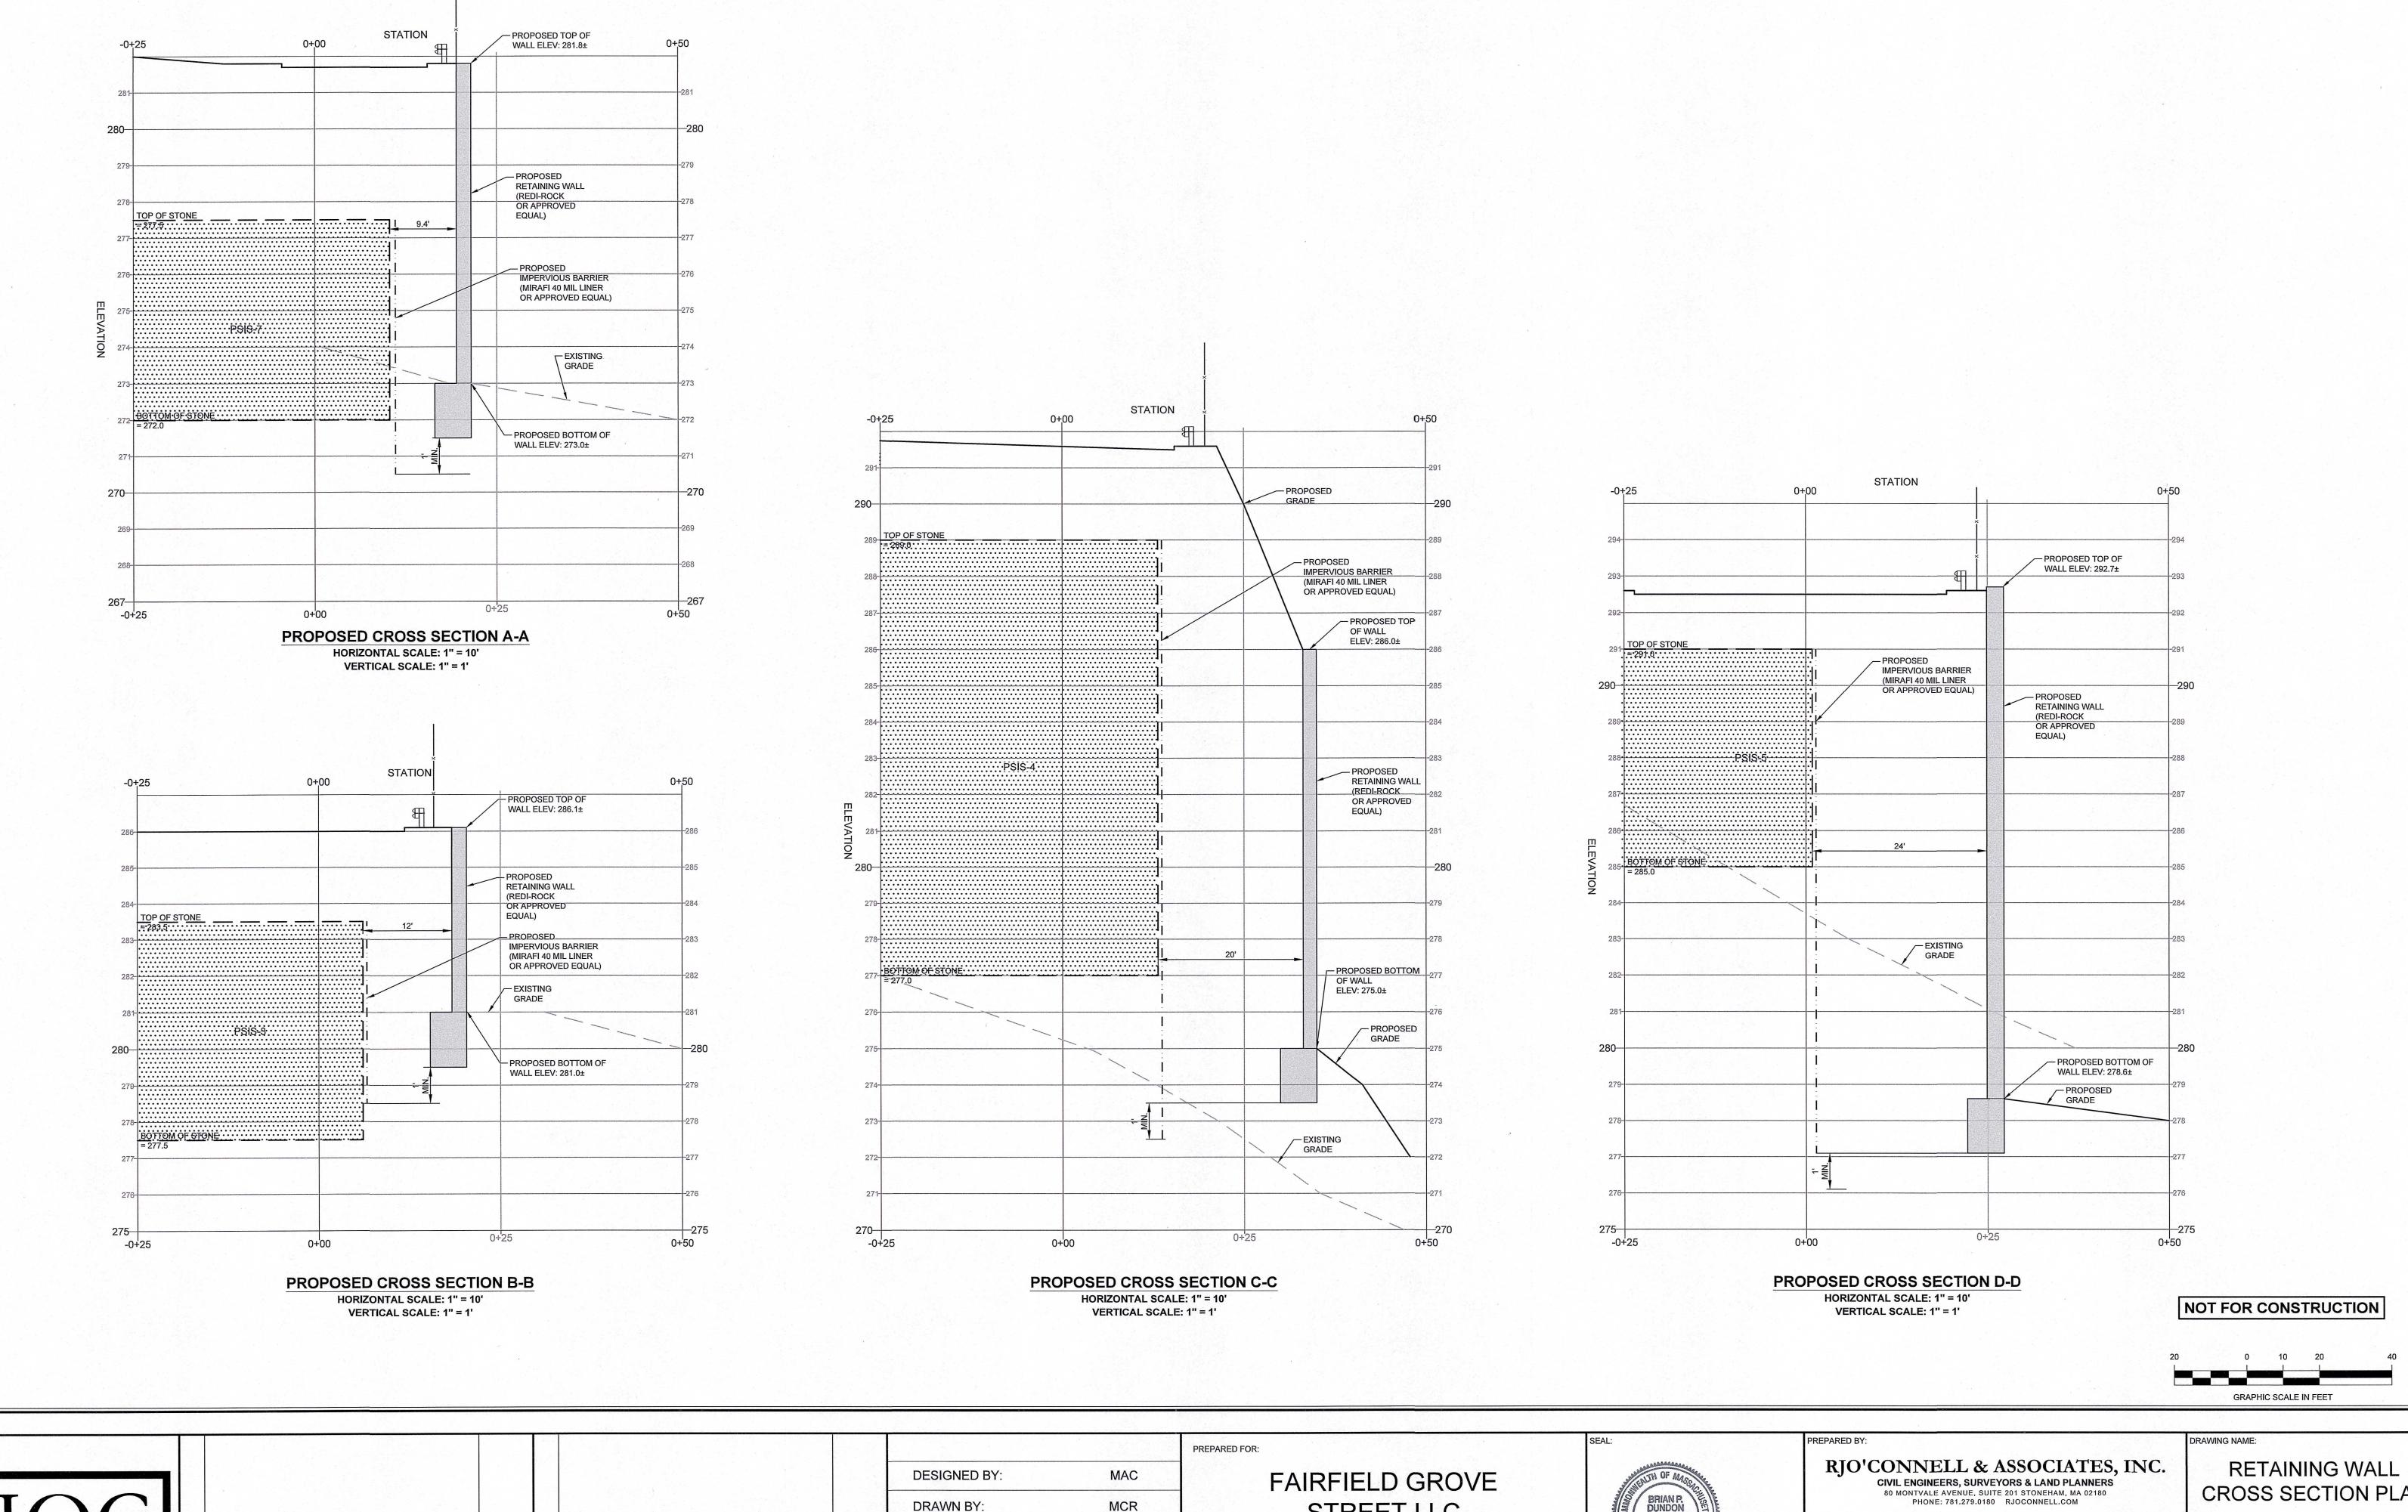

MCR DRAWN BY: REVISED PER CONCOM PEER REVIEW COMMENTS 05/10/2024 REVIEWED BY: BJM REVISED PER CONCOM PEER REVIEW COMMENTS 03/28/2024 REVISED PER ZBA PEER REVIEW COMMENTS 02/12/2024 SCALE: AS NOTED REVISED PER ZBA PEER REVIEW COMMENTS 02/02/2024 REVISION DATE REVISION

STREET LLC 30 BRAINTREE HILL OFFICE PARK SUITE 105 BRAINTREE, MA 02184

BRIAN P. DUNDON CIVIL No. 41505 5-10-2024 **CROSS SECTION PLAN** 

PROJECT NAME: **GROVE STREET RESIDENCES** 

FRANKLIN, MA

PROJECT NO.: 22016