
LIBERTY PARKING EXPANSION


OLIVER STREET CAPITAL

15 LIBERTY WAY

FRANKLIN, MASSACHUSETTS

DATE: JANUARY 13, 2023 REVISED: MARCH 19, 2024

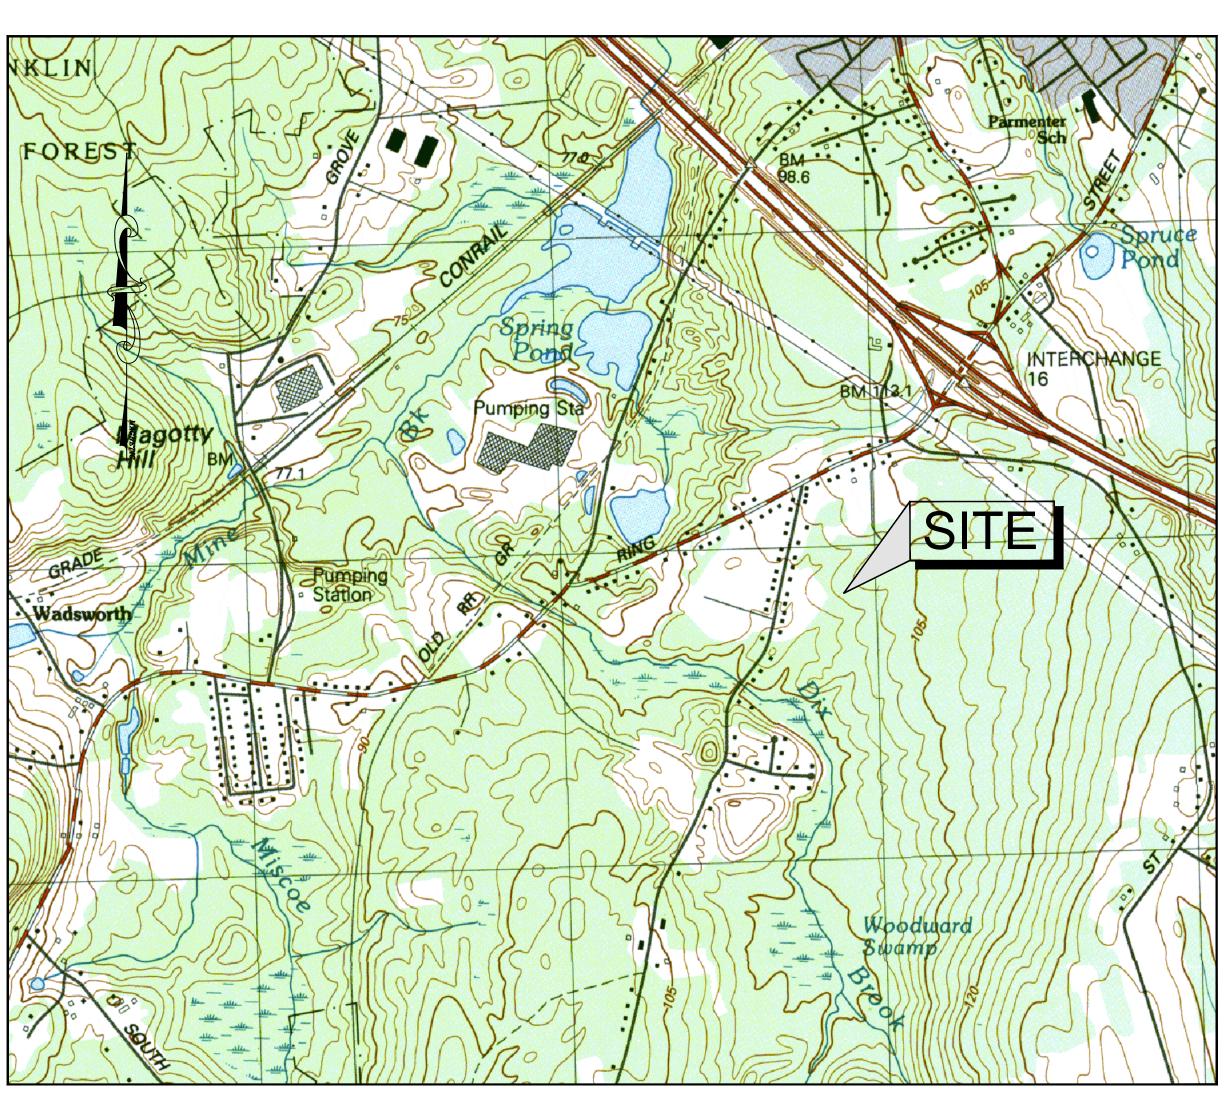

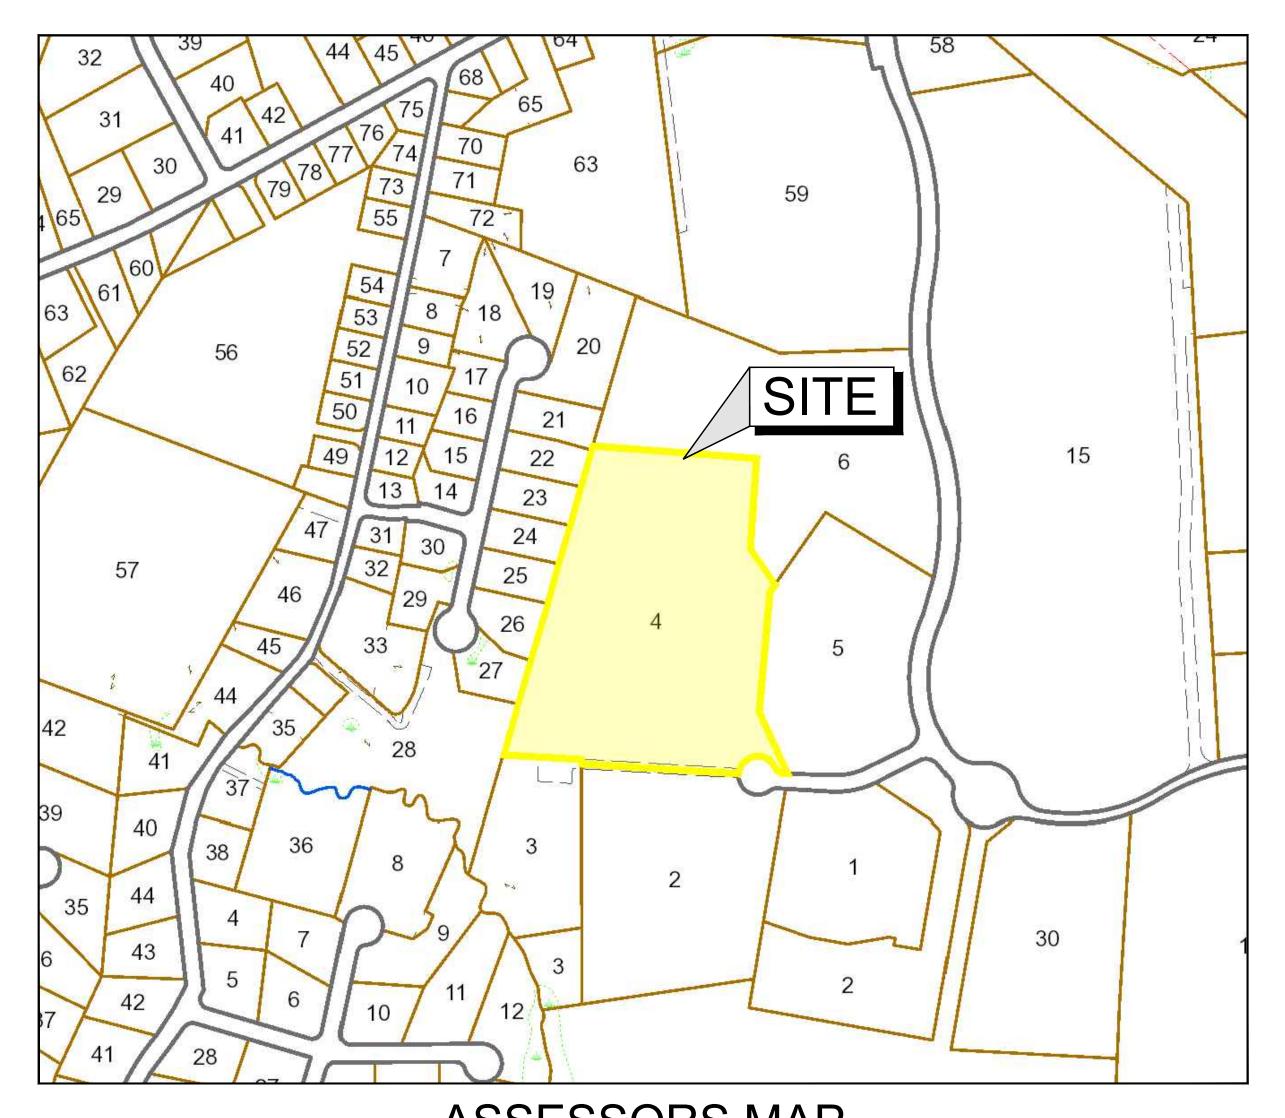

USGS MAP

SCALE: 1"= 1,000'±

ASSESSORS MAP

SCALE: 1"= 300'±

1 10/17/2023 RESOURCE AREA FLAGS 2 11/22/2023 REVIEW COMMENTS 3 02/01/2024 REVISE LAYOUT

APPLICANT:

OLIVER STREET CAPITAL 125 HIGH STREET, SUITE 220 BOSTON, MA 02110

CIVIL ENGINEER:



PROPERTY ADDRESS:
15 LIBERTY WAY
FRANKLIN, MASSACHUSETTS

ASSESSORS MAP/PARCEL:

MAP 320, PARCEL 004


ZONING DISTRICT: INDUSTRIAL

DRAWING LIST:

C-0.0	COVER
C-1.0	EXISTING CONDITIONS
C-2.0	OVERALL SITE PLAN
C-3.0	LAYOUT & MATERIALS
C-4.0	GRADING & DRAINAGE
C-5.0	EROSION CONROL PLAN
C-6.0	TYPICAL DETAILS
C-6.1	TYPICAL DETAILS
C-6.2	TYPICAL DETAILS

SK-1.0 EMERGENCY VEHICLE ACCESS
PH-1.1 PHOTOMETRIC SITE LIGHTING
PH-2.1 PHOTOMETRY LIGHTING SPECS

L-1.0 LANDSCAPE PLAN

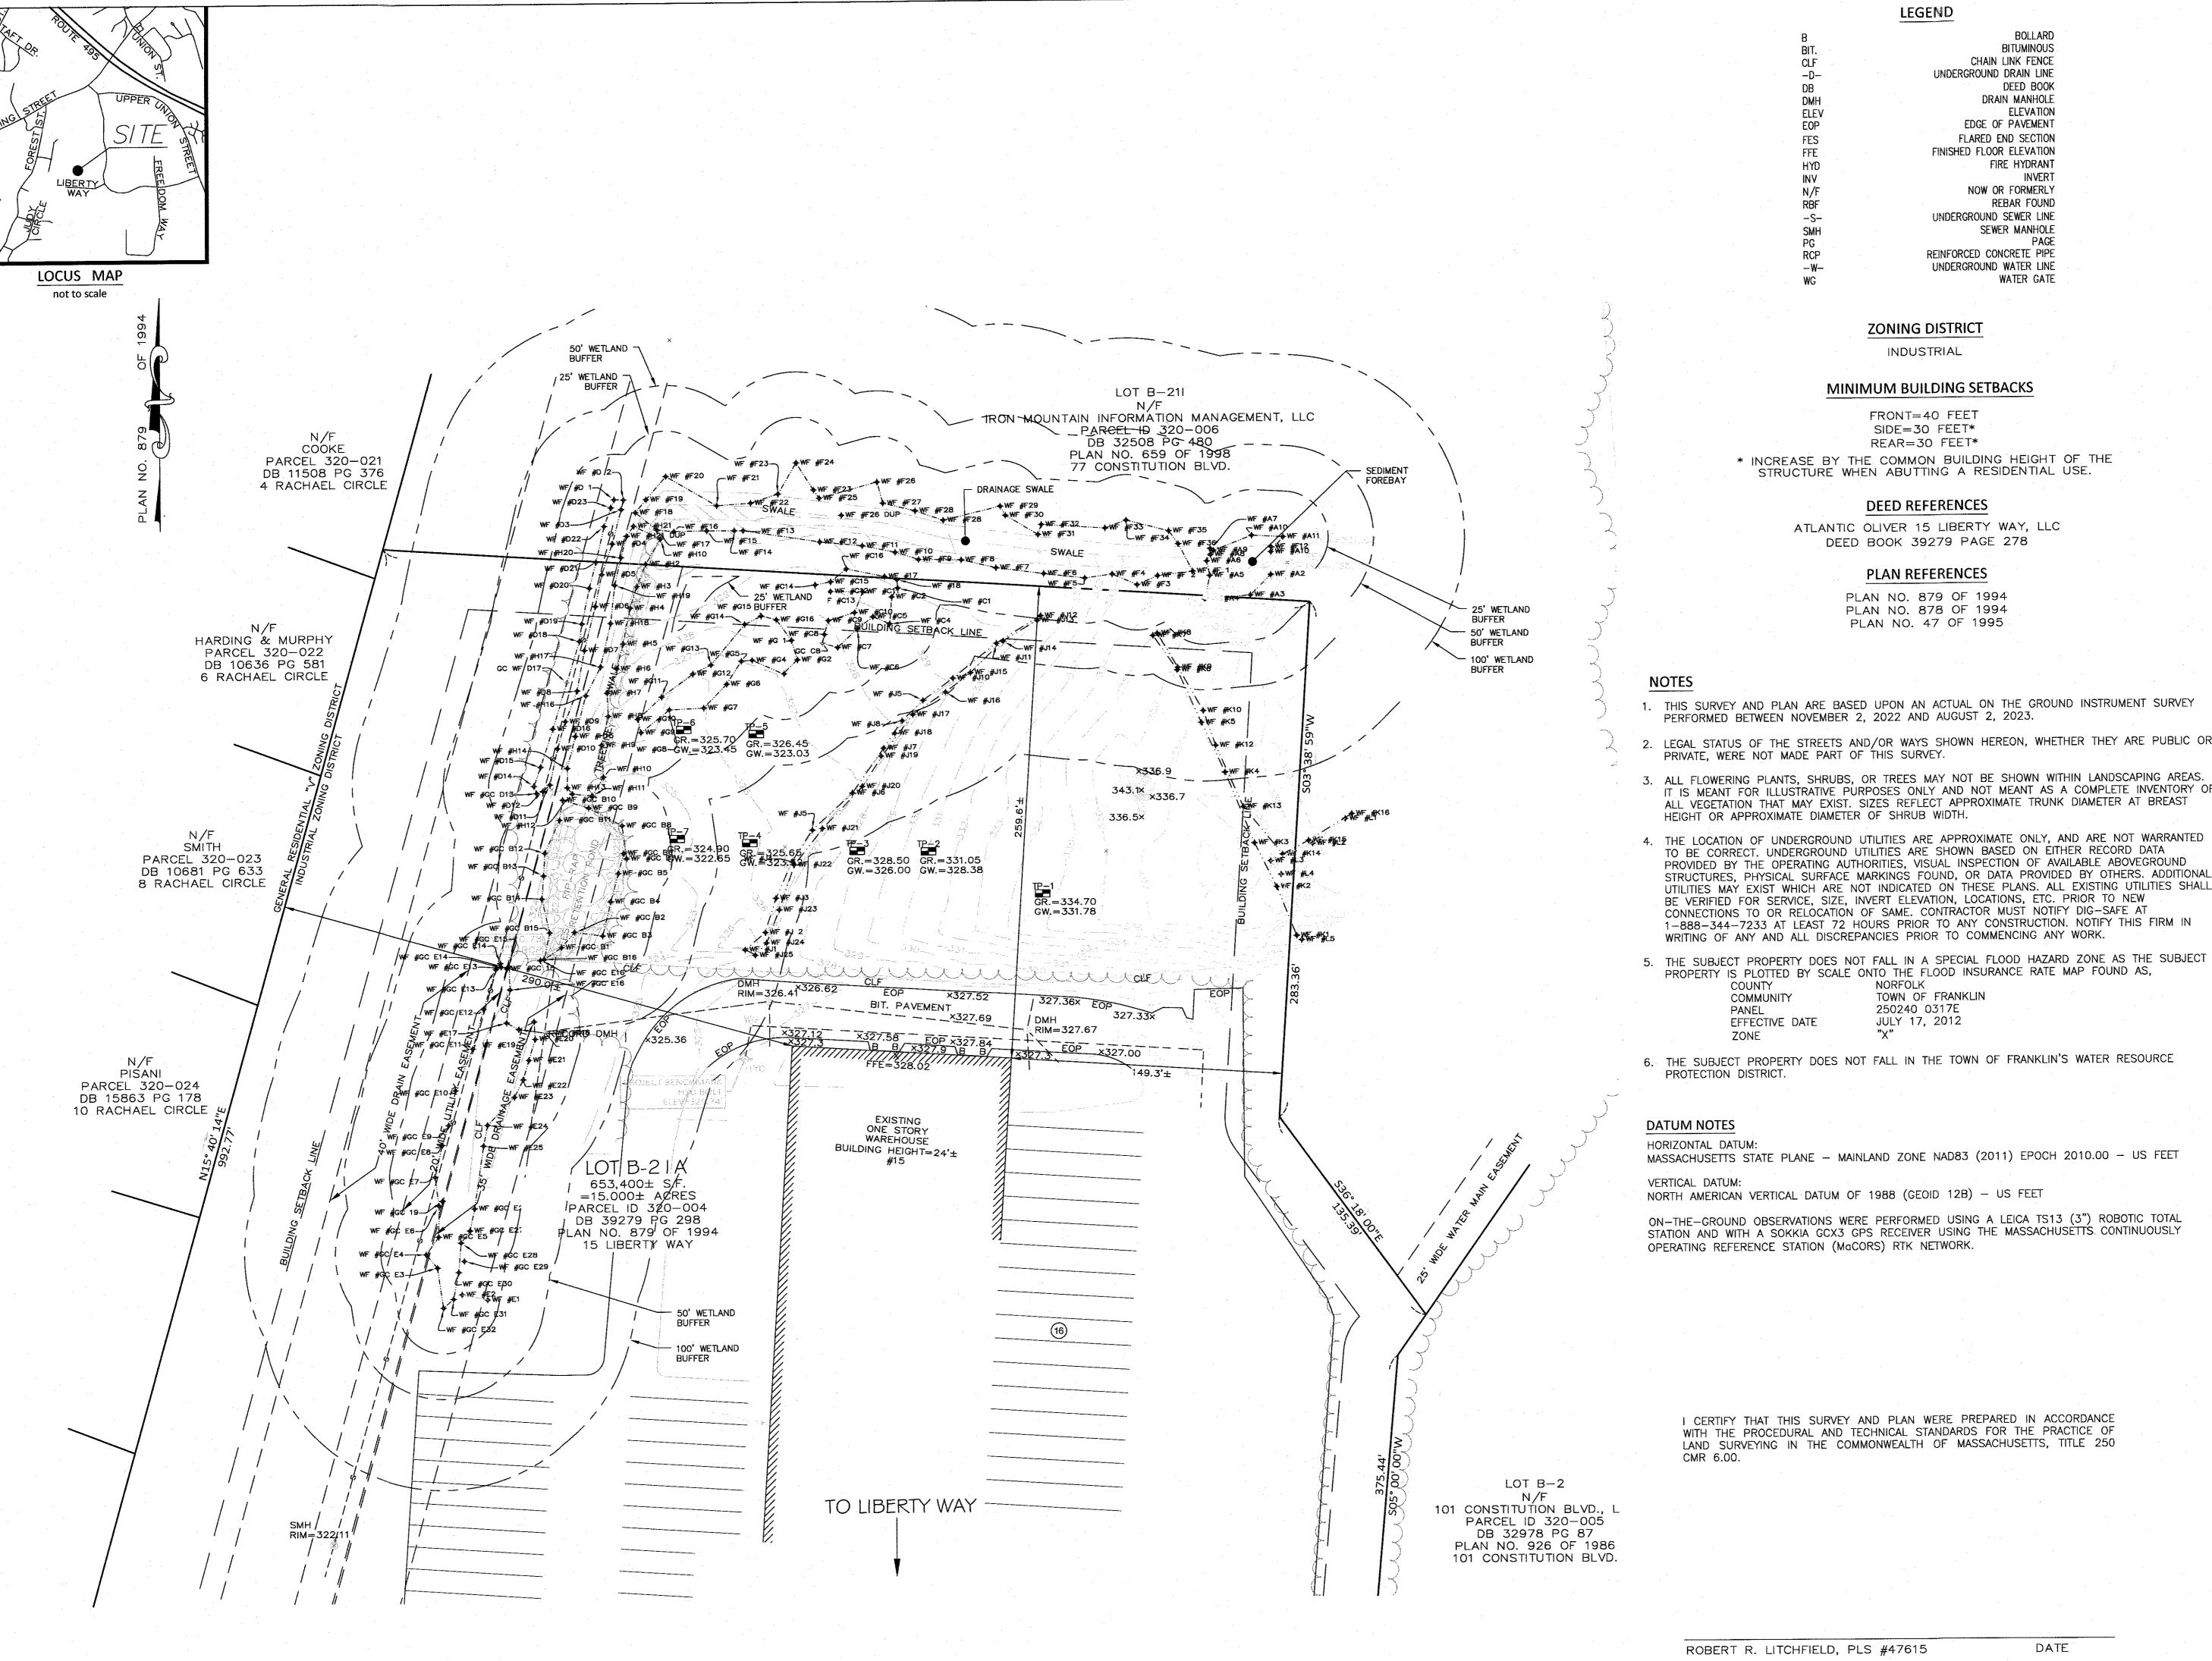

- 2. LEGAL STATUS OF THE STREETS AND/OR WAYS SHOWN HEREON, WHETHER THEY ARE PUBLIC OR
- 3. ALL FLOWERING PLANTS, SHRUBS, OR TREES MAY NOT BE SHOWN WITHIN LANDSCAPING AREAS. IT IS MEANT FOR ILLUSTRATIVE PURPOSES ONLY AND NOT MEANT AS A COMPLETE INVENTORY OF ALL VEGETATION THAT MAY EXIST. SIZES REFLECT APPROXIMATE TRUNK DIAMETER AT BREAST
- 4. THE LOCATION OF UNDERGROUND UTILITIES ARE APPROXIMATE ONLY, AND ARE NOT WARRANTED TO BE CORRECT. UNDERGROUND UTILITIES ARE SHOWN BASED ON EITHER RECORD DATA PROVIDED BY THE OPERATING AUTHORITIES, VISUAL INSPECTION OF AVAILABLE ABOVEGROUND STRUCTURES, PHYSICAL SURFACE MARKINGS FOUND, OR DATA PROVIDED BY OTHERS. ADDITIONAL UTILITIES MAY EXIST WHICH ARE NOT INDICATED ON THESE PLANS. ALL EXISTING UTILITIES SHALL 1-888-344-7233 AT LEAST 72 HOURS PRIOR TO ANY CONSTRUCTION. NOTIFY THIS FIRM IN

MASSACHUSETTS STATE PLANE - MAINLAND ZONE NAD83 (2011) EPOCH 2010.00 - US FEET

1 10/17/2023 RESOURCE AREA FLAGS 2 11/22/2023 REVIEW COMMENTS 3 02/01/2024 REVIEW COMMENTS 4 03/19/2024 REVISE LAYOUT

REVISIONS

NO DATE

JANUARY 13, 2023 DATE: DRAWN: AH/DRC SCALE: 1" = 40'

NP SHEET LIBERTY ANKLIN, I

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20,

ACHUSETT

DESIGN GROUP Civil Engineers & Land Surveyors

249 SOUTH STREET, UNIT 1 PLAINVILLE, MA 02762 TEL. (508) 695-2221 FAX. (508) 695-2219

EXISTING CONDITIONS

20' 40'

ZONING DISTRICT

ZONED: INDUSTRIAL

USE: 3.10 WAREHOUSE, DISTRIBUTION FACILITY (EXISTING)

MINIMUM BUILDING SETBACKS


FRONT=40 FEET SIDE=30 FEET REAR=30 FEET

DEED REFERENCES

ATLANTIC OLIVER 15 LIBERTY WAY, LLC DEED BOOK 39279 PAGE 278

PLAN REFERENCES

PLAN NO. 879 OF 1994 PLAN NO. 878 OF 1994 PLAN NO. 47 OF 1995

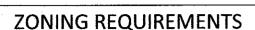

ZONING DISTRICT	ZONING DISTRICT: INDUSTRIAL				
		REQUIRED	EXISTING	PROPOSED	
MIN. LOT AREA		40,000 S.F.	653,400± S.F.	653,400± S.F	
FRONTAGE		175'	946.73'	946.73'	
FRONT YARD SETBACK		40'	95.9'***	95.9'***	
SIDE YARD SETBACK		30'	149.3'	149.3	

70% MAX.

80% MAX.

14.6%**

46.7%***

3 STORIES* 1 STORY/24' 1 STORY/24'

259.6'

14.6%**

56.9%***

MAX. BUILDING HEIGHT	3 STORIES*	1 STORY/24'	1 STORY/24'
PARKING REQUIREMENTS			
USE: EXISTING WAREHOUSE: ONE SPACE PER 1,000 SF OF GROSS FLOOR AREA.	95,475 SF /1,000 SF =96 SPACES	98	(98) EXISTING

^{*} BUILDINGS UP TO 60' IN HEIGHT MAY BE PERMITTED BY A SPECIAL PERMIT FROM THE PLANNING BOARD.

** BUILDING AREA IS BASED ON FRANKLIN ASSESSORS RECORDS *** TAKEN FROM THE RECORD SURVEY IN ADDITION TO AERIAL IMAGERY.

PLAN NOTES:

REAR YARD SETBACK

BUILDING COVERAGE

IMPERVIOUS COVERAGE

- 1. EXISTING CONDITIONS WERE OBTAINED FROM FIELD SURVEY PREPARED BY LEVEL DESIGN GROUP, LLC BETWEEN NOVEMBER 2, 2022 AND AUGUST 2, 2023. SOIL TESTING COMPLETED BY ADAM P. HUNT ON NOVEMBER 16, 2022 AND OCTOBER 4, 2023.
- 2. THE LOCATION OF EXISTING UTILITIES IS APPROXIMATE, THE CONTRACTOR SHALL VERIFY THE LOCATION OF ALL UTILITIES IN THE FIELD PRIOR TO THE START OF CONSTRUCTION. NOTIFY "DIG-SAFE" AT 1-888-344-7233 AT LEAST 72 HOURS PRIOR TO ANY SITE DEMOLITION OR EXCAVATION.
- 3. CONTRACTOR SHALL NOTIFY ENGINEER OF ANY DISCREPANCIES IN THE DESIGN PLANS PRIOR TO THE START OF CONSTRUCTION.
- 4. ALL DISTURBED AREAS NOT RECEIVING IMPROVEMENTS SHALL BE LOAMED AND SEEDED.
- 5. THE SITE IS NOT LOCATED WITHIN A ZONE II WATER RESOURCE DISTRICT.
- 6. THE SITE IS NOT LOCATED WITHIN A FLOOD PLAIN DISTRICT.


CONSTRUCTION NOTES:


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- 2. CONTRACTOR SHALL NOTIFY ENGINEER OF ANY DISCREPANCIES IN THE DESIGN PLANS PRIOR TO THE START OF CONSTRUCTION.
- 3. ALL EXISTING PAVEMENT SHALL BE SAWCUT PRIOR TO REMOVAL.
- 4. ALL EXISTING PAVEMENT, CURB, WALKS, UTILITIES, LIGHT POLES, TREES, SHRUBS, ETC., SHALL BE REMOVED FROM THE AREAS TO BE DEVELOPED. ALL SUCH ITEMS NOT WITHIN THE WORK AREA SHALL BE PROTECTED AND UNDISTURBED.
- 5. ALL DISTURBED AREAS NOT RECEIVING IMPROVEMENTS SHALL BE LOAMED AND SEEDED.
- 6. ALL CONSTRUCTION AND CONSTRUCTION ACTIVITIES SHALL CONFORM TO STATE AND LOCAL REQUIREMENTS. INCLUDING BUT NOT LIMITED TO THE TOWN OF FRANKLIN, THE COMMONWEALTH OF MASSACHUSETTS AND ANY OTHER AGENCIES HAVING JURISDICTION.
- 7. MATERIAL TO BE EXPORTED FROM THE SITE WILL BE LIMITED TO TOPSOIL IN AREAS TO BE PAVED AND ANY DELETERIOUS MATERIAL ENCOUNTERED DURING EXCAVATION. MATERIAL TO BE EXPORTED WILL BE LIMITED TO GRAVEL BASE AND SEPTIC AGGREGATE.

SITE PLAN NOTES:

THIS PLAN SET HAS BEEN ISSUED FOR PERMITTING ONLY. A FULL CONSTRUCTION PLAN SET SHALL BE ISSUED ONCE ALL LOCAL, STATE, AND FEDERAL PERMIT APPROVALS HAVE BEEN GRANTED.



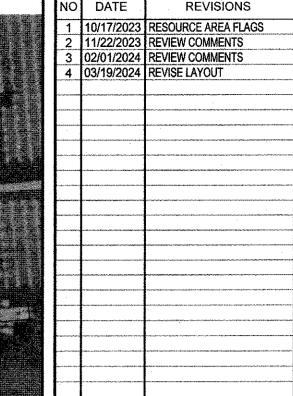


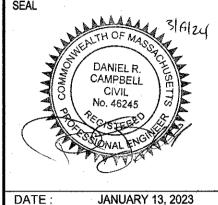

DRAWN: AH/DRC SCALE: 1" = 50'

249 SOUTH STREET, UNIT 1 PLAINVILLE, MA 02762 TEL. (508) 695-2221 FAX. (508) 695-2219

OVERALL SITE PLAN

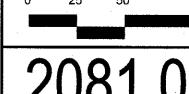

ZONING DISTRICT

ZONED: INDUSTRIAL

USE: 3.10 WAREHOUSE, DISTRIBUTION FACILITY (EXISTING)

MINIMUM BUILDING SETBACKS

FRONT=40
FEET SIDE=30 FEET
REAR=30 FEET

DEED REFERENCES

ATLANTIC OLIVER 15 LIBERTY WAY, LLC DEED BOOK 39279 PAGE 278

PLAN REFERENCES

PLAN NO. 879 OF 1994 PLAN NO. 878 OF 1994 PLAN NO. 47 OF 1995

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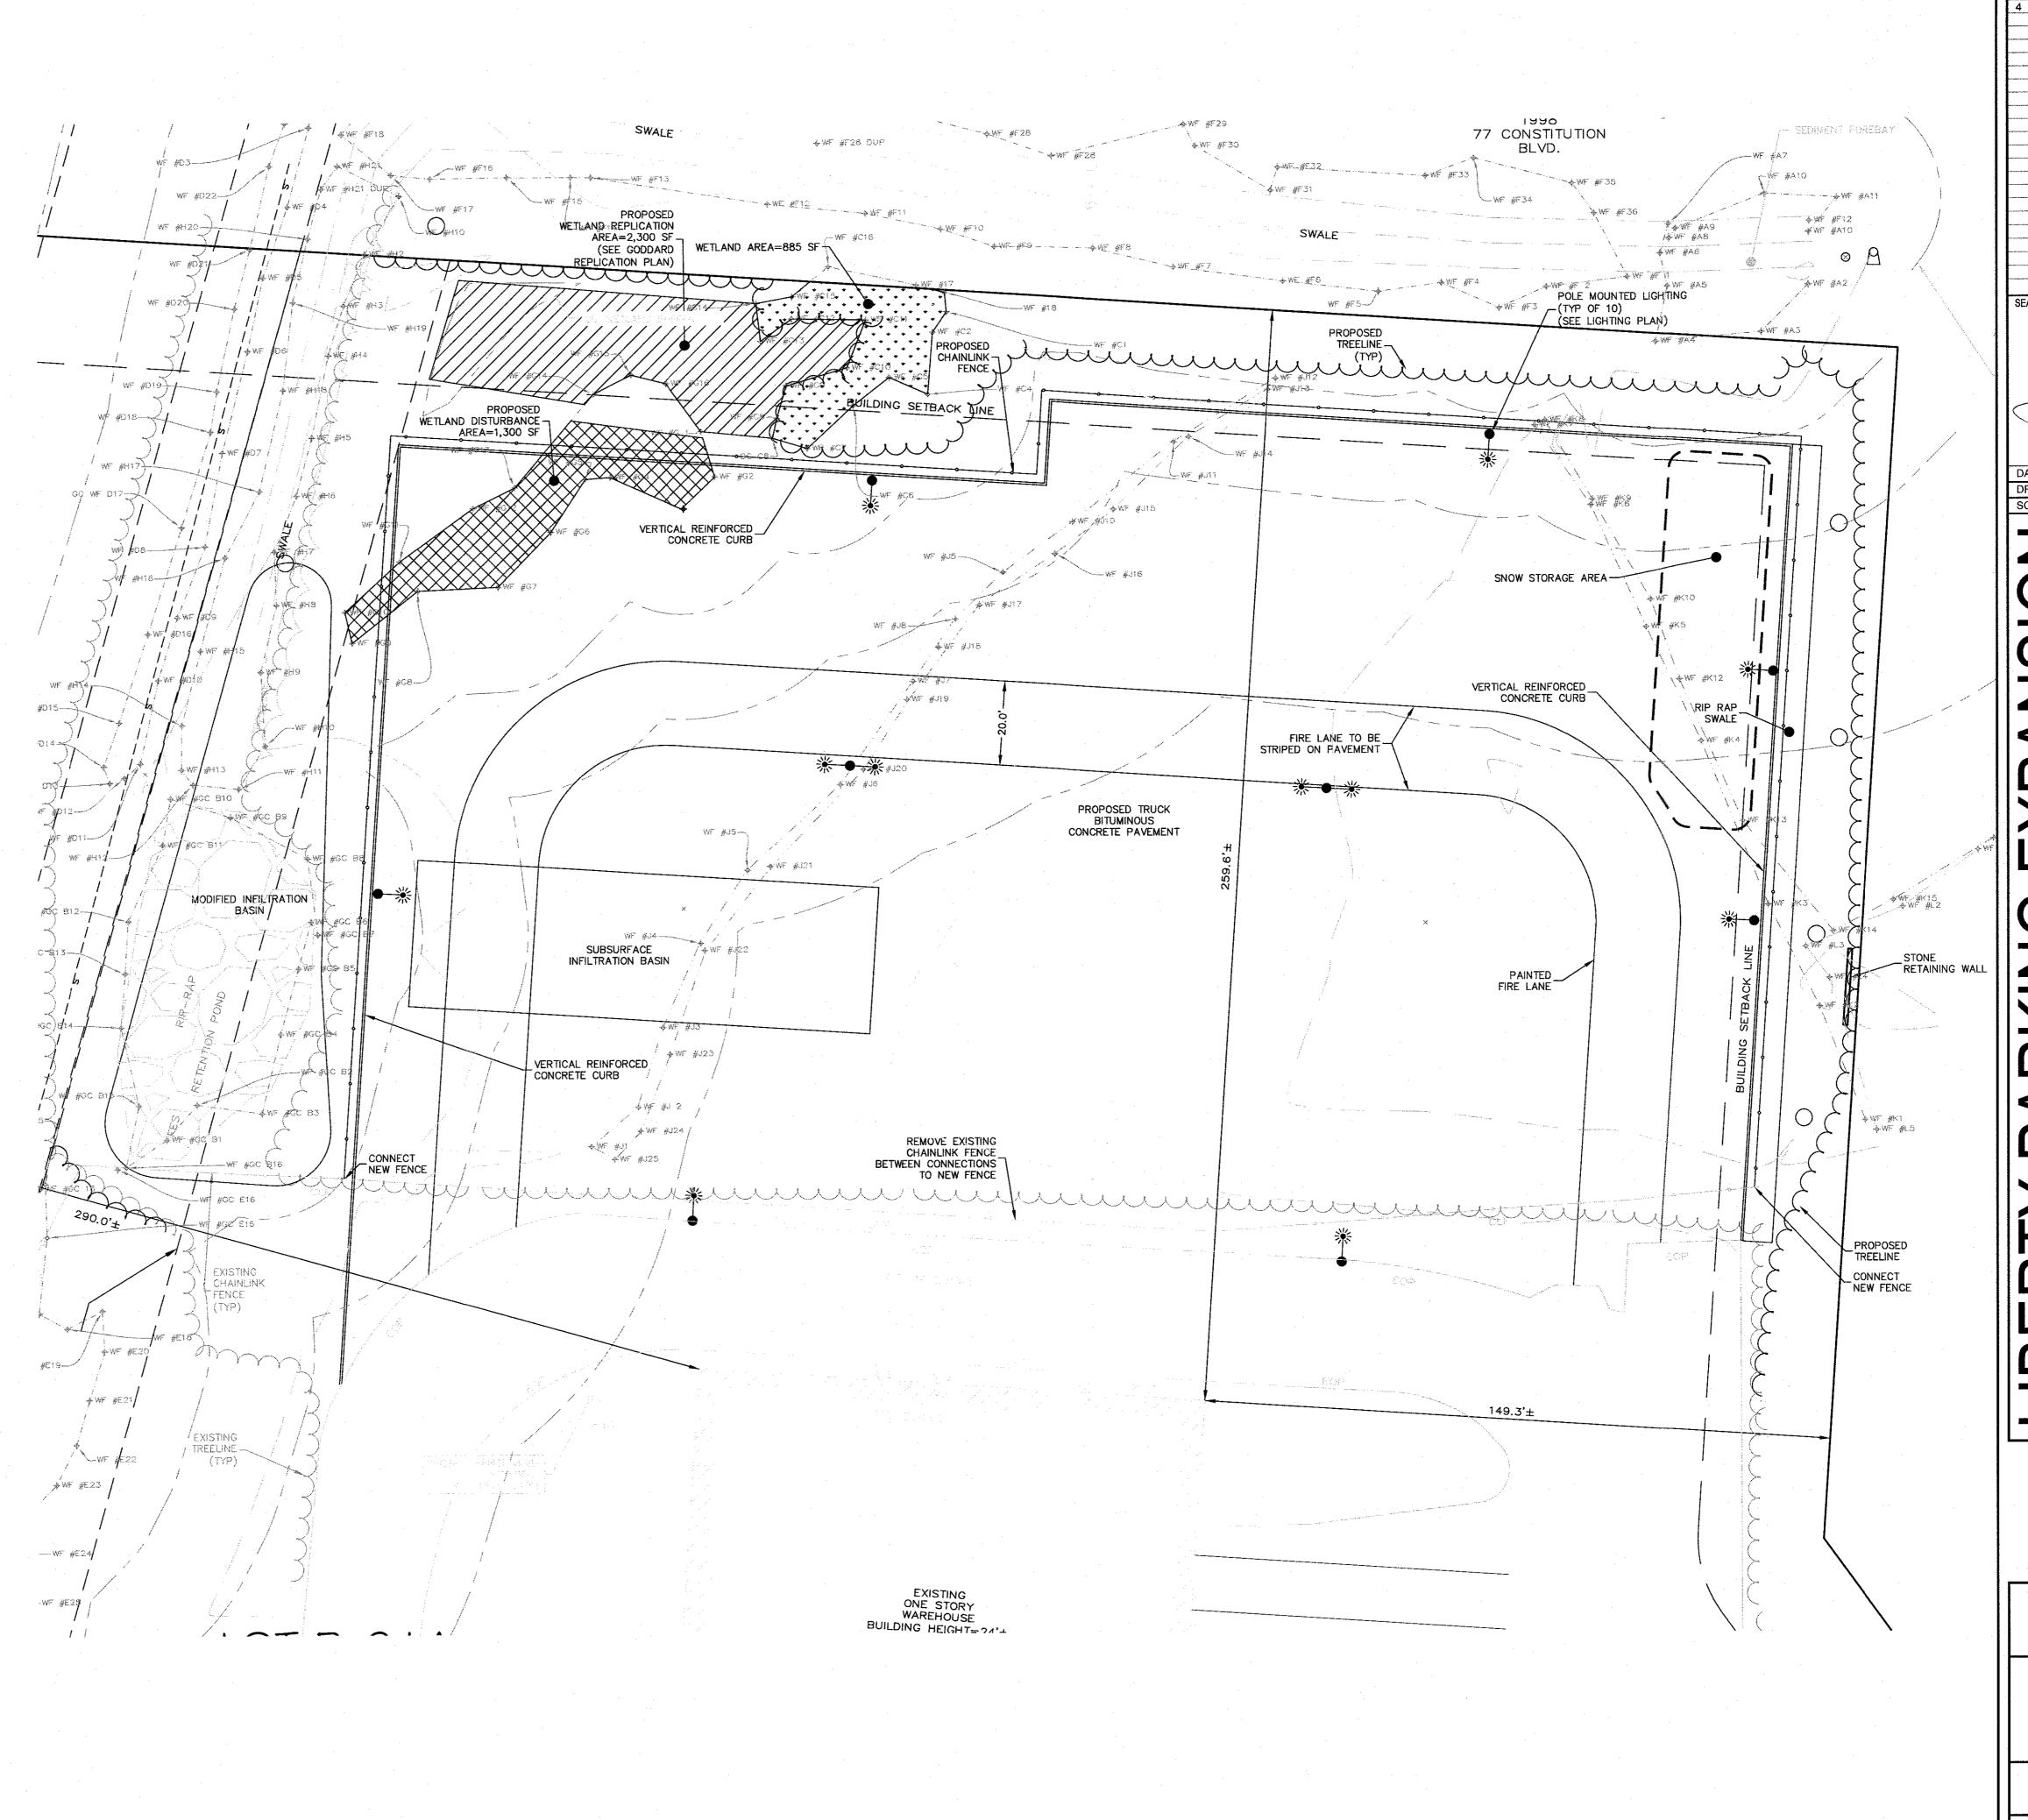
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NO DATE REVISIONS

1 10/17/2023 RESOURCE AREA FLAGS
2 11/22/2023 REVIEW COMMENTS
3 02/01/2024 REVIEW COMMENTS
4 03/19/2024 REVISE LAYOUT

SEAL

SEAL

DANIEL R
CAMPBELL
CIVIL
No. 46245

DATE: JANUARY 13, 2023

DRAWN: AH/DRC
SCALE: 1" = 20'

ARKING EXPANSIC

0

DESIGN GROUP


249 SOUTH STREET, UNIT 1 PLAINVILLE, MA 02762 TEL. (508) 695-2221 FAX. (508) 695-2219


LAYOUT & MATERIALS

C-3.0

0' 10' 20'

2081.00

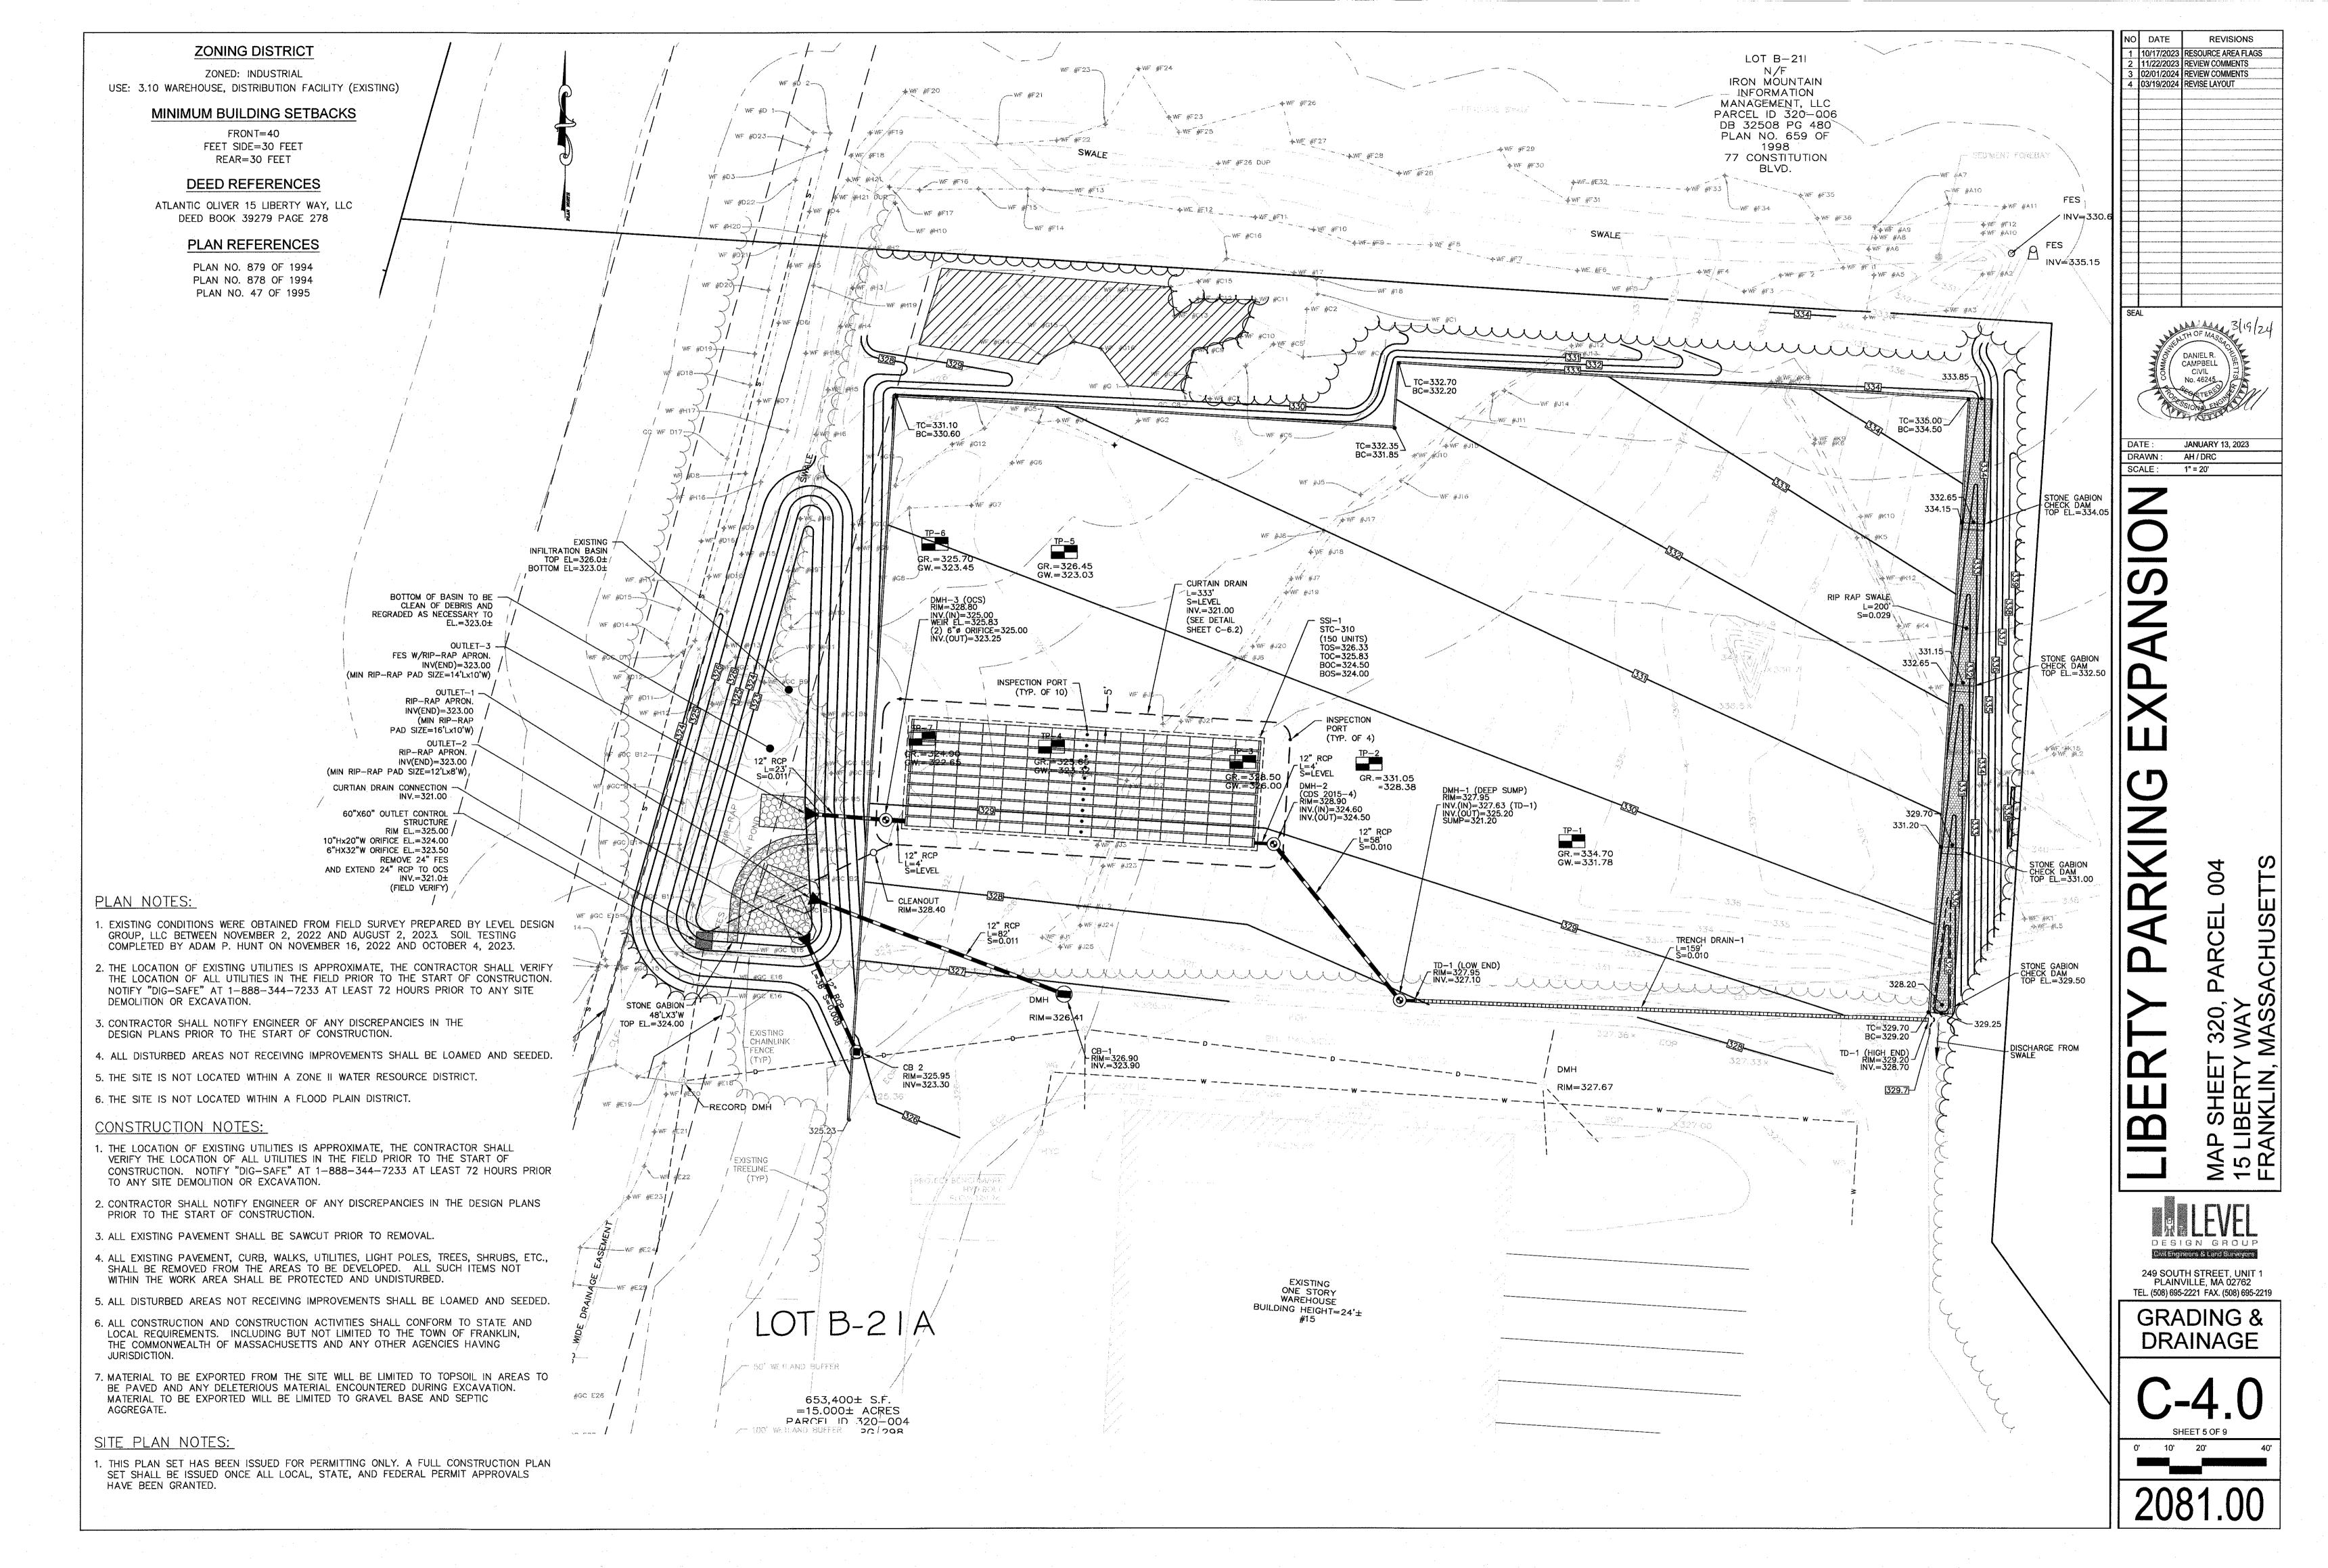

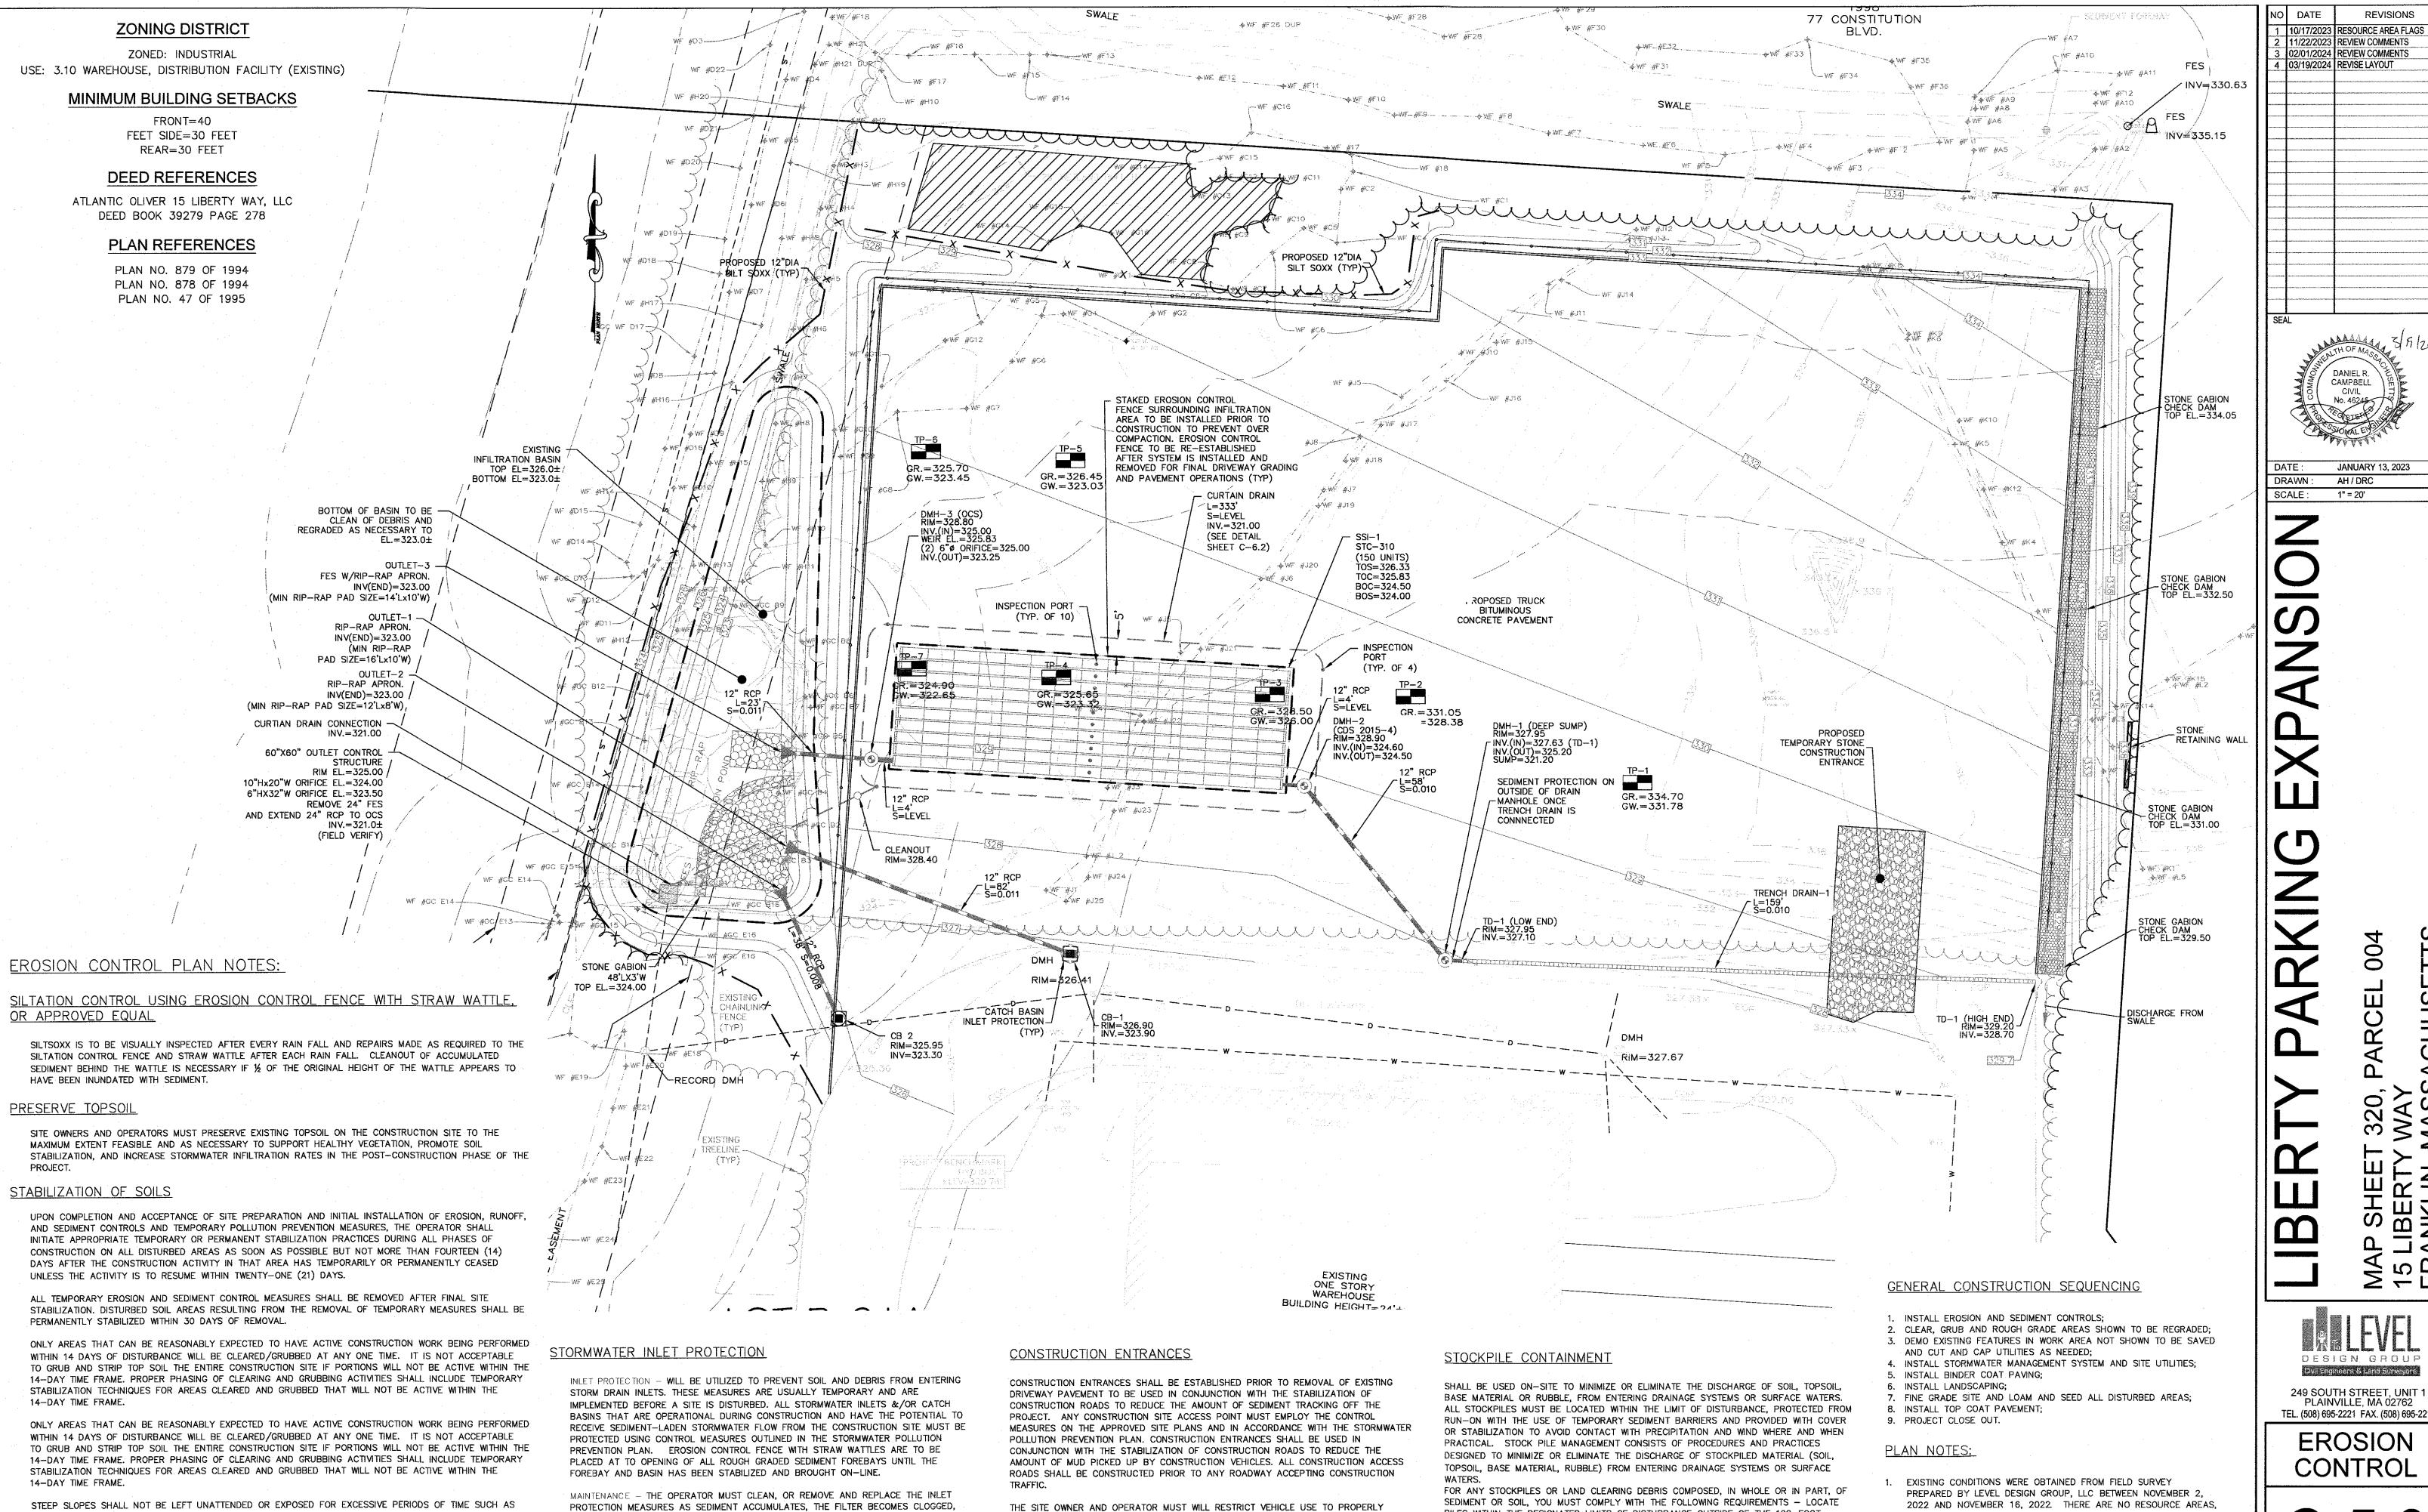

DESIGNATED EXIT POINTS, USE PROPERLY DESIGNED AND CONSTRUCTED CONSTRUCTION

ADDITIONAL CONTROLS TO REMOVE SEDIMENT FROM VEHICLE TIRES PRIOR TO EXIT (I.E.

BEEN TRACKED OUT FROM THE CONSTRUCTION SITE ONTO THE SURFACE OF OFFSET

STREETS, OTHER PAVED AREAS, AND SIDEWALKS, THE DEPOSITED SEDIMENT MUST BE

REMOVED BY THE END OF THE SAME WORK DAY IN WHICH THE TRACK OUT OCCURS.

SURFACES, OR BY USING OTHER SIMILARLY EFFECTIVE MEANS OF SEDIMENT REMOVAL.

TRACK-OUT MUST BE REMOVED BY SWEEPING, SHOVELING, OR VACUUMING THESE

WHEEL WASHING RACKS, RUMBLE STRIPS, AND RATTLE PLATES). WHERE SEDIMENT HAS

ENTRANCES AT ALL POINTS THAT EXIT ONTO PAVED ROADS SO THAT SEDIMENT

REMOVAL OCCURS PRIOR TO VEHICLE EXIT. WHEN AND WHERE NECESSARY, USE

THE INACTIVE WINTER SEASON. THE CONTRACTOR SHALL INITIATE APPROPRIATE VEGETATIVE PRACTICES ON

ALL DISTURBED AREAS IN AREAS OF STEEP SLOPES AS SOON AS POSSIBLE BUT NOT MORE THAN FOURTEEN

(14) DAYS AFTER THE CONSTRUCTION ACTIVITY IN THAT AREA HAS TEMPORARILY OR PERMANENTLY CEASED,

BEEN TEMPORARY AND/OR FINAL SEEDED IT SHALL BE PROTECTED WITH 4' HIGH ORANGE CONSTRUCTION TO

% BY WEIGHT

UNLESS THE ACTIVITY IS TO RESUME WITHIN TWENTY-ONE (21) DAYS. ONCE AN STEEP SLOPE AREA HAS

THE TEMPORARY SEEDING DESIGN MIX SHALL BE COMPRISED OF THE FOLLOWING:

ANNUAL RYE GRASS

PERENNIAL RYE GRASS

PREVENT FURTHER DISTURBANCE OF THE AREA.

AND/OR AS PERFORMANCE IS COMPROMISED. ACCUMULATED SEDIMENT ADJACENT TO

THE INLET PROTECTION MEASURES SHOULD BE REMOVED BY THE END OF THE SAME

WORK DAY IN WHICH IT IS FOUND OR BY THE END OF THE FOLLOWING WORK DAY IF

INFILTRATION BASINS - ALL AREAS CONTAINING INFILTRATION BASINS (ABOVE OR

BELOW GROUND) SHALL BE PROTECTED THROUGHOUT CONSTRUCTION. THESE AREAS

ARE NOT BE USED FOR MATERIAL STOCKPILES OR FOR PARKING EQUIPMENT. SURFACE

BASINS ARE TO BE ROUGH GRADED AND PROTECTED UNTIL STABILIZED AND BROUGHT

REMOVAL BY THE SAME WORK DAY IS NOT FEASIBLE.

ON-LINE FOR STORMWATER MANAGEMENT OF THE STABILIZED SITE.

PILES WITHIN THE DESIGNATED LIMITS OF DISTURBANCE OUTSIDE OF THE 100-FOOT

OR SWEEP SOIL OR SEDIMENT ACCUMULATED ON PAVEMENT OR OTHER IMPERVIOUS

SURFACES INTO ANY STORMWATER CONVEYANCE, STORM DRAIN INLET, OR SURFACE

BUFFER ZONE, PROTECT FROM CONTACT WITH STORMWATER (INCLUDING RUN-ON) USING

A TEMPORARY PERIMETER SEDIMENT BARRIER; WHERE PRACTICABLE, PROVIDE COVER OR

APPROPRIATE TEMPORARY VEGETATIVE OR STRUCTURAL STABILIZATION TO AVOID DIRECT

CONTACT WITH PRECIPITATION OR TO MINIMIZE SEDIMENT DISCHARGE: NEVER HOSE DOWN

WATER; TO THE MAXIMUM EXTENT PRACTICABLE, CONTAIN AND SECURELY PROTECT FROM

DESIGN GROUP

11/22/2023 REVIEW COMMENTS 02/01/2024 REVIEW COMMENTS

JANUARY 13, 2023

AH / DRC

03/19/2024 REVISE LAYOUT

249 SOUTH STREET, UNIT 1 PLAINVILLE, MA 02762

TEL. (508) 695-2221 FAX. (508) 695-2219

EROSION

IN ACCORDANCE WITH 310 CMR 10.00 WITHIN 100' OF PROPOSED

CONTRACTOR SHALL VERIFY THE LOCATION OF ALL UTILITIES IN THE

FIELD PRIOR TO THE START OF CONSTRUCTION. NOTIFY "DIG-SAFE"

CONSTRUCTION ACTIVITIES AT 15 LIBERTY WAY FRANKLIN, MA 02038,

FOR ADDITIONAL EROSION AND SEDIMENT CONTROL PRACTICES AND

AT 1-888-344-7233 AT LEAST 72 HOURS PRIOR TO ANY SITE


THE LOCATION OF EXISTING UTILITIES IS APPROXIMATE, THE

3. SEE STORMWATER POLLUTION PREVENTION PLAN PREPARED FOR

DEMOLITION OR EXCAVATION.


PROCEDURES.


0' 10' 20'

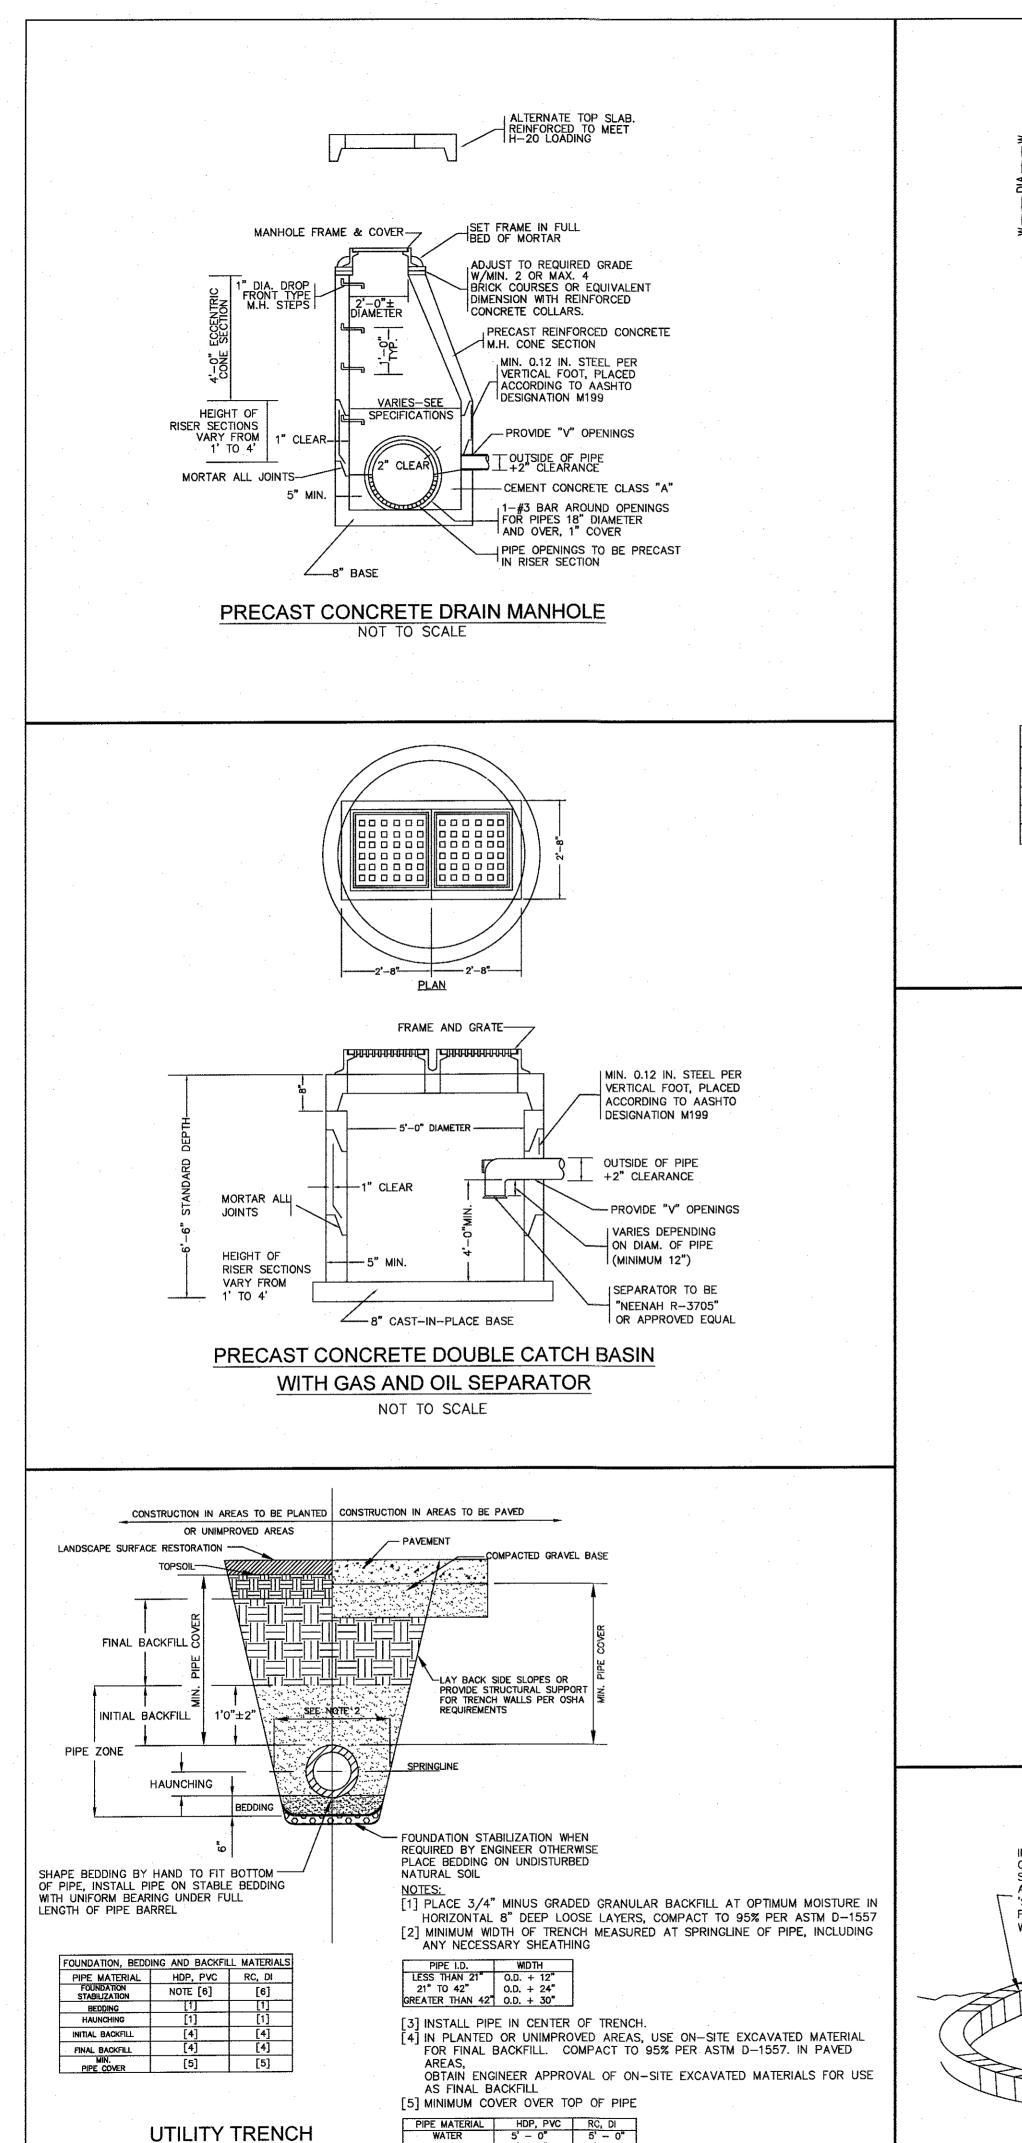



[6] FOR FOUNDATION STABILIZATION, USE 2" MINUS CRUSHED STONE

NOT TO SCALE

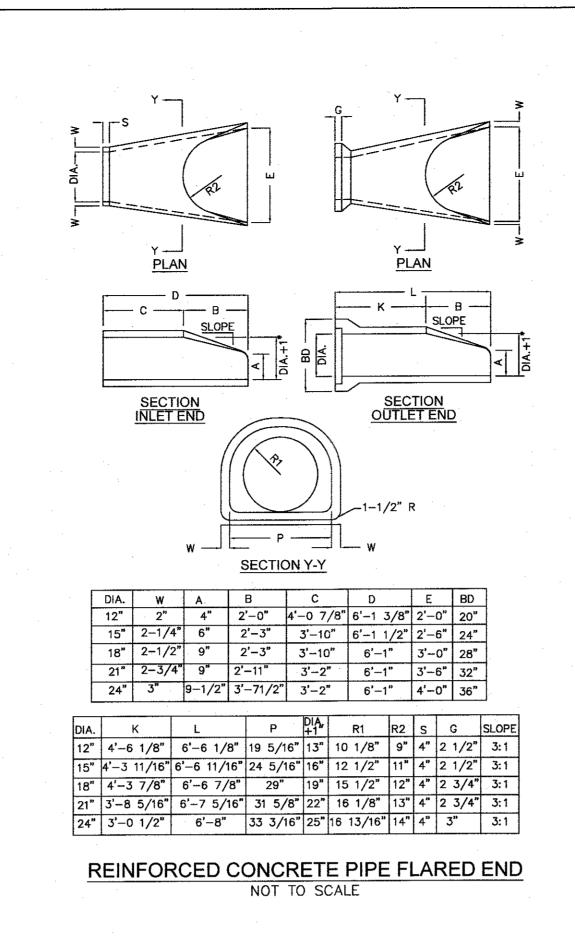

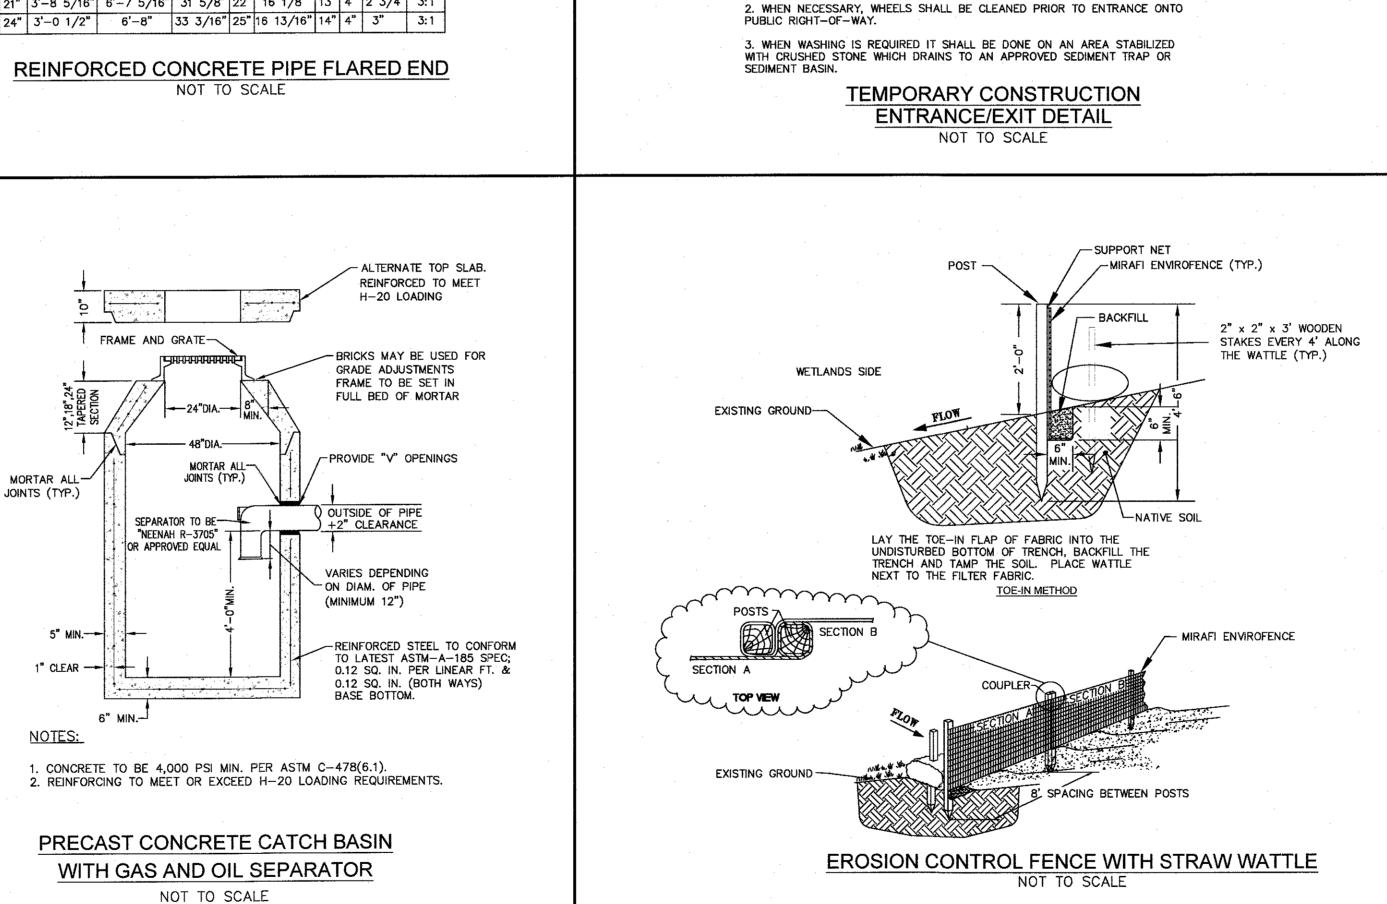

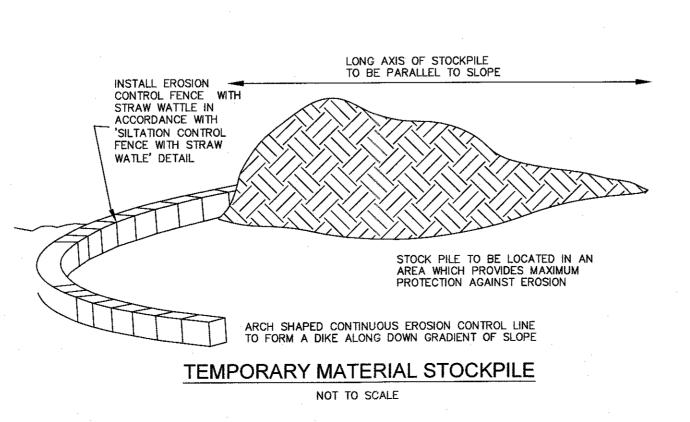

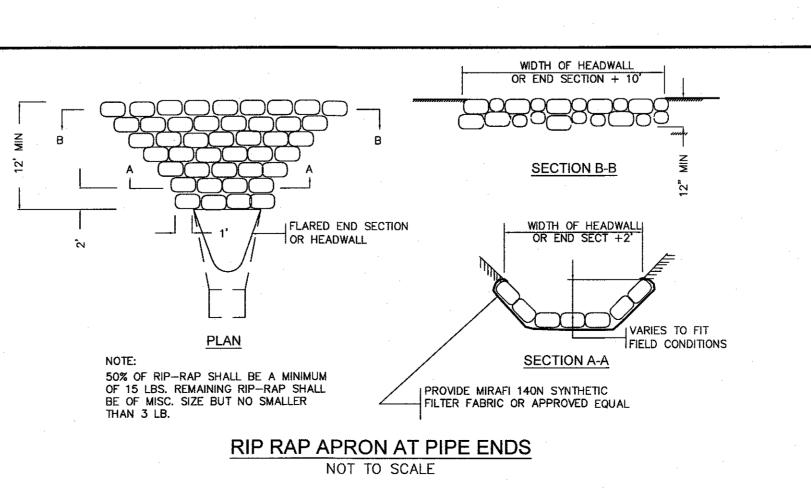

DIVERSION RIDGE REQUIRED

WHERE GRADE EXCEEDS 2%

SECTION A-A

SPILLWAY

1. THE ENTRANCE SHALL BE MAINTAINED IN A CONDITIONS THAT WILL PREVENT TRACKING OR FLOWING OF SEDIMENT ONTO PUBLIC RIGHT-OF-WAYS. THIS MAY

REQUIRE TOP DRESSING, REPAIR AND/OR CLEANOUT OF ANY MEASURES USED TO TRAP SEDIMENT.

COURSE AGGREGATE

-DIVERSION RIDGE

FROM

6" MIN COURSE-

GRAVEL APRON

HAY BALES, SANDBAGS, OR CONTINUOUS BERM OF

EQUIVALENT HEIGHT

EXISTING ROADWAY

ROAD


2 % OR GREATER


USE HAYBALES OR OTHER APPROVED


METHODS TO CHANNELIZE RUNOFF TO


BASIN AS REQUIRED.

ACCESS RD.

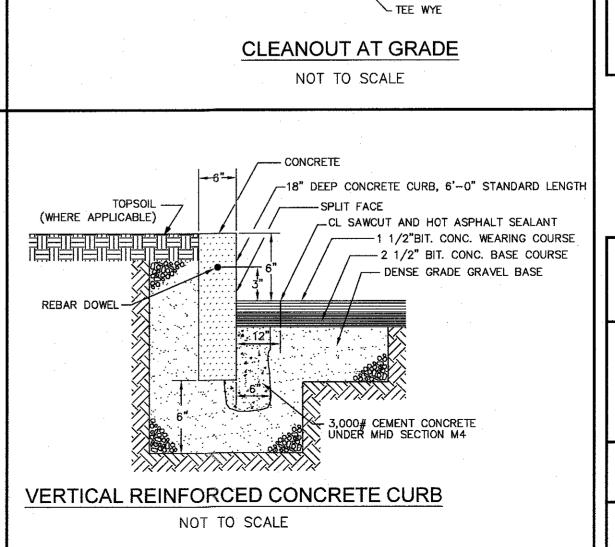

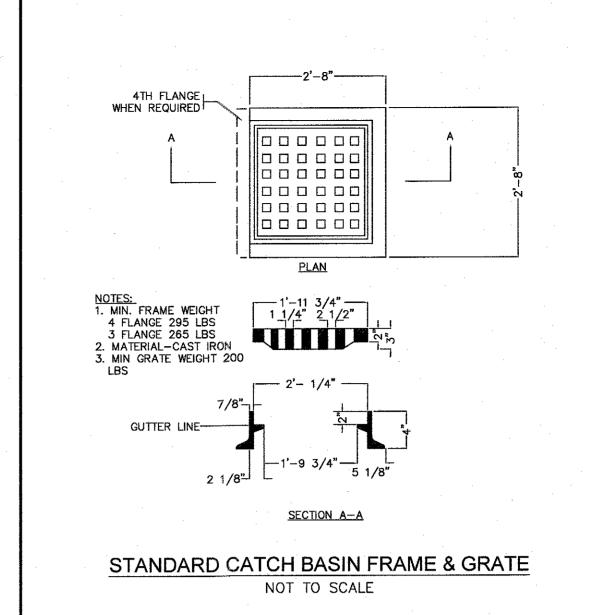

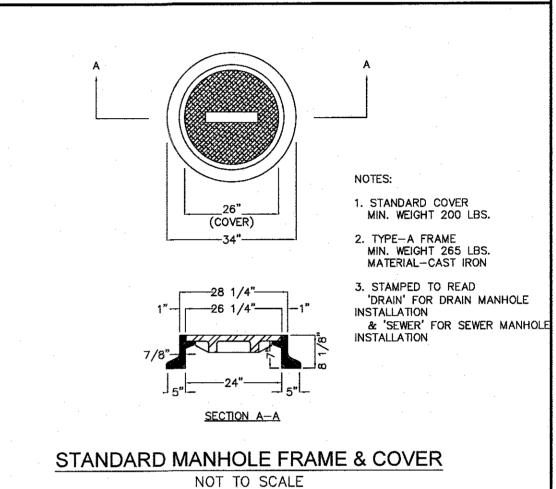

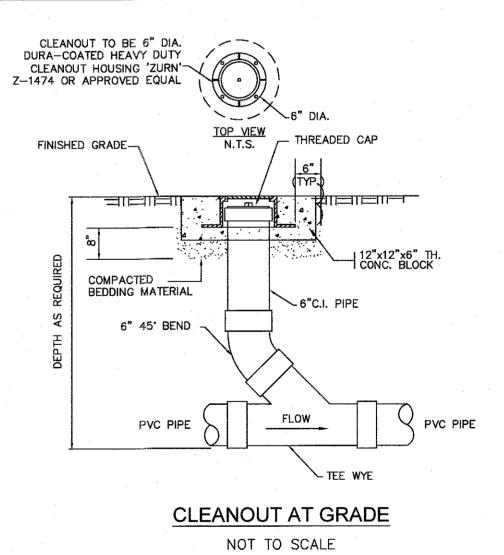

DESIGN GROUP Civil Engineers & Land Surveyors

NO DATE

REVISIONS

1 10/17/2023 RESOURCE AREA FLAGS

DANIEL R.

CAMPBELL

JANUARY 13, 2023

CIVIL No. 46245

AS NOTED

DATE:


SCALE:


DRAWN: AH/DRC


2 11/22/2023 REVIEW COMMENTS 3 02/01/2024 REVIEW COMMENTS 4 03/19/2024 REVISE LAYOUT


249 SOUTH STREET, UNIT 1 PLAINVILLE, MA 02762 TEL. (508) 695-2221 FAX. (508) 695-2219

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JANUARY 13, 2023

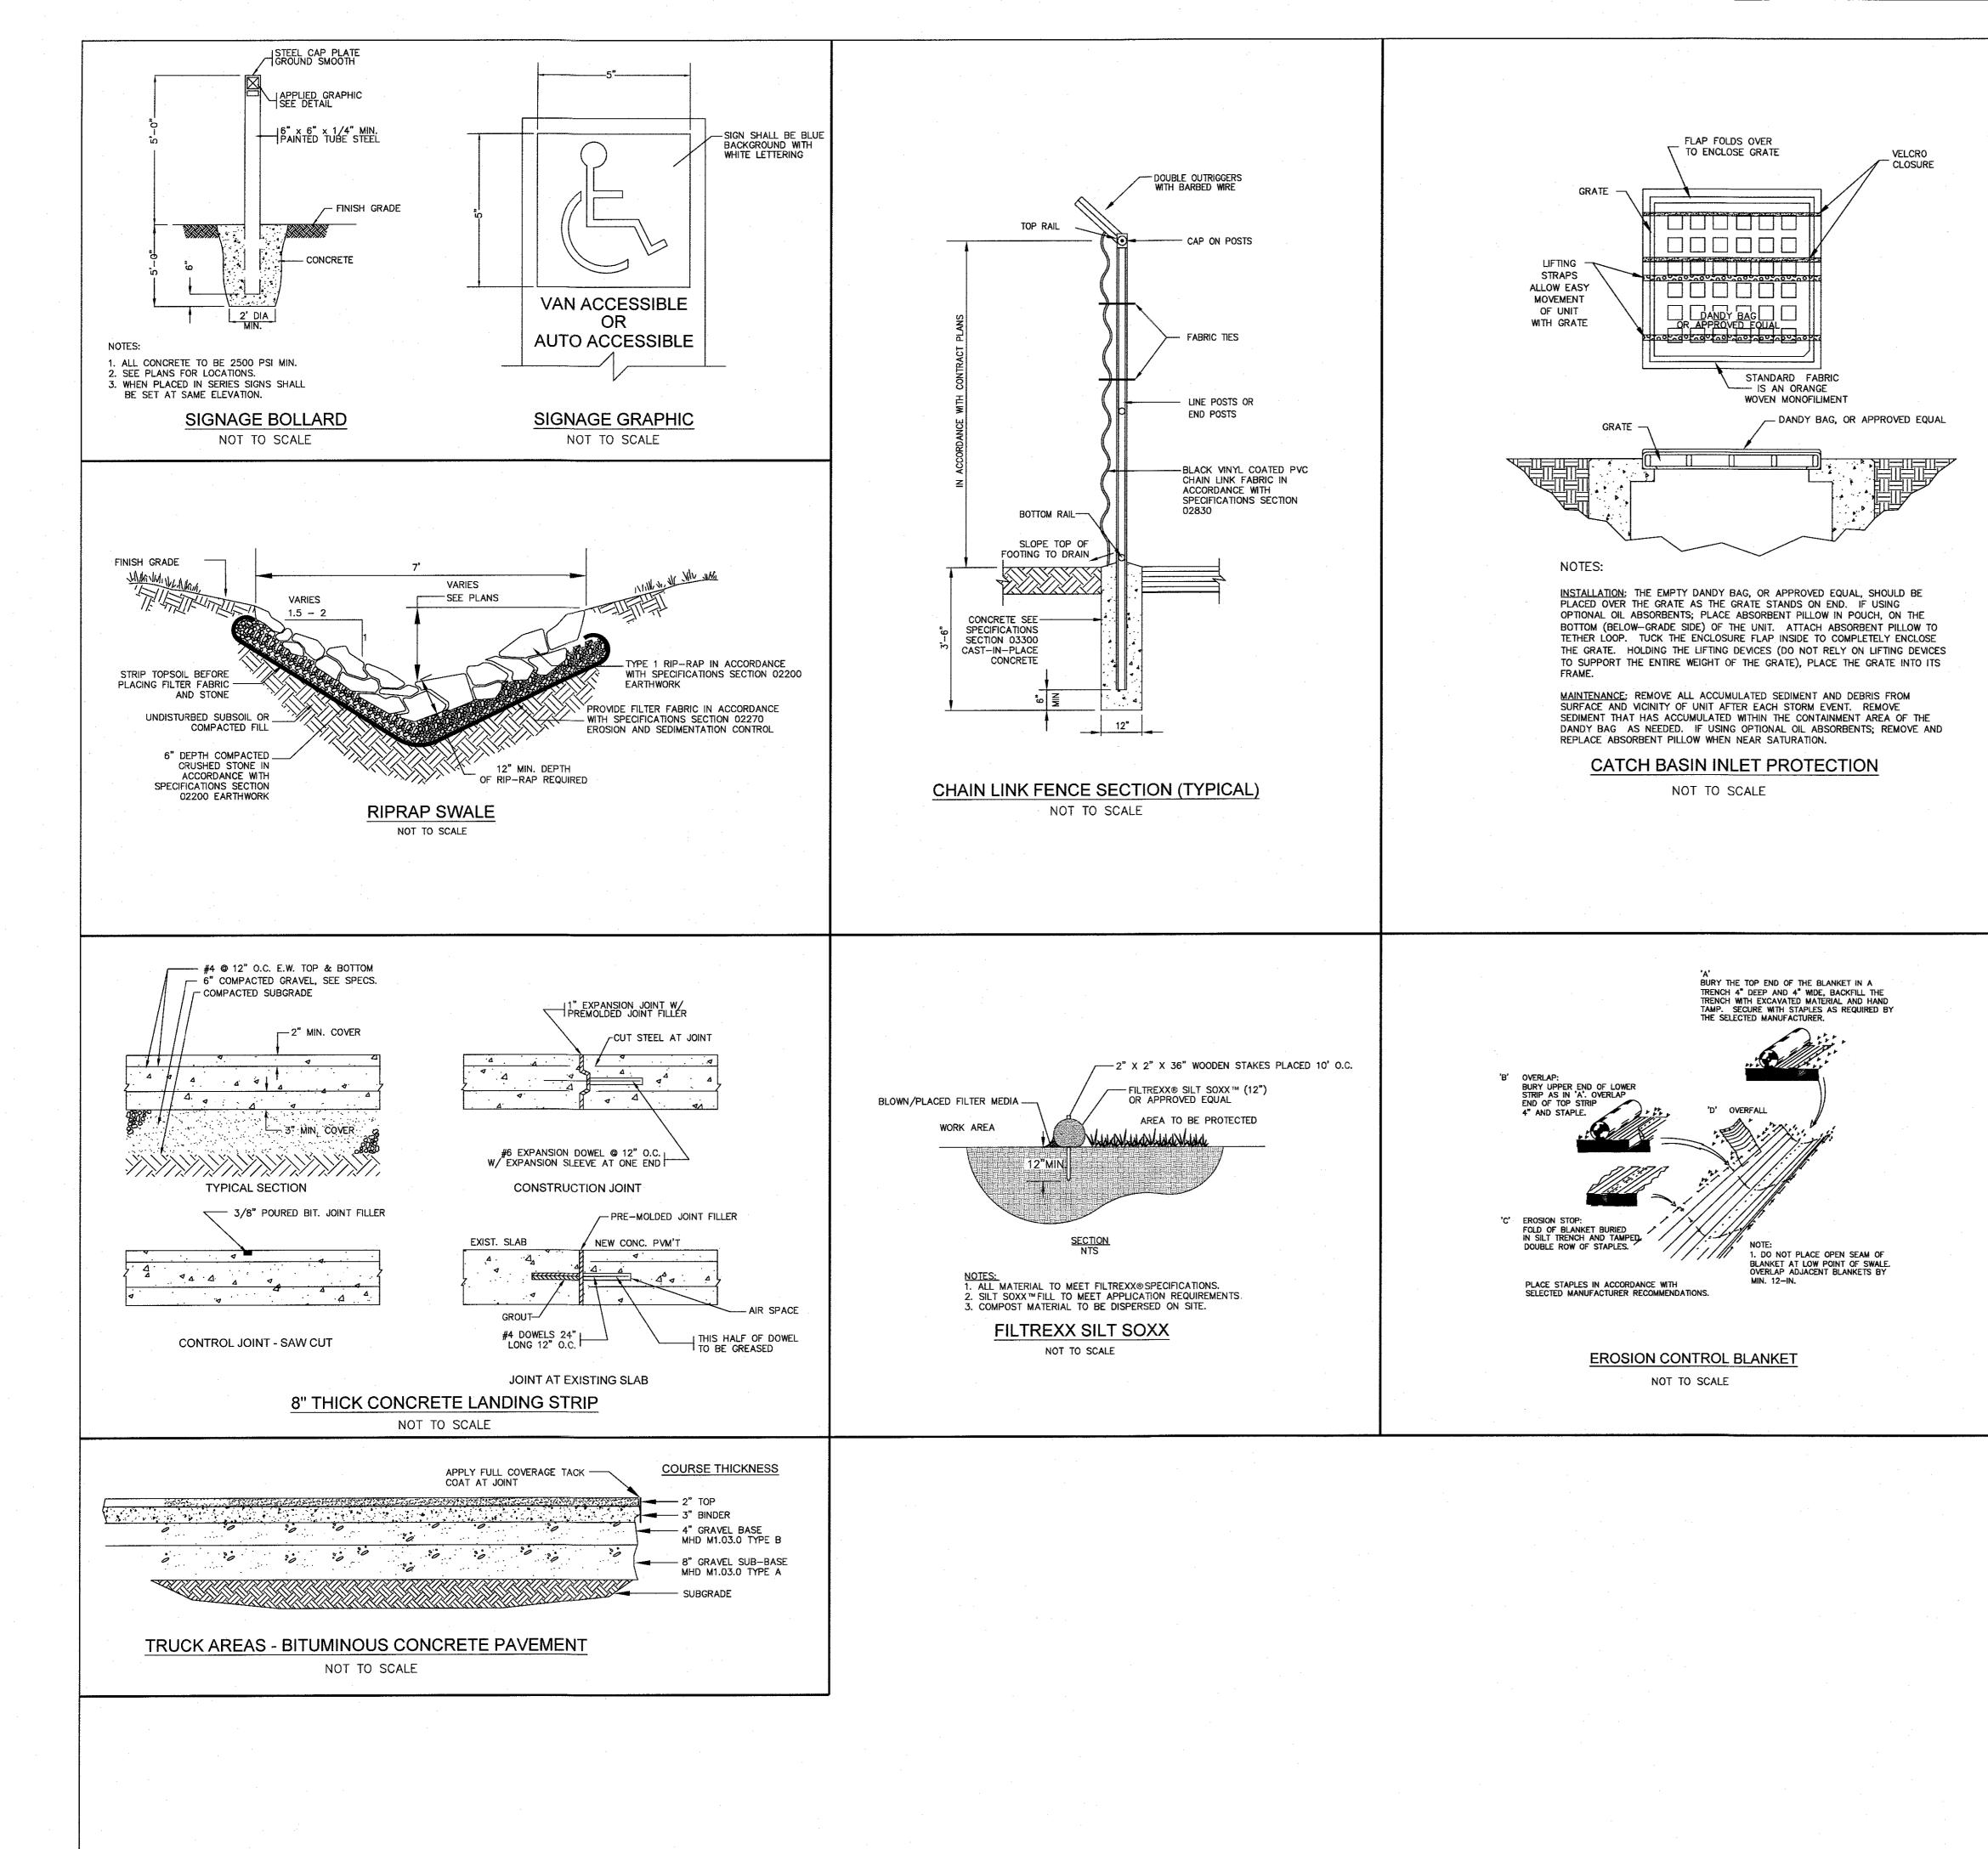AH / DRC

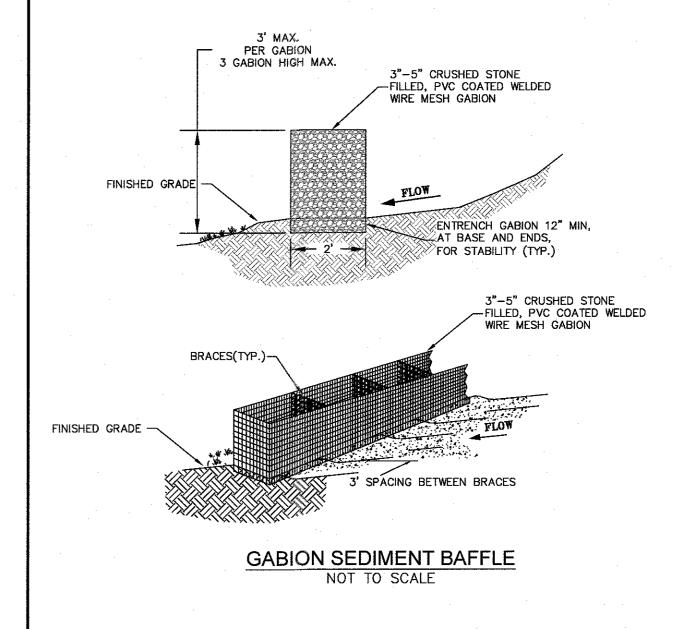AS NOTED

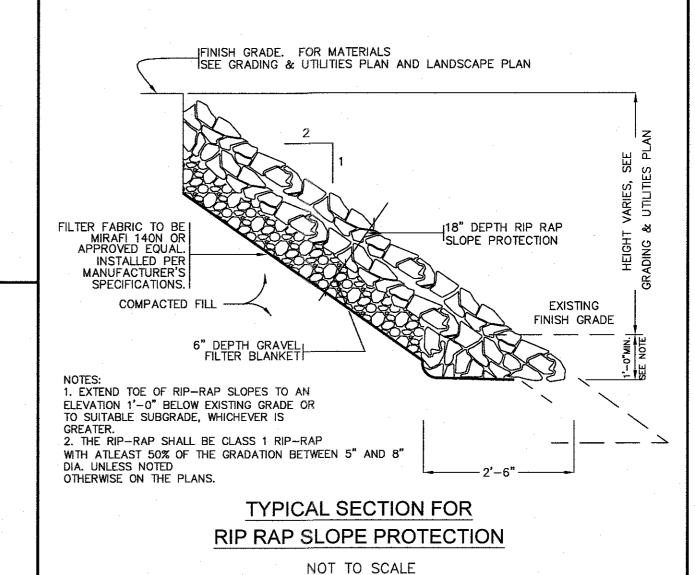DRAWN:

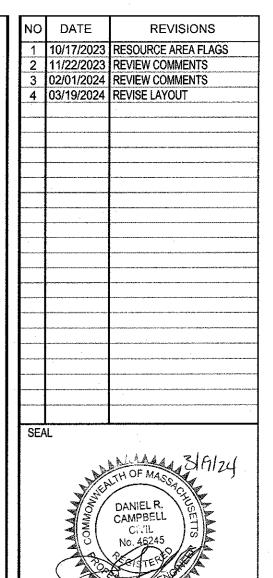SCALE:

MAP SHEET 320, PARCEL 004

Civil Engineers & Land Surveyo

249 SOUTH STREET, UNIT 1 PLAINVILLE, MA 02762

TEL. (508) 695-2221 FAX. (508) 695-2219

TYPICAL

DETAILS


C-6.1

2081.00

GENERAL NOTES


- 1. CONTECH TO PROVIDE ALL MATERIALS UNLESS NOTED OTHERWISE. 2. CONTRACTOR SHALL REQUEST SHOP DRAWINGS OF EACH INDIVIDUAL CDS STORMWATER TREATMENT UNIT AND SHALL SUBMIT THEM FOR REVIEW AND APPROVAL TO THE DESIGN ENGINEER
- PRIOR TO UNITS BEING ORDERED OR ENTERING PRODUCTION. 3. DIMENSIONS MARKED WITH () ARE REFERENCE DIMENSIONS. ACTUAL DIMENSIONS MAY VARY.
- 4. FOR FABRICATION DRAWINGS WITH DETAILED STRUCTURE DIMENSIONS AND WEIGHTS, PLEASE CONTACT YOUR CONTECH CONSTRUCTION PRODUCT'S REPRESENTATIVE. www.contech-cpi.com 5. CDS WATER QUALITY STRUCTURE SHALL BE IN ACCORDANCE WITH ALL DESIGN DATA AND
- INFORMATION CONTAINED IN THIS DRAWING. 6. STRUCTURE SHALL MEET AASHTO HS20 AND CASTINGS SHALL MEET AASHTO M306 LOAD RATING, ASSUMING GROUNDWATER ELEVATION AT, OR BELOW, THE OUTLET PIPE INVERT ELEVATION.
- ENGINEER OF RECORD TO CONFIRM ACTUAL GROUNDWATER ELEVATION. 7. PVC HYDRAULIC SHEAR PLATE IS PLACED ON SHELF AT BOTTOM OF SCREEN CYLINDER. REMOVE
- AND REPLACE AS NECESSARY DURING MAINTENANCE CLEANING. INSTALLATION NOTES


 1. ANY SUB-BASE, BACKFILL DEPTH, AND/OR ANTI-FLOTATION PROVISIONS ARE SITE-SPECIFIC DESIGN
- CONSIDERATIONS AND SHALL BE SPECIFIED BY ENGINEER OF RECORD. 2. CONTRACTOR TO PROVIDE EQUIPMENT WITH SUFFICIENT LIFTING AND REACH CAPACITY TO LIFT AND
- SET THE CDS MANHOLE STRUCTURE (LIFTING CLUTCHES PROVIDED). 3. CONTRACTOR TO ADD JOINT SEALANT BETWEEN ALL STRUCTURE SECTIONS, AND ASSEMBLE
- 4. CONTRACTOR TO PROVIDE, INSTALL, AND GROUT PIPES. MATCH PIPE INVERTS WITH ELEVATIONS
- 5. CONTRACTOR TO TAKE APPROPRIATE MEASURES TO ASSURE UNIT IS WATER TIGHT, HOLDING WATER TO FLOWLINE INVERT MINIMUM. IT IS SUGGESTED THAT ALL JOINTS BELOW PIPE INVERTS
- 60" I.D. MANHOLE OUTLET PIPE STRUCTURE

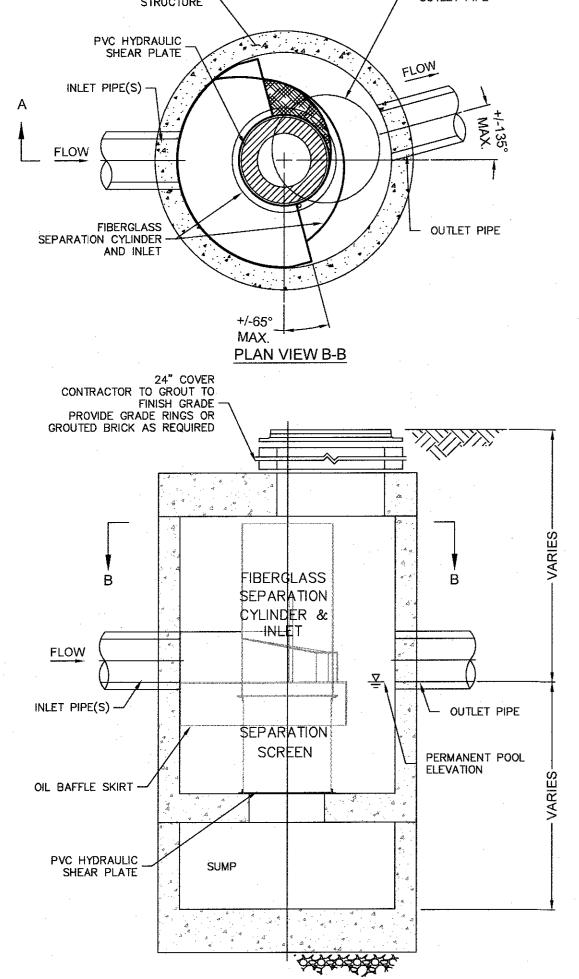

ELEVATION VIEW

STORM WATER TREATMENT UNIT

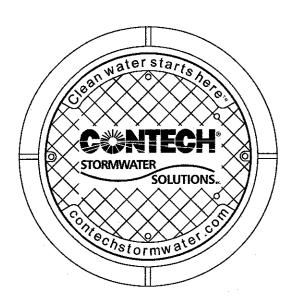

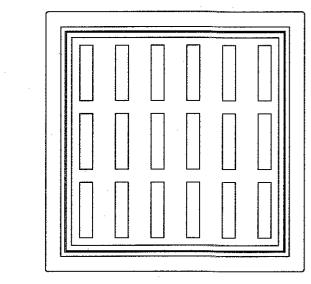

FRAME AND COVER (DIAMETER VARIES) N.T.S.

FRAME AND GRATE (24" SQUARE) N.T.S.

CDS STORMWATER TREATEMENT UNITS
NOT TO SCALE

ACCEPTABLE FILL MATERIALS: STORMTECH SC-310 CHAMBER SYSTEMS

····· b · · · · · b · · ·	MATERIAL LOCATION	DESCRIPTION	AASHTO MATERIAL CLASSIFICATIONS	COMPACTION / DENSITY REQUIREMENT
D	FINAL FILL: FILL MATERIAL FOR LAYER 'D' STARTS FROM THE TOP OF THE 'C' LAYER TO THE BOTTOM OF FLEXIBLE PAVEMENT OR UNPAVED FINISHED GRADE ABOVE. NOTE THAT PAVEMENT SUBBASE MAY BE PART OF THE 'D' LAYER.	ANY SOIL/ROCK MATERIALS, NATIVE SOILS, OR PER ENGINEER'S PLANS. CHECK PLANS FOR PAVEMENT SUBGRADE REQUIREMENTS.	N/A	PREPARE PER SITE DESIGN ENGINEER'S PLANS. PAVED INSTALLATIONS MAY HAVE STRINGENT MATERIAL AND PREPARATION REQUIREMENTS.
C .	INITIAL FILL: FILL MATERIAL FOR LAYER 'C' STARTS FROM THE TOP OF THE EMBEDMENT STONE ('B' LAYER) TO 18" (450 mm) ABOVE THE TOP OF THE CHAMBER. NOTE THAT PAVEMENT SUBBASE MAY BE A PART OF THE 'C' LAYER.	GRANULAR WELL-GRADED SOIL/AGGREGATE MIXTURES, <35% FINES OR PROCESSED AGGREGATE. MOST PAVEMENT SUBBASE MATERIALS CAN BE USED IN LIEU OF THIS LAYER.	AASHTO M145 ¹ A-1, A-2-4, A-3 OR AASHTO M43 ¹ 3, 357, 4, 467, 5, 56, 57, 6, 67, 68, 7, 78, 8, 89, 9, 10	BEGIN COMPACTIONS AFTER 12" (300 mm) OF MATERIAL OVER THE CHAMBERS IS REACHED. COMPACT ADDITIONAL LAYERS IN 6" (150 mm) MAX LIFTS TO A MIN. 95% PROCTOR DENSITY FOR WELL GRADED MATERIAL AND 95% RELATIVE DENSITY FOR PROCESSED AGGREGATE MATERIALS. ROLLER GROSS VEHICLE WEIGHT NOT TO EXCEED 12,000 lbs (53 kN). DYNAMIC FORCE NOT TO EXCEED 20,000 lbs (89 kN).
В	EMBEDMENT STONE: FILL SURROUNDING THE CHAMBERS FROM THE FOUNDATION STONE ('A' LAYER) TO THE 'C' LAYER ABOVE.	CLEAN, CRUSHED, ANGULAR STONE	AASHTO M43 ¹ 3, 357, 4, 467, 5, 56, 57	NO COMPACTION REQUIRED.
А	FOUNDATION STONE: FILL BELOW CHAMBERS FROM THE SUBGRADE UP TO THE FOOT (BOTTOM) OF THE CHAMBER.	CLEAN, CRUSHED, ANGULAR STONE	AASHTO M43 ¹ 3, 357, 4, 467, 5, 56, 57	PLATE COMPACT OR ROLL TO ACHIEVE A FLAT SURFACE. ^{2,3}

1. THE LISTED AASHTO DESIGNATIONS ARE FOR GRADATIONS ONLY, THE STONE MUST ALSO BE CLEAN, CRUSHED, ANGULAR, FOR EXAMPLE, A SPECIFICATION FOR #4 STONE WOULD STATE: "CLEAN, CRUSHED, ANGULAR NO. 4 (AASHTO M43) STONE". STORMTECH COMPACTION REQUIREMENTS ARE MET FOR 'A' LOCATION MATERIALS WHEN PLACED AND COMPACTED IN 6" (150 mm) (MAX) LIFTS USING TWO FULL COVERAGES WITH A VIBRATORY COMPACTOR.


(150 mm) MIN

SYSTEM CROSS SECTION

3. WHERE INFILTRATION SURFACES MAY BE COMPROMISED BY COMPACTION, FOR STANDARD DESIGN LOAD CONDITIONS, A FLAT SURFACE MAY BE ACHIEVED BY RAKING OR DRAGGING WITHOUT COMPACTION EQUIPMENT. FOR SPECIAL LOAD DESIGNS.

*TO BOTTOM OF FLEXIBLE PAVEMENT. FOR UNPAVED INSTALLATIONS WHERE RUTTING FROM VEHICLES MAY OCCUR, INCREASE COVER TO 24" (600 mm).

4. ONCE LAYER 'C' IS PLACED, ANY SOIL/MATERIAL CAN BE PLACED IN LAYER 'D' UP TO THE FINISHED GRADE. MOST PAVEMENT SUBBASE SOILS CAN BE USED TO REPLACE THE MATERIAL REQUIREMENTS OF LAYER 'C' OR 'D' AT THE SITE DESIGN ENGINEER'S

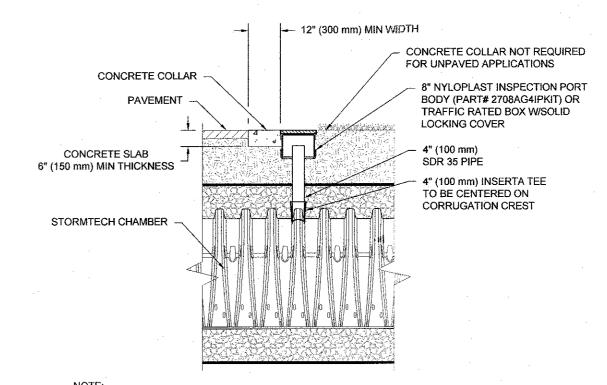

INSPECTION PORTS MAY BE CONNECTED THROUGH ANY CHAMBER CORRUGATION CREST. INSPECTION PORT

- 1. CHAMBERS SHALL MEET THE REQUIREMENTS OF ASTM F2922 (POLETHYLENE) OR ASTM F2418 (POLYPROPYLENE), "STANDARD SPECIFICATION FOR CORRUGATED WALL STORMWATER COLLECTION CHAMBERS".
- 2. SC-310 CHAMBERS SHALL BE DESIGNED IN ACCORDANCE WITH ASTM F2787 "STANDARD PRACTICE FOR STRUCTURAL DESIGN OF THERMOPLASTIC
- CORRUGATED WALL STORMWATER COLLECTION CHAMBERS". 3. THE SITE DESIGN ENGINEER IS RESPONSIBLE FOR ASSESSING THE BEARING RESISTANCE (ALLOWABLE BEARING CAPACITY) OF THE SUBGRADE SOILS AND
- THE DEPTH OF FOUNDATION STONE WITH CONSIDERATION FOR THE RANGE OF EXPECTED SOIL MOISTURE CONDITIONS.
- 4. PERIMETER STONE MUST BE EXTENDED HORIZONTALLY TO THE EXCAVATION WALL FOR BOTH VERTICAL AND SLOPED EXCAVATION WALLS. 5. REQUIREMENTS FOR HANDLING AND INSTALLATION:
- TO MAINTAIN THE WIDTH OF CHAMBERS DURING SHIPPING AND HANDLING, CHAMBERS SHALL HAVE INTEGRAL, INTERLOCKING STACKING LUGS. • TO ENSURE A SECURE JOINT DURING INSTALLATION AND BACKFILL, THE HEIGHT OF THE CHAMBER JOINT SHALL NOT BE LESS THAN 2".
- TO ENSURE THE INTEGRITY OF THE ARCH SHAPE DURING INSTALLATION, a) THE ARCH STIFFNESS CONSTANT AS DEFINED IN SECTION 6.2.8 OF ASTM F2922 SHALL BE GREATER THAN OR EQUAL TO 400 LBS/FT/%. AND b) TO RESIST CHAMBER DEFORMATION DURING INSTALLATION AT ELEVATED TEMPERATURES (ABOVE 73° F / 23° C), CHAMBERS SHALL BE PRODUCED FROM REFLECTIVE GOLD OR YELLOW COLORS.

STORMTECH SC-310 DETAILS NOT TO SCALE

(450 mm) MIN*

DEPTH OF STONE TO BE DETERMINED

BY SITE DESIGN ENGINEER 6" (150 mm) MIN

**THIS CROSS SECTION DETAIL REPRESENTS

MINIMUM REQUIREMENTS FOR INSTALLATION. PLEASE SEE THE LAYOUT SHEET(S) FOR

PROJECT SPECIFIC REQUIREMENTS.

PAVEMENT LAYER (DESIGNED


6" (150 mm)

MIN

12" (300 mm) MIN.SYSTEM SS-1

36" MIN, SYSTEM SS-2

BY SITE DESIGN ENGINEER)

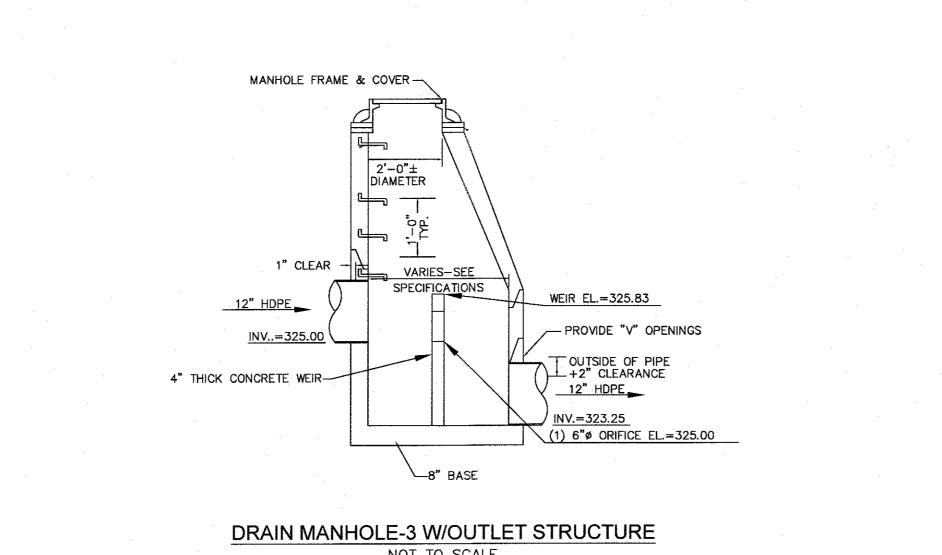

SUBGRADE SOILS -

(SEE NOTE 4)

ADS GEOSYNTHETICS 601T NON-WOVEN GEOTEXTILE ALL AROUND

PERIMETER STONE

(SEE NOTE 5)

EXCAVATION WALL -


12" (300 mm) MIN -

(CAN BE SLOPED OR VERTICAL)

CLEAN CRUSHED, ANGULAR STONE IN A & B LAYERS


END CAP

NOT TO SCALE

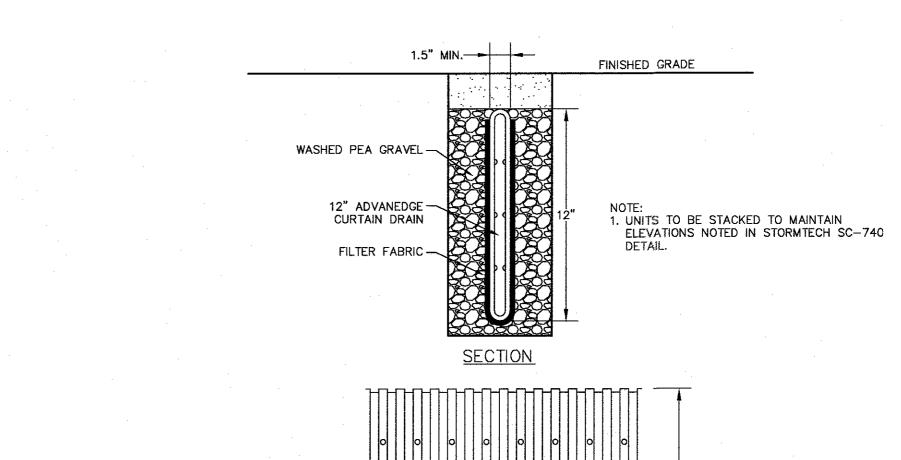


1. TRENCH MUST BE NO LESS THAN 4" WIDE 2. MINIMUM COVER SHALL BE NO LESS THAN 4"
3. ALL PIPE FITTINGS SHALL BE MADE OF POLY ETHYLENE WITH A MINIMUM CELL CLASSIFICATION OF 424420C AS DEFINED AND

DESCRIBED IN ASTM D3350. 4. GEOTEXTILE SHALL MEET THE REQUIREMENTS OF CLASS B GEOCOMPOSITE AS DEFINED IN ASTM

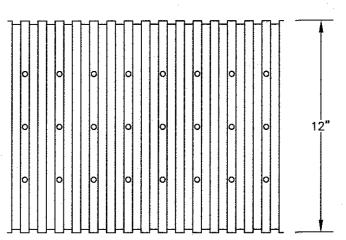

ELEVATION ADVANEDGE CURTAIN DRAIN

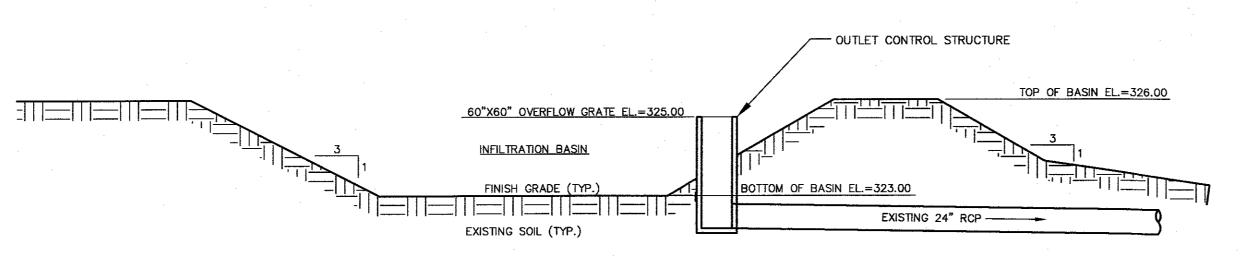

CROSS SECTION

INFILTRATION BASIN NOT TO SCALE



O DATE

REVISIONS

10/17/2023 RESOURCE AREA FLAGS 11/22/2023 REVIEW COMMENTS

JANUARY 13, 2023

004

RCEL

AH / DRC

AS NOTED

DRAWN:


SCALE:

02/01/2024 REVIEW COMMENTS

03/19/2024 REVISE LAYOUT

249 SOUTH STREET, UNIT 1 PLAINVILLE, MA 02762 TEL. (508) 695-2221 FAX. (508) 695-2219

TYPICAL DETAILS

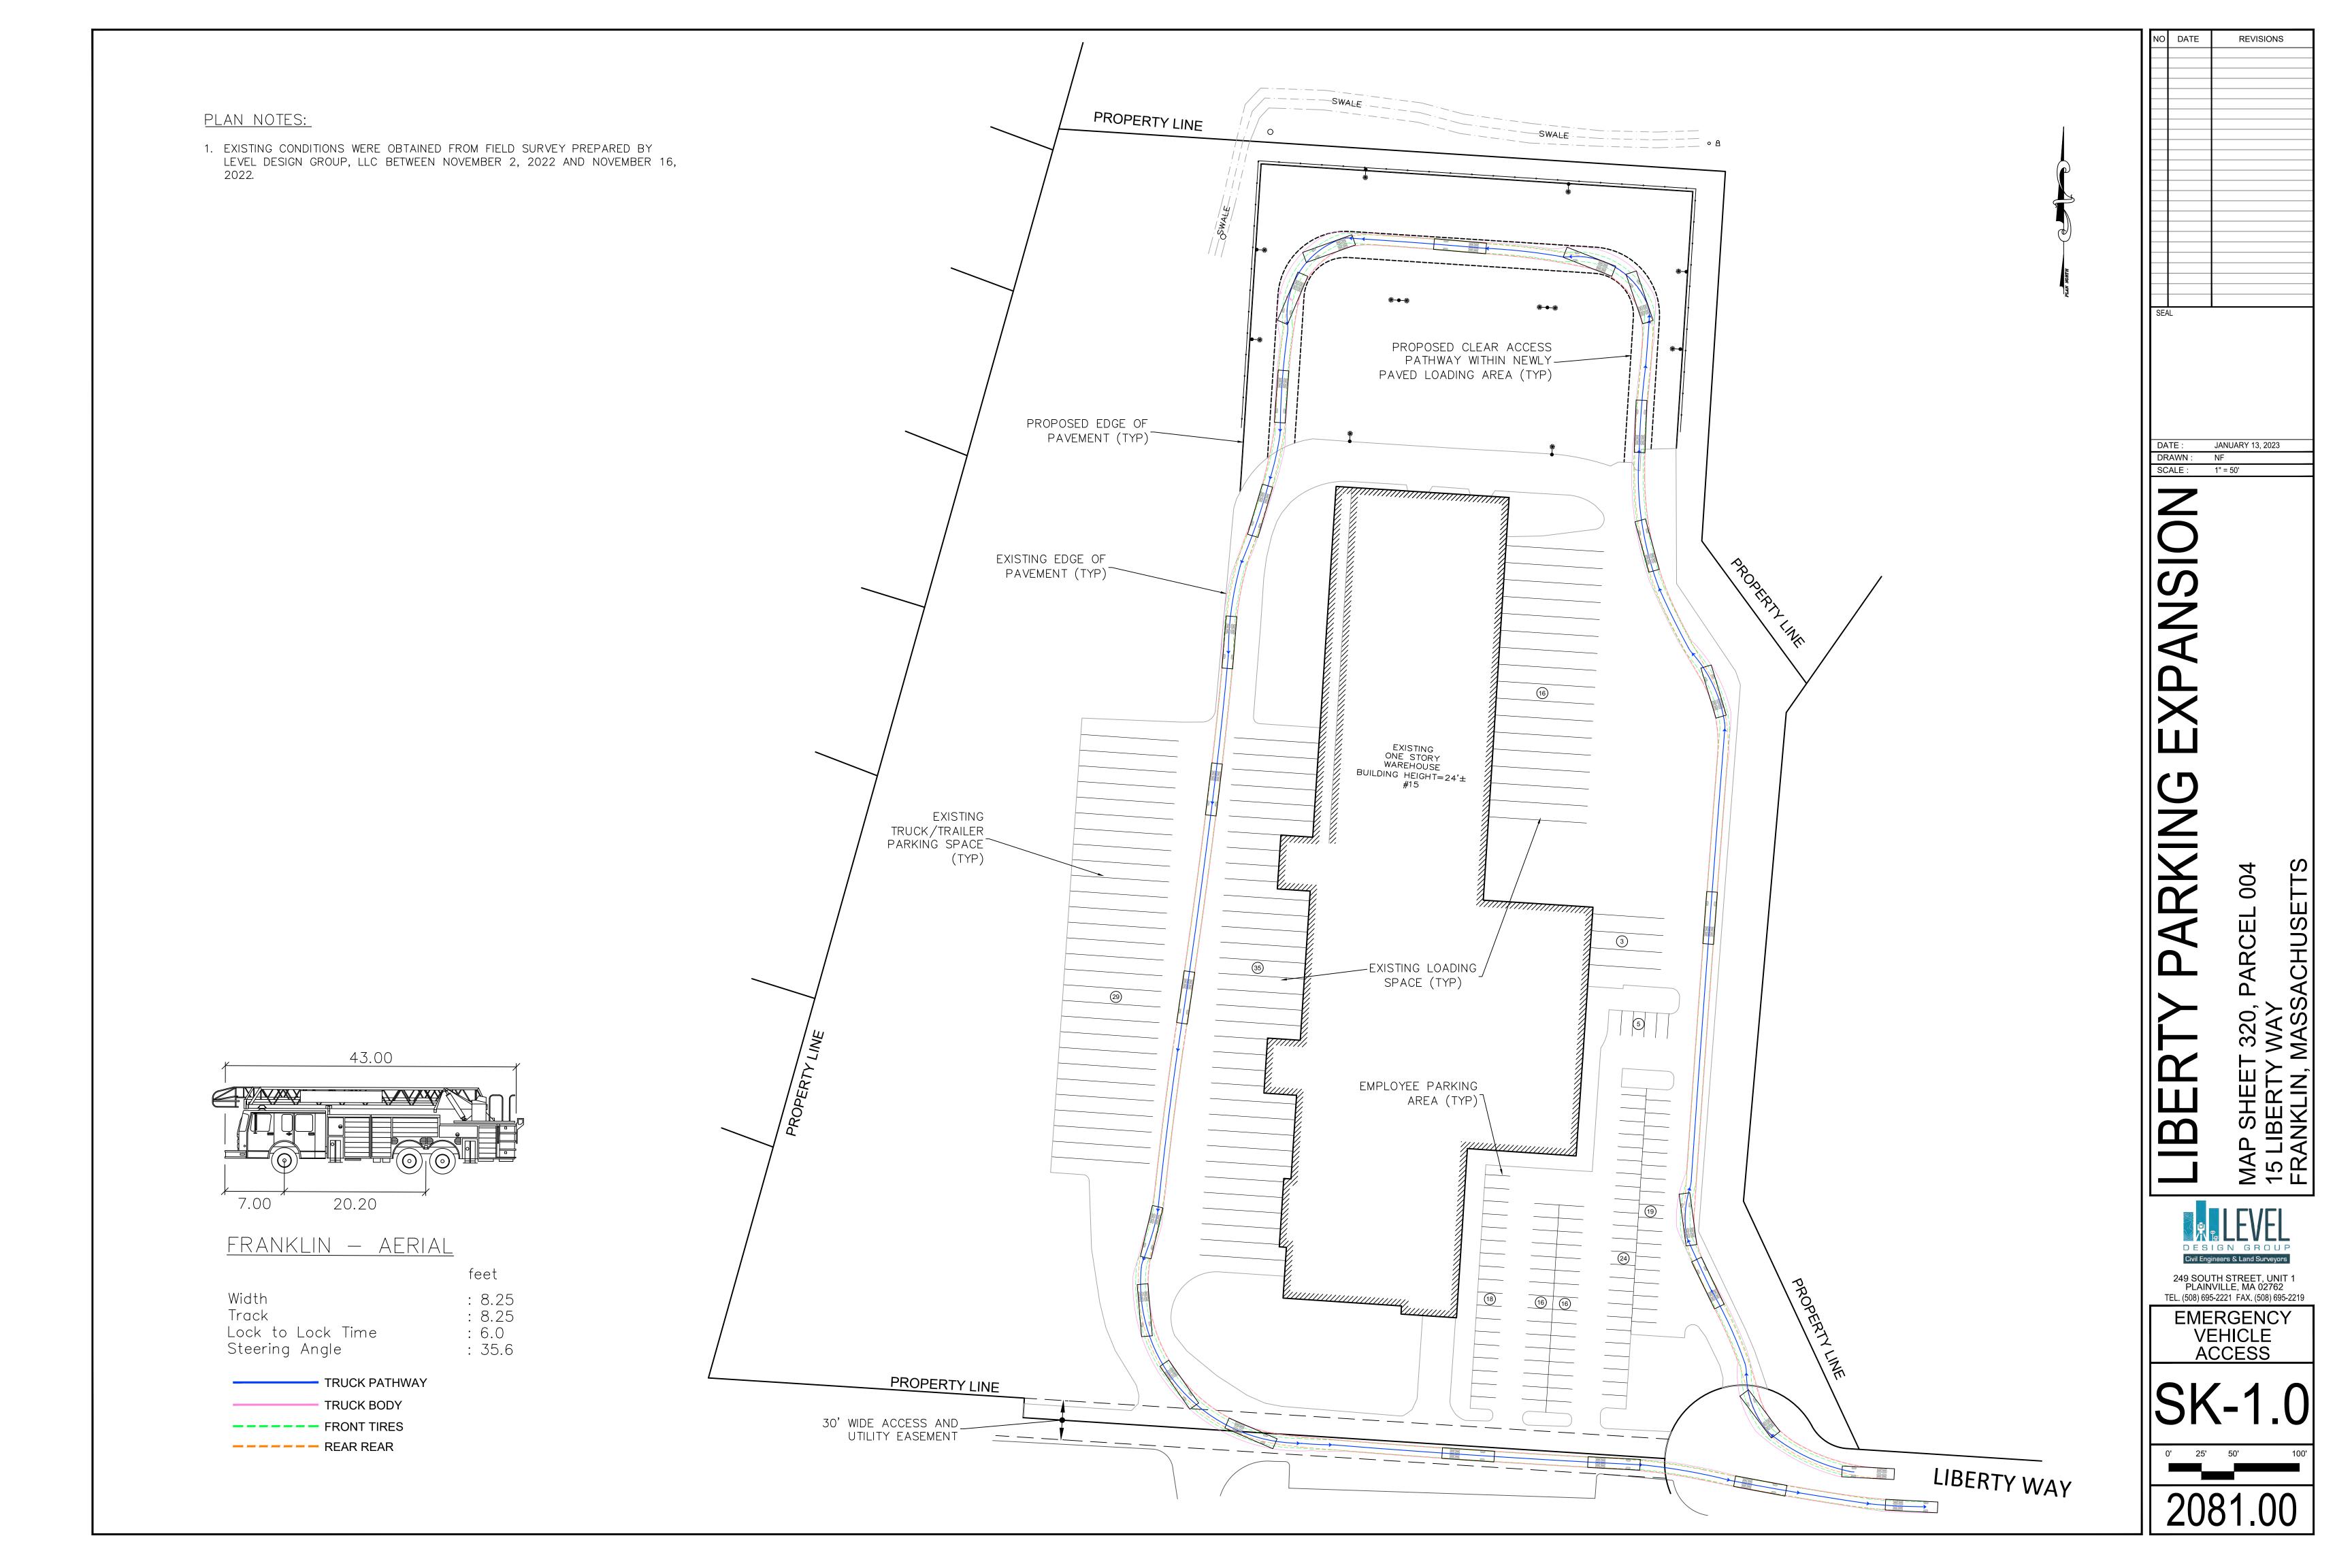


Statistics

Description Symbol Avg Max Min Max/Min Avg/Min

TRAILED BARKING X 1469 to 2946 to 0.05 to 58931 9381

Schedule									
Symbol	Label	QTY	Manufacturer	Catalog	Description	Number Lamps	Lamp Qutput	片	Input Power
Ċ	PI	8	PHILIPS GARDCO	ECF-L-8OL-IA-NW-G2- BLC	EcoForm Area LED ECF - Large, 80 4000K CCT, TYPE BLC OPTIC,	LED's,	24081	1	261.0493
ÇĐÇ	P2	2	SIGNIFY GARDCO	ECF-L-8OL-IA-NW-G2-4	EcoForm Area LED ECF - Large, 80 4000K CCT, TYPE 4 OPTIC, No Shie	LED' s , Id	33656	1	529.9496

ALL FIXTURES ARE SHOWN AT 18'-O" ABOVE FINISHED GRADE

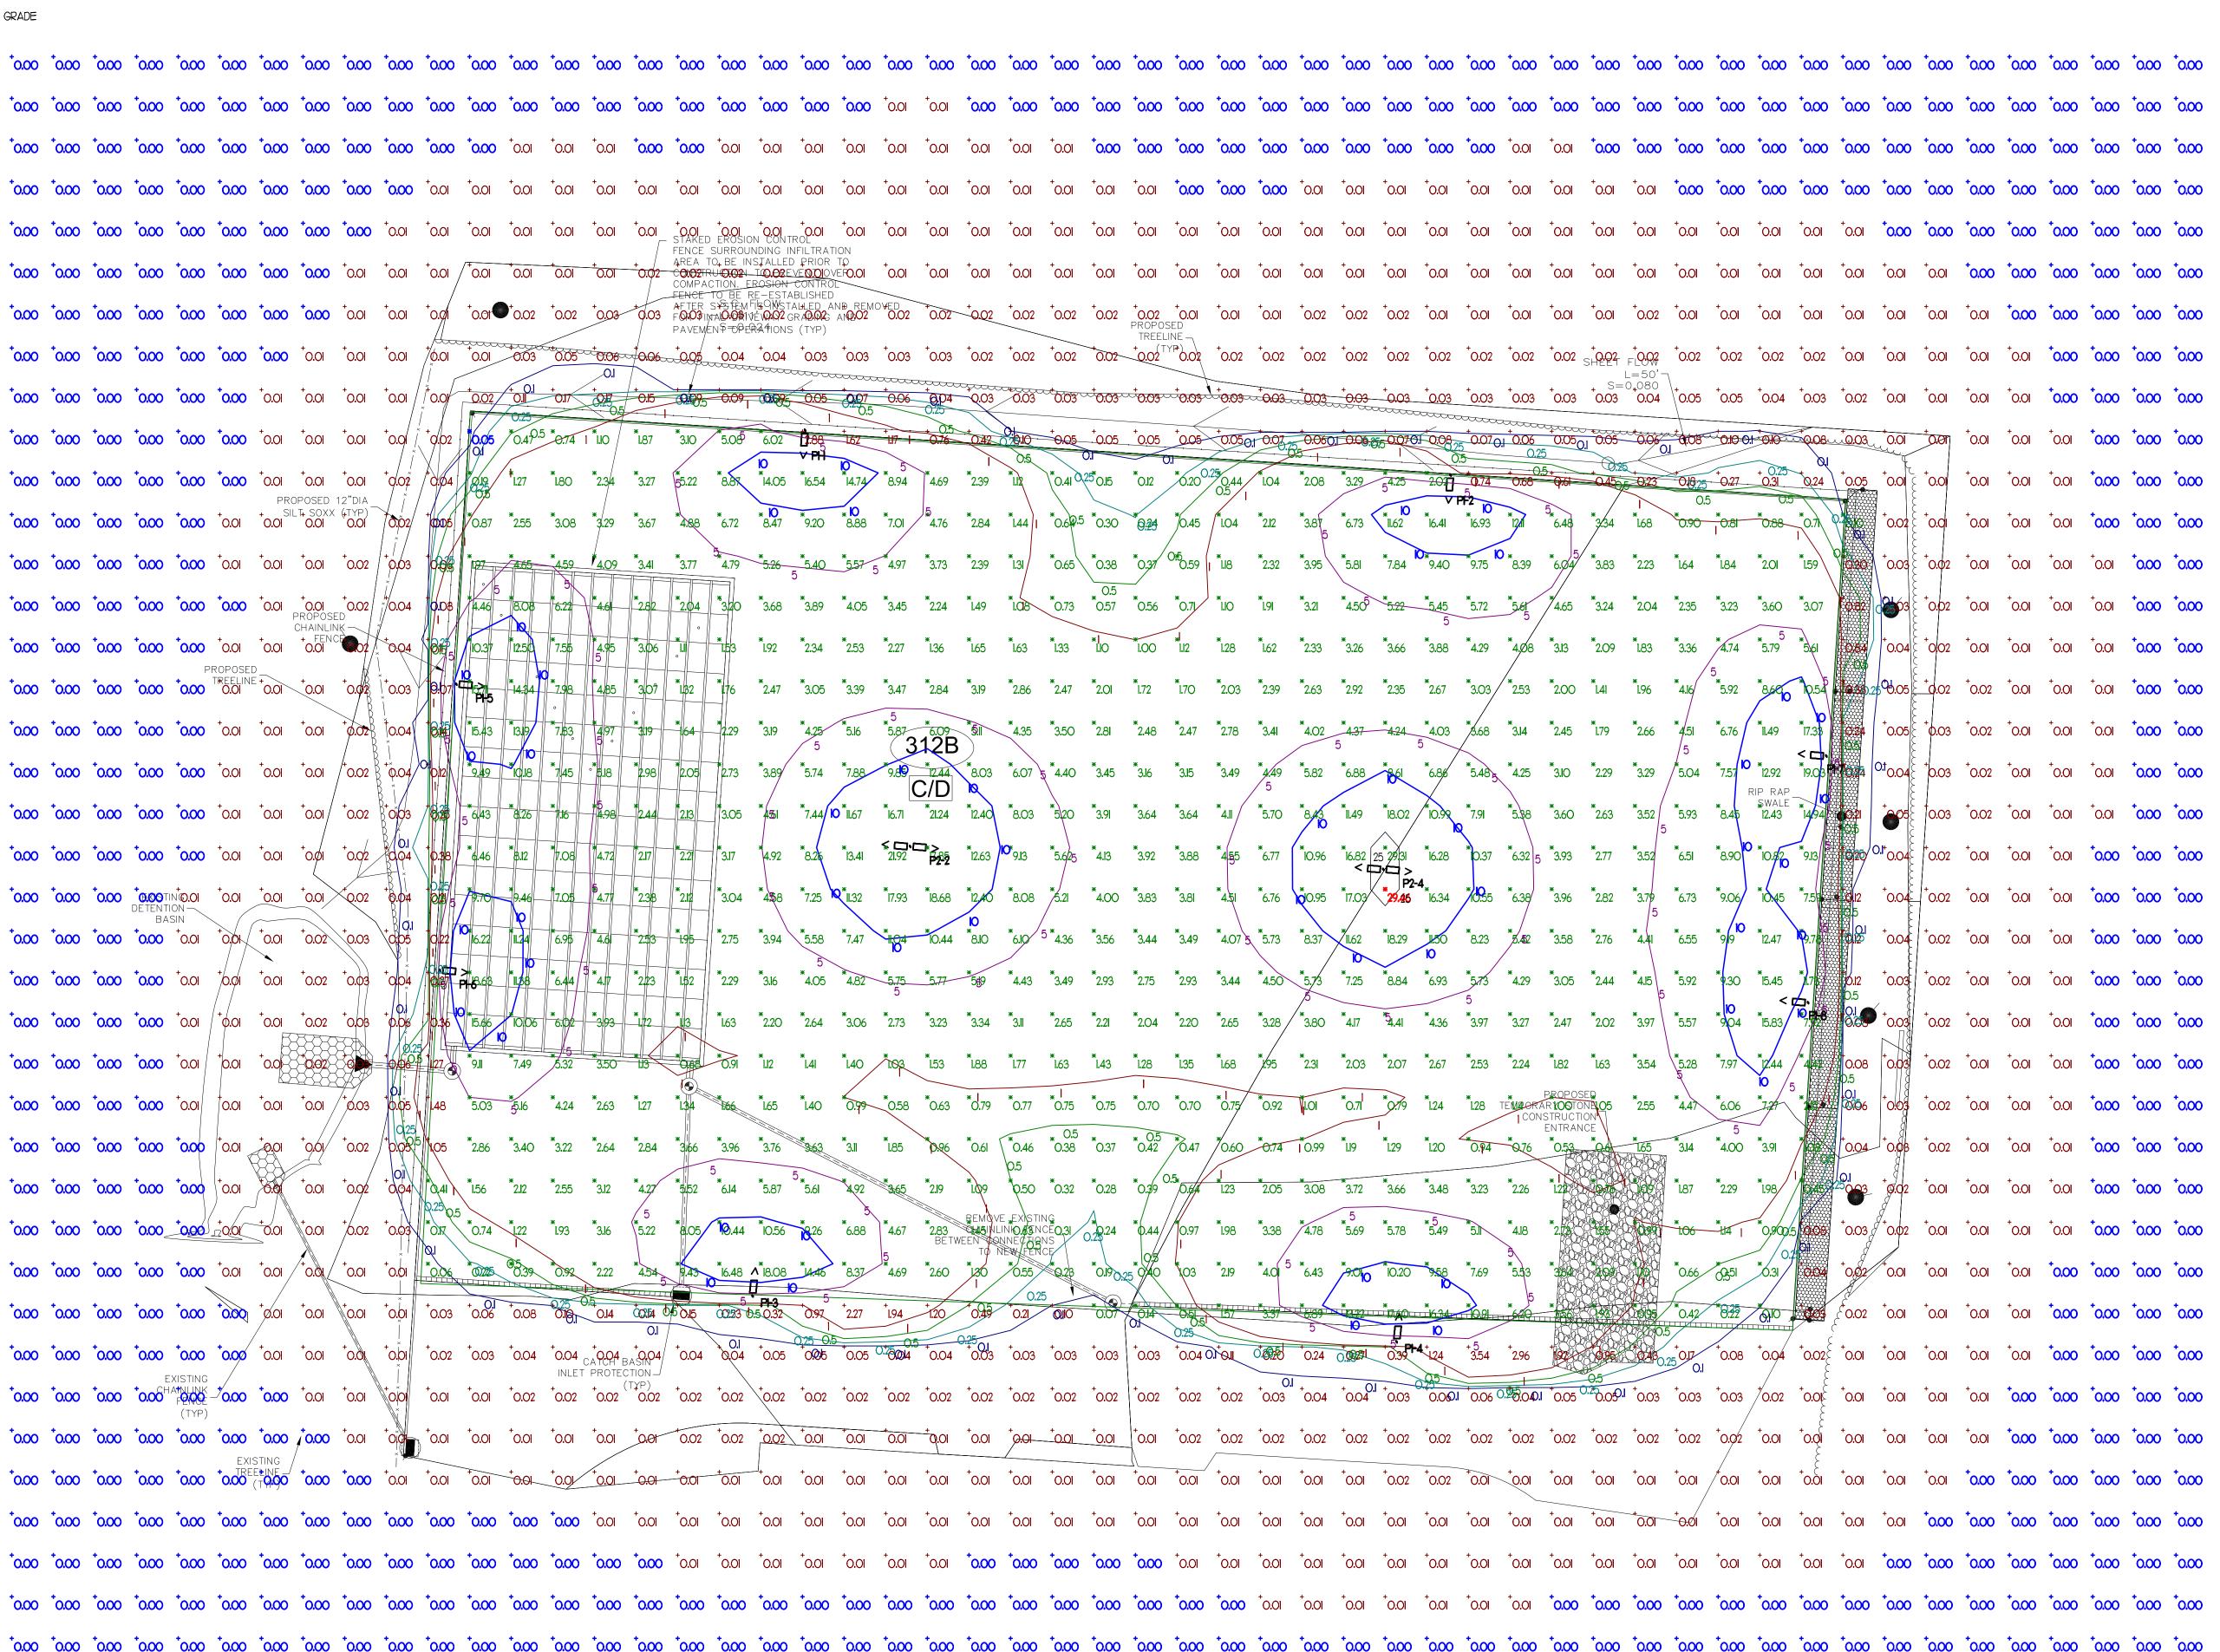



REVIS	SIONS:	
REV.:	DATE:	DESCRIPTION:

LEVEL DESIGN GROUP

249 SOUTH ST., UNIT 1 PLAINVILLE, MA 02762

OJECT:

LIBERTY PARKING EXPANSION

15 LIBERTY WAY FRANKLIN, MA

DRAWING TITLE

PHOTOMETRIC SITE LIGHTING


 DRAWN:
 CDO


 CHECKED:
 VAD Jr


 SCALE:
 1" = 20'-0"


 DATE:
 3/13/23

PH1.1

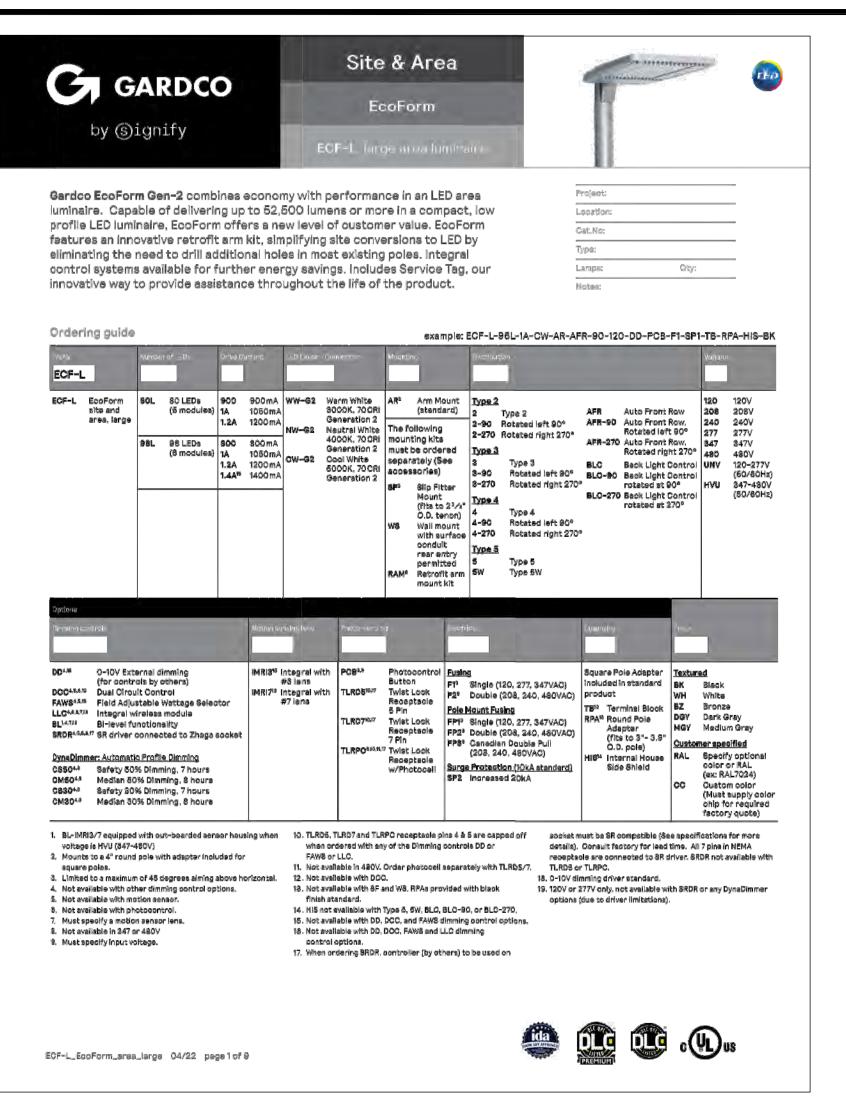

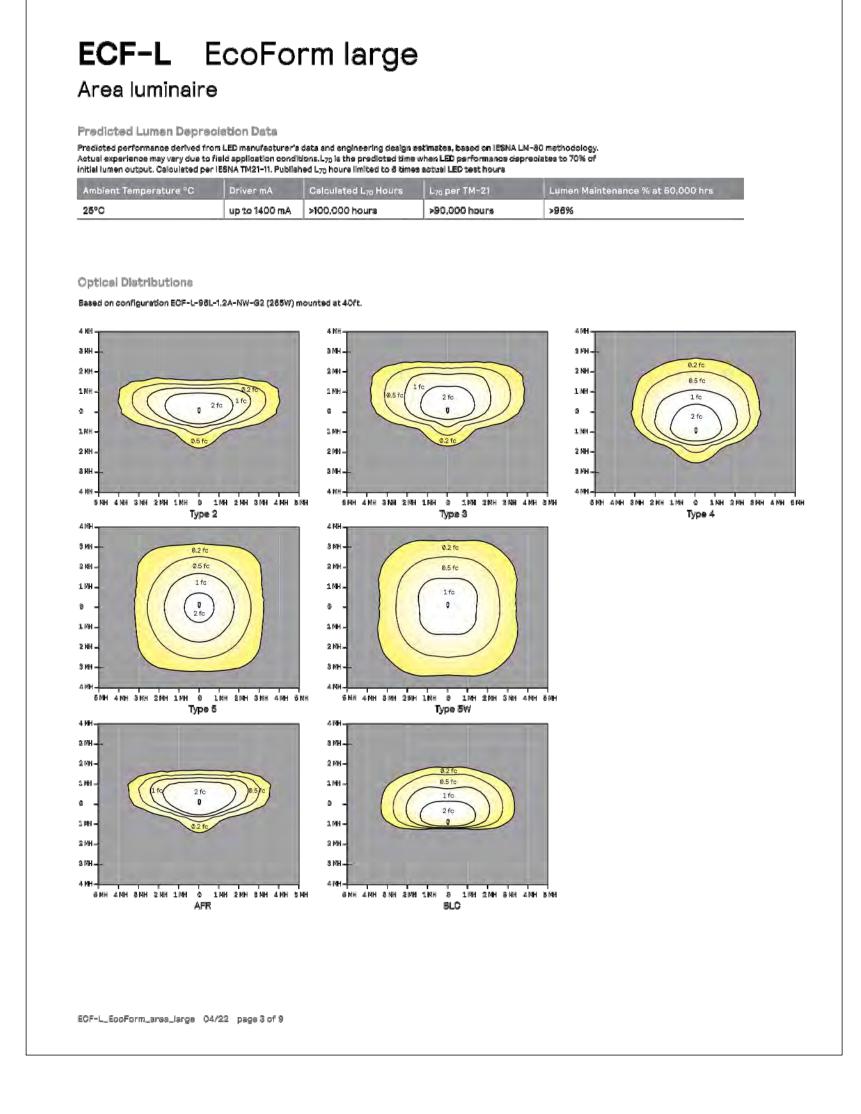

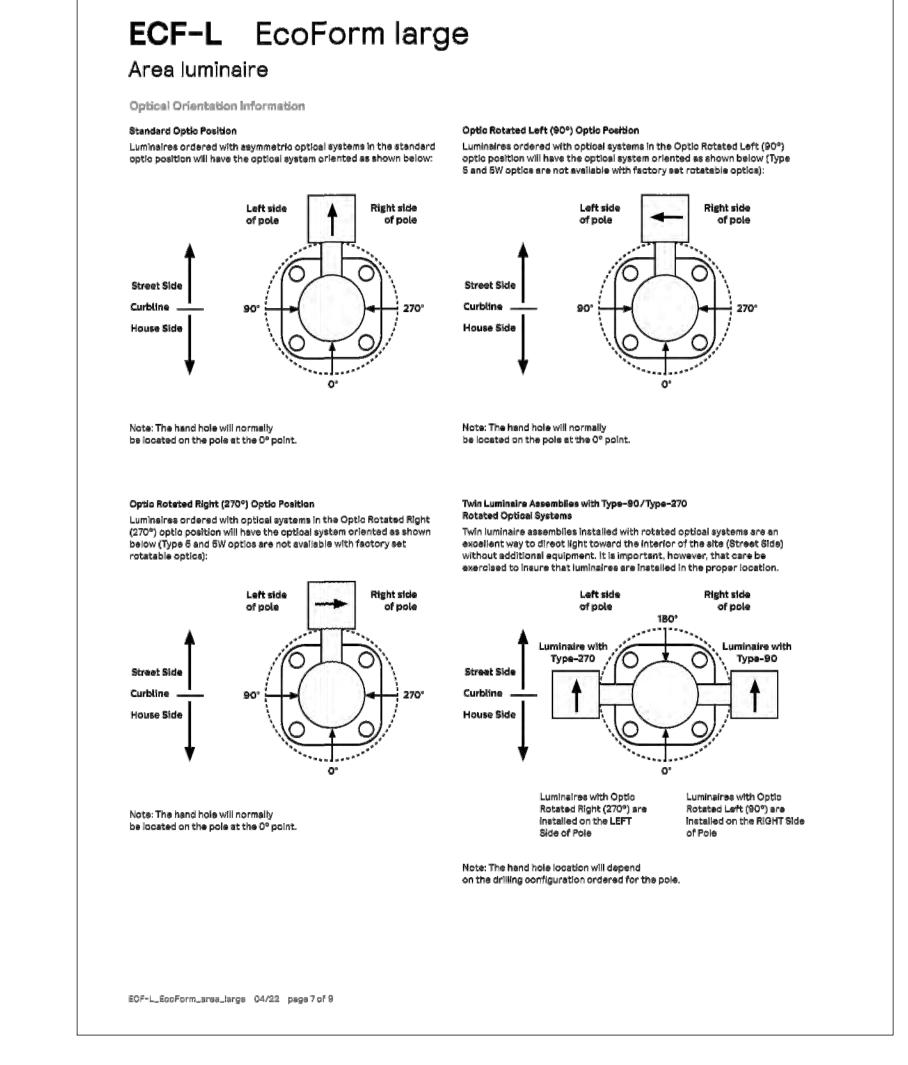

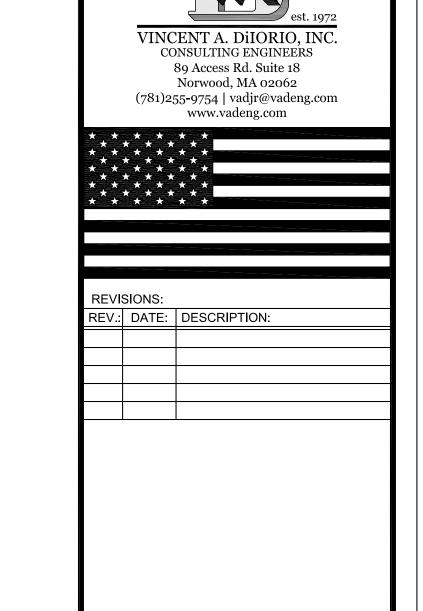

LEVEL DESIGN GROUP 249 SOUTH ST., UNIT 1

PLAINVILLE, MA 02762

LIBERTY PARKING EXPANSION

15 LIBERTY WAY FRANKLIN, MA

DRAWN:


DRAWING TITLE PHOTOMETRY

LIGHTING SPEC'S

CHECKED: VAD Ji SCALE: NOT TO SCALE DATE: 3/13/23

CDO

PH2.1

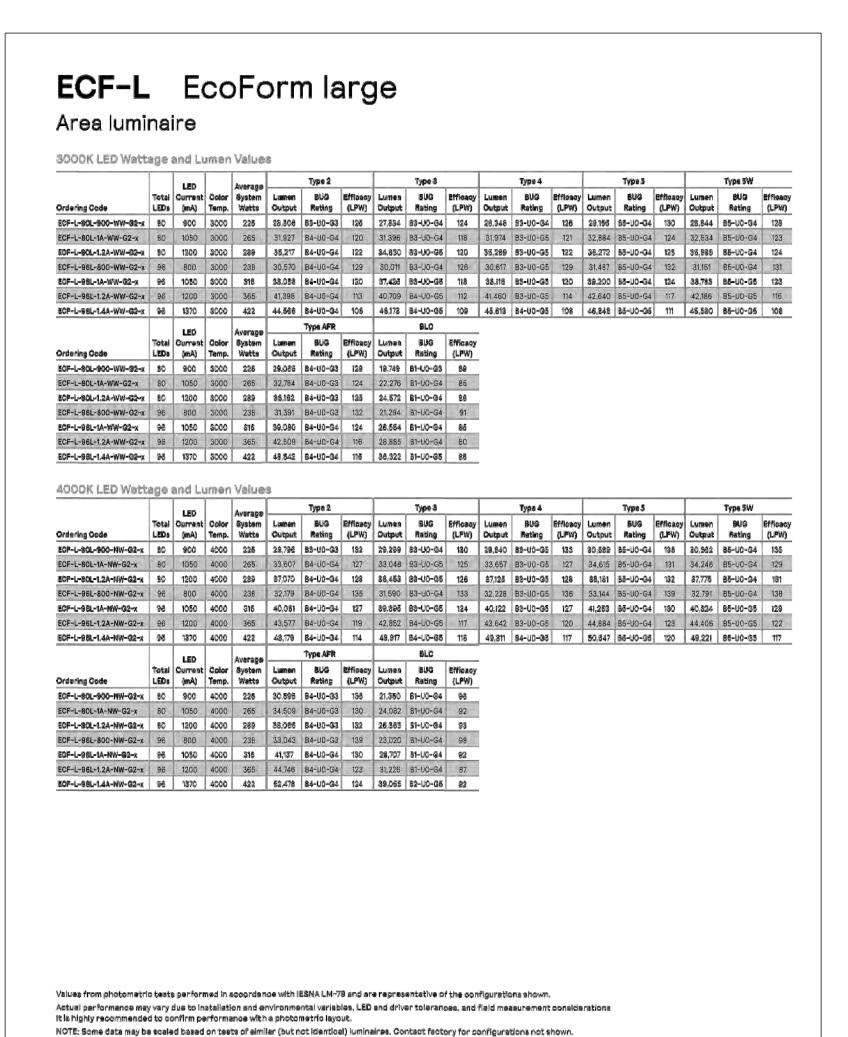

ECF-L_EcoForm_area_large 04/22 page 4 of 9

Plar	nt Schedule			Feb 5 2024
Sym. Trees	Botanical Name	Common Name	Qty.	Size, Comments
AG BN	Amelanchier 'Autumn Brilliance' Betula nigra 'Heritage'	Autumn Brilliance Serviceberry Heritage River Birch	10 3	8-10' B+B m/s 12-14' B+B, m/s
Shrub	S			
Ca	Clethra alnifolia	Summersweet	8	#10
Ci	Cornus alba 'Ivory Halo'	Red-twig Dogwood	10	2-3' B+B
Rs	Amelanchier alnifolia 'Regent'	Regent Serviceberry	12	#7
Tm	Taxus med. 'Densiformis'	Densiformis Yew	8	18-24"
Vd	Viburnum dentatum	Arrowwood Viburnum	14	2-3' B+B

General Planting Notes

1. All plants shall be the highest quality, heavy nursery-grown stock and sized according to Massachusetts Nurseryman's Association Standards. No substitutions will be permitted without the

prior approval of the Landscape Architect. 2. Topsoil for plant beds and pits shall be good quality sandy loam devoid of roots, clods, stones, rubbish, glass, brick, or asphalt. Soil should be between pH 6 and 7, and have good fertility and

3. Plant beds shall have a minimum soil depth of 10" unless otherwise specified and be mulched with 2-3" of finely shredded pine bark mulch. Groundcover area should have a 1 ½ - 2" mulch

4. All plant material shall be guaranteed for one full year from the completion of the installation. 5. All seeded and sodded areas shall have 6" of screened loam, spread and finely graded according to the plans. All areas indicated of the drawings and disturbed areas not otherwise indicated, shall receive 6" of loam previously stripped and stockpiled with the addition of 3" loam borrow tilled together and finely graded over all areas to receive seed. Loam borrow shall consist of friable soil typical of locally cultivated soils containing a minimum of 2% decayed organic matter, no clods, sticks and debris; and have a pH of 6 to 7. Test soil for acidity, fertility and texture by a reputable soils testing lab. Amend soil with lime and fertilizers accordingly. Rake until surface is smooth, friable, and uniform in texture to the elevations indicated on the drawings. Seed evenly at a rate of 5 lbs. per 1000 square feet or according to the manufacturers instructions. Lay sod with hand-tight joints. Irrigate immediately and as necessary to provide one inch of water per week while the seed germinates and sod takes root until the grass is thoroughly established.

General Planting Notes


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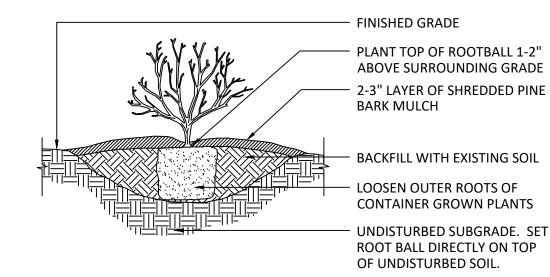
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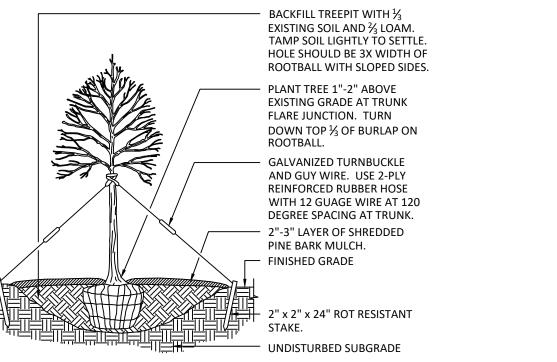
PLAN NOTES:

- 1. EXISTING CONDITIONS WERE OBTAINED FROM FIELD SURVEY PREPARED BY LEVEL DESIGN GROUP, LLC BETWEEN NOVEMBER 2, 2022 AND NOVEMBER 16, 2022. SOIL TESTING COMPLETED BY ADAM P. HUNT ON NOVEMBER 16,
- 2. THE LOCATION OF EXISTING UTILITIES IS APPROXIMATE, THE CONTRACTOR SHALL VERIFY THE LOCATION OF ALL UTILITIES IN THE FIELD PRIOR TO THE START OF CONSTRUCTION. NOTIFY "DIG-SAFE" AT 1-888-344-7233 AT LEAST 72 HOURS PRIOR TO ANY SITE DEMOLITION OR EXCAVATION.
- 3. CONTRACTOR SHALL NOTIFY ENGINEER OF ANY DISCREPANCIES IN THE DESIGN PLANS PRIOR TO THE START OF CONSTRUCTION.
- 4. ALL DISTURBED AREAS NOT RECEIVING IMPROVEMENTS SHALL BE LOAMED AND SEEDED.
- 5. THE SITE IS NOT LOCATED WITHIN A ZONE II WATER RESOURCE DISTRICT.
- 6. THE SITE IS NOT LOCATED WITHIN A FLOOD PLAIN DISTRICT. CONSTRUCTION NOTES:
- 1. THE LOCATION OF EXISTING UTILITIES IS APPROXIMATE, THE CONTRACTOR SHALL VERIFY THE LOCATION OF ALL UTILITIES IN THE FIELD PRIOR TO THE START OF CONSTRUCTION. NOTIFY "DIG-SAFE" AT 1-888-344-7233 AT LEAST 72 HOURS PRIOR TO ANY SITE DEMOLITION OR EXCAVATION.
- 2. CONTRACTOR SHALL NOTIFY ENGINEER OF ANY DISCREPANCIES IN THE DESIGN PLANS PRIOR TO THE START OF CONSTRUCTION.
- 3. ALL EXISTING PAVEMENT SHALL BE SAWCUT PRIOR TO REMOVAL.
- 4. ALL EXISTING PAVEMENT, CURB, WALKS, UTILITIES, LIGHT POLES, TREES, SHRUBS, ETC., SHALL BE REMOVED FROM THE AREAS TO BE DEVELOPED. ALL SUCH ITEMS NOT WITHIN THE WORK AREA SHALL BE PROTECTED AND UNDISTURBED.
- 5. ALL DISTURBED AREAS NOT RECEIVING IMPROVEMENTS SHALL BE LOAMED AND SEEDED.
- 6. ALL CONSTRUCTION AND CONSTRUCTION ACTIVITIES SHALL CONFORM TO STATE AND LOCAL REQUIREMENTS. INCLUDING BUT NOT LIMITED TO THE TOWN OF FRANKLIN, THE COMMONWEALTH OF MASSACHUSETTS AND ANY OTHER AGENCIES HAVING JURISDICTION.
- 7. MATERIAL TO BE EXPORTED FROM THE SITE WILL BE LIMITED TO TOPSOIL IN AREAS TO BE PAVED AND ANY DELETERIOUS MATERIAL ENCOUNTERED DURING EXCAVATION. MATERIAL TO BE EXPORTED WILL BE LIMITED TO GRAVEL BASE AND SEPTIC AGGREGATE.
- SITE PLAN NOTES:
- 1. THIS PLAN SET HAS BEEN ISSUED FOR PERMITTING ONLY. A FULL CONSTRUCTION PLAN SET SHALL BE ISSUED ONCE ALL LOCAL, STATE, AND FEDERAL PERMIT APPROVALS HAVE BEEN GRANTED.






SHRUB PLANTING DETAIL

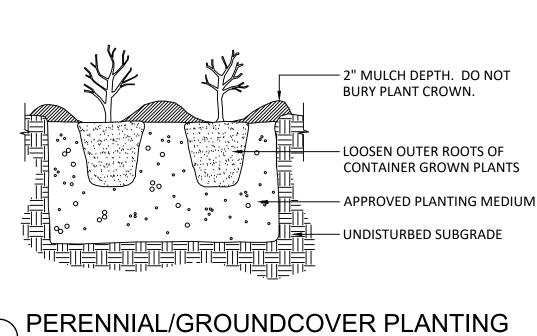

FES

FES

TREE PLANTING DETAIL

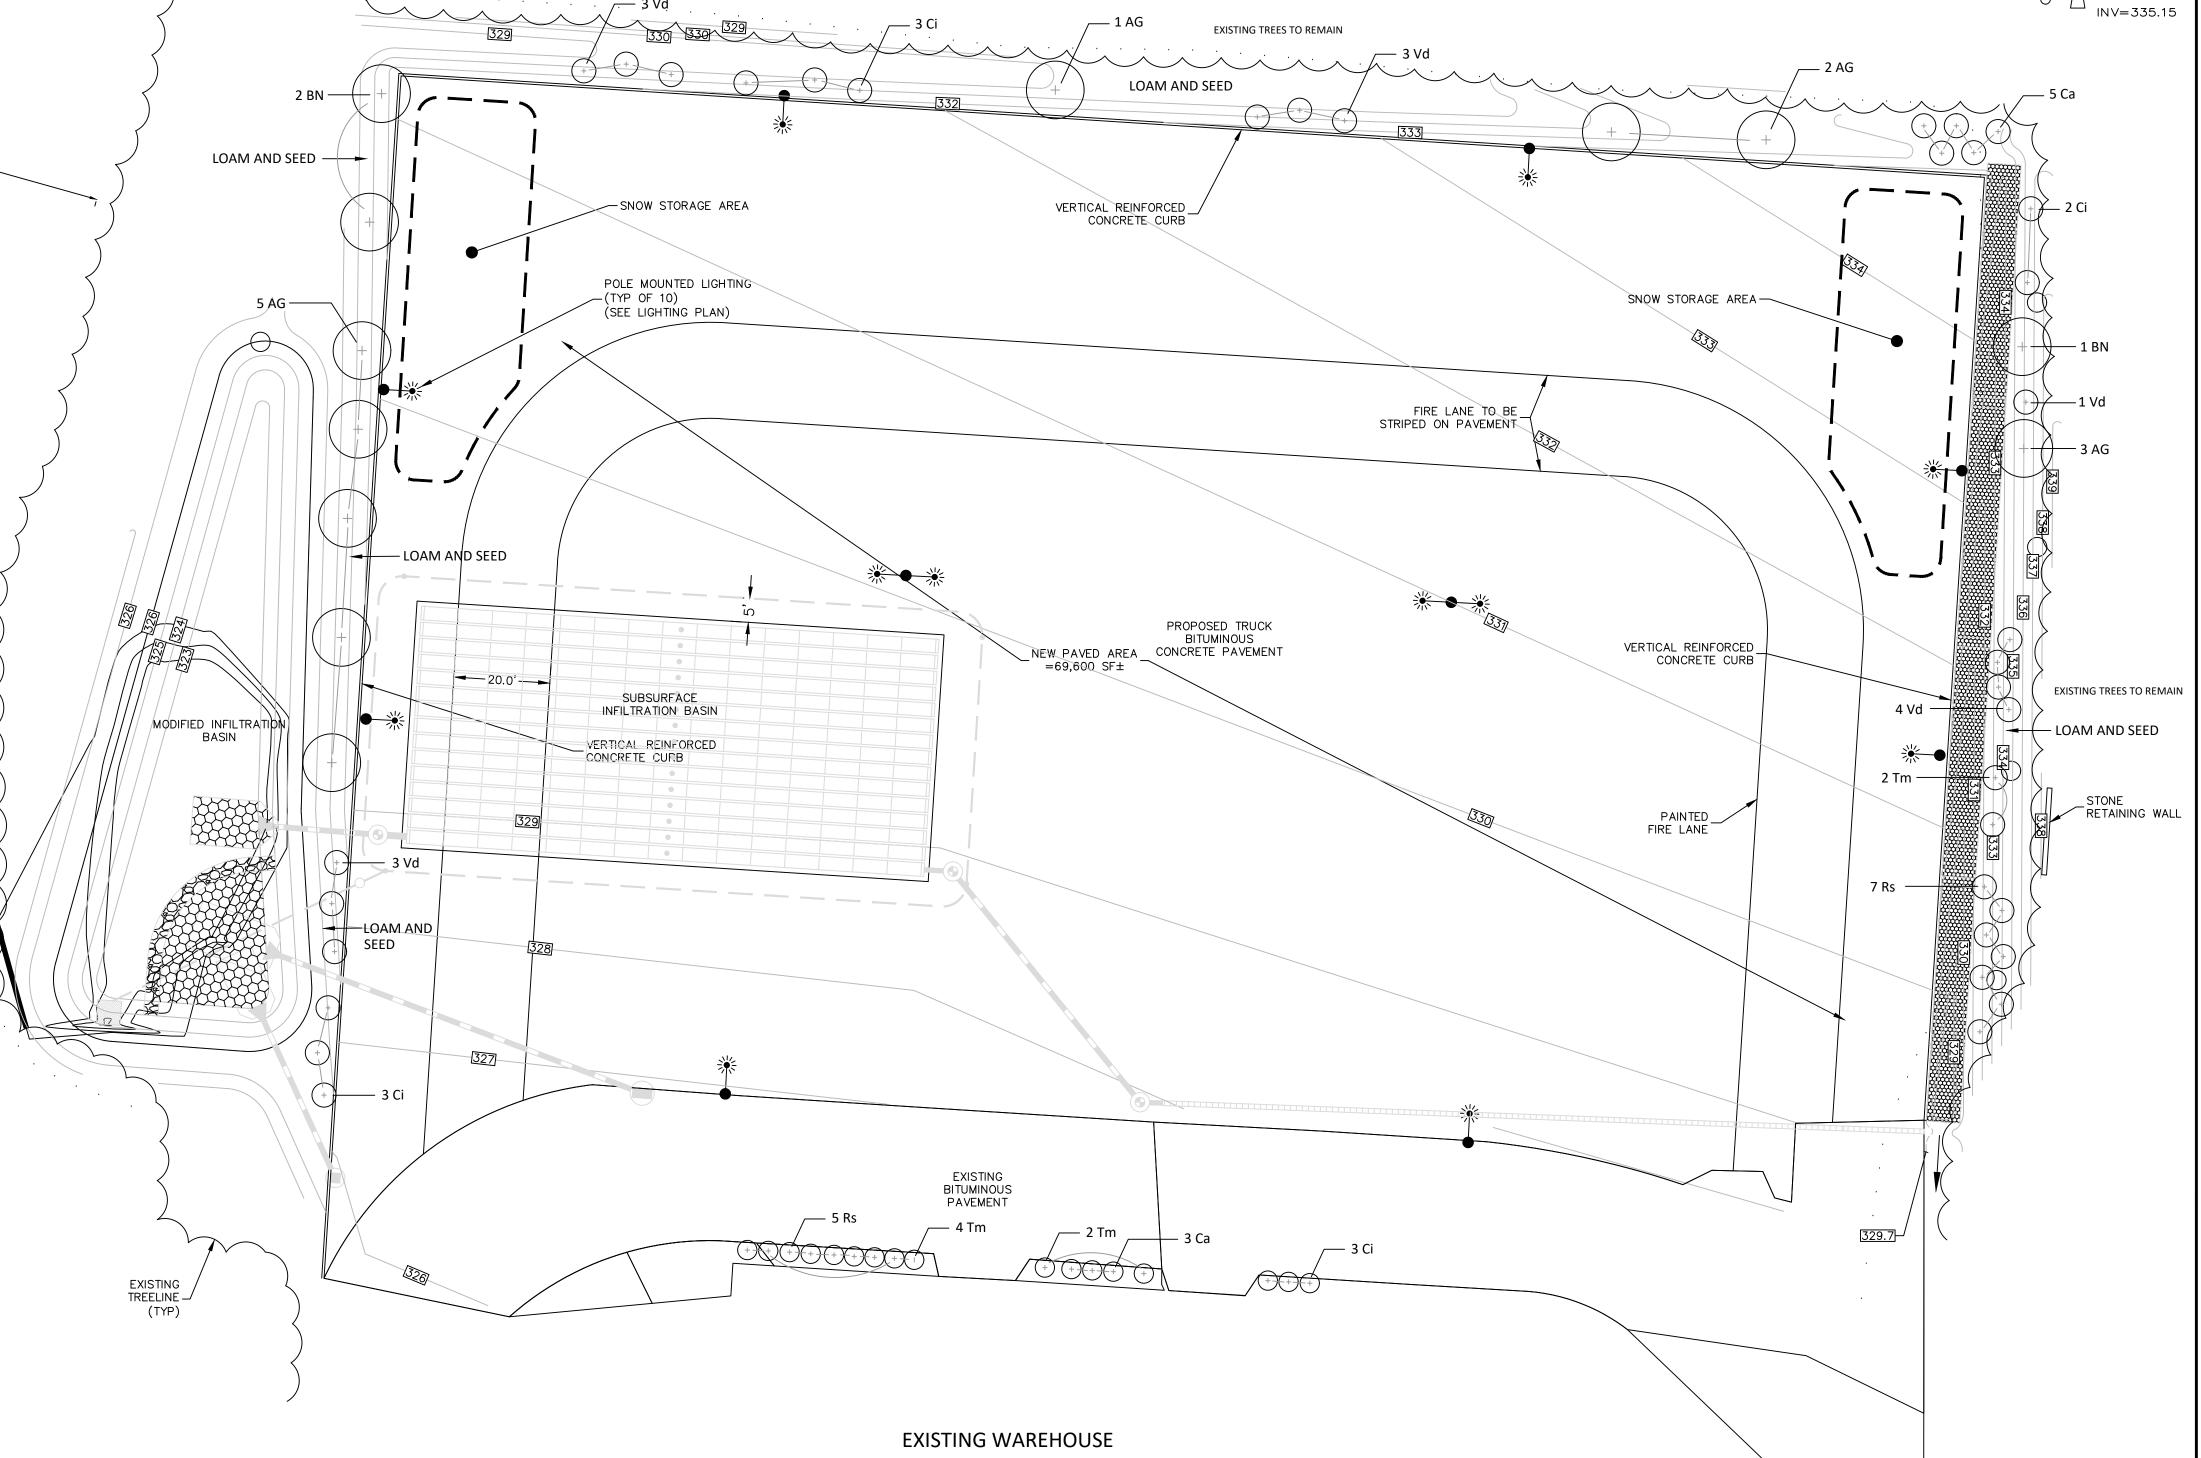

IRRIGATION NOTES

1. The Landscape Contractor shall provide a drip irrigation system for all planted islands.

2. The Landscape Contractor shall submit an irrigation plan with zone boxes, valve boxes, clock, and backflow preventer locations to the Owner. 3. Once the irrigation system has been installed, the Landscape Contractor shall provide an as-built plan to the Owner with all irrigation equipment shown on the plan, including sub-surface sleeves,

conduit and valve boxes.

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ELLIOTT BRUNDAGE

978 470 4970

elliottbrundage.com

LANDSCAPE ARCHITECTURE

190 High Plain Road Andover MA

LANDSCAPE

PLAN

10' 20'

DATE:

DRAWN:

SCALE :

FEB 5 2024

1" = 20'

REVISIONS