# SITE PLAN 175 EAST CENTRAL STREET FRANKLIN MASSACHUSETTS



# ZONING:

THE FRANKLIN FORD SITE IS LOCATED WITHIN A COMMERCIAL II ZONE.

R	EQUIREMENTS:	EXISTING	PROPOSED
INDUSTRIAL ZONE			
AREA:	40,000 S.F.	226,697± S.F.	226,697± S.F.
FRONTAGE:	175'	243.21	243.21
DEPTH:	200'	759'±	759'±
HEIGHT: 3	STORIES 40'	21.1'	21.1' - 1 STORY
WIDTH:	157.5'	> 157.5'	> 157.5'
COVERAGE -			
STRUCTURES:	70%	12.1%	15.6%
STRUC. & PAVING	: 80%	66.6%	76.3%
SETBACKS-			
FRONT:	40'	55.9'	55.9'
RIGHT SIDE:	30'	54.1'	37.2'
LEFT SIDE	30"	20'	20'
REAR:	30'	37.8'	37.8'

LOT COVERAGE CALCULATION AREA BASED ON UPLAND AREA

THE ENTIRE PROPERTY IS LOCATED WITHIN A FRANKLIN WATER RESOURCE DISTRICT AND A DEP ZONE II.
THE SITE AREA PROPOSED FOR DEVELOPMENT IS LOCATED IN A ZONE X BASED ON FEMA FIRM MAP 25021C0309E
DATED JULY 17, 2012.

AREA WITHIN THE WATER RESOURCE DISTRICT — 226,697± SQ. FT. UPLAND AREA WITHIN THE WATER RESOURCE DISTRICT — 177,773± SQ. FT. IMPERVIOUS AREA WITHIN THE WATER RESOURCE DISTRICT — 135,580± SQ. FT. COVERAGE WITHIN THE WATER RESOURCE DISTRICT — = 76.3%

FRANKLIN FORD:

BUILDING USE - AUTOMOBILE DEALERSHIP.

REFERENCES:
ASSESSORS MAP 285 PARCEL 090-000-000
DEED BOOK 28674 PAGE 487
ASSESSORS MAP 285 PARCEL 092-000-000
DEED BOOK 3788 PAGE 197
PLAN 826 OF 1997
LIMITED SITE PLAN FRANKLIN FORD, LLC DATED SEPTEMBER 11, 2013 AND ENDORSED ON OCTOBER 21, 2013.

# DRAWING INDEX:

1. COVER SHEET

2. EXISTING CONDITIONS PLAN

3. SITE LAYOUT PLAN

4. SITE GRADING AND UTILITY PLAN

5. SITE GRADING AND UTILITY PLAN RE-DEVELOPMENT AREA

6. SITE PLANTING PLAN

7. EROSION CONTROL PLAN

8. CONSTRUCTION DETAILS - 1

9. CONSTRUCTION DETAILS - 2 10. CONSTRUCTION DETAILS - 3

SITE LIGHTING-LIGHTING PLAN, PHOTOMETRICS AND SCHEDULES

BY SK & ASSOCIATES

OWNERS:
MAP 285 PARCEL 090-000-000
FRANKLIN FORD, LLC
175 EAST CENTRAL STREET
FRANKLIN, MASSACHUSETTS

MAP 285 PARCEL 092-000-000 HERBERT CATALANO 9 CHESTNUT STREET FRANKLIN, MASSACHUSETTS

APPLICANT: FRANKLIN FORD, LLC 175 EAST CENTRAL STREET FRANKLIN, MASSACHUSETTS

SITE PLAN
COVER SHEET
175 EAST CENTRAL STREET
FRANKLIN, MASSACHUSETTS
PREPARED FOR
FRANKLIN FORD, LLC
175 EAST CENTRAL STREET
FRANKLIN, MASSACHUSETTS
APRIL 14, 2022

SCALE: 1'' = 40'

1. TO ALLOW LESS THAN 42" OF COVER OVER THE RCP DRAIN PIPE. PROPOSED CLASS V RCP.
2. TO ALLOW THE USE OF HDPE PIPE FOR THE, ROOF DRAIN MANIFOLDS AND POND 1.
3. TO ALLOW MINIMAL LIGHT SPILLAGE ONTO THE CHESTNUT STREET RIGHT OF WAY.

WAIVER REQUESTED:

SITE PLAN APPROVAL REQUIRED FRANKLIN PLANNING BOARD

DATE

GRAPHIC SCALE

100 0 50 100 200 400

( IN FEET )
1 inch = 100 ft.


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				CARLOS A. QUINTAI CIVIL No. 30812
2	9/12/22	BETA REVIEW COMMENTS	RRG	
1	8/4/22	REVIEW COMMENTS	RRG	Melon Would 9/15/2-4
NO.	DATE	DESCRIPTION	BY	CARLOS A. QUINTAL P.E. #30812 4


DATE	T	INT.
8/21	FIELD BY:	BL
BK#	FIELD BOOK	PG#
4/22	CALCS BY:	RRG
4/22	DESIGNED BY:	RRG
-4/22	DRAWN BY:	COMP
4/22	CHECKED BY:	CAQ


UNITED CONSULTANTS INC.


850 FRANKLIN STREET SUITE 11D WRENTHAM, MASSACHUSETTS 02093 508-384-6560 FAX 508-384-6566 1" = 200'
PROJECT
UC1007
SHEET
1 of 10

APRIL 14, 2022

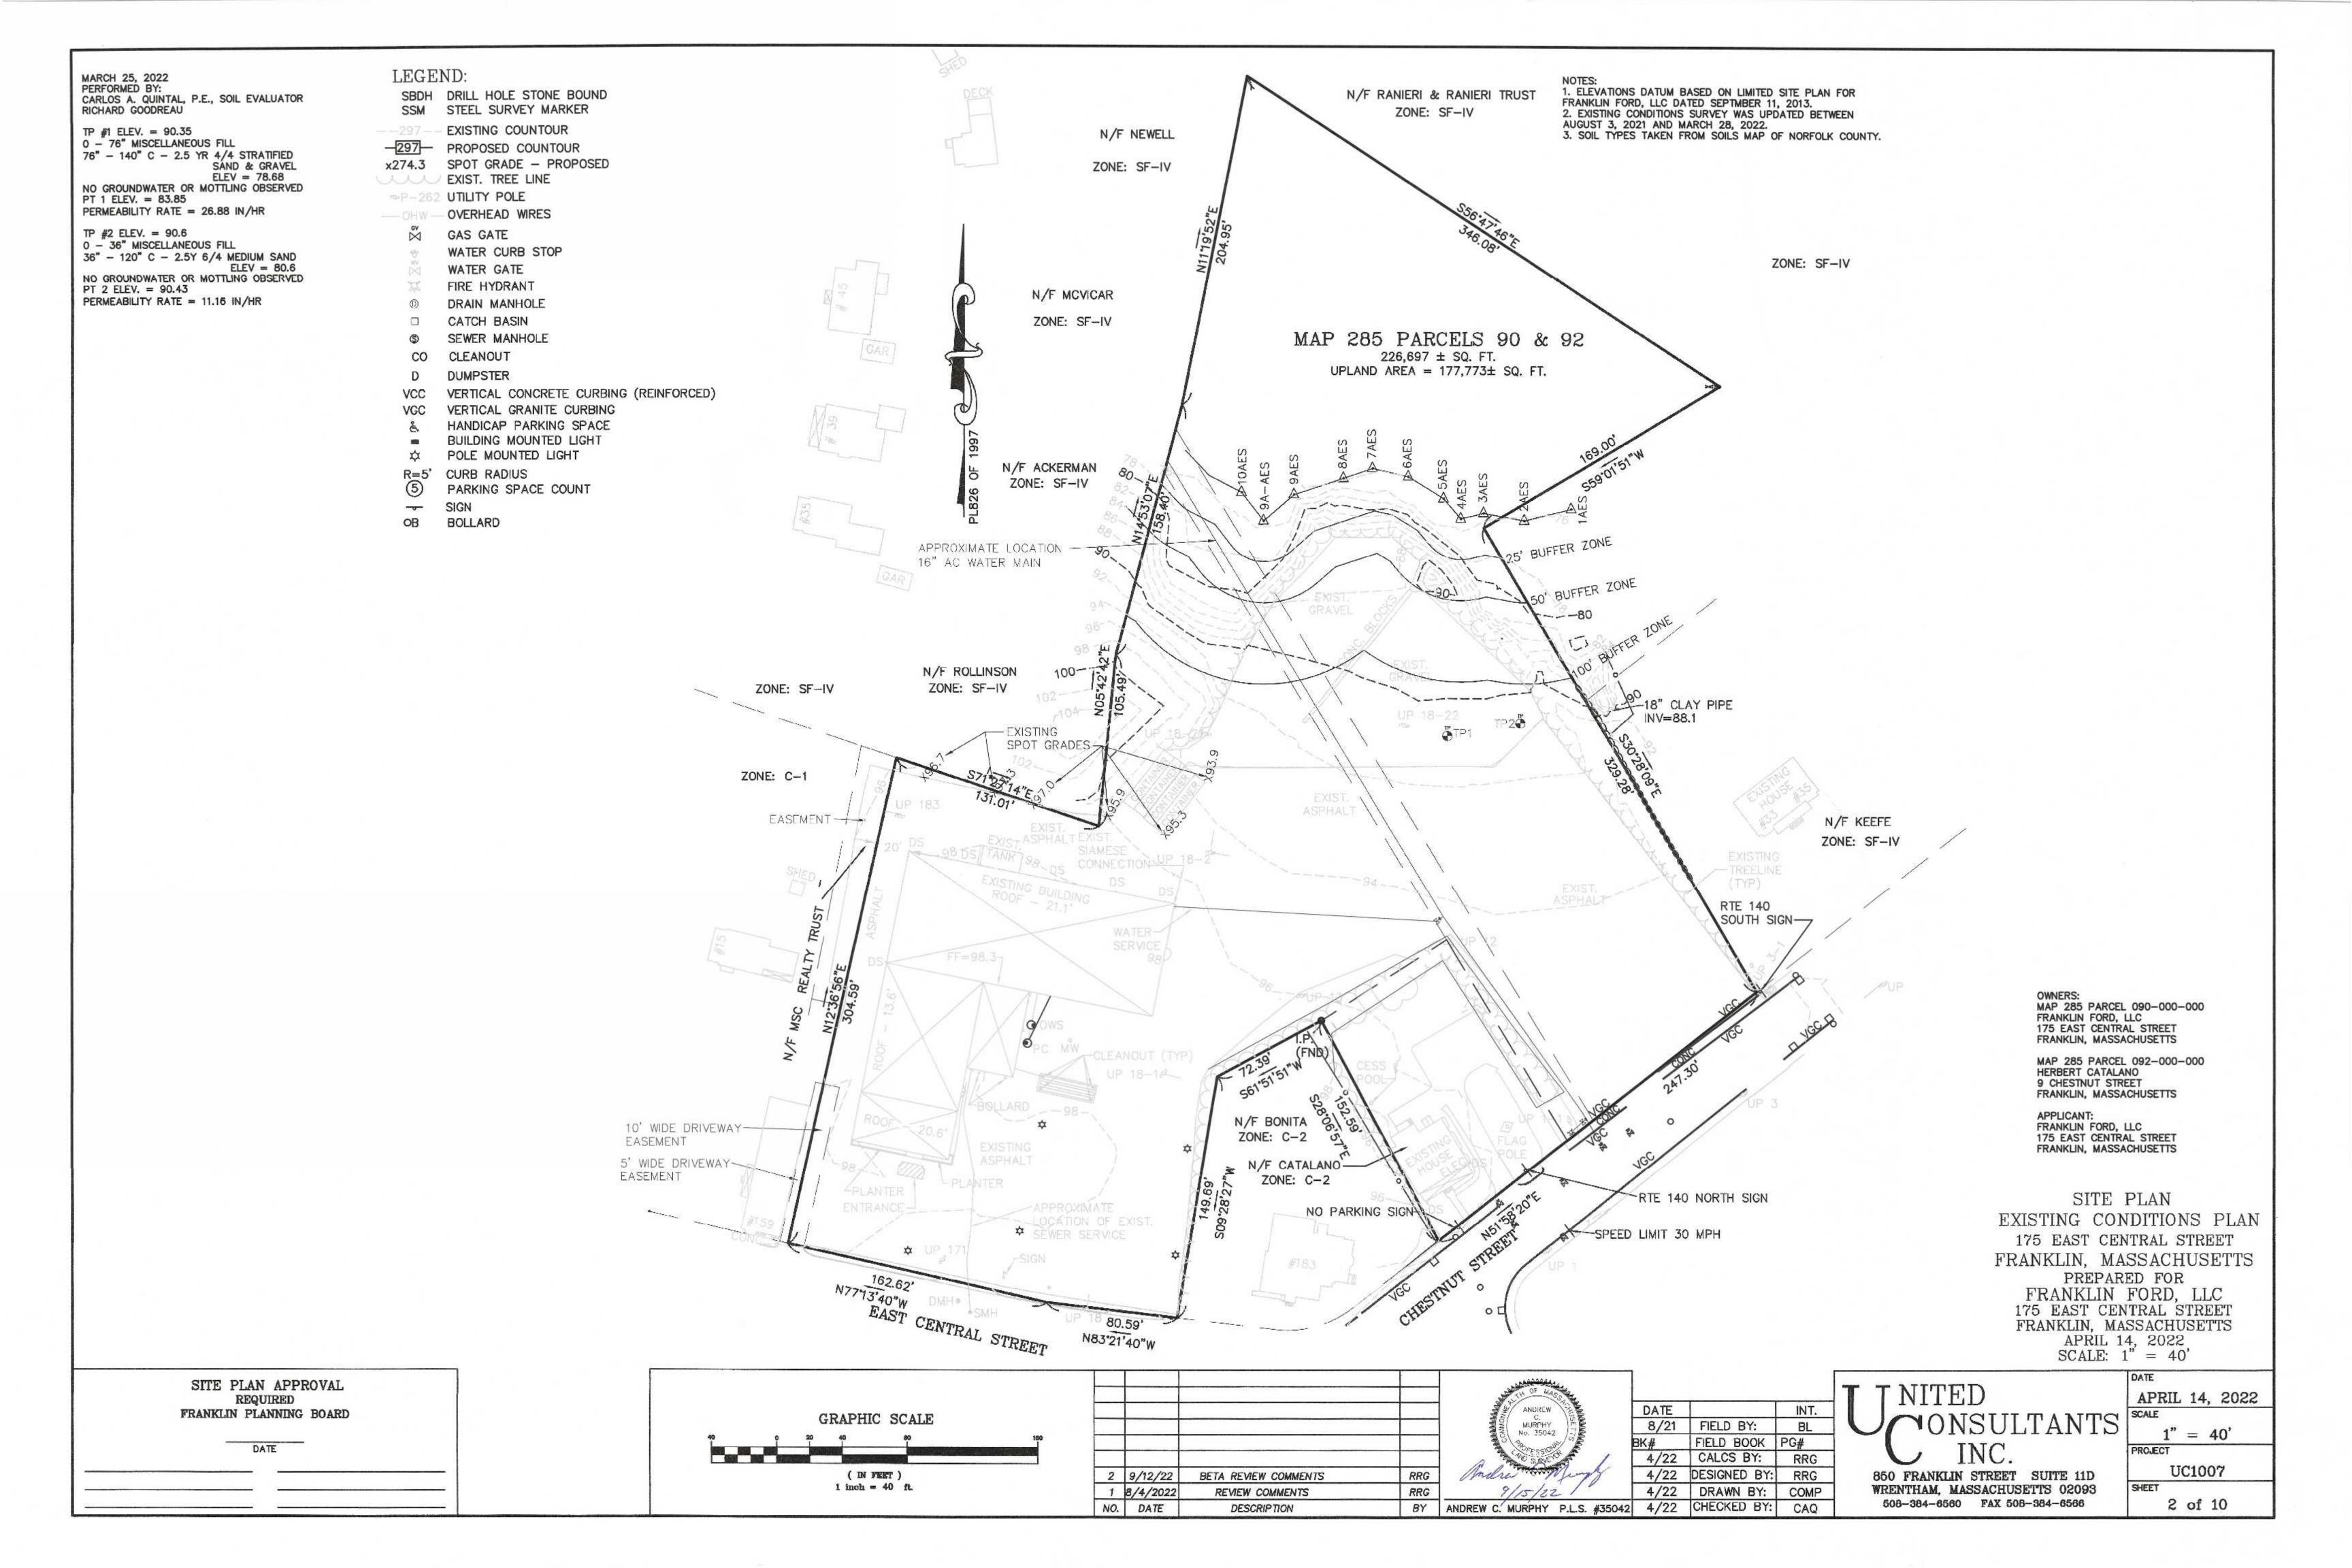

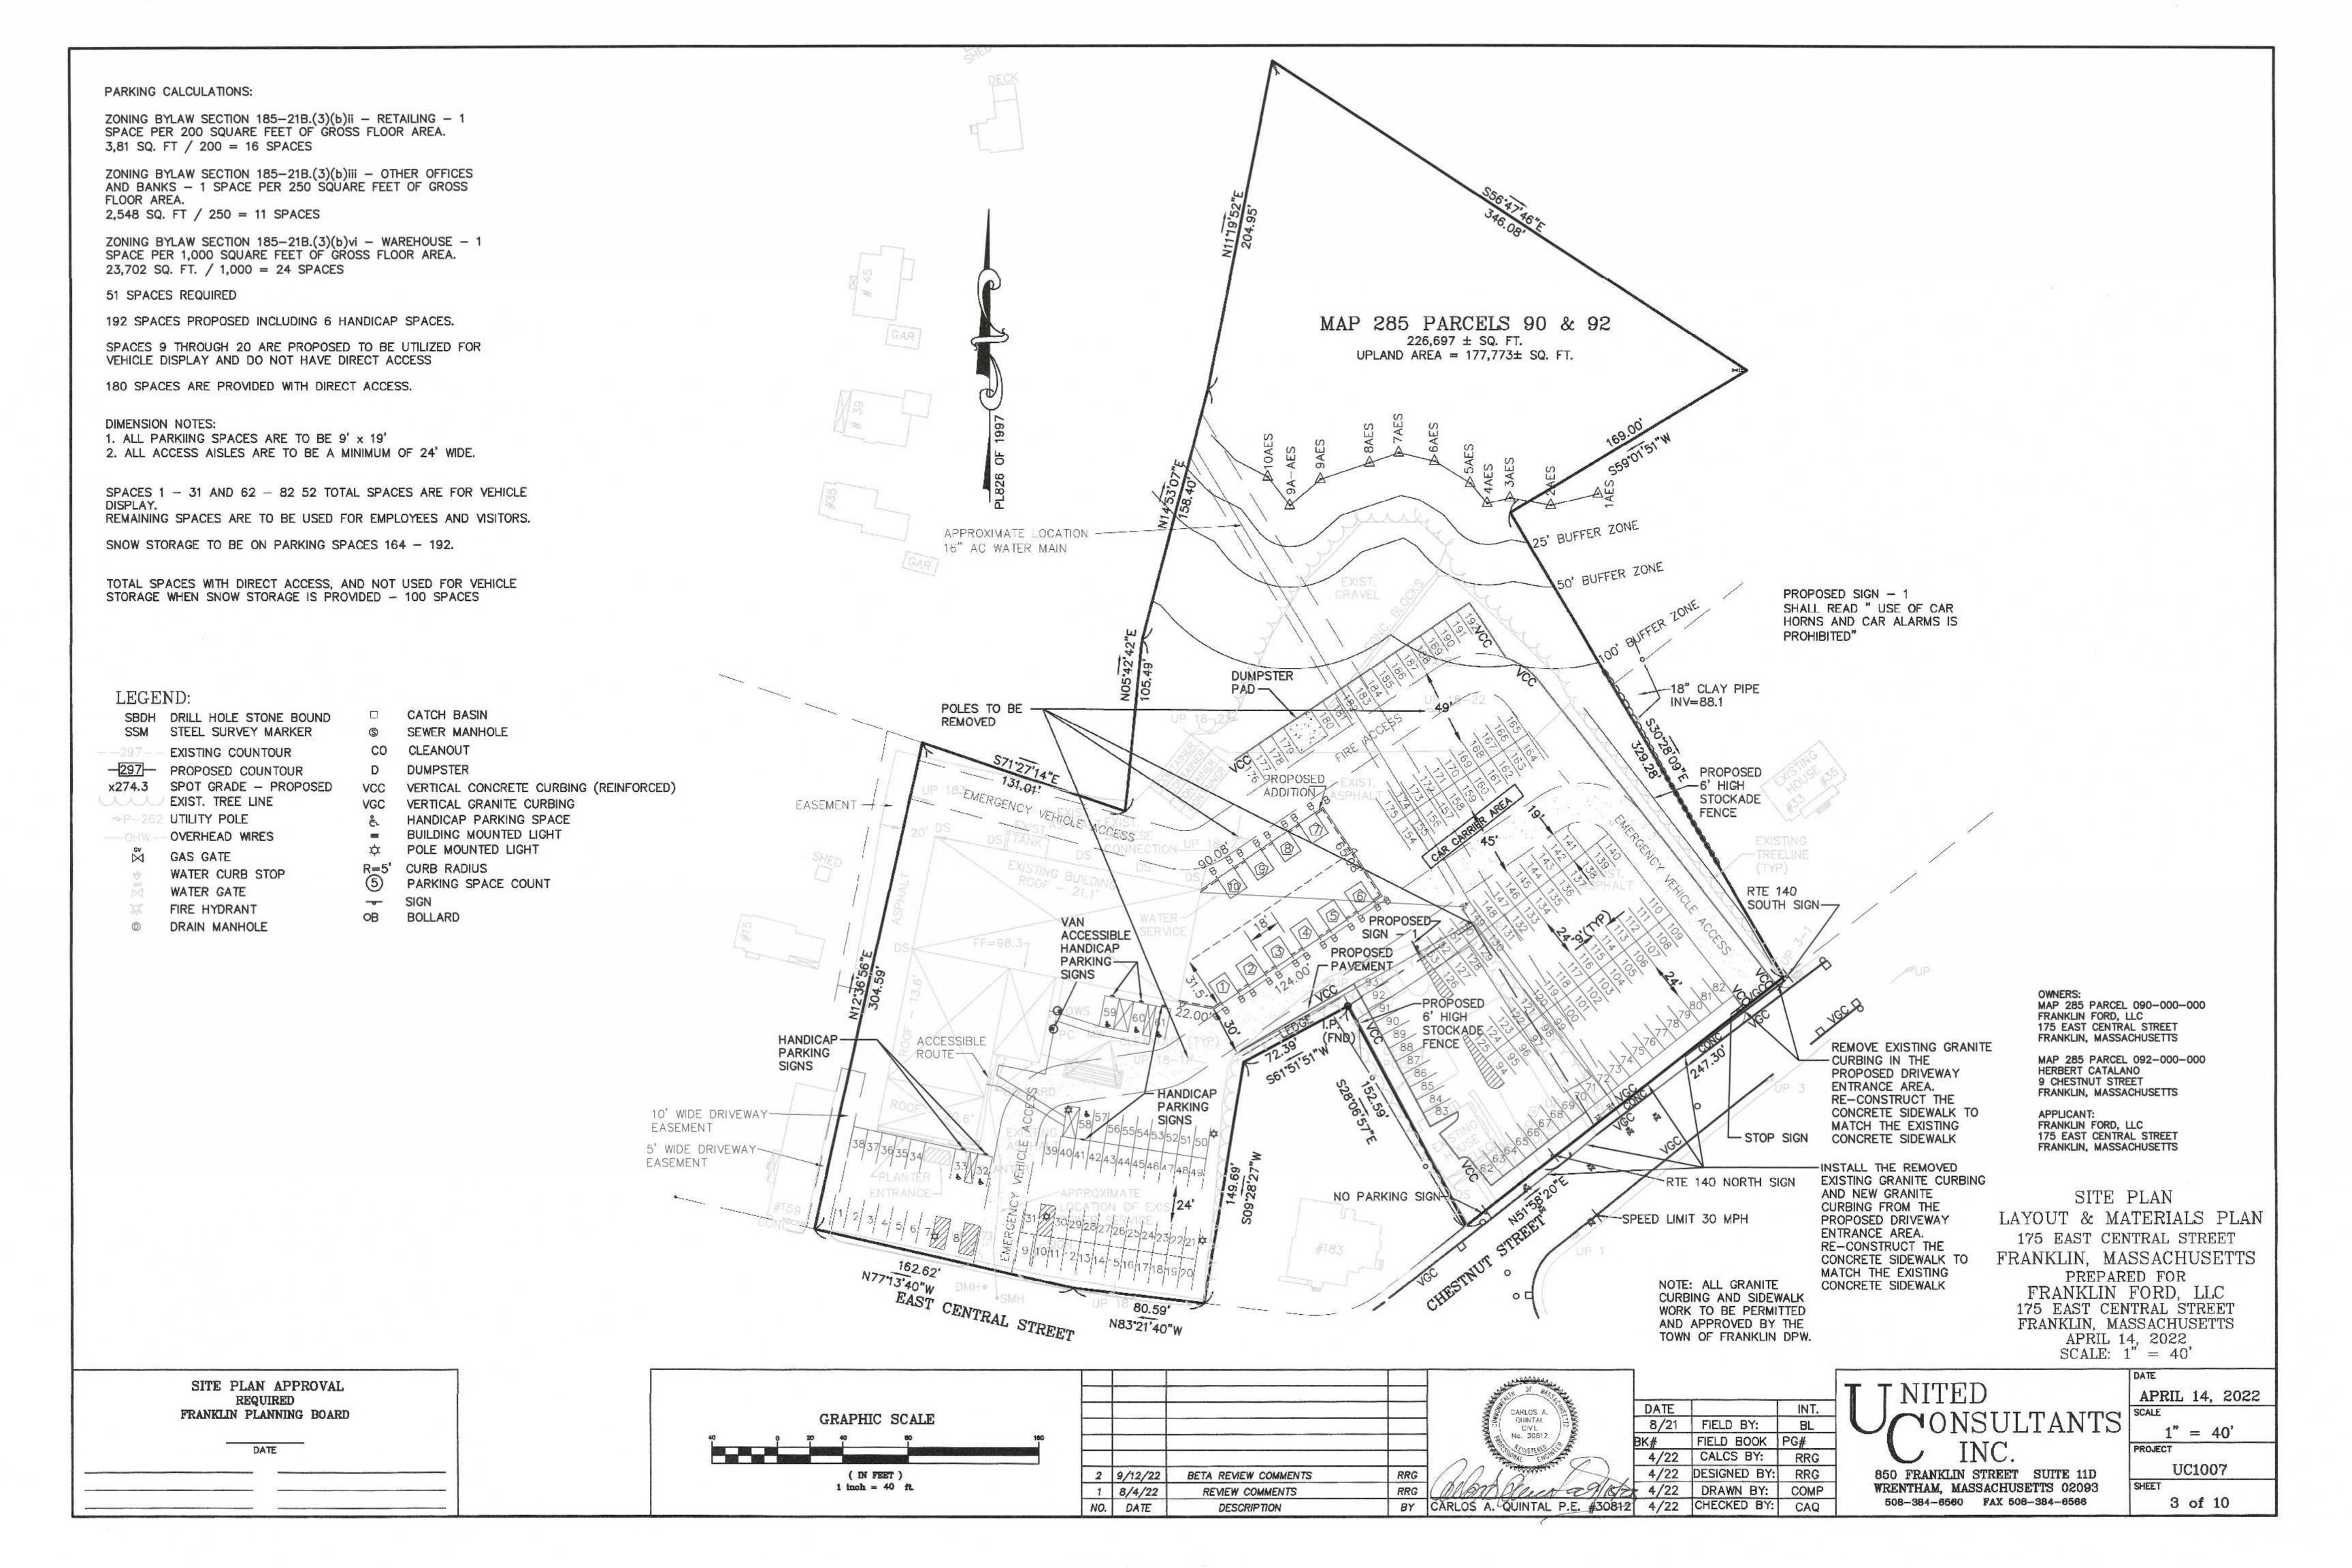

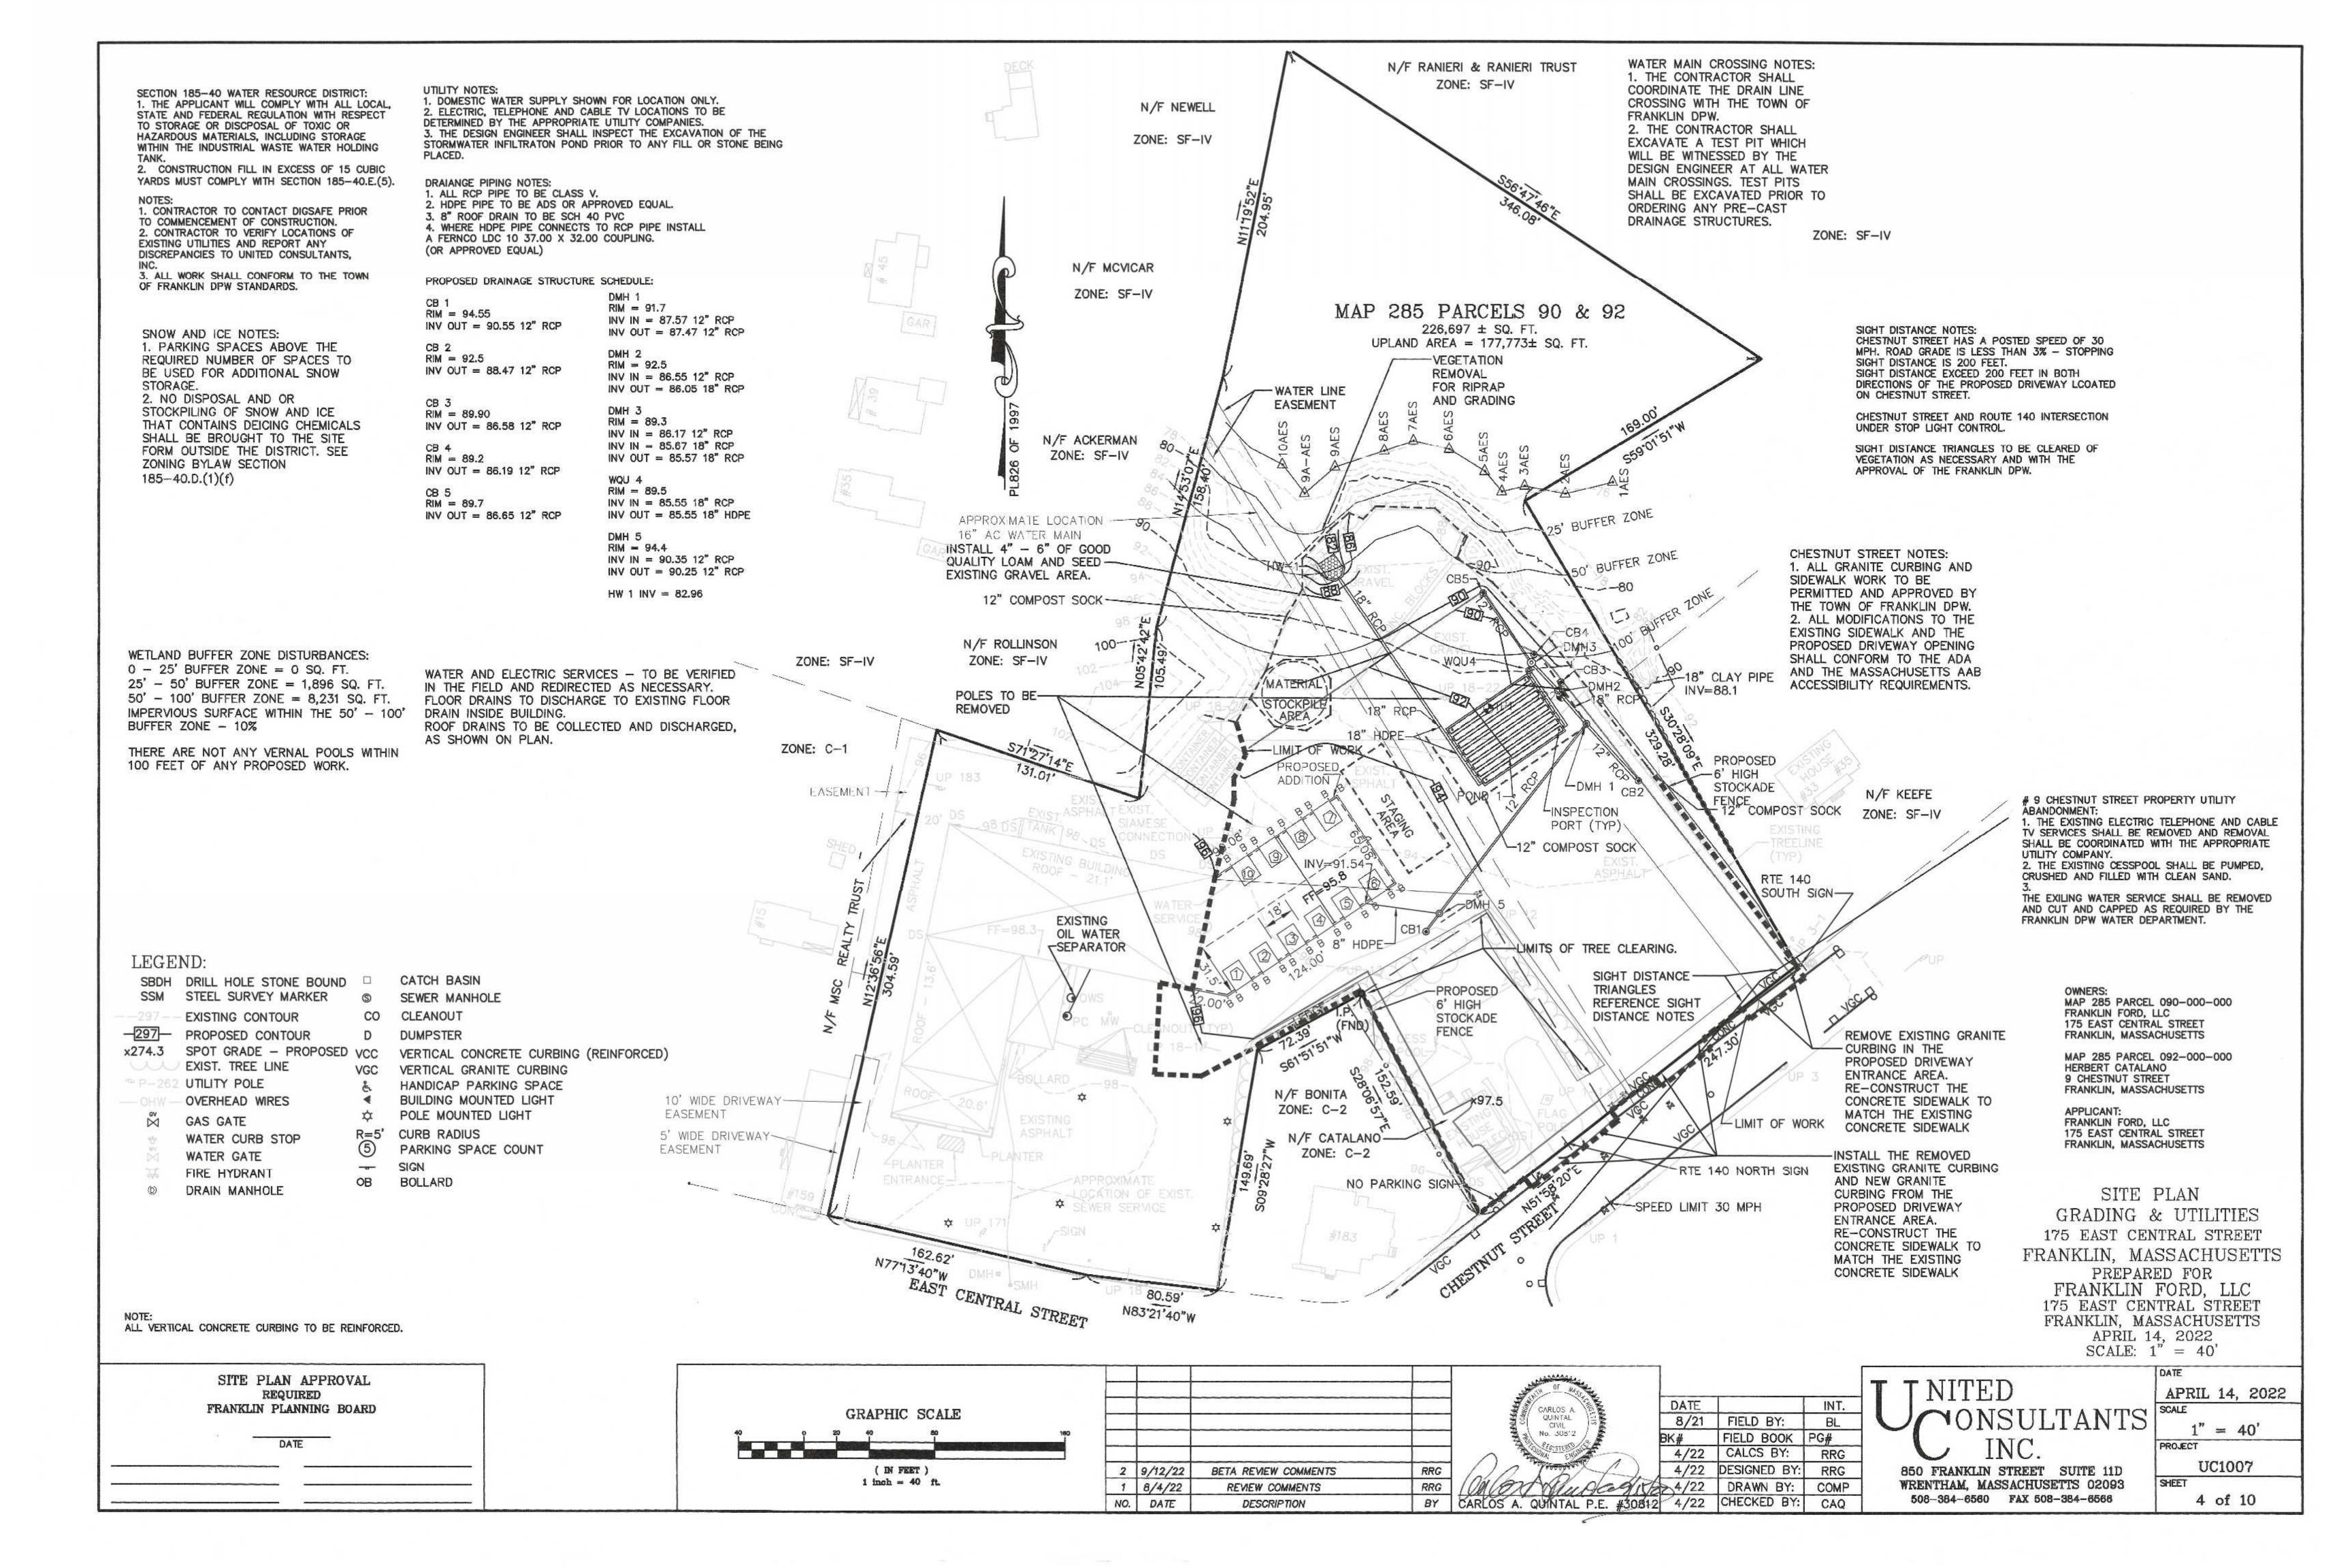

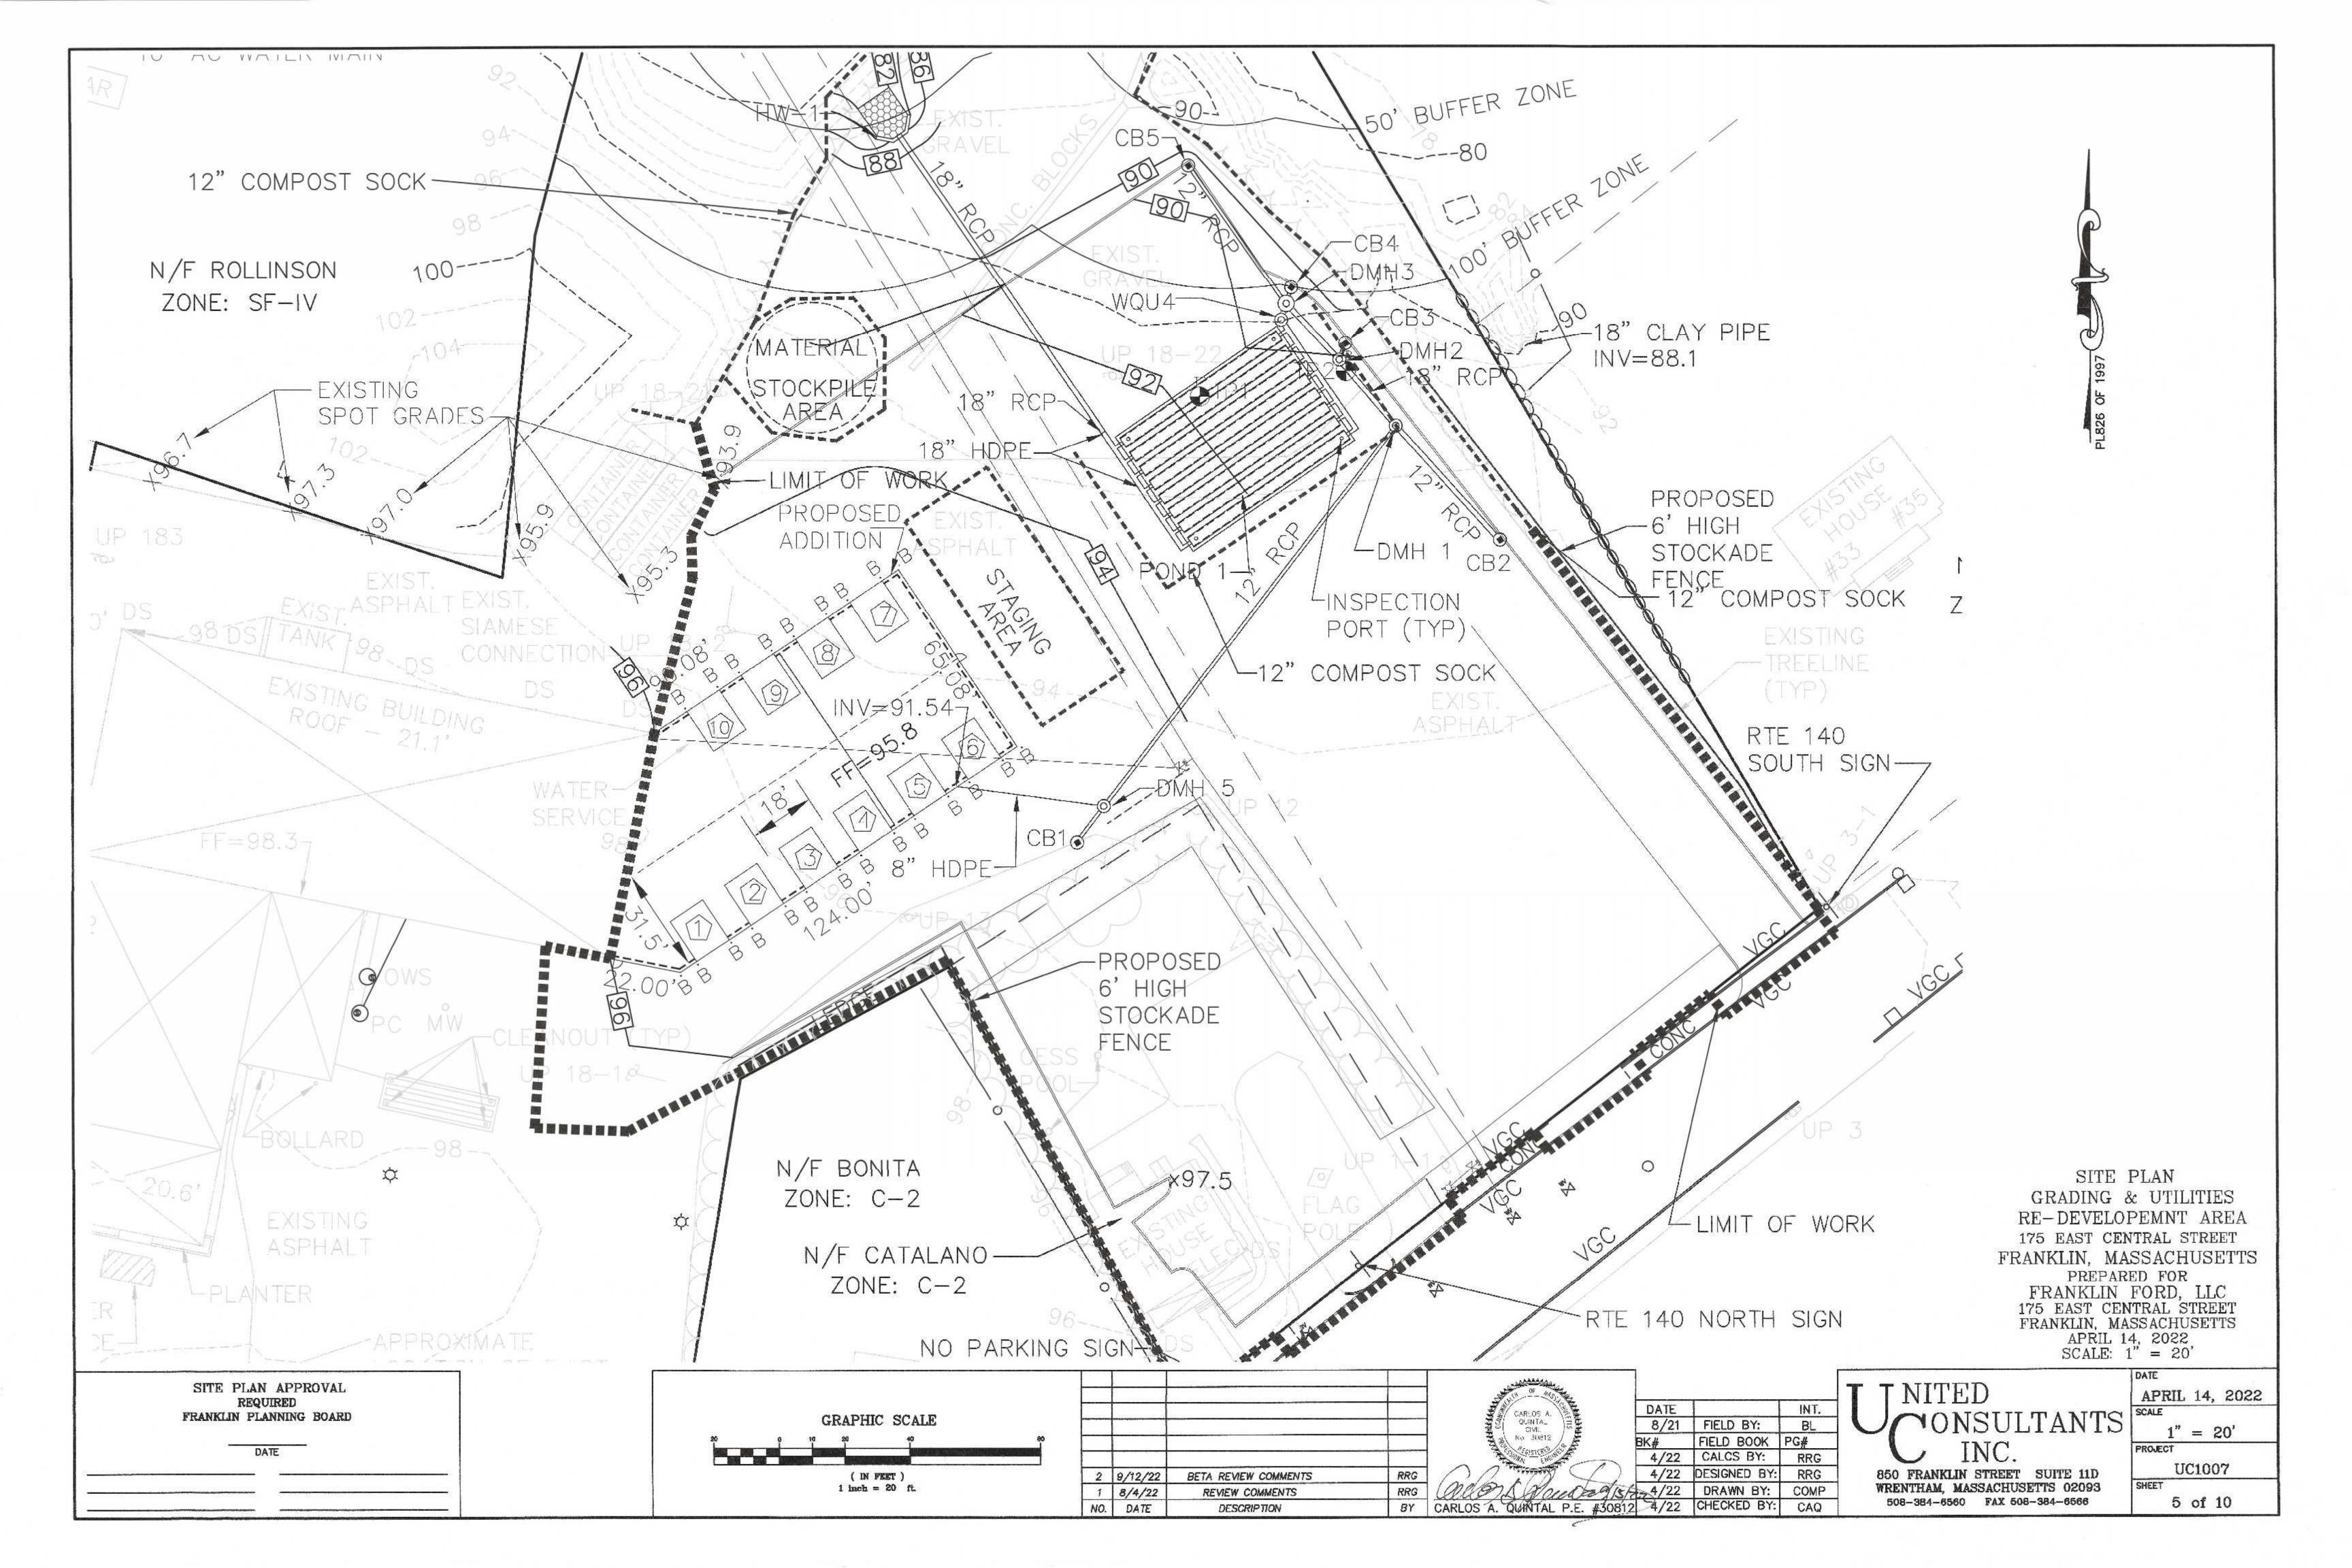

## PLANTING SCHEDULE WATER MAIN CROSSING NOTES: N/F RANIERI & RANIERI TRUST 1. THE CONTRACTOR SHALL CONDITION NUMBER | COMMON NAME SCIENTIFIC NAME SIZE ZONE: SF-IV COORDINATE THE DRAIN LINE CROSSING WITH THE TOWN OF **ULMUS AMERICANA** AMERICAN ELM - AE N/F NEWELL ACER RUBRUM RED MAPLE - RM FRANKLIN DPW. 4 - 6 FEET 18" - 24" WHITE BIRCH - WE BETULA PAPYRIFERA 2. THE CONTRACTOR SHALL ILEX GLABRA INKBERRY - I ZONE: SF-IV EXCAVATE A TEST PIT WHICH CREEPING JUNIPER - CJ RUSSIAN SAGE - RS SEDUM - S JUNIPERUS HORIZONTALIS WILL BE WITNESSED BY THE PEROVSKIA ATRIPLICIFOLIA DESIGN ENGINEER AT ALL WATER HYLOTELEPHIUM TELEPHIOIDES MAIN CROSSINGS. TEST PITS SHALL BE EXCAVATED PRIOR TO - PER SECTION 185-21C(5) PROVIDE 1 TREE PER 10 PARKING SPACES. ORDERING ANY PRE-CAST 192 TOTAL PARKING SPACES / 10 = 20 TREES DRAINAGE STRUCTURES. 20 TREES PROVIDED. ZONE: SF-IV - ALL PLANTINGS ARE IN ACCORDANCE WITH THE TOWN OF FRANKLIN BEST DEVELOPMENT PRACTICES GUIDEBOOK. N/F MCVICAR GENENRAL SITE PLANTING NOTE: ALL DISTURBED AREAS NOT COVERED WITH ZONE: SF-IV BUILDING, ASPHALT PAVEMENT, CURBING, STONE. MAP 285 PARCELS 90 & 92 RIPRAP OR GEOWEB SHALL HAVE 4" TO 6" OF GOOD QUALITY LOAM COVERING THE AREAS AND 226,697 ± SQ. FT. SHALL BE HYDROSEEDED. UPLAND AREA = 177,773± SQ. FT. -VEGETATION GENERAL NOTES REMOVAL FOR RIPRAP -WATER LINE AND GRADING EASEMENT 1. PLANTING HOLE SHALL BE THREE TIMES ROOT BALL DIAMETER. 2. ALL INSTALLED PLANT MATERIAL SHALL BEAR THE SAME RELATIONSHIP TO FINISH GRADE (TOP OF PLANTING SOIL MIX), AS N/F ACKERMAN IT BORE TO THE NURSERY OR FIELD GRADE. ZONE: SF-IV 3. THE PLANTING HOLE DEPTH SHALL PROVIDE FOR A SIX INCH DEPTH OF PLANTING SOIL MIX BELOW THE ANTICIPATED ROOT BALL BOTTOM. 4. NOTWITHSTANDING THE REQUIREMENTS OF NOTES 1 & 3 ABOVE, NO PLANTING HOLE FOR TREES SHALL HAVE LESS THAN ONE CUBIC YARD OF PLANTING SOIL MIX. 5. PLANTING SOIL MIX SHALL BE A LOAM OR SANDY LOAM, AS DEFINED BY THE U.S.D.A. THE FIRST (BOTTOM) SIX INCH APPROXIMATE LOCATION -- 30 LAYER IN THE PRE-EXCAVATED PLANTING HOLE SHALL BE FIRMLY TAMPED TO PREVENT SETTLEMENT OF THE ROOT BALL 16" AC WATER MAIN POSITIONED THEREON. SUBSEQUENT LIFTS TO FINISH GRADE SHALL BE IN SIX INCH LOOSE LIFTS, EACH SETTLED BY THOROUGH INSTALL 4" - 6" OF GOOD BUFFER ZONE CHESTNUT STREET NOTES: SOAKING. QUALITY LOAM AND SEED-1. ALL GRANITE CURBING AND 6. UPON ATTAINMENT OF FINISH GRADE WITHIN EACH PLANTING BED, THE GROUND SURFACE SHALL RECEIVE AN EVEN EXISTING GRAVEL AREA. SIDEWALK WORK TO BE APPLICATION OF ORGANIC NON-PHOSPHORUS FERTILIZER APPLIED PER THE MANUFACTURERS RECOMENDATIONS. PERMITTED AND APPROVED BY 7. COVERED WITH A THREE INCH NOMINAL DEPTH OF SHREDDED CEDAR BARK (OR APPROVED EQUIVALENT), MAINTAINING A 12" COMPOST SOCK THE TOWN OF FRANKLIN DPW. ONE INCH MINIMUM DEPTH AT THE BERM EDGE, AND IMMEDIATELY RISING TO A THREE INCH DEPTH ACROSS THE PLANTING BED 2. ALL MODIFICATIONS TO THE OR LANDSCAPE ISLAND. (SEE DETAIL) EXISTING SIDEWALK AND THE N/F ROLLINSON PROPOSED DRIVEWAY OPENING SHALL CONFORM TO THE ADA ZONE: SF-IV ZONE: SF-IV AND THE MASSACHUSETTS AAB -18" CLAY PIPE ACCESSIBILITY REQUIREMENTS. POLES TO BE-REMOVED ZONE: C-1 PROPOSED STOCKADE EASEMENT -N/F KEEFE FENCE 12 COMPOST SOCK ZONE: SF-IV PORT (TYP) -12" COMPOST SOCK -TREELINE RTE 140 SOUTH SIGN-EXISTING OIL WATER SEPARATOR LIMITS OF TREE CLEARING. SIGHT DISTANCE TRIANGLES MAP 285 PARCEL 090-000-000 REFERENCE SIGHT FRANKLIN FORD, LLC 175 EAST CENTRAL STREET 6' HIGH DISTANCE NOTES STOCKADE FRANKLIN, MASSACHUSETTS FENCE REMOVE EXISTING GRANITE MAP 285 PARCEL 092-000-000 HERBERT CATALANO -CURBING IN THE PROPOSED DRIVEWAY 9 CHESTNUT STREET ENTRANCE AREA. FRANKLIN, MASSACHUSETTS RE-CONSTRUCT THE N/F BONITA CONCRETE SIDEWALK TO 10' WIDE DRIVEWAY-APPLICANT: ZONE: C-2 FRANKLIN FORD, LLC 175 EAST CENTRAL STREET FRANKLIN, MASSACHUSETTS MATCH THE EXISTING EASEMENT -LIMIT OF WORK CONCRETE SIDEWALK 5' WIDE DRIVEWAY-N/F CATALANC EASEMENT ZONE: C-2 INSTALL THE REMOVED EXISTING GRANITE CURBING RTE 140 NORTH SIGN AND NEW GRANITE NO PARKING SIGN SITE PLAN LOCATION OF EXIST CURBING FROM THE PLANTING PLAN SPEED LIMIT 30 MPH PROPOSED DRIVEWAY ENTRANCE AREA. Χ 175 EAST CENTRAL STREET RE-CONSTRUCT THE CONCRETE SIDEWALK TO FRANKLIN, MASSACHUSETTS N7773'40"W DMINEAST CENTRAL STREET 162.62 MATCH THE EXISTING PREPARED FOR CONCRETE SIDEWALK FRANKLIN FORD, LLC 175 EAST CENTRAL STREET N83'21'40"W FRANKLIN, MASSACHUSETTS APRIL 14, 2022 SCALE: 1" = 40' SITE PLAN APPROVAL APRIL 14, 2022 REQUIRED DATE INT. FRANKLIN PLANNING BOARD GRAPHIC SCALE 8/21 | FIELD BY: BL 1'' = 40'FIELD BOOK PG# INC. DATE PROJECT 4/22 CALCS BY: RRG UC1007 4/22 DESIGNED BY: 850 FRANKLIN STREET SUITE 11D ( IN FEET ) 2 9/12/22 BETA REVIEW COMMENTS RRG 1 inch = 40 ft. SHEET 4/22 DRAWN BY: WRENTHAM, MASSACHUSETTS 02093 1 8/4/22 RRG REVIEW COMMENTS


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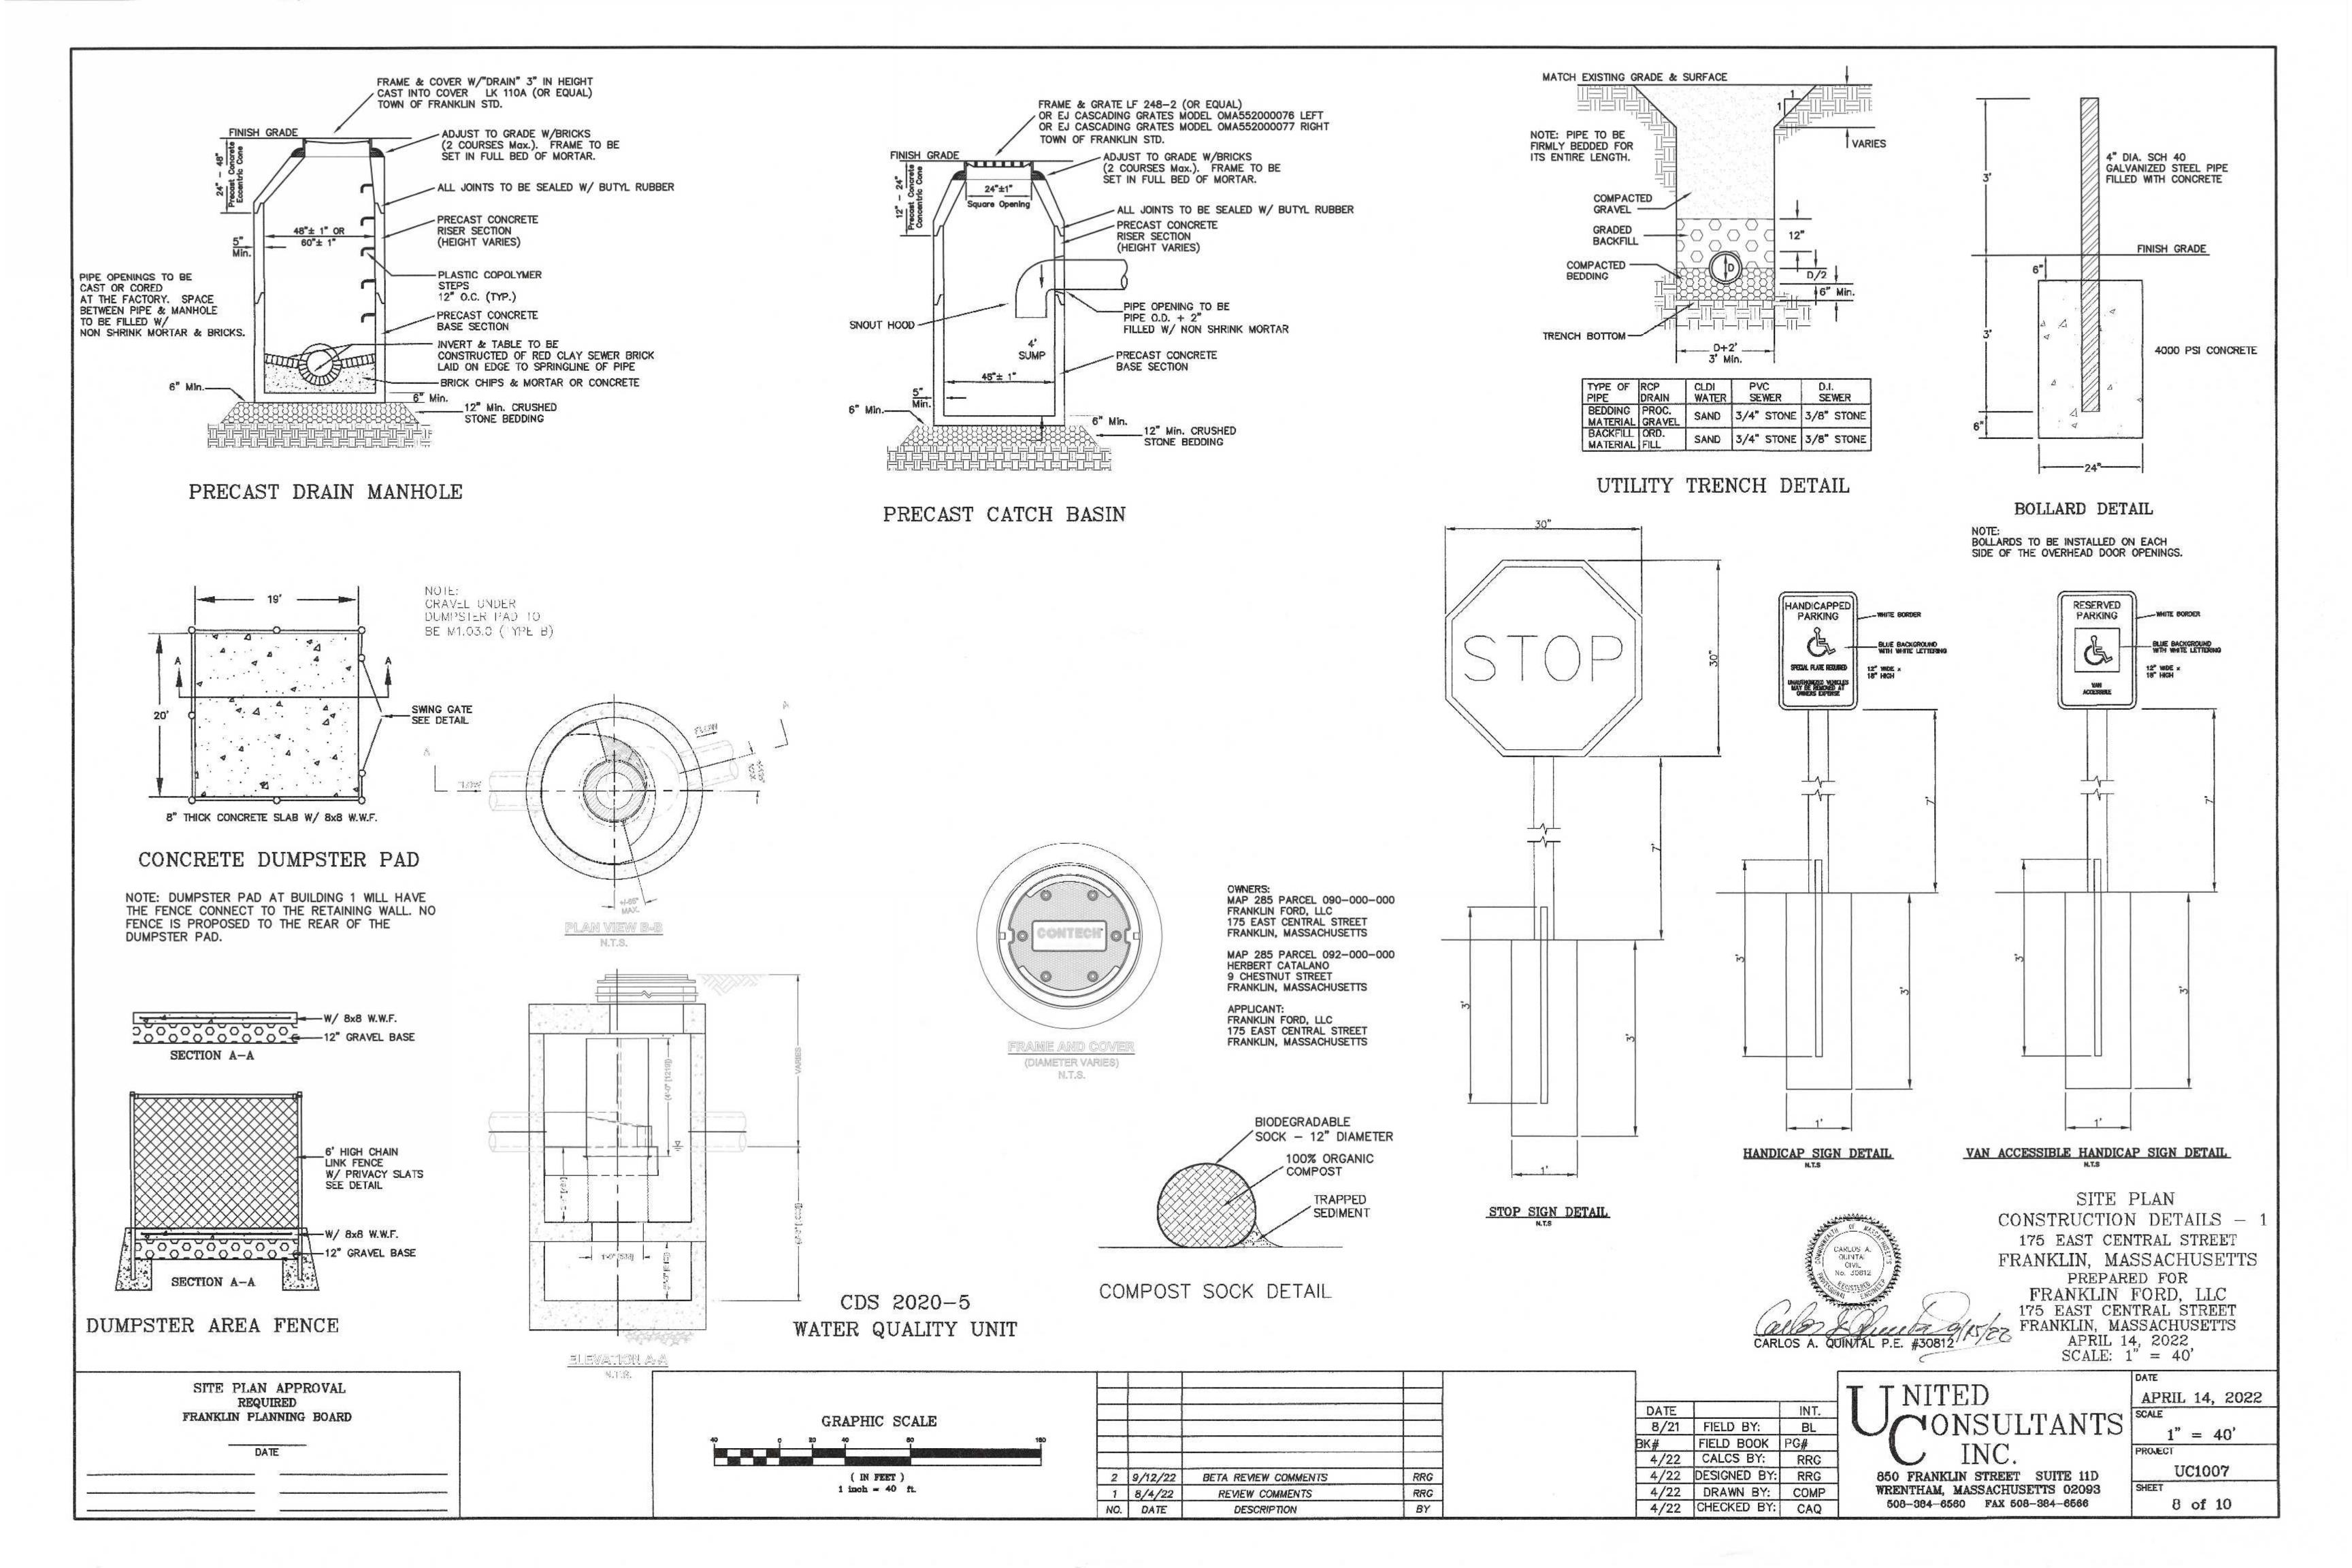
DESCRIPTION

6 of 10

508-384-6560 FAX 508-384-6566

CARLOS A. QUINTAL P.E. #30812 4/22 CHECKED BY:



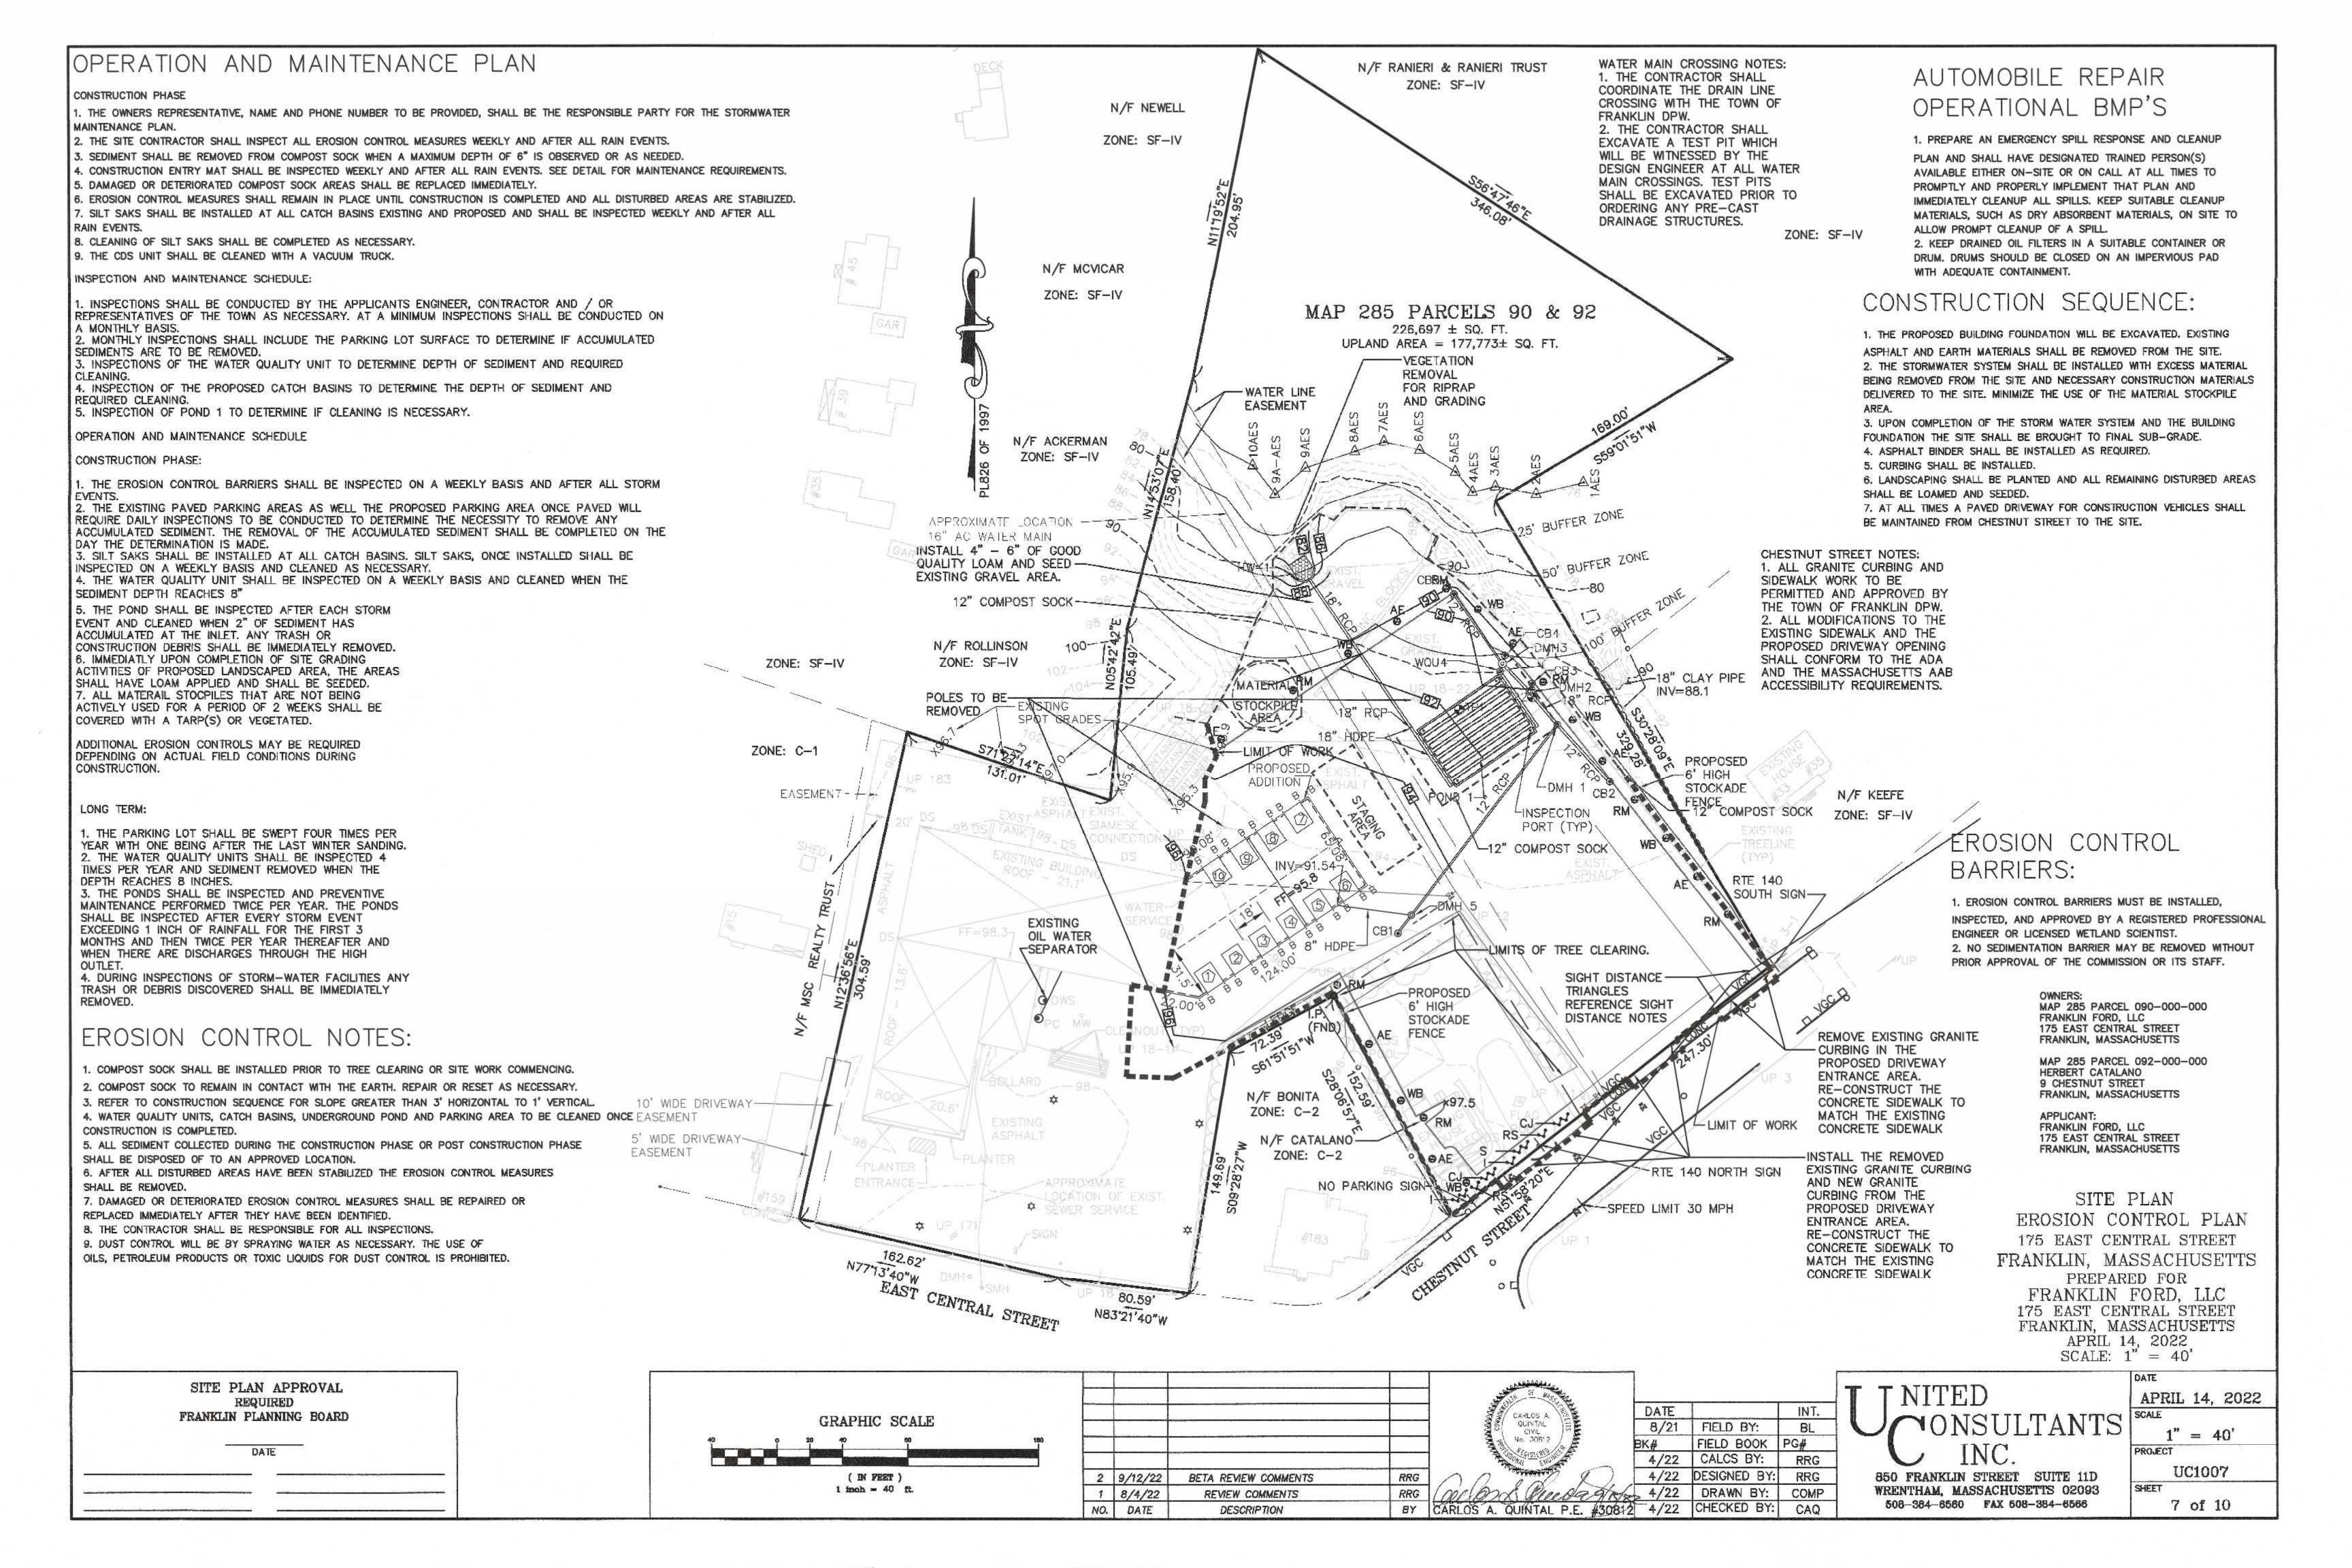

# EXCAVATION AND FILL NOTES:

SOIL REMOVAL AT INFITRATION SYSTEM: ALL EXISTING TOP (A HORIZON) AND SUB-SOIL (B HORIZON SOILS AND FILL SHALL BE REMOVED UNDER THE INFITRATION SYSTEMS AND FIVE FEET FROM THE OUTER EDGE OF THE STONE ENVELOPE.


Fill material for drainage systems constructed in fill shall consist of select on—site or imported soil material. The fill shall be comprised of clean granular sand, free from organic matter and material. The fill shall be comprised of clean granular sand, free from organic matter and deleterious substances. Mixtures and layers of different classes of soil shall not be used. The fill shall not contain any material larger than two inches. A sieve analysis, using a #4 sieve, shall be performed on a representative sample of the fill. Up to 45% by weight of the fill sample may be retained on the #4 sieve. Sieve analyses also shall be performed on the fraction of the fill sample passing the #4 sieve, such analyses must demonstrate that the material meets each of the following specifications:

SIEVE SIZE	EFFECTIVE PARTICLE SIZE	% THAT MUST PASS SIEVE
# 4	4.75 mm	100%
<b>#</b> 50	0.30 mm	10% - 100%
#100	0.15 mm	0% - 20%
#200	0.075 mm	0% - 2%


A minimum of two representative sample shall be taken from the in-place fill and tested for compliance with the grain size distribution specification. Where fill is required to replace unsuitable or impermeable soils, the excavation of the unsuitable material shall extend a minimum of five feet laterally in all directions beyond the outer perimeter of the soil drainage systems to the depth of naturally occurring pervious material and replaced with fill.

Prior to placement of the fill, the bottom surface of the excavation shall be scarified and relatively dry. Fill shall not be placed during rain or snow storms. If the water table elevation is above the elevation of the bottom of the excavation, the excavation shall be dewatered as necessary.

THE DESIGN ENGINEER SHALL INSPECT AND CERTIFY THE EXCAVATION OF THE SOIL INFILTRATION AREAS AND THE RAIN GARDEN AREA PRIOR TO ANY FILL BEING PLACED.

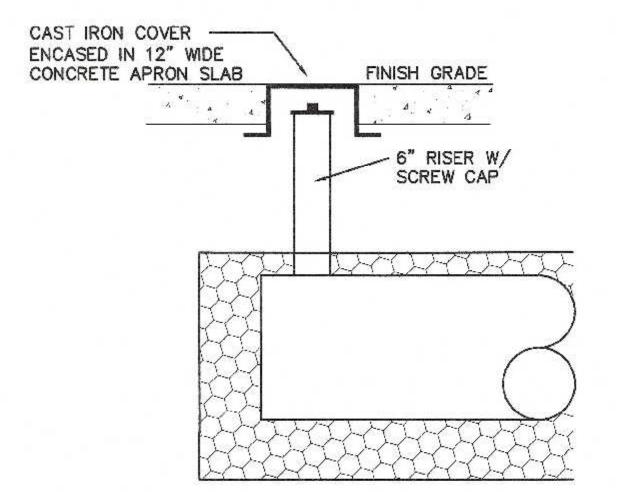

INSPECTION PORT DETAIL DRAINAGE INFILTRATION AREAS

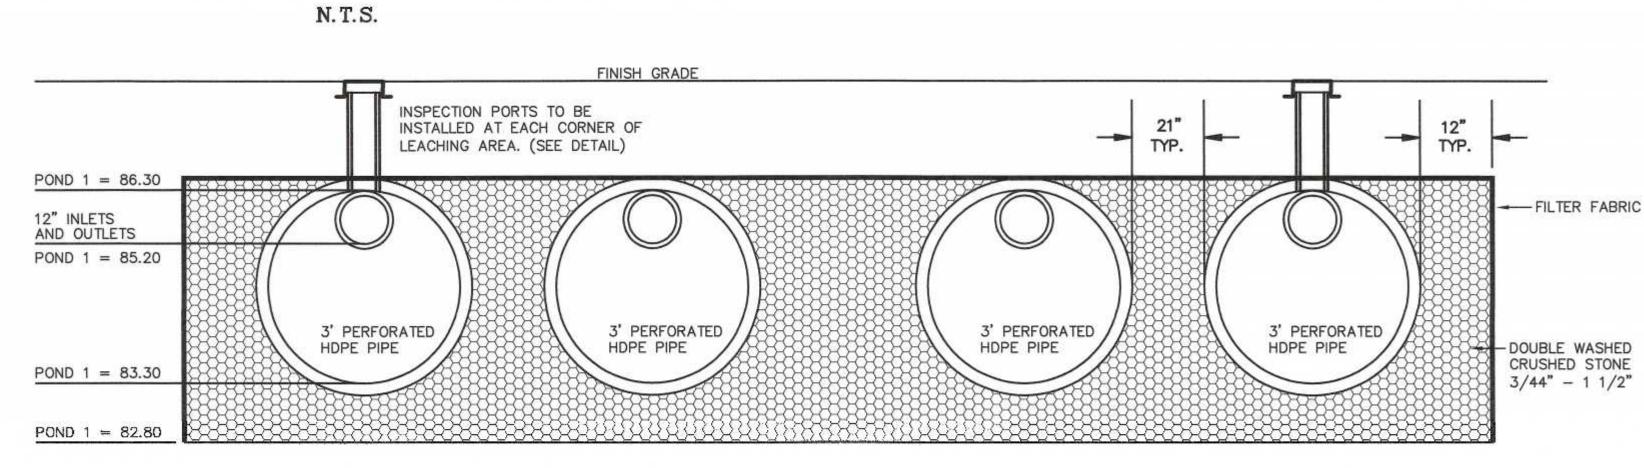

INFILTRATION POND 1


1. INFILTRATION POND 1 CONSISTS OF 7 ROWS OF 3' DIAMETER PERFORATED HDPE PIPE 58' IN LENGTH. STONE ENVELOPE IS 37.22' x 60'

SITE PLAN APPROVAL

FRANKLIN PLANNING BOARD

DATE

ESHGW - POND 1 = 78.68 BOTTOM TEST PIT 1

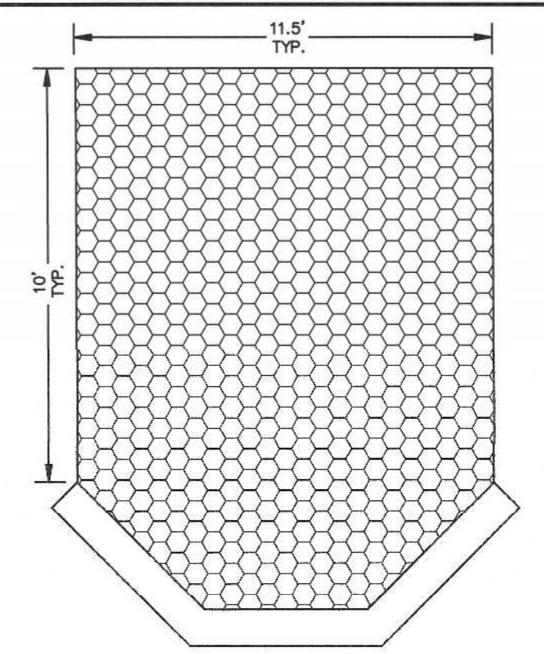

RIP RAP AT HEADWALL N.T.S.

3,6000

FRONT

1" PVC ANTI-SIPHUN

PIPE ADAPTER

CONSTRUCTION NOTES: 1. RIP RAP TO BE MAXIMUM OF 21" AVERAGE OF 14" AND MINIMUM OF 8". 2. RIP RAP TO BE PLACED OVER A FILTER 3. RIP RAP MINIMUM DEPTH SHALL BF 28" REFERENCE TECHNICAL SUPPLEMENT 14C - US BUREAU OF RECLIMATION METHOD.

REMOVABLE VATERTIGHT

ACCESS PURI, 6" UPENING

**---**14,18" **---**

SIDE

DATE

8/21 | FIELD BY:

4/22 CALCS BY:

4/22 DESIGNED BY: RRG

4/22 DRAWN BY: COMP

4/22 CHECKED BY: CAQ

FIELD BOOK PG#


SNOUT DETAIL

 $D50 = 0.0122 \times 8.92$ 

INSERT 1" REBAR FOR BAG REMOVAL FROM INLET (REBAR NOT INCLUDED) -OPTIONAL OVERFLOW DUMP LOOPS -(REBAR NOT INCLUDED)

Typical Siltsack® Construction - Type B

SILT SAK DETAIL NOT TO SCALE

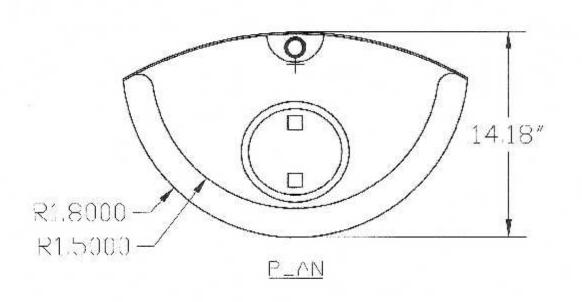

DESIGNED TO FIT 48"-80" DIAM. STRUCTURES

US PATENT # 6126817 ADDITIONAL PATENTS PENDING

DRAWING NUMBER	
DATE	SCALE NONE
	09/06/99

CARLOS A. QUINTAL P.E. #30812

INT.

BL

RRG

OWNERS: MAP 285 PARCEL 090-000-000 FRANKLIN FORD, LLC 175 EAST CENTRAL STREET FRANKLIN, MASSACHUSETTS

MAP 285 PARCEL 092-000-000 HERBERT CATALANO 9 CHESTNUT STREET FRANKLIN, MASSACHUSETTS APPLICANT:

FRANKLIN FORD, LLC 175 EAST CENTRAL STREET FRANKLIN, MASSACHUSETTS SITE PLAN

SCONSTRUCTION DETAILS - 2

175 EAST CENTRAL STREET FRANKLIN, MASSACHUSETTS PREPARED FOR FRANKLIN FORD, LLC 175 EAST CENTRAL STREET

FRANKLIN, MASSACHUSETTS APRIL 14, 2022

SCALE: 1'' = 40'APRIL 14, 2022

NITED INC.

850 FRANKLIN STREET SUITE 11D

WRENTHAM, MASSACHUSETTS 02093


508-384-6560 FAX 508-384-6566

PROJECT UC1007 SHEET 9 of 10


= 40'

GRAPHIC SCALE ( IN FEET ) 1 inch = 40 ft.


2	9/12/22	BETA REVIEW COMMENTS	RRG
1	8/4/22	REVIEW COMMENTS	RRG
VO.	DATE	DESCRIPTION	BY

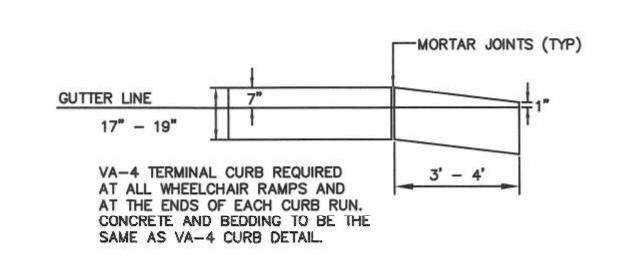


# VA-4 TERMINAL AND TRANSITION CURB

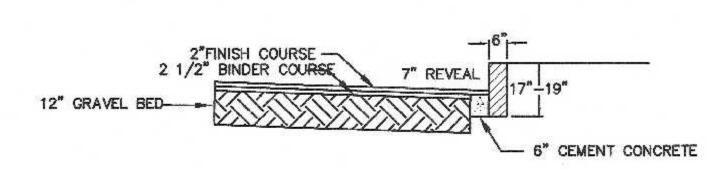


PAVEMENT AND VA-4 VERTICAL GRANITE CURBING

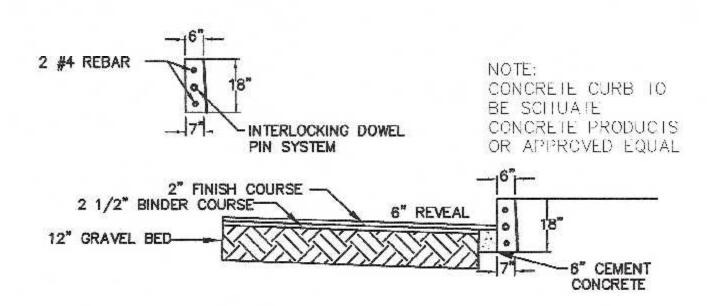


PAVEMENT AND VERTICAL CONCRETE CURBING

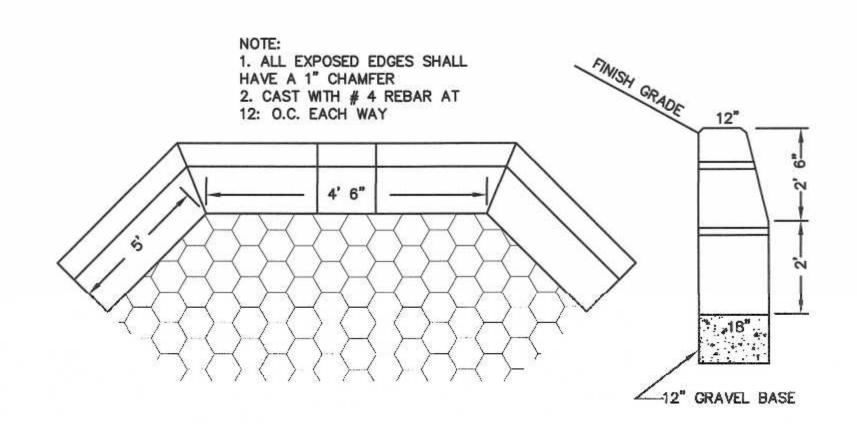

TYPE "B" PRECAST HEADWALL

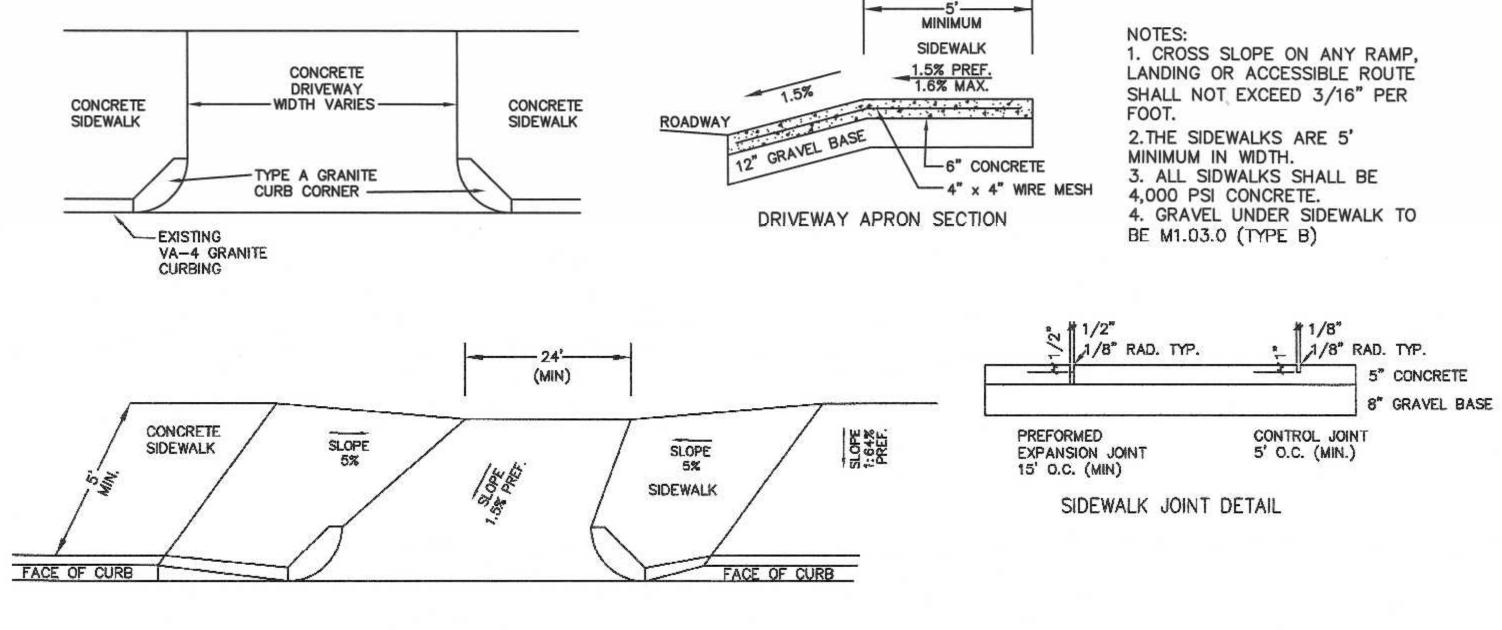

DRIVEWAY APRON

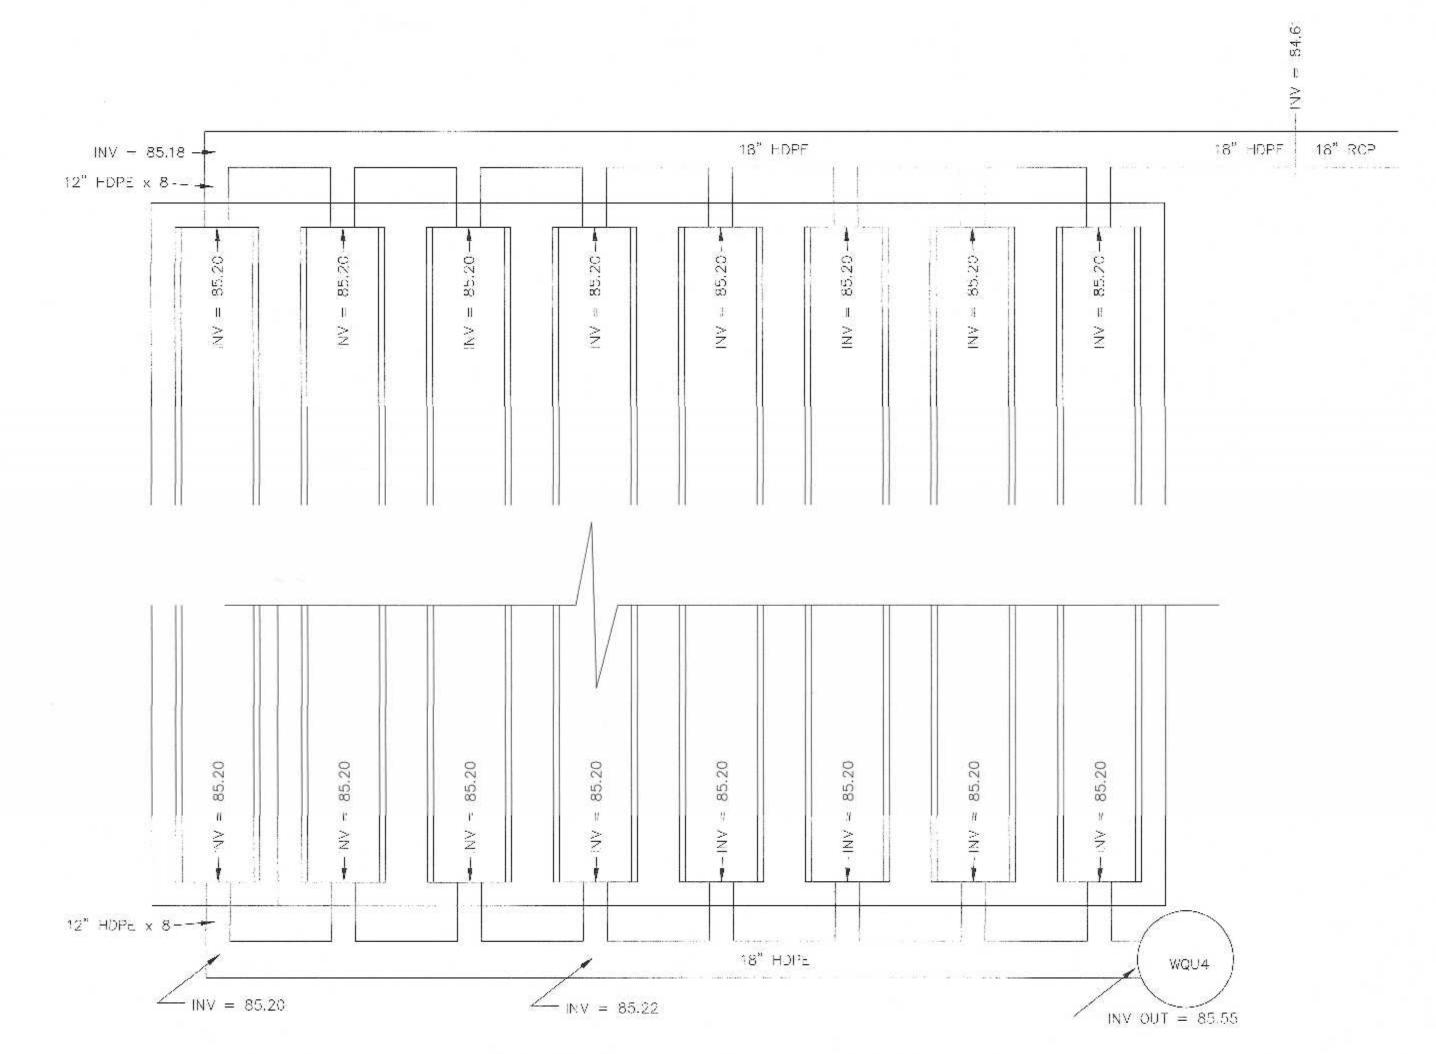

INFILTRATION POND 1 MANIFOLDS

SITE PLAN APPROVAL REQUIRED FRANKLIN PLANNING BOARD DATE

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2	9/12/22	BETA REVIEW COMMENTS	RRG	
1	8/4/22	REVIEW COMMENTS	RRG	Malan South a 9/100
NO.	DATE	DESCRIPTION	BY	CARLOS A. QUINTAL P.E. #30812

DATE INT. 8/21 FIELD BY: BL	-
	1
DICE DOOK DOW	
BK#   FIELD BOOK   PG#	
4/22 CALCS BY: RRG	
4/22 DESIGNED BY: RRG	
4/22 DRAWN BY: COMP	
4/22 CHECKED BY: CAQ	$\neg$

SITE PLAN CONSTRUCTION DETAILS - 3 175 EAST CENTRAL STREET FRANKLIN, MASSACHUSETTS PREPARED FOR
FRANKLIN FORD, LLC
175 EAST CENTRAL STREET
FRANKLIN, MASSACHUSETTS APRIL 14, 2022 SCALE: 1" = 40'

BITUMINOUS CONCRETE

SIDEWALK

- TRANSITION CURB

FACE OF CURB

WHEELCHAIR RAMP

**T** NITED ONSULTANTS INC.

APRIL 14, 2022 1'' = 40'UC1007 850 FRANKLIN STREET SUITE 11D WRENTHAM, MASSACHUSETTS 02093 SHEET 10 of 10 508-384-6560 FAX 508-384-6566