
SITE PLAN 100 AND 110 EAST CENTRAL STREET

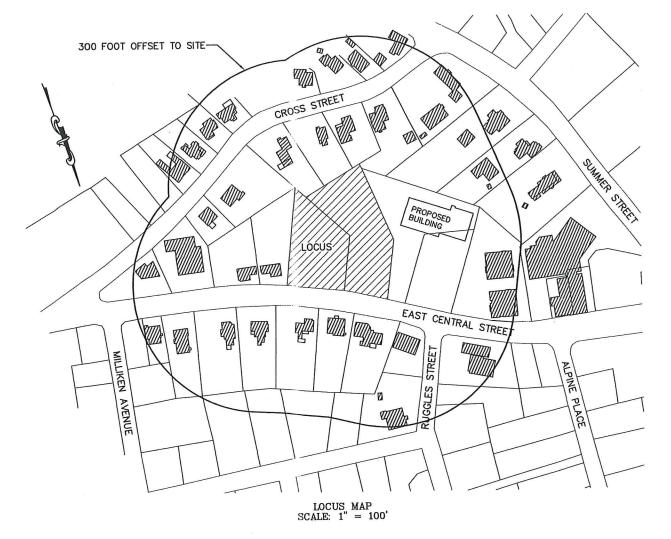

DRAWING INDEX:

1. COVER SHEET

EXISTING CONDITIONS PLAN

3. SITE LAYOUT PLAN

SITE GRADING AND UTILITY PLAN

5. PLANTING PLAN

EROSION CONTROL PLAN

7. CONSTRUCTION DETAILS - 1

CONSTRUCTION DETAILS - 2

9. CONSTRUCTION DETAILS - 3 10. CONSTRUCTION DETAILS - 4 SITE LIGHTING-LIGHTING PLAN,

PHOTOMETRICS AND SCHEDULES BY SK & ACCOCIATES

FRONTAGE: 50'
DEPTH: 50'
HEIGHT: 3 STORIES
WIDTH: 45'
SETBACKS
FRONT: 20' 41
SIDE WEST: 10' 414
SIDE EAST: 10' 414
REAR: 15'
COVERAGE
STRUCTURES: 80%
STRUC. & PANNG: 90%

LOT COVERAGE BASED ON UPLAND AREA.
**REFER TO ARCHITECTURAL PLANS FOR BUILDING HEIGHT.

*1 — BUT NO NEW STRUCTURE SHALL BE REQUIRED TO PROVIDE A DEEPER YARD THAN EXISTED ON THAT PARCEL UPON ADOPTION OF THIS AMENDMENT.

*14 — THE 10-FOOT SIDE SETBACK IS ONLY REQUIRED ON ONE SIDE OF THE LOT; IF LOT ABUTS A RESIDENTIAL DISTRICT, A 20-FOOT SETBACK IS REQUIRED ON THE ABUTTING SIDE.

*15 — BUILDINGS UP TO 50 FEET IN HEIGHT, REGARDLESS OF THE NUMBER OF STORIES, MAY BE PERMITTED BY A SPECIAL PERMIT FROM THE PLANNING BOARD.

EXISTING 56,329± S.F. 245.1' 293.7'

2 STORIES > 45'

31.3' 15.0' 14.7' 114.5'

PROPOSED 56,329± S.F. 245.1' 293.7'

3 STORIES < 40'44

120.4 18.2% 64.9%

> 45'

THE 100 AND 110 EAST CENTRAL STREET PROPERTIES ARE LOCATED WITHIN A COMMERCIAL I ZONE.

REQUIREMENTS: 5.000 S.F.

500 5.F. 50' 50' 3 STORIES - 40'

REQUIREMENTS FOR 100 AND 110 EAST CENTRAL STREET ZONE COMMERCIAL 1 EXISTING AND PROPOSED LOT AREA, FRONTAGE, DEPTH, WIDTH AND COVERAGE BASED ON THE LOTS BEING COMBINED.
BUILDING HEIGHT, AND SETBACKS BASED ON EXISTING AND PROPOSED BUILDINGS LOCATED ON 100 AND 110 EAST CENTRAL STREET.
PROPERTY IS NOT LOCATED WITHIN A FRANKLIN WATER RESOURCE DISTRICT.
THE PROPERTY IS LOCATED IN A ZONE C BASED ON FEMA FIRM MAP 25021C0309E DATED JULY 17, 2012.

100 EAST CENTRAL STREET

	REQUIREMENTS: 5,000 S.F. 50' 50' 3 STORIES - 40' *15	33,061± S.F. 109.78' 278.1' 2 STORIES > 45'	33,061± S.F. 109.78' 278.1' 2 STORIES < 40'** > 45'
WDTH: SETBACKS FRONT: SIDE WEST: SIDE EAST: REAR:	20' *1 10' *14 10' *14 15'	70.6' 15.0' 15.2' 127.8'	70.6' 15.0' 15.2' 127.8'
COVERAGE STRUCTURES: STRUC. & PAV	80% NG: 90%	13.3% 66.1%	13.3% 71.8%

LOT COVERAGE BASED ON UPLAND AREA.

110 EAST CENTRAL STREET

AREA: FRONTAGE: DEPTH: HEIGHT: WDTH:	REQUIREMENTS: 5,000 S.F. 50' 50' 3 STORIES - 40' *15 45'	EXISTING 22,268± S.F. 135.32' 220.9' 2 STORIES > 45'	PROPOSED 22,268± S.F. 135.32' 220.9' 3 STORIES < 40'** > 45'	
SETBACKS FRONT: SIDE WEST: SIDE EAST: REAR: COVERAGE	20' *1 10' *14 10' *14 15'	29.4' 62.0' 14.7' 85.1'	20.5' 14.4' 10.4' 120.4'	
STRUCTURES: STRUC. & PAV	80% NNG: 90%	9.1% 14.7%	25.7% 56.0%	

LOT COVERAGE BASED ON UPLAND AREA.

REFERENCES: ASSESSORS MAP 286 PARCELS 30 AND 31 DEED BOOK 38897 PAGE 557 CERTIFICATE NUMBER 209218

PLAN 19290B PLAN IN BOOK 1091 PAGE 108 PLAN 3334 OF 1913

OWNERS: 100 EAST CENTRAL STREET RE, LLC 110 EAST CENTRAL STREET RE, LLC 37 EAST CENTRAL STREET FRANKLIN, MASSACHUSETTS

APPLICANT: 110 EAST CENTRAL STREET RE, LLC 37 EAST CENTRAL STREET FRANKLIN, MASSACHUSETTS


SITE PLAN COVER SHEET 100 & 110 EAST CENTRAL STREET FRANKLIN, MASSACHUSETTS

PREPARED FOR 110 EAST CENTRAL STREET RE, LLC
37 EAST CENTRAL STREET
FRANKLIN, MASSACHUSETTS

JANUARY 5, 2024 SCALE: 1" = 100'

- ALL EROSION CONTROL MITIGATION MEASURES SHALL BE IN PLACE PRIOR TO MAJOR CONSTRUCTION OR SOIL DISTURBANCE COMMENCING ON THE SITE.

SITE PLAN APPROVAL REQUIRED
FRANKLIN PLANNING BOARD

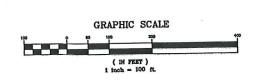

				Of Maria
				CARIOS A CELLO
				227 24
1	2/26/24	REVIEW COMMENTS	RRG	1000
	DATE	DESCRIPTION	BY	CARLOS A. QUINTAL P.E. #308

WAIVER REQUESTS:

1. TO ALLOW THE USE OF PVC AND HPDE PIPE FOR THE ROOF DRAINS AND UNDERGROUND STORMWATER STORAGE AREA.

2. TO ALLOW SITE LIGHTING TO EXTEND PAST THE PROPERTY


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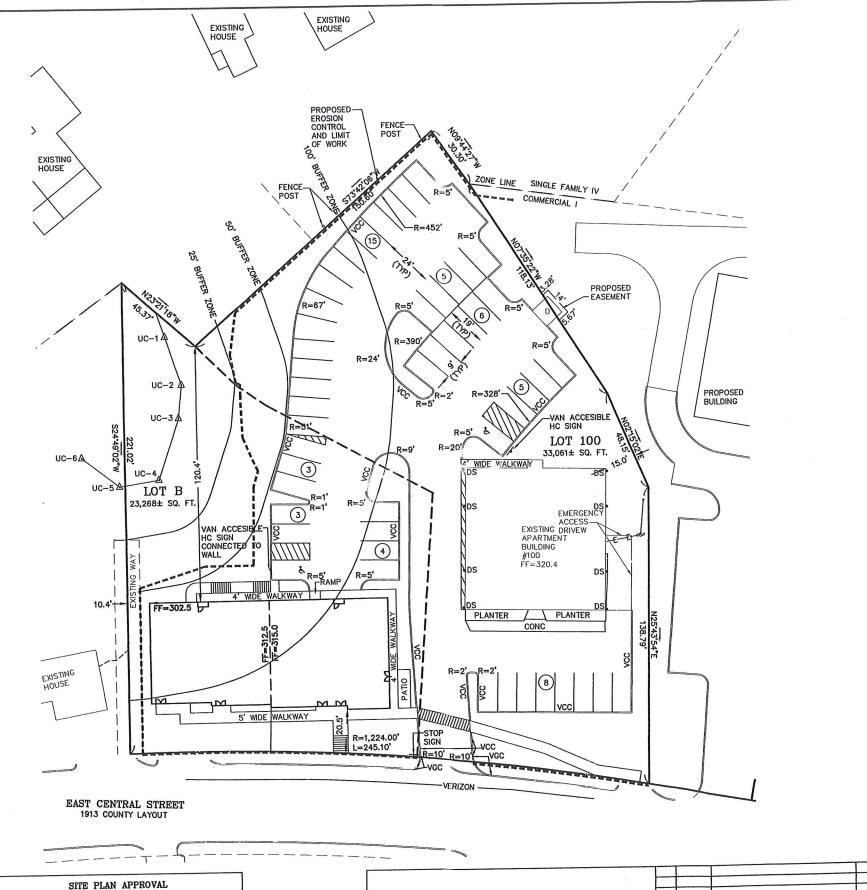
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3			INC	•

850 FRANKLIN STREET SUITE 11D WRENTHAM, MASSACHUSETTS 02093 508-384-6560 FAX 508-384-6566

	DATE
	JAN. 5, 2024
27	SCALE
LO	1" = 100'
	PROJECT
,	UC1587
3	SHEET
	1 of 10



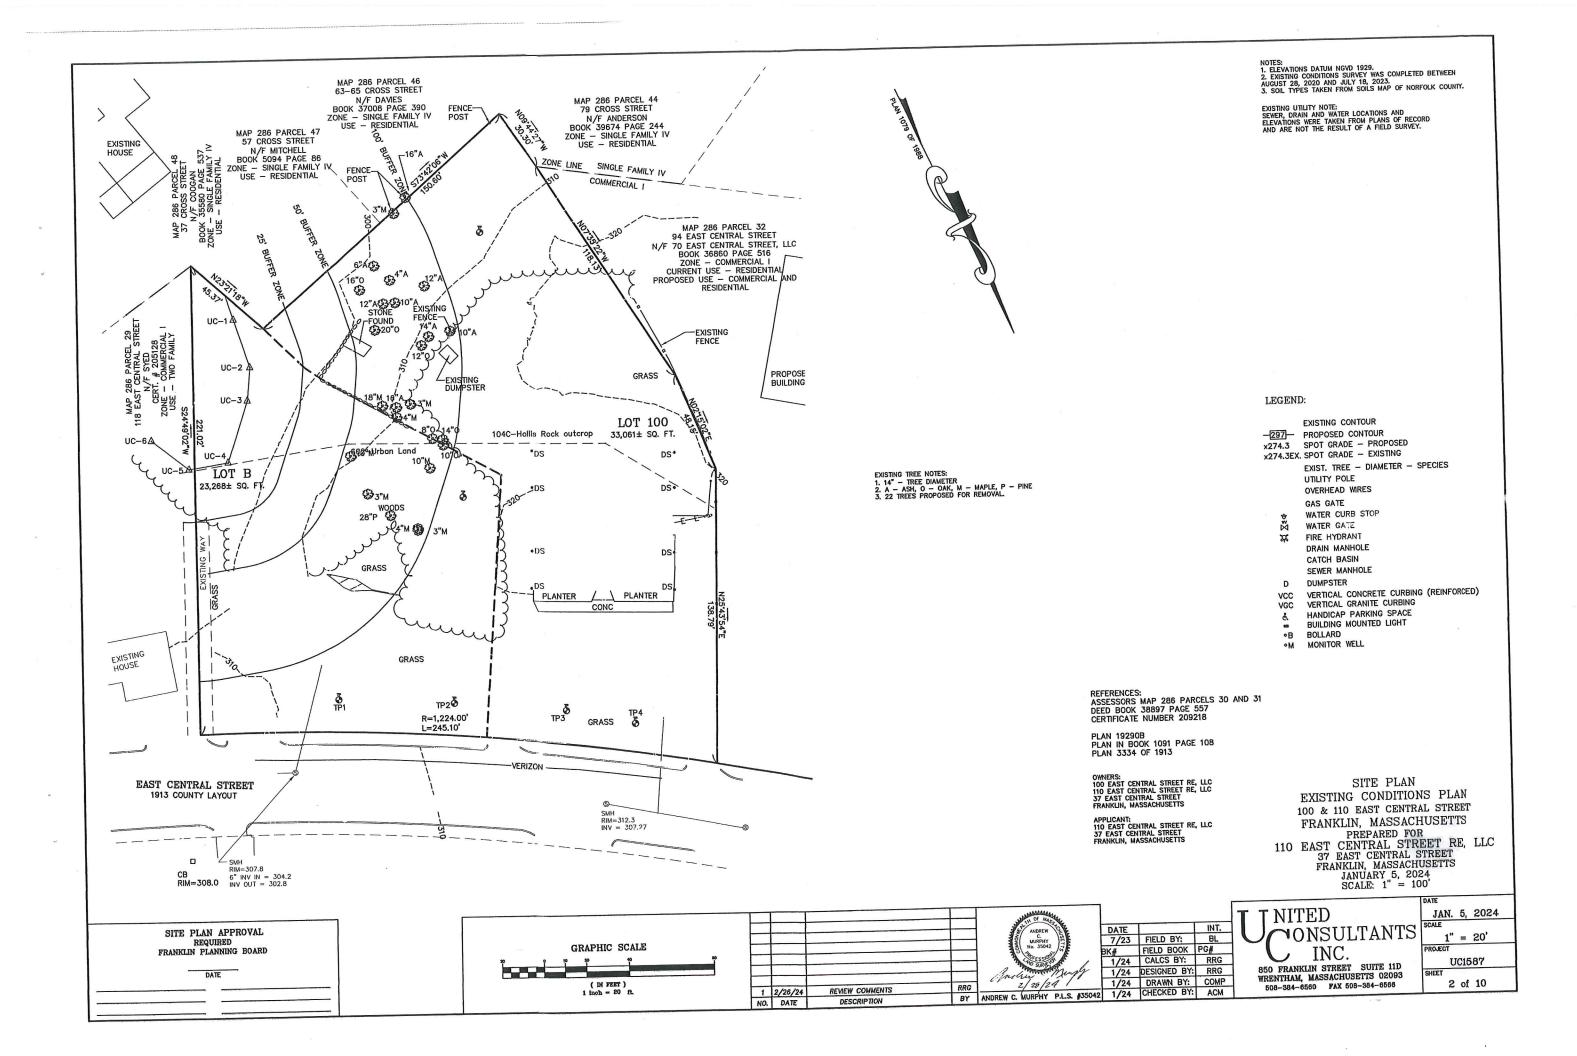

PARKING CALCULATIONS: #100 - #110 EAST CENTRAL STREET COMMERCIAL I REQUIREMENTS (SECTIONS 185-21B.(2)(a) 1.5 SPACES PER DWELLING UNIT
RESIDENTIAL DWELLINGS - 30 x 1.5 = 45

COMMERCIAL I REQUIREMENTS (SECTIONS 185-21B.(2)(b)
COMMERCIAL SPACE (NON RESIDENTIAL USE) 1 SPACE PER 500
SQ. FT. = 949 SQ. FT. / 500 = 2 SPACE REQUIRED

47 SPACES REQUIRED

49 TOTAL SPACES PROVIDED INCLUDING 2 HANDICAP SPACES.

RESIDENTIAL UNIT DENSITY:

1 UNIT PER 2,250 SQ. FT.
56,329 SQ. FT. / 2,250 = 25.03 UNITS
SEE 185 ATTACHMENT 7 NOTE 3.
30 DWELLING UNITS PROPOSED (INCLUDING 10 EXISTING UNITS)
SPECIAL PERMIT REQUIRED.

LEGEND:

EXISTING CONTOUR -297 - PROPOSED CONTOUR x274.3 SPOT GRADE - PROPOSED

x274.3EX. SPOT GRADE - EXISTING EXIST. TREE - DIAMETER - SPECIES

UTILITY POLE OVERHEAD WIRES

GAS GATE WATER CURB STOP

WATER GATE FIRE HYDRANT DRAIN MANHOLE CATCH BASIN

SEWER MANHOLE DUMPSTER

VERTICAL CONCRETE CURBING (REINFORCED)

VERTICAL GRANITE CURBING HANDICAP PARKING SPACE

BUILDING MOUNTED LIGHT ۰B BOLLARD

MONITOR WELL

REFERENCES: ASSESSORS MAP 286 PARCELS 30 AND 31 DEED BOOK 38897 PAGE 557 CERTIFICATE NUMBER 209218

PLAN 19290B PLAN IN BOOK 1091 PAGE 108 PLAN 3334 OF 1913

OWNERS: 100 EAST CENTRAL STREET RE, LLC 110 EAST CENTRAL STREET RE, LLC 37 EAST CENTRAL STREET FRANKLIN, MASSACHUSETTS

SITE PLAN SITE LAYOUT PLAN 100 & 110 EAST CENTRAL STREET FRANKLIN, MASSACHUSETTS PREPARED FOR 110 EAST CENTRAL STREET RE, LLC 37 EAST CENTRAL STREET FRANKLIN, MASSACHUSETTS JANUARY 5, 2024 SCALE: 1" = 100'

T NITED INT. DATE INT.
7/23 FIELD BY: BL ONSULTANTS BK# FIELD BOOK PG# INC. 1/24 CALCS BY: RRG 1/24 DESIGNED BY: RRG

850 FRANKLIN STREET SUITE 11D WRENTHAM, MASSACHUSETTS 02093 508-384-6560 FAX 508-384-6566


JAN. 5, 2024 1" = 20' UC1587 3 of 10

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REQUIRED

FRANKLIN PLANNING BOARD

				CARLOS A CENTER	DATE		INT.
				S OVINTAL	7/23	FIELD BY:	BL
				7 A 3 (2 308) 2 L	BK#	FIELD BOOK	PG#
				74	1/24	CALCS BY:	RRG
				111010	1/24	DESIGNED BY:	RRG
			RRG	11/200 2 210	1/24	DRAWN BY:	COMP
1	2/26/24	REVIEW COMMENTS		CARLOS A. QUINTAL P.E. #30812		CHECKED BY:	CAQ
NO.	DATE	DESCRIPTION	BY	CHILOS A. GOILLINE LIE! BOOLE	1 ./ ~ .		

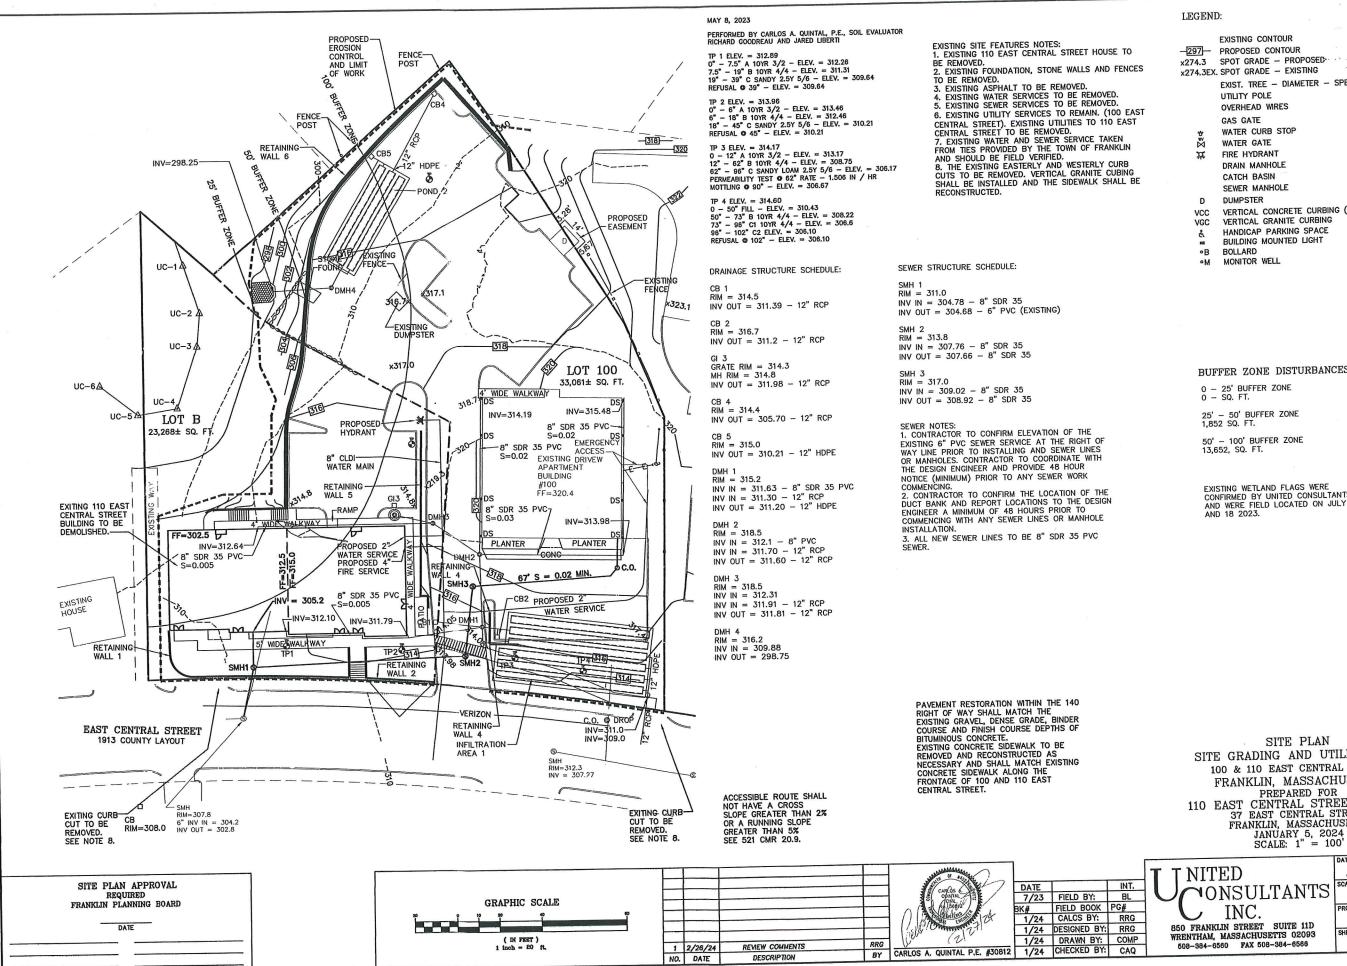

EXISTING CONTOUR -297- PROPOSED CONTOUR x274.3 SPOT GRADE - PROPOSED x274.3EX. SPOT GRADE - EXISTING EXIST. TREE - DIAMETER - SPECIES OVERHEAD WIRES WATER CURB STOP

> DRAIN MANHOLE CATCH BASIN SEWER MANHOLE

VERTICAL CONCRETE CURBING (REINFORCED) VERTICAL GRANITE CURBING

HANDICAP PARKING SPACE BUILDING MOUNTED LIGHT

BUFFER ZONE DISTURBANCES:

25' - 50' BUFFER ZONE 1,852 SQ. FT.


EXISTING WETLAND FLAGS WERE CONFIRMED BY UNITED CONSULTANTS, INC. AND WERE FIELD LOCATED ON JULY 17


SITE PLAN SITE GRADING AND UTILITY PLAN 100 & 110 EAST CENTRAL STREET FRANKLIN, MASSACHUSETTS PREPARED FOR 110 EAST CENTRAL STREET RE, LLC 37 EAST CENTRAL STREET FRANKLIN, MASSACHUSETTS

ONSULTANTS

850 FRANKLIN STREET SUITE 11D WRENTHAM, MASSACHUSETTS 02093

JAN. 5, 2024 1" = 20' PROFCT UC1587 4 of 10

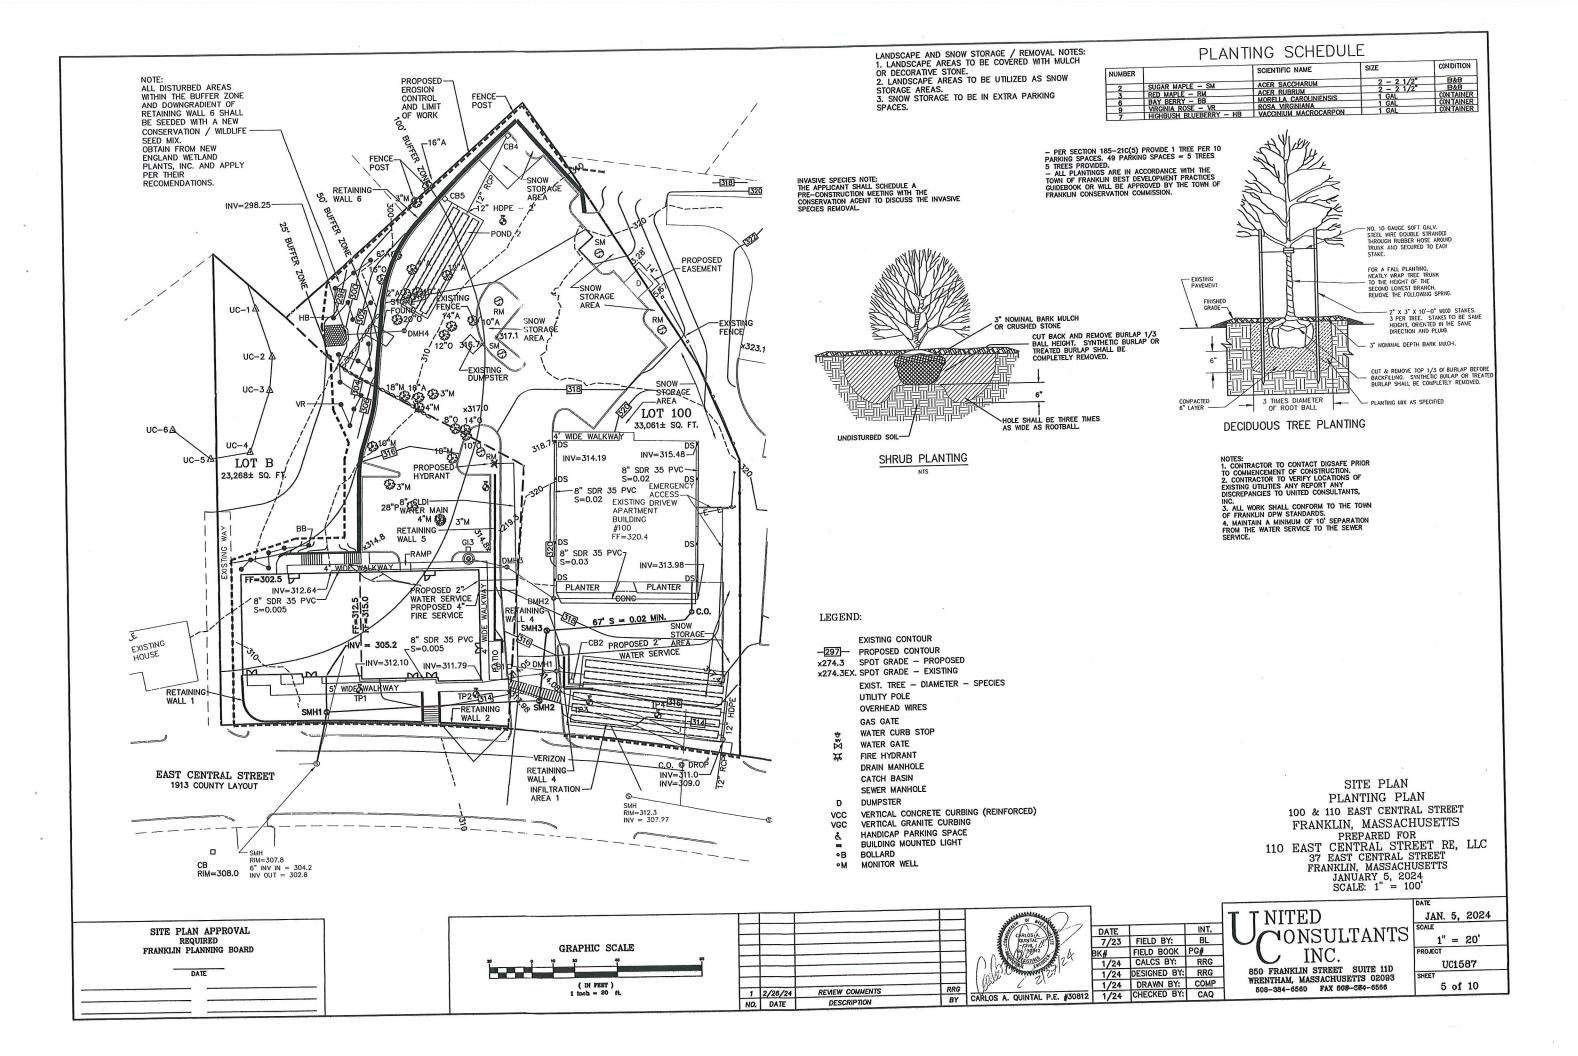

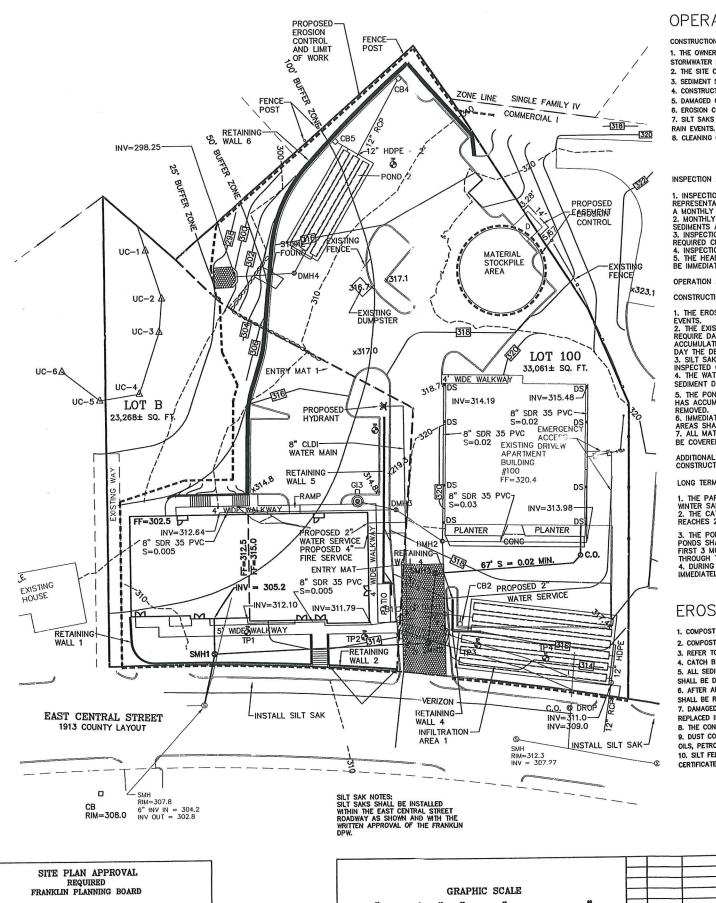

(DI FEET) 1 inch = 20 ft.

DATE

OPERATION AND MAINTENANCE PLAN

CONSTRUCTION PHASE

1. THE OWNERS REPRESENTATIVE, 110 EAST CENTRAL STREET RE, LLC 1-508-507-9020 SHALL BE THE RESPONSIBLE PARTY FOR THE STORMWATER MAINTENANCE PLAN.

2. THE SITE CONTRACTOR SHALL INSPECT ALL EROSION CONTROL MEASURES WEEKLY AND AFTER ALL RAIN EVENTS.

3. SEDIMENT SHALL BE REMOVED FROM COMPOST SOCK WHEN A MAXIMUM DEPTH OF 6" IS OBSERVED OR AS NEEDED.

4. CONSTRUCTION ENTRY MAT SHALL BE INSPECTED WEEKLY AND AFTER ALL RAIN EVENTS. SEE DETAIL FOR MAINTENANCE REQUIREMENTS. 5. DAMAGED OR DETERIORATED COMPOST SOCK AND/OR SILT FENCE AREAS SHALL BE REPLACED IMMEDIATELY.

6. EROSION CONTROL MEASURES SHALL REMAIN IN PLACE UNTIL CONSTRUCTION IS COMPLETED AND ALL DISTURBED AREAS ARE STABILIZED. 7. SILT SAKS SHALL BE INSTALLED AT ALL CATCH BASINS EXISTING AND PROPOSED AND SHALL BE INSPECTED WEEKLY AND AFTER ALL

8. CLEANING OF SILT SAKS SHALL BE COMPLETED AS NECESSARY.

INSPECTION AND MAINTENANCE SCHEDULE:

1. INSPECTIONS SHALL BE CONDUCTED BY THE APPLICANTS ENGINEER, CONTRACTOR AND / OR REPRESENTATIVES OF THE TOWN AS NECESSARY. AT A MINIMUM INSPECTIONS SHALL BE CONDUCTED ON

A MUNIFICY BASIS.

2. MONTHLY INSPECTIONS SHALL INCLUDE THE PARKING LOT SURFACE TO DETERMINE IF ACCUMULATED SEDIMENTS ARE TO BE REMOVED.

3. INSPECTION OF THE PROPOSED CATCH BASINS TO DETERMINE THE DEPTH OF SEDIMENT AND

4. INSPECTION OF PONDS 1 AND 2 TO DETERMINE IF CLEANING IS NECESSARY.

5. THE HEADWALL OUTLET RIPRAP SHALL BE INSPECTED WEEKLY AND ANY SEDIMENT OBSERVED SHALL BE IMMEDIATELY REMOVED.

OPERATION AND MAINTENANCE SCHEDULE

CONSTRUCTION PHASE:

THE EROSION CONTROL BARRIERS SHALL BE INSPECTED ON A WEEKLY BASIS AND AFTER ALL STORM

1. THE ENDSION CONTROL BARKIERS STALL BE INDICED.

2. THE EXISTING PAVED PARKING AREAS AS WELL THE PROPOSED PARKING AREA ONCE PAVED WILL REQUIRE DAILY INSPECTIONS TO BE CONDUCTED TO DETERMINE THE NECESSITY TO REMOVE ANY ACCUMULATED SEDIMENT. THE REMOVAL OF THE ACCUMULATED SEDIMENT SHALL BE COMPLETED ON THE DAY THE DETERMINATION IS MADE.

3. SILT SAKS SHALL BE INSTALLED AT ALL CATCH BASINS. SILT SAKS, ONCE INSTALLED SHALL BE INSPECTED ON A WEEKLY BASIS AND CLEANED AS NECESSARY.

4. THE WATER QUALITY UNIT SHALL BE INSPECTED ON A WEEKLY BASIS AND CLEANED WHEN THE

SEDIMENT DEPTH REACHES 8" 5. THE PONDS SHALL BE INSPECTED AFTER EACH STORM EVENT AND CLEANED WHEN 2" OF SEDIMENT HAS ACCUMULATED AT THE INLET. ANY TRASH OR CONSTRUCTION DEBRIS SHALL BE IMMEDIATELY

REMOVED.
6. IMMEDIATELY UPON COMPLETION OF SITE GRADING ACTIVITIES OF PROPOSED LANDSCAPED AREA, THE AREAS SHALL HAVE LOAM APPLIED AND SHALL BE SEEDED.
7. ALL MATERIAL STOCKPILES THAT ARE NOT BEING ACTIVELY USED FOR A PERIOD OF 2 WEEKS SHALL BE COVERED WITH A TARP(S) OR VEGETATED.

ADDITIONAL EROSION CONTROLS MAY BE REQUIRED DEPENDING ON ACTUAL FIELD CONDITIONS DURING CONSTRUCTION.

1. THE PARKING LOT SHALL BE SWEPT FOUR TIMES PER YEAR WITH ONE BEING AFTER THE LAST SANDING INTER SANDING. .. THE CATCH SHALL BE INSPECTED 4 TIMES PER YEAR AND SEDIMENT REMOVED WHEN THE DEPTH

3. THE PONDS SHALL BE INSPECTED AND PREVENTIVE MAINTENANCE PERFORMED TWICE PER YEAR. THE PONDS SHALL BE INSPECTED AFTER EVERY STORM EVENT EXCEEDING 1 INCH OF RAINFALL FOR THE FIRST 3 MONTHS AND THEN TWICE PER YEAR THEREAFTER AND WHEN THERE ARE DISCHARGES TRADEOLOGY. THROUGH THE HIGH OUTLET. DURING INSPECTIONS OF STORM-WATER FACILITIES ANY TRASH OR DEBRIS DISCOVERED SHALL BE

EROSION CONTROL NOTES:

1. COMPOST SOCK AND SILT FENCE SHALL BE INSTALLED PRIOR TO TREE CLEARING OR SITE WORK COMMENCING.

2. COMPOST SOCK AND SILT FENCE TO REMAIN IN CONTACT WITH THE EARTH. REPAIR OR RESET AS NECESSARY.

3, REFER TO CONSTRUCTION SEQUENCE FOR SLOPE GREATER THAN 3' HORIZONTAL TO 1' VERTICAL.

4. CATCH BASINS, UNDERGROUND POND AND PARKING AREA TO BE CLEANED ONCE CONSTRUCTION IS COMPLETED. 5. ALL SEDIMENT COLLECTED DURING THE CONSTRUCTION PHASE OR POST CONSTRUCTION PHASE SHALL BE DISPOSED OF TO AN APPROVED LOCATION.

6. AFTER ALL DISTURBED AREAS HAVE BEEN STABILIZED THE EROSION CONTROL MEASURES SHALL BE REMOVED.

RRG

CARLOS A. QUINTAL P.E. #30812

7. DAMAGED OR DETERIORATED EROSION CONTROL MEASURES SHALL BE REPAIRED OR

REPLACED IMMEDIATELY AFTER THEY HAVE BEEN IDENTIFIED.

REVIEW COMMENTS

DESCRIPTION

1 2/26/24

B. THE CONTRACTOR SHALL BE RESPONSIBLE FOR ALL INSPECTIONS. 9. DUST CONTROL WILL BE BY SPRAYING WATER AS NECESSARY. THE USE OF

OILS, PETROLEUM PRODUCTS OR TOXIC LIQUIDS FOR DUST CONTROL IS PROHIBITED.

10. SILT FENCE TO BE REMOVED AT THE APPROVAL OF THE CONSERVATION AGENT, PRIOR TO THE ISSUANCE OF A CERTIFICATE OF COMPLIANCE.

LEGEND:

EXISTING CONTOUR

-297- PROPOSED CONTOUR

x274.3 SPOT GRADE - PROPOSED x274.3EX. SPOT GRADE - EXISTING

EXIST. TREE - DIAMETER - SPECIES

UTILITY POLE

OVERHEAD WIRES

GAS GATE

WATER CURB STOP WATER GATE

> FIRE HYDRANT DRAIN MANHOLE

> CATCH BASIN

SEWER MANHOLE

DUMPSTER

VERTICAL CONCRETE CURBING (REINFORCED) VCC VERTICAL GRANITE CURBING

HANDICAP PARKING SPACE

BUILDING MOUNTED LIGHT

°B BOLLARD

MONITOR WELL

CONSTRUCTION SEQUENCE:

1. INSTALL EROSION CONTROL AND SIGN.

2. COMPLETE TREE CLEARING, STUMP REMOVAL AND REMOVE LOAM AND

3.REMOVE EXISTING UTILITIES AND RAZE EXISTING 110 EAST CENTRAL

4. EXCAVATE THE FOUNDATION HOLE. FORM AND POUR THE FOUNDATION AND THEN BACKFILL FOUNDATION.

5. INSTALL SITE UTILITIES. THE STORMWATER SYSTEM SHALL BE INSTALLED WITH EXCESS MATERIAL BEING REMOVED FROM THE SITE AND NECESSARY CONSTRUCTION MATERIALS DELIVERED TO THE SITE, MINIMIZE THE USE OF THE MATERIAL STOCKPILE AREA.


6. CONSTRUCT RETAINING WALLS.

7. BRING THE SITE TO SUB GRADE.

B. INSTALL A BINDER COURSE OF PAVING. CONSTRUCT THE SITE WALKWAYS.

9. CURBING SHALL BE INSTALLED.

10. LANDSCAPING SHALL BE PLANTED AND ALL REMAINING DISTURBED AREAS SHALL BE LOAMED AND SEEDED.

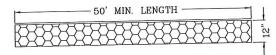

ENTRY SEDIMENTATION CONTROL MAT SECTION

N.T.S.

1. PAD SHALL BE A MINIMUM OF 20 FEET IN WIDTH, EXISTING ASPHALT DRIVE TO REMAIN IN PLACE UNTIL FINAL PAVEMENT IS TO BE INSTALLED. BE INSTALLED. 2. PAD SHALL CONSIST OF 4" STONE 8" MIN. DEPTH AND THEN TOP DRESSED WITH 4" OF 1" - 2" WASHED STONE.

> SITE PLAN EROSION CONTROL PLAN 100 & 110 EAST CENTRAL STREET FRANKLIN, MASSACHUSETTS PREPARED FOR 110 EAST CENTRAL STREET RE, LLC 37 EAST CENTRAL STREET FRANKLIN, MASSACHUSETTS JANUARY 5, 2024 SCALE: 1" = 100'

T NITED INT. ONSULTANTS INC.

850 FRANKLIN STREET SUITE 11D


1/24 DESIGNED BY: RRG


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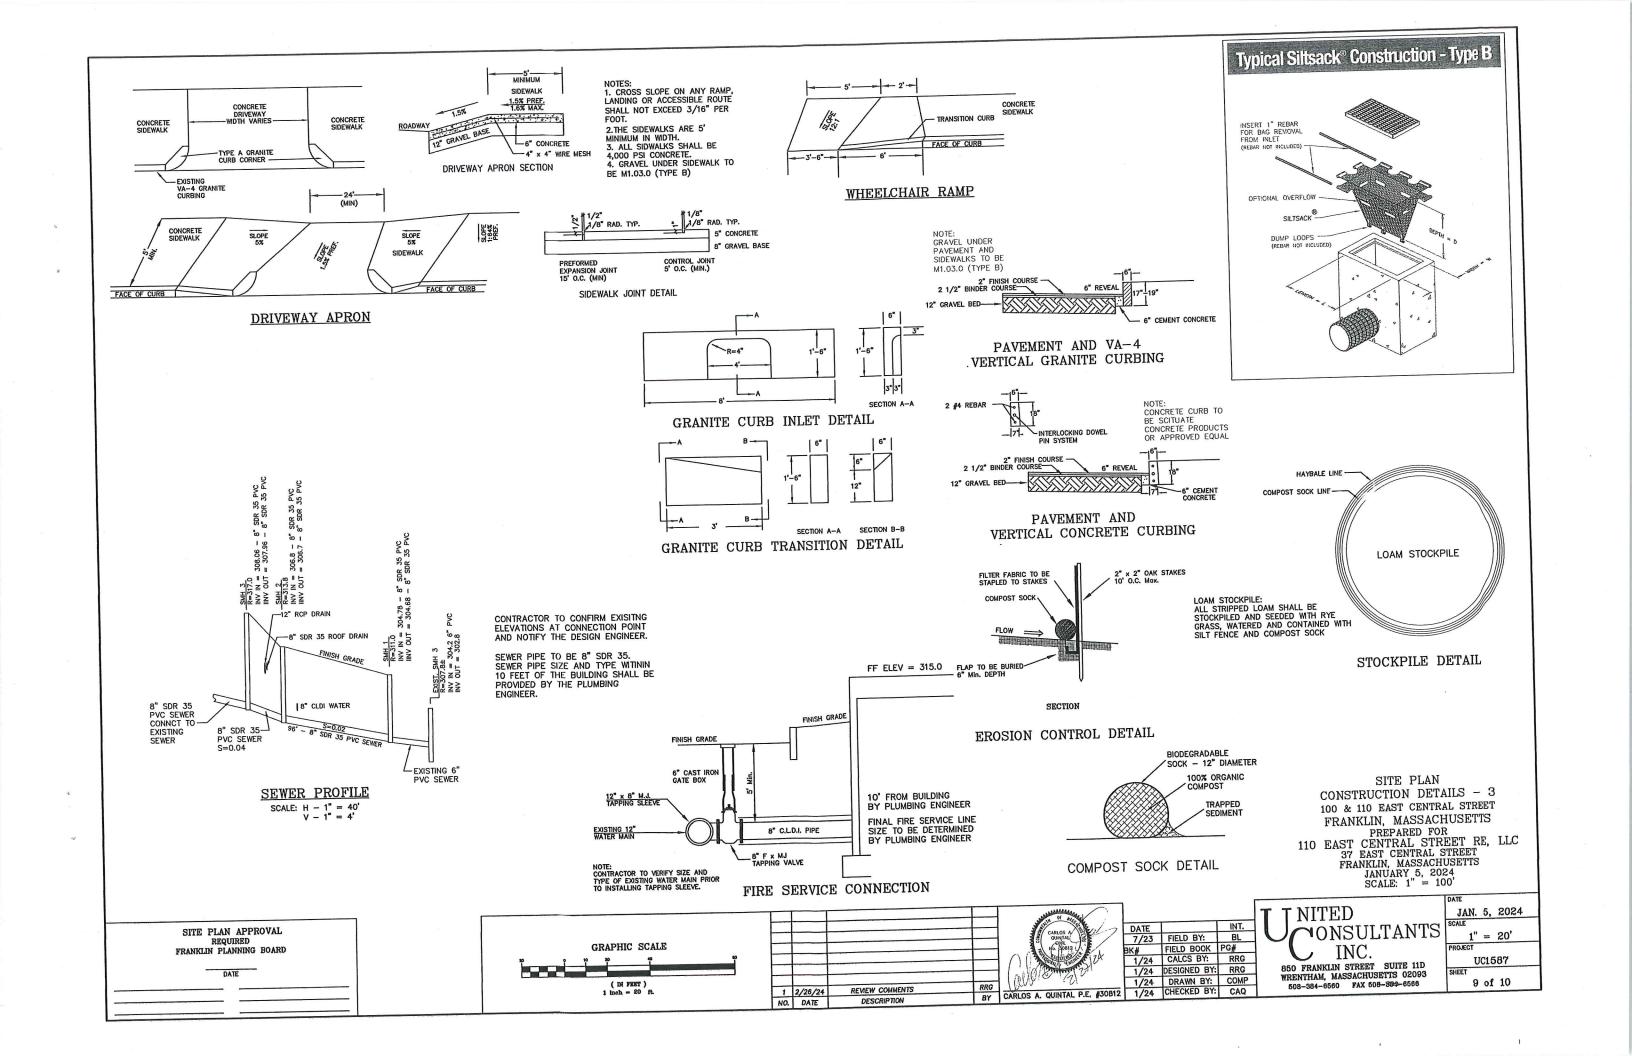
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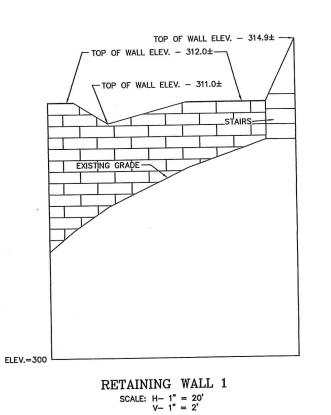
WRENTHAM, MASSACHUSETTS 02093 508-384-8560 FAX 508-384-6566

JAN. 5, 2024 1" = 20' UC1587 6 of 10





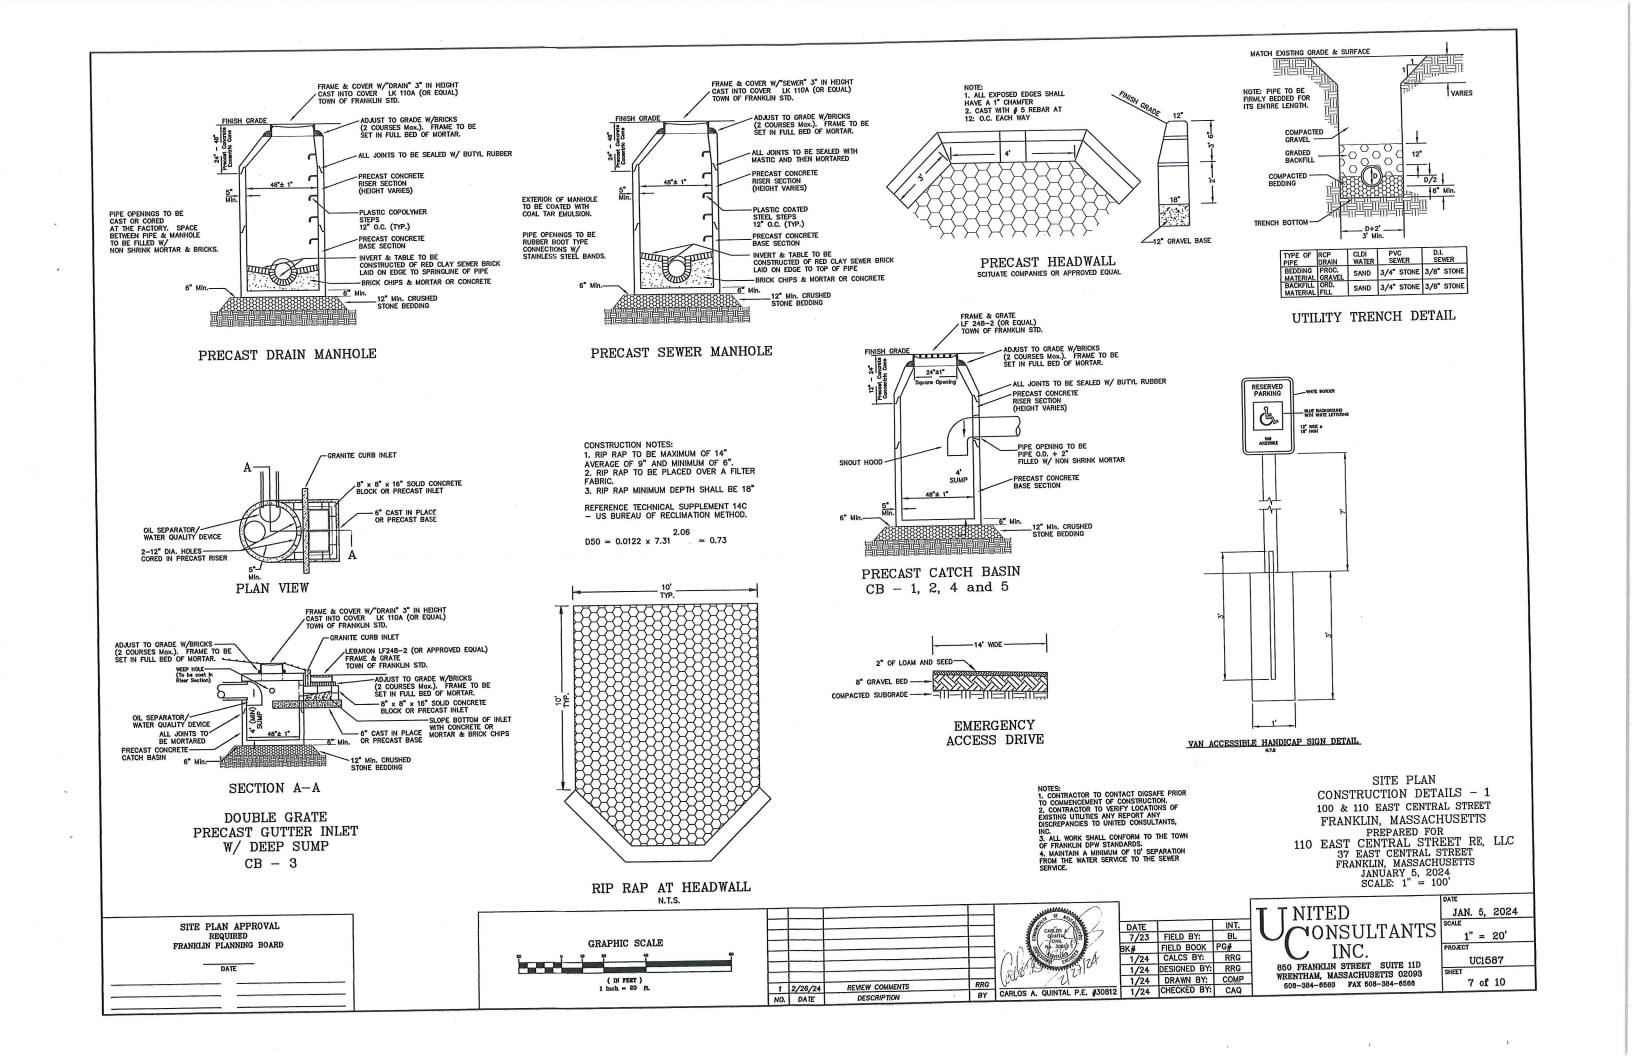

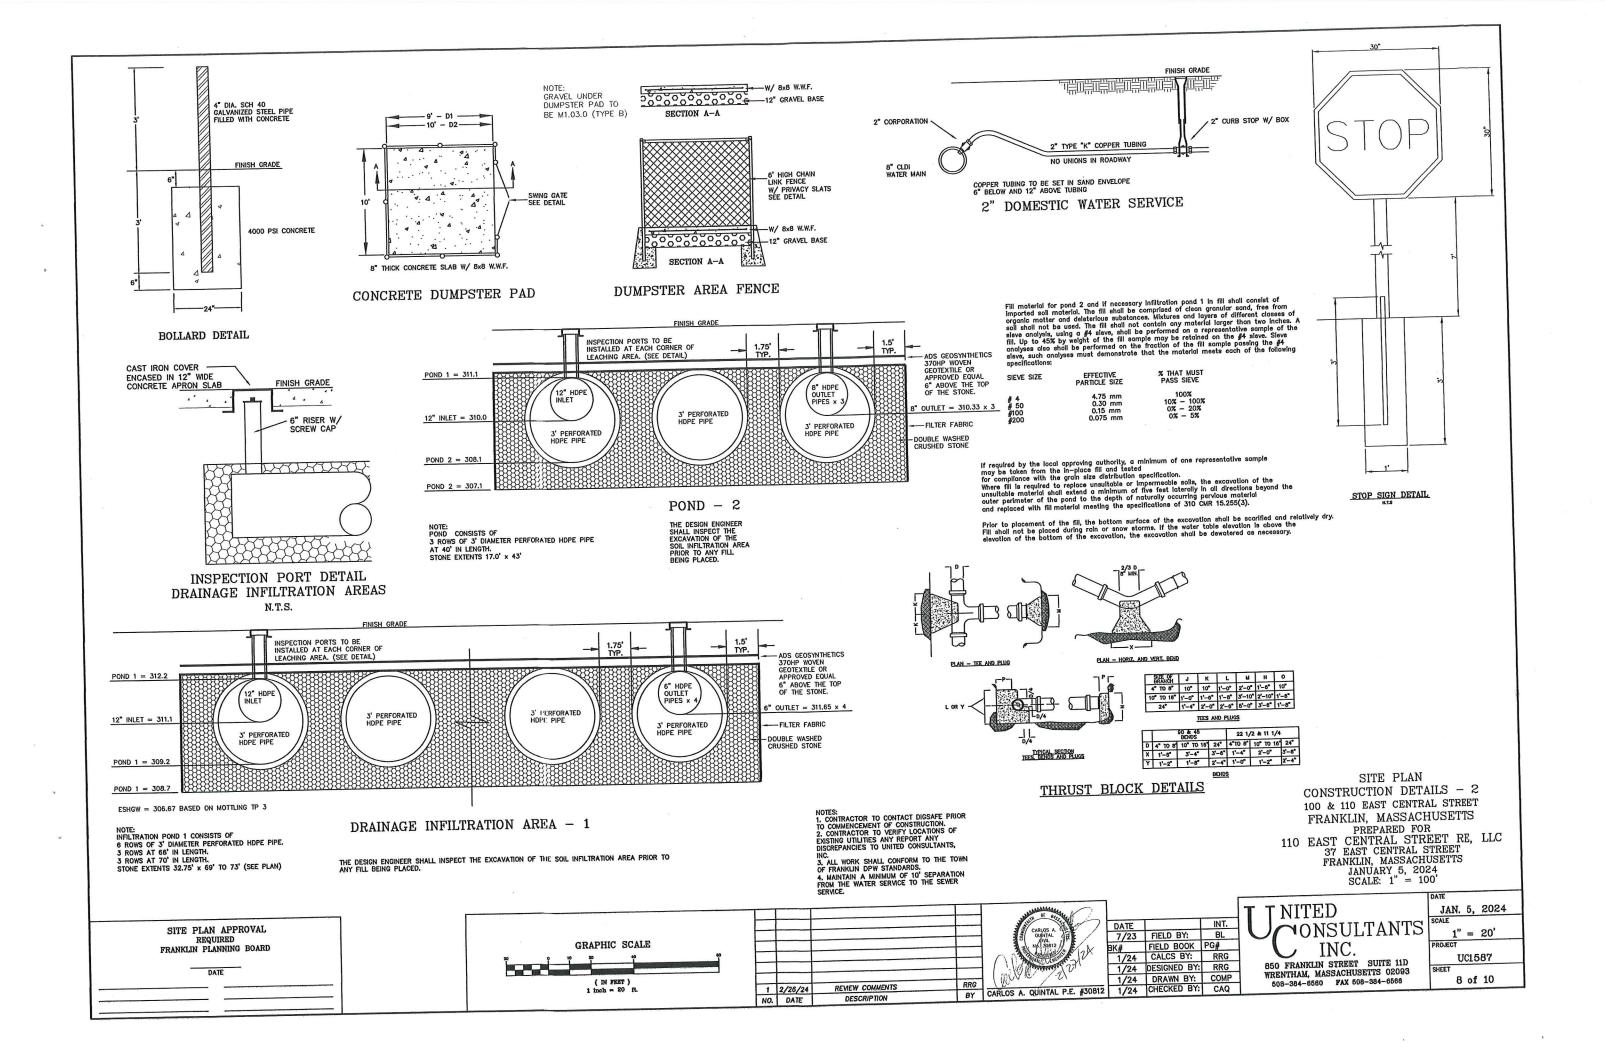

SITE PLAN APPROVAL

REQUIRED FRANKLIN PLANNING BOARD

DATE

RETAINING WALL NOTES:


1. RETAINING WALLS 1, 2, 3 AND 4 SHALL BE
CONSTRUCTED OF STONE.

2. RETAINING WALL 5 SHALL BE SEGMENTAL BLOCK.

3. ALL WALLS REQUIRING A BUILDING PERMIT SHALL
BE DESIGNED BY A STRUCTURAL ENGINEER.

4. ALL WALLS THAT EXCEED FOUR FEET IN HEIGHT
SHALL HAVE A NON-CLIMABLE FENCE.

5. GUARDRAILS SHALL BE PROVIDED AT RETAINING
WALLS 4, 5 AND 6 AND SHALL BE DESIGNED BY THE
WALL STRUCTURAL ENGINEER. WALL STRUCTURAL ENGINEER.

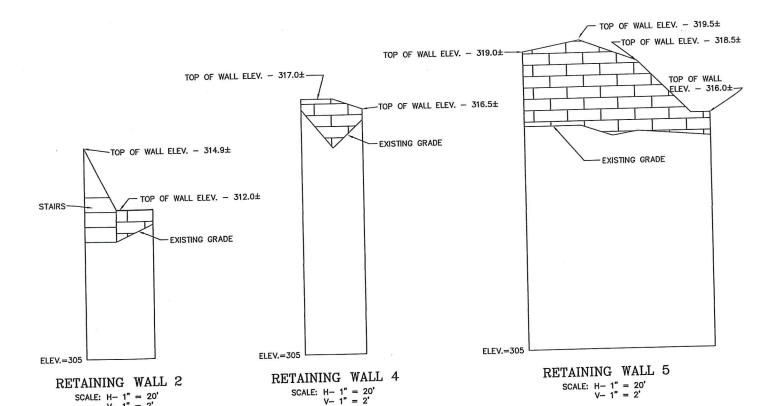

4' WOOD STOCKADE FENCE-**GUARDRAIL** EXISTING GRADE RETAINING WALL 6 SCALE: H- 1" = 20' V- 1" = 2' ELEV.=303

EXISTING DRIVEW
APARTMENT BUILDING RETAINING -FF=320.4 -RAILING-50 S'S' WIDE WALKWAY 314.9 TETAINING WALL 2 RAILING-SITE PLAN CONSTRUCTION DETAILS - 4 100 & 110 EAST CENTRAL STREET FRANKLIN, MASSACHUSETTS PREPARED FOR

110 EAST CENTRAL STREET RE, LLC

37 EAST CENTRAL STREET

FRANKLIN, MASSACHUSETTS

JANUARY 5, 2024

SCALE: 1" = 100' RETAINING-WALL 4 EAST CENTRAL STREET WALKWAY GRADING PLAN SCALE: 1" = 20'

GRAPHIC SCALE (IN FEET) 1 inoh = 20 ft.

REVIEW COMMENTS 1 2/28/24 NO. DATE DESCRIPTION

SCALE: H- 1" = 20' V- 1" = 2'

DATE INT.
7/23 FIELD BY: BL
BK# FIELD BOOK PG#
1/24 CALCS BY: RRG
1/24 DESPRISE RRG RRG UNIVERSITY 1/24 DRAWN BY: COMP
BY CARLOS A. QUINTAL P.E. #30812 1/24 CHECKED BY: CAQ

T NITED JAN. 5, 2024 ONSULTANTS INC. 850 FRANKLIN STREET SUITE 11D WRENTHAM, MASSACHUSETTS 02093

UC1587 10 of 10 508-384-6560 FAX 508-384-6566

1" = 20'