

LOCUS MAP

NOT TO SCALE

APPLICANT/OWNER: TMC HOLDINGS & DEVELOPMENT 2, LLC 25 FORGE PARKWAY FRANKLIN, MA 02038


CIVIL ENGINEER\LANDSCAPE ARCHITECT: ALLEN & MAJOR ASSOCIATES, INC. **400 HARVEY ROAD** MANCHESTER, NH 03103

SURVEYOR: ALLEN & MAJOR ASSOCIATES, INC. 100 COMMERCE WAY **WOBURN, MA 01801**



SITE DEVELOPMENT PLANS FOR 25 FORGE PARKWAY

FRANKLIN, MA 02038 TAX MAP 275, LOT 14

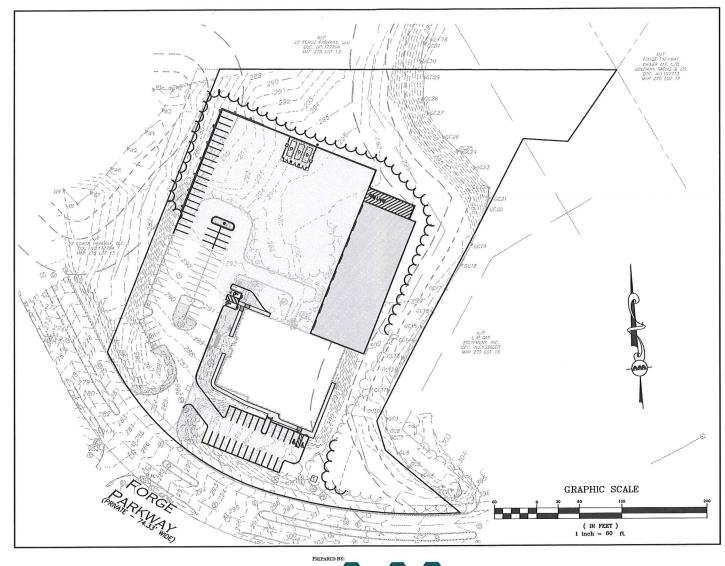





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		LIS	T OF D	RAWI	NGS					
DRAWING TITLE	SHEET NO.	ISSUED	REV 1	REV 2	REV 3	REV 4	REV 5	REV 6	REV 7	REV 8
EXISTING CONDITIONS	V-101	02-21-23	04-04-23	-	1.5		-	-	-	-
EROSION CONTROL & SITE PREPARATION NOTES	C-100	-	04-04-23	04-14-23	05-31-23	-	-	15	12-14-23	-
SITE PREPARATION PLAN	C-101	02-21-23	04-04-23	04-14-23	05-01-23	-	05-18-23	-	12-14-23	-
LAYOUT & MATERIALS PLAN	C-102	02-21-23	04-04-23	04-14-23	05-01-23	•	05-18-23	10-24-23	12-14-23	01-19-24
GRADING & DRAINAGE PLAN	C-103	02-21-23	04-04-23	04-14-23	05-01-23	05-11-23	05-18-23		12-14-23	-
UTILITIES PLAN	C-104	12-14-23	•	-	-		-	•	-	-
LIGHTING PLAN	C-105	02-21-23	04-04-23	04-14-23	05-01-23	-	-		12-14-23	-
SITE PLAN & CROSS-SECTION	C-201		-	04-14-23	05-01-23	05-11-23	-		12-14-23	-
DETAILS	C-501	02-21-23	04-04-23	04-14-23	05-01-23	-			12-14-23	01-19-24
DETAILS	C-502	02-21-23	04-04-23	04-14-23	05-01-23	05-11-23			12-14-23	-
DETAILS	C-503	02-21-23	04-04-23	04-14-23	05-01-23	05-11-23	-	-	12-14-23	-
DETAILS	C-504	12-14-23	-					-		
DETAILS	C-505	12-14-23	01-19-24	-	-	-		-	-	-
LANDSCAPE PLAN	L-101		04-04-23	04-14-23	05-01-23		-	-	12-14-23	01-19-24
LANDSCAPE NOTES & DETAILS	L-501	-	04-04-23	04-14-23	05-01-23	-	-		12-14-23	-
LANDSCAPE NOTES & DETAILS	L-502	12-14-23	-	-	-	-	-		-	-

CERTIFICATE OF VOTE / CONDITIONS OF APPROVAL

PLEASE BE ADVISED THAT AT ITS MEETING ON MONDAY, FEBRUARY 5, 2024 THE PLANNING BOARD VOTED (3-0), UPON MOTION DULY MADE AND SECONDED TO APPROVE, WITH CONDITIONS, THE SITE PLAN SHOWN HEREON. THE CONDITIONS OF APPROVAL ARE LISTED BELOW.

- THE PLANNING BOARD WILL USE OUTSIDE CONSULTANT SERVICE TO COMPLETE CONSTRUCTION INSPECTIONS UPON THE COMMENCEMENT OF CONSTRUCTION. THE FRANKLIN DEPARTMENT OF PUBLIC WORKS DIRECTOR, DIRECTLY AND THROUGH EMPLOYEES OF THE DEPARTMENT OF PUBLIC WORKS AND OUTSIDE CONSULTANT SERVICES SHALL ACT AS THE PLANNING BOARD'S INSPECTIOR TO ASSIST THE BOARD WITH INSPECTIONS NECESSARY TO ENSURE COMPLIANCE WITH ALL RELEVANT LAWS, REGULATIONS AND PLANNING BOARD APPROVED PLAN SPECIFICATIONS. SUCH CONSULTANTS SHALL BE SELECTED AND RETAINED UPON A MAJORITY VOTE OF THE BOARD.
- 2. ACTUAL AND REASONABLE COSTS OF INSPECTION CONSULTING SERVICES SHALL BE PAID BY THE OWNER/APPLICANT BEFORE OR AT THE TIME OF THE PRE-CONSTRUCTION MEETING. SHOULD ADDITIONAL INSPECTIONS BE REQUIRED BEYOND THE ORIGINAL SCOPE OF WORK, THE OWNER/APPLICANT SHALL BE REQUIRED TO SUBMIT FEES PRIOR TO THE ISSUANCE OF A FINAL CERTIFICATE OF COMPLETION BY THE PLANNING BOARD (FORM H). SAID INSPECTION IS FURTHER OUTLINED IN CONDITION #1.
- NO ALTERATION OF THESE PLANS SHALL BE MADE OR AFFECTED OTHER THAT BY AN AFFIRMATIVE VOTE OF THE MEMBERS OF THE BOARD AT A DULY POSTED MEETING AND UPON THE ISSUANCE OF A WRITTEN AMENDED DECISION.
- 4. ALL APPLICABLE LAWS , BY-LAWS, RULES, REGULATIONS, AND CODES SHALL BE COMPLIED WITH, AND ALL NECESSARY LICENSES, PERMITS AND APPROVALS SHALL BE OBTAINED BY THE OWNER/APPLICANT.
- PRIOR TO THE ENDORSEMENT OF THE SITE PLAN. THE FOLLOWING SHALL BE DONE: PRIOR TO THE ENDORSEMENT OF THE SITE PLAN, THE FOLLOWING SHALL BE DONE:

 THE OWNER/APPLICANT SHALL PROVIDE THE ENTIRE LIST OF CONDITIONS AND THIS CERTIFICATE OF

 VOTE ON THE FRONT PAGE OF THE PLANS.

 A NOTATION SHALL BE MADE ON THE PLANS THAT ALL EROSION MITIGATION MEASURES SHALL BE
 IN PLACE PRIOR TO MAJOR CONSTRUCTION OR SOIL DISTURBANCE COMMENCING ON THE SITE.

 ALL OUTSTANDING INVOICES FOR SERVICES RENDERED BY THE TOWN'S ENGINEERS AND OTHER
- REVIEWING DEPARTMENTS OF THE TOWN RELATIVE TO THEIR REVIEW OF THE OWNER/APPLICANT'S APPLICATION AND PLANS SHALL HAVE BEEN PAID IN FULL.
- ALL REQUIRED IMPROVEMENTS SPECIFIED IN THIS CERTIFICATE OF VOTE SHALL BE CONSTRUCTED WITHIN A ONE-YEAR PERIOD UNLESS THE BOARD GRANTS AN EXTENSION. NO FINAL CERTIFICATE OF OCCUPANCY SHALL BE ISSUED UNTIL ALL REQUIREMENTS OF THE APPROVED PLAN HAVE BEEN COMPLETED TO THE SATISFACTION OF THE BOARD UNLESS THE APPLICANT HAS SUBMITTED A PARTIAL CERTIFICATE OF COMPLETION FOR THE REMAINDER OF THE REQUIRED IMPROVEMENTS. THE APPLICANT'S ENGINEER OR SURVEYOR, UPON COMPLETION OF ALL REQUIRED IMPROVEMENTS, SHALL SUBMIT A CERTIFICATE OF COMPLETION. THE BOARD OR ITS AGENT(S) SHALL COMPLETE A FINAL INSPECTION OF THE SITE UPON FILING OF THE CERTIFICATE OF COMPLETION BY THE APPLICANT. SAID INSPECTION IS FURTHER OUTLINED, IN CONDITION \$1 FURTHER OUTLINED IN CONDITION #1.
- PRIOR TO ANY WORK COMMENCING ON THE SUBJECT PROPERTY, THE OWNER/APPLICANT SHALL PROVIDE PLANS TO LIMIT CONSTRUCTION DEBRIS AND MATERIALS ON THE SITE. IN THE EVENT THAT DEBRIS IS CARRIED ONTO ANY PUBLIC WAY, THE OWNER/APPLICANT AND HIS ASSIGNS SHALL BE RESPONSIBLE FOR ALL CLEANUP OF THE ROADWAY. ALL CLEANUPS SHALL OCCUR WITHIN TWENTY-FOUR (24) HOURS AFTER FIRST WRITTEN NOTIFICATION TO THE OWNER/APPLICANT BY THE BOARD OR ITS DESIGNEE. FAILURE TO COMPLETE SUCH CLEANUP MAY RESULT IN SUSPENSION OF CONSTRUCTION OF THE SITE UNTIL SUCH PUBLIC WAY IS CLEAR OF DEBRIS.
- 8 THE OWNER/APPLICANT SHALL INSTALL EROSION CONTROL DEVICES AS NECESSARY AND AS DIRECTED
- MAINTENANCE AND REPAIR OF THE PARKING AREA, WATER SUPPLY SYSTEM, SEWER PIPES, ELECTRIC DISTRIBUTION SYSTEM, AND STORM WATER SYSTEM SHALL BE THE RESPONSIBILITY OF THE OWNER/APPLICANT AND SHALL NEVER BE THE RESPONSIBILITY OF THE TOWN AND THE TOWN SHALL NEVER BE REQUIRED TO PERFORM ANY SERVICE, REPAIR OR MAINTENANCE WITH RESPECT TO SAID AREAS, OR ANY OF THE AFOREMENTIONED SYSTEMS WITHIN THE SUBJECT PROPERTY. THE TOWN WILL NEVER BE REQUIRED TO PROVIDE SNOW PLOWING OR TRASH PICKUP, WITH RESPECT TO THE SUBJECT PROPERTY.
- 10. PRIOR TO CONSTRUCTION ACTIVITIES, THERE SHALL BE A PRE-CONSTRUCTION MEETING WITH THE OWNER/APPLICANT, AND HIS CONTRACTOR(S), THE DEPARTMENT OF PUBLIC WORKS AND THE PLANNING
- 11. SITE PLANS MUST BE ENDORSED BY THE PLANNING BOARD PRIOR TO THE PRE-CONSTRUCTION MEETING

1. SECTION 300-11.B(2.o) - TO ALLOW THE USE OF HDPE PIPE IN LIEU OF REINFORCED CONCRETE

ISSUED FOR INITIAL REVIEW: FEBRUARY 21, 2023

REVISION 1: APRIL 4, 2023

REVISION 2: APRIL 14, 2023

REVISION 3: MAY 1, 2023


REVISION 4: MAY 11, 2023

REVISION 5: MAY 18, 2023

FINAL SITE PLAN: OCTOBER 24, 2023

ISSUED FOR SITE PLAN AMENDMENT: DECEMBER 14, 2023 **REVISED PER REVIEW COMMENTS: JANUARY 19, 2024**

FINAL SITE PLAN: FEBRUARY 9, 2024

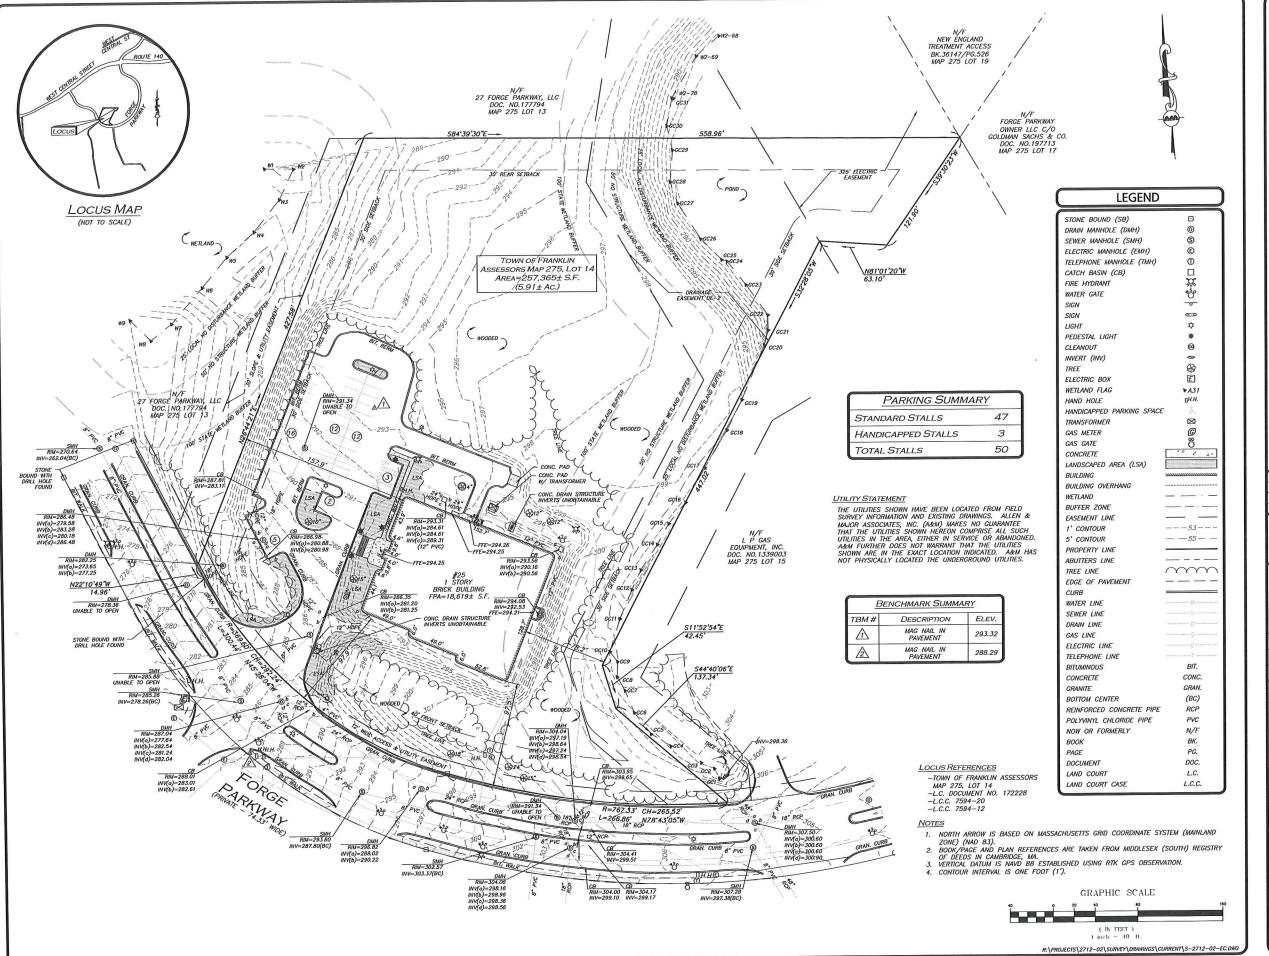

WE HEREBY CERTIFY THAT THIS PLAN IS THE RESULT OF AN ACTUAL ON THE GROUND SURVEY PERFORMED ON OR BETWEEN APRIL 1, 2021 AND FEBRUARY 15, 2023.

APR. 4, 2023

PROFESSIONAL LAND SURVEYOR FOR ALLEN & MAJOR ASSOCIATES, INC.



1.	04/04/23	PEER REVIEW COMMENTS
REV	DATE	DESCRIPTION

GREEN SITE SERVICES GROUP 24 WILLIAM WAY BELLINGHAM, MA 02019

PROJECT

25 FORGE PARKWAY FRANKLIN, MA

PROJECT NO.	2712-02	DATE:	2/15/23
SCALE:	1" - 40'	DWG. NAME:	S-2712-02-EC
DRAFTED BY:	AJR	CHECKED BY:	NIL



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DRAWING TITLE: SHEET NO.

EXISTING CONDITIONS V-101

AREAS OF EXPOSED SOIL UNDERGOING CONSTRUCTION THAT WILL NOT BE COVERED AND OR FINISHED GRADED SHALL BE STABILIZED AS SOON AS PRACTICABLE BUT IN NO CASE MORE THAN 14 DAYS AFTER THE CONSTRUCTION ACTIVITY (UNLESS MUNICIPALITY HAS STRICTER REQUIREMENTS WHICH SHALL BE FOLLOWED) IN THAT PORTION OF THE SITE HAS TEMPORARILY OR PERMANENTLY CEASED. TEMPORARY EROSION CONTROL MEASURES SHALL INCLUDE EROSION CONTROL MEASURES SHALL INCLUDE EROSION CONTROL MESH, NETTING OR MULCH AS DIRECTED BY THE OWNER'S REPRESENTATIVE AND SHOWN ON THE DESIGN PLANS. IF MULCH IS USED, STRAW MULCH SHALL BE APPLIED AT THE RATE OF 4 BALES PER 1,000 SQUARE FEET. APPLICATION AREA SHALL BE SUFFICIENTLY COVERED WITH MULCH TO AVOID ANY VISIBLE SOIL EXPOSURE. MULCH SHALL BE KEPT MOIST TO AVOID LOSS DUE TO WIND. MULCH AND NETTING SHALL BE APPLIED IN THE BASE OF ALL GRASSED WATERWAYS, IN VEGETATIVE SLOPES WHICH EXCEED 15% AND DISTURBED AREAS WITHIN 100 FEET OF WETLANDS OR STREAMS.

IF DISTURBED AREAS DO NOT RECEIVE FINAL SEEDING BY OCTOBER 1ST OF THE CONSTRUCTION YEAR, THEN ALL DISTURBED AREAS SHALL BE SEEDED WITH A WINTER COVER CROP AT THE RATE OF 3 LBS PER 1,000 SQUARE FEET. WINTER SEEDING SHALL BE COVERED WITH EROSION CONTROL MESH (MULCH AND NETTING). HEAVY GRADE MATS SHALL BE USED IN THE BASE OF ALL GRASSED WATERWAYS ON VEGETATED SLOPES IN EXCESS OF 15%, AND ANY DISTURBED AREAS WITHIN 100 FEET OF WETLANDS OR STREAMS. MULCH AND NETTING SHALL ALSO BE PROVIDED FOR ADDITIONAL WINTER PROTECTION.

ALL TOPSOIL SHALL BE COLLECTED, STOCKPILED, SEEDED WITH RYE AT 3LBS PER 1,000 SQUARE FOOT AND MULCHED, AND REUSED AS REQUIRED. TUBULAR BARRIERS SHALL BE PLACED DOWN GRADIENT FROM STOCKPILED LOAM. LOAM SHALL BE STOCKPILED AT LOCATIONS DESIGNATED BY THE OWNER AND ENGINEER.

ALL TUBULAR BARRIERS, SILT SACKS, AND EROSION CONTROL BERMS SHALL BE INSTALLED ACCORDING TO THE SITE PREPARATION PLAN. THESE SHALL BE MAINTAINED DURNING DEVELOPMENT TO REMOVE SEDIMENT FROM RUNDOF WATER. ALL THE FILTER BARRIERS AND EROSION CONTROL BERMS SHALL BE INSPECTED AFTER ANY RAINFALL OR RUNDOF EVENT, MAINTAINED AND CLEANED UNTIL ALL AREAS HAVE AT LEAST 85–90% VIGOROUS PERENNIAL COVER OF GRASSES.

ADJACENT ROADS SHALL BE PERIODICALLY SWEPT OR WASHED TO AVOID TRACKING MUD, ADJACENT ROADS SHALL BE PERIODICALL SWEP! ON WASHEU IN AVOID INVESTIGATION OF THE CONSTRUCTION AREA AS OFTEN AS NECESSARY (WHICH COULD BE ON A DAILY BASIS) TO REMOVE ANY SOIL OR SEDIMENTS AT NO ADDITIONAL COST TO THE OWNER. A WATERING TRUCK WILL BE USED TO PERIODICALLY SPRINKLY CONSTRUCTION AREAS IN ORDER TO KEEP THE LEVEL OF DUST TO A MINIMUM DURING MONTHS AT NO ADDITIONAL COST TO THE OWNER.

THE CONTRACTOR SHALL USE EXTREME CAUTION TO AVOID ALLOWING SEDIMENTS TO ENTER THE STORM DRAIN SYSTEM DURING CONSTRUCTION. BOTH EXISTING AND PROPOSED CATCH BASIN INLETS SHALL BE PROTECTED DURING CONSTRUCTION BY THE PROPOSED CATCH BASIN INLETS SHALL BE PROTECTED SOUTH OF THE USE SILT SACKS AND/OR TUBULAR BARRIERS AROUND EACH INLET AS NOTED ON THE PLANS. INLET PROTECTION MAY BE REMOVED ONLY AFTER FINISHED AREAS ARE PAVED AND THE VEGETATED SLOPES ARE ESTABLISHED WITH AT LEAST 85-90% OF VIGOROUS CORNELL CORNELL.

AS APPLICABLE, EROSION CONTROL MESH SHALL BE APPLIED IN ACCORDANCE WITH THE PLANS OVER ALL FINISHED SEEDED AREAS AS SPECIFIED ON THE DESIGN PLANS.

9. AT A MINIMUM, ALL TUBULAR BARRIERS AND FILTER FABRIC SHALL REMAIN IN PLACE UNTIL SEEDINGS OR PLANTINGS HAVE BECOME 85-90% ESTABLISHED. THE LOCAL CONSERVATION COMMISSION MUST APPROVE THE REMOVAL OR RELOCATION OF ANY OF THE TUBULAR BARRIERS AND FILTER FABRIC. ONCE THE TUBULAR BARRIERS ARE REMOVED THE AREAS ARE TO BE LOAMED AND SEEDED TO ACHIEVE FULL STABILIZATION.

AT THE OWNER'S DISCRETION ADDITIONAL EROSION CONTROL MEASURES MAY BE REQUIRED TO MAINTAIN STABILITY OF EARTHWORKS AND FINISHED GRADED AREAS. THE CONTRACTOR, AT HIS EXPENSE, WILL BE RESPONSIBLE FOR PROVIDING AND INSTALLIGHT ANY ADDITIONAL MEASURES AS SPECIFIED BY THE OWNER. THIS INCLUDES BUT IS NOT LIMITED TO REQUESTS BY MA DEP, THE ENGINEER AND THE LOCAL MUNICIPALITY, AS AUTHORIZED BY THE OWNER, FAILURE TO COMPLY WITH THE OWNER'S DIRECTIONS WILL RESULT IN DISCONTINUATION OF CONSTRUCTION ACTIVITIES.

INSPECTIONS AND MONITORING MAINTENANCE MEASURES SHALL BE APPLIED AS NEEDED DURING THE ENTIRE CONSTRUCTION CYCLE. WEEKLY INSPECTIONS SHALL BE HELD THROUGH THE DURATION OF CONSTRUCTION ACTIVITY. WEEKLY INSPECTION REPORTS SHALL BE MAINTAINED BY THE CONTRACTOR AND LOCATED IN THE CONTRACTORS FIELD OFFICE ONSITE. IN ADDITION TO THE NORMAL WEEKLY INSPECTIONS, THE CONTRACTOR SHALL PERFORM AN INSPECTION OF ALL EROSION CONTROL MEASURES AFTER EACH RAINFALL OF 0.25° OR MORE, AND PERFORM THE NECESSARY REPAIRS. THE INSPECTIONS SHALL INCLUDE BUT NOT BE LIMITED TO THE SITE'S DOWN STREAM DISCHARGE POINTS.

12. IF ANY EVIDENCE OF SEDIMENTATION IS OBSERVED AT THE STORMWATER MANAGEMENT AREA INLETS, THE CONTRACTOR SHALL, AT HIS OWN EXPENSE, PROVIDE A PLAN TO THE ENGINEER TO REMOVE ANY ACCUMULATED SEDIMENT IN THESE AREAS. THE CONTRACTOR SHALL ALSO IMMEDIATELY PROVIDE ADDITIONAL ON SITE EROSION AND SEDIMENTATION CONTROL MEASURES TO PREVENT FURTHER DEGRADATION OF THE AREA.

13. FOLLOWING THE TEMPORARY OR FINAL SEEDINGS, THE CONTRACTOR SHALL INSPECT THE WORK AREA SEMI-MONTHLY TO ENSURE THE AREAS HAVE A MINIMUM OF 85-90% VEGETATED VIGOROUS GROWTH, RE-SEEDING SHALL BE CARRIED OUT BY THE CONTRACTOR WITH FOLLOW UP INSPECTIONS IN THE EVENT OF ANY FAILURES LINTIL VEGETATION IS ADEQUATELY ESTABLISHED.

14. CONTRACTOR & ALL SITE SUBCONTRACTORS SHALL BE FAMILIAR WITH & FOLLOW ALL APPROVED PERMITS AND CONDITIONS. CONTRACTOR SHALL MAINTAIN A COPY OF ALL APPROVED PERMITS ONSITE. ALL CONDITIONS & RECOMMENDATIONS WITHIN THE APPROVED PERMITS SHALL BE COMPLETED.

ALL EROSION MEASURES SHALL BE INSTALLED PRIOR TO CONSTRUCTION AND SHALL BE ADEQUATE TO MAINTAIN SEDIMENT ON SITE. ANY MODIFICATIONS SHALL BE INSTALLED AS DIRECTED BY THE ENGINEER OR THE LOCAL MUNICIPALITY.

EROSION AND SEDIMENTATION CONTROL MEASURES SHALL BE MAINTAINED DURING CONSTRUCTION, AND SHALL REMAIN IN PLACE UNTIL ALL SITE WORK IS COMPLETE AND GROUND COVER IS ESTABLISHED.

17. TOP OF STOCKPILES SHALL BE COVERED IN SUCH MANNER THAT STORMWATER DOES NOT INFILTRATE THE MATERIALS AND THEREBY RENDER THE SAME UNSUITABLE FOR

EROSION & SEDIMENTATION CONTROL NOTES (CONTINUED):

18. ALL DISTURBED OR EXPOSED AREAS SUBJECT TO EROSION SHALL BE STABILIZED WITH MULCH OR SEEDED FOR TEMPORARY VEGETATIVE COVER. NO AREA, SUBJECT TO EROSION SHALL BE LEFT DISTURBED AND UNSTABILIZED FOR PERIODS LONGER THAN IS ABSOLUTELY NECESSARY TO CARRY OUT THAT PORTION OF THE CONSTRUCTION WORK OR SIX MONTHS AFTER SOIL HAS BEEN DISTURBED WHICHEVER IS LESS.

19. CULVERT/PIPE INLETS AND OUTFALLS SHALL BE PROTECTED BY TUBULAR BARRIER FILTERS AND STONE CHECK DAMS UNTIL DISTURBED AREAS ARE PERMANENTLY STABILIZED.

TUBULAR BARRIER DIKES SHALL BE CONSTRUCTED AT ALL EXISTING & PROPOSED CATCH BASINS. NO SEDIMENTATION SHALL ENTER THE ON-SITE OR OFF-SITE DRAINAGE SYSTEMS AT ANY TIME.

ALL EROSION CONTROL MEASURES SHALL BE ROUTINELY INSPECTED, CLEANED AND REPAIRED OR REPLACED AS NECESSARY THROUGHOUT ALL PHASES OF CONSTRUCTION. IN ADDITION, INSPECTIONS SHALL TAKE PLACE WEEKLY AND BEFORE AND AFTER EACH RAINFALL EVENT.

22. ALL PROPOSED SLOPES STEEPER THAN 3:1 SHALL BE STABILIZED WITH JUTE MESH AND PROTECTED FROM EROSION UNTIL WORK IS COMPLETE AND GROUND COVER IS ESTABLISHED.

THE CONTRACTOR SHALL KEEP ON SITE AT ALL TIMES ADDITIONAL TUBULAR BARRIERS FOR INSTALLATION AT THE DIRECTION OF THE ENGINEER OR THE TOWN ENGINEER TO MITIGATE ANY EMERGENCY CONDITION.

AS CONSTRUCTION DISTURBANCE IS GREATER THAN 1 ACRE, A NATIONAL POLLUTANT AS CONSTRUCTION DISTURBANCE IS ORDER THOM STRUCTION GENERAL PERMIT NOI, AND DISCHARGE ELIMINATION SYSTEM (NPDES) CONSTRUCTION GENERAL PERMIT NOI, AND STORM WATER POLLUTION PREVENTION PLAN (SWPPP) WILL NEED TO BE SUBMITTED TO THE FPA. THE NPDES PERMIT FOR STORM WATER DISCHARGE, & CONSTRUCTION GENERAL PERMIT NOI WILL BE REQUIRED TO BE SUBMITTED AT LEAST 14 DAYS PRIOR TO COMMENCING CONSTRUCTION BY THE CONTRACTOR.

25. OWNER AND CONTRACTOR ARE RESPONSIBLE FOR COMPLIANCE WITH THE CONSTRUCTION GENERAL PERMIT NOI. WEEKLY SWPPP INSPECTION REPORTS TO BE PERFORMED BY CONTRACTOR. COPIES OF ALL SWPPP INSPECTION REPORTS SHALL BE PROVIDED TO THE LOCAL MUNICIPALITY, EPA, DEP, OR ANY OTHER AUTHORITY REQUESTING WITHIN 3

26. APPLICABLE WORK AND MATERIALS SHALL COMPLY WITH ALL LOCAL, MA DEP, EPA CONSTRUCTION GENERAL PERMIT STANDARDS. ALL CONSTRUCTION SHALL CONFORM TO THE APPLICABLE SITE PLAN REGULATIONS FROM THE LOCAL AND USDA SOIL CONSERVATION SERVICE VEGETATIVE PRACTICES IN SITE DEVELOPMENT.

27. A WATERING TRUCK SHALL BE USED TO PERIODICALLY SPRINKLE CONSTRUCTION AREAS IN ORDER TO KEEP THE LEVEL OF DUST TO A MINIMUM DURING THE DRY MONTHS AND AS REQUIRED.

28. IF DEWATERING IS NECESSARY IT SHALL ONLY BE COMPLETED AS FOLLOWS: THE DISCHARGE SHALL BE STOPPED IMMEDIATELY IF THE RECEINING AREA SHOWS ANY SIGN OF INSTABILITY OR EROSION. ALL CHANNELS, SWALES, AND DITCHES DUG FOR DISCHARGING WATER FROM THE EXCANATED AREA SHALL BE STABLE PRIOR TO DIRECTING DISCHARGE TO THEM. IF A CONSTRUCTION EQUIPMENT BUCKET IS USED, IT SHALL EMPTY THE MATERIAL TO A STABLE AREA. NO DEWATERING SHALL OCCUR DURING PERIODS OF INTENSE, HEAVY RAIN, FLOW TO THE SEDIMENT REMOVAL STRUCTURE SHALL NOT EXCEED THE STRUCTURE'S CAPACITY TO SETTLE AND FILTER FLOW OR ITS VOLUME CAPACITY, WHENEVER POSSIBLE, THE DISCHARGE FROM THE SEDIMENT REMOVAL STRUCTURE SHALL DRAIN TO A WELL-VEGETATED BUFFER BY SHEET FLOW WHILE MAXIMIZING THE DISTANCE TO THE NEAREST WATER RESOURCE AND MINIMIZING THE SUPPLY OF THE BUFFER SHALL BE NO DIRECT DISCHARGE TO EXISTING WETLANDS OR STREAMS. ALL DISCHARGE SHALL BE IN COMPLIANCE WITH STATE, LOCAL, AND FEDERAL REQUIREMENTS.

INITIATE STABILIZATION OF EXPOSED AREAS IMMEDIATELY IF CONSTRUCTION WORK TEMPORARILY OR PERMANENTLY CEASES.

30. ALL DISCHARGES FROM POLLUTION SOURCES ARE PROHIBITED ONSITE SUCH AS FUELS, WASTEWATER FROM WASH OUT OF CONCRETE, WASTEWATER FROM CLEAN OUT OF PAINTS, FORM RELEASE OLS, SOLVENTS, ADHESIVES, CURING COMPOUNDS, POLLUTANTS USED FOR MANTENANCE OF VEHICLES AND EQUIPMENT, SOAPS & SOLVENTS, TOXIC OR HAZARDOUS SUBSTANCES, CHEMICALS AND OLS, IF A POLLUTANT IS DISCHARGED IT NEEDS TO BE IMMEDIATELY CLEANED UP BY REMOVING THE CHEMICAL AND AFFECTED SOIL OR AREA OF SPILL FROM THE SITE IN ACCORDANCE WITH BOTH THE MANUFACTURER RECOMMENDATIONS, FEDERAL, STATE, AND LOCAL REQUIREMENTS. DO NOT HOSE DOWN AND SPREAD SPILLED ITEM. ALL CHEMICALS USED ON THE SITE SHALL BE IN LEAV.—PROOF CONTAINERS STORED MAYS FROM WETLANDS, SURFACE WATERS, STORMWATER INLETS, AND DRAINAGE MEASURES. SPILL KITS SHALL BE AVAILABLE ONSITE FOR EMERGENCY USE. THERE SHALL BE A SECONDARY CONTAINMENT MEASURE OF ALL CHEMICALS IN ADDITION TO SPILL—PROOF CONTAINERS.

31. PRIOR TO COMMENCEMENT OF CONSTRUCTION, APPLICABLE CONTRACTOR PERSONNEL MUST HAVE AN UNDERSTANDING OF THE EPA CONSTRUCTION GENERAL PERMIT REQUIREMENTS AND THEIR SPECIFIC RESPONSIBILITIES UNDER THE PERMIT. AT A MINIMUM, PERSONNEL MUST BE TRAINED AND UNDERSTAND THE FOLLOWING: LOCATION OF ALL STORMWATER CONTROLS AND HOW TO MAINTAIN THEM, PROCEDURES FOR COMPLYING WITH THE POLLUTION PREVENTION REQUIREMENTS. PROCEDURES FOR CONDUCTING INSPECTIONS, RECORDING FINDINGS, AND TAKING CORRECTIVE ACTION.

32. ALL SEDIMENT TRACKED ONTO ROADWAYS MUST BE REMOVED AT END OF EACH WORK

33. ALL USE OF CATIONIC TREATMENT CHEMICALS (EXAMPLES INCLUDE POLYMERS, CHITOSAN, CATIONIC PAM, FLOCCULANTS OR OTHER CHEMICAL UTILIZED FOR STABILIZATION) ARE PROHIBITED. IF ALL OTHER AVAILABLE STABILIZATION MEASURES ARE NOT POSSIBLE AND USE OF CATONIC CHEMICALS IS ABSOLUTELY NECESSARY THE CONTRACTOR WILL NEED TO CONTACT THE EPA NEW ENGLAND OFFICE IN WRITING FOR APPROVAL AND SPECIFIC REQUIREMENTS (MAXIMUM DOSAGE RATE, RESIDUAL TESTING, SPECIFIC INVESTINGS FTC) PROJECT TO INFORMATIONS FTC) PROJECT TO INFORMATION FTC) PROJ SPECIFIC LIMITATIONS, ETC) PRIOR TO USE.

34. IF USING NON-VEGETATIVE STABILIZATION MEASURES, IT MUST BE COMPLETED NO LATER THAN 14 DAYS AFTER INITIATING STABILIZATION. ALL AREAS OF EXPOSED SOILS MUST BE COVERED.

35. INSPECTIONS OF EROSION CONTROL MEASURES SHALL BE AT LEAST ONCE EVERY INSPECTIONS OF EROSION CONTROL MEASURES SHALL BE AT LEAST ONCE EVERY 7 DAYS BY THE CONTRACTOR. AT A MINIMUM INSPECTIONS SHALL INCLUDE ALL DISTURBED AREAS, ALL STORMWATER CONTROLS AND POLLUTION PREVENTION MEASURES, ALL LOCATIONS WHERE STABILIZATION MEASURES HAVE BEEN IMPLEMENTED, EQUIPMENT AND MATERIAL STORAGE AREAS, ALL AREAS WHERE STORMWATER FLOWS AND ALL POINTS OF DISCHARGE. WHEN CORRECTIVE ACTIONS ARE REQUIRED, THE CONTRACTOR MUST IMMEDIATELY TAKE ALL STEPS TO PREVENT POLLUTANT DISCHARGES UNTIL A PERMANENT SOLUTION IS IMPLEMENTED. AS NECESSARY NEW OR MODIFIED CONTROLS MUST BE INSTALLED AND OPERATIONAL, THE REPAIR MUST BE COMPLETED WITHIN 7 DAYS FROM THE TIME OF DISCOVERY. WITHIN 24 HOURS OF A TRIGGERING CONDITION OCCURRING THAT REQUIRES A CORRECTIVE ACTION, A CORRECTIVE ACTION REPORT MUST BE COMPLETED.

MAINTENANCE:

ALL MEASURES STATED ON THE STORMWATER POLLUTION PREVENTION PLANS, SHALL BE MAINTAINED IN FULLY FUNCTIONAL CONDITION BY CONTRACTOR UNTIL NO LONGER REQUIRED FOR A COMPLETED PHASE OF WORK OR FINAL STABILIZATION OF THE SITE. ALL EROSION AND SEDIMENTATION CONTROL MEASURES SHALL BE CHECKED BY A QUALIFIED PERSON IN ACCORDANCE WITH THE CONTRACT DOCUMENTS OR THE APPLICABLE PERMIT, WHICHEVER IS NGENT, AND REPAIRED IN ACCORDANCE WITH THE FOLLOWING:

1. INLET PROTECTION DEVICES AND BARRIERS SHALL BE REPAIRED OR REPLACED IF THEY UNDERMINING, OR DETERIORATION

ALL SEEDED AREAS SHALL BE CHECKED REGULARLY TO SEE THAT A HEALTHY STAND OF GRASS IS MAINTAINED. AREAS SHOULD BE FERTILIZED, WATERED, AND RESEEDED AS

ALL SEDIMENT CONTROLS SHALL BE REPAIRED TO THEIR ORIGINAL CONDITIONS IF DAMAGED. SEDIMENT SHALL BE REMOVED FROM THE TUBULAR SEDIMENT CONTROLS WHEN IT REACHES HALF THE HEIGHT OF THE CONTROL MEASURE OR AS REQUESTED BY THE OWNER OR ENGINEER.

THE CONSTRUCTION ENTRANCES SHALL BE MAINTAINED IN A CONDITION WHICH WILL PREVENT TRACKING OR FLOW OF MUD ONTO PUBLIC RIGHTS-OF-WAY. THIS MAY REQUIRE PERIODIC TOP DRESSING OF THE CONSTRUCTION ENTRANCES AS CONDITIONS

THE TEMPORARY PARKING AND STORAGE AREA SHALL BE KEPT IN GOOD CONDITION (SUITABLE FOR PARKING AND STORAGE). THIS MAY REQUIRE PERIODIC TOP DRESSING OF THE TEMPORARY PARKING AS CONDITIONS DEMAND.

OUTLET STRUCTURES IN THE SEDIMENTATION BASINS SHALL BE MAINTAINED IN OPERATIONAL CONDITIONS AT ALL TIMES. SEDIMENT SHALL BE REMOVED FROM BASINS OR TRAPS WHEN THE DESIGN CAPACITY HAS BEEN REDUCED BY 50%. M SEDIMENT

CONSTRUCTION GENERAL PERMIT NOTES AND NARRATIVE:

NARRATIVE: THE STORMWATER POLLUTION PREVENTION PLANS CONSIST OF THE SITE PREPARATION PLAN TOGETHER WITH AN EXISTING CONDITIONS PLANS, GRADING PLANS, ABBREVANTIONS AND NOTES SHEETS, AND DETAIL SHEETS.

THE EROSION CONTROL PLAN WILL BE IMPLEMENTED TO:

A. TREAT EROSION AS SOON AS POSSIBLE AFTER DISTURBANCE.

B. PREVENT SEDIMENT FROM LEAVING THE CONSTRUCTION AREA AND ENTERING THE

C. CONSTRUCTION ACTIVITIES SHALL BE SCHEDULED TO MINIMIZE EROSION.

D. ONLY DISTURB, CLEAR, OR GRADE AREAS NECESSARY FOR CONSTRUCTION.



PROFESSIONAL ENGINEER FOR ALLEN & MAJOR ASSOCIATES, INC.

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6	10-24-23	REVISED PER CONDITIONS OF APPROVAL
5	05-18-23	REVISION 5 PER REVIEW COMMENTS
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3	05-01-23	REVISION 3 PER REVIEW COMMENTS
2	04-14-23	REVISION 2 PER DPW COMMENTS
1	04-04-23	REVISION 1 PER PEER REVIEW
REV	DATE	DESCRIPTION

TMC HOLDINGS & DEVELOPMENT 2, LLC 24 WILLIAM WAY BELLINGHAM, MA 02019

25 FORGE PARKWAY FRANKLIN, MA

PROJECT NO.	2712-02A	DATE:	02-21-2
SCALE:	NONE	DWG. NAME:	C-2712-02
DESIGNED BY:	SM/JRG	CHECKED BY:	В



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FROSION CONTROL &

C-100

SITE PREPARATION NOTES

- PREPARE TEJEODARY PARKING AND STORAGE AREA, UPON INFLEDENTATION AND RESTAULTION OF THE FOLICIMING MARCH STRAILER, PARKING, LAV DIA STORAGE CONTAINERS, SOLIO WASTE COMMENTES, ETC., DEPORTE THEM ON THE SITE MARS IMMEDIATELY AND NOTE ANY CHANGES IN THE LOCATIONS AS THEY OCCUR TRIBOUGHOUT THE CONSTRUCTION PROCESS.
- INSTALL THE TUBULAR BARRIERS AND SILT SACKS AS SHOWN HEREON. EROSION CONTROL BARRIERS MUST BE INSPECTED AND APPROVED BY A PROFESSIONAL ENGINEER OF LICENSED WETLANDS SCIENTIST. NO SEDIMENTATION BARRIER MAY BE REMOVED WITHOUT PRIOR APPROVAL OF THE COMMISSION OR ITS STAFF.
- 5. CLEAR AND GRUB THE SITE.
- 3. CONSTRUCT TEMPORARY SEDIMENTATION AND SEDIMENT TRAP BASINS AS NECESSARY.

- CONSTRUCT STORMWATER MEASURES. SITE SHALL BE STABILIZED PRIOR TO STORMWATER MEASURES RECEIVING RUNOFF.
- 8. START CONSTRUCTION OF BUILDING PAD AND STRUCTURES. TEMPORARIL SEED DEVILOED AREAS, ALL CUT AND FILL SLOPES SHALL BE SEEDED / LOAMED WITHIN 72 HOURS OF ACHIEVING FINISH GRADE, EXCEPT WHERE RIP RAP IS APPLIED.
- 9. INSTALL BUILDING, UTILITIES, STORM SEWERS, CURBS AND GUTTERS.
- 10. INSTALL INLET PROTECTION DEVICES AROUND ALL STORM DRAIN STRUCTURES.
- 11. INSTALL RIP RAP AROUND OUTLET STRUCTURES.

WI - W2

- 12. FINALIZE GRADING, AND PREPARE SITE FOR PAYING. NOTE, ALL PARKING LOTS SHALL BE STABILIZED WITHIN 72 HOURS OF ACHIEVING FINISH GRADE.
- PAVE SITE. COMPLETE FINISH GRADING AND INSTALL PERMANENT SEEDING AND PLANTING.
- ONCE SITE IS STABILIZED, REMOVE ALL TEMPORARY EROSION AND SEDIMENT CONTROL DEVICES.
- ALL RAINFALL EVENTS GREATER THAN 0.25°, AND SHALL BE MAINTAINED, REPAIRED OR REPLACED AS REQUIRED OR AT THE DIRECTION OF THE OWNER'S ENGINEER, OR THE TOWN ENGINEER.

EXISTING CATCH BASIN T.B.R.

CONC. STEPS -T.B.R.

INSTALL SILT SACK INLET -INTECTION WITHIN EXISTING CATCH BASIN, TYP.

FORGE

LIMIT OF WORK

APPOXIMATE /
LOCATION OF TEMPORARY DEWATERING RECHARGE AREA

IT OF CLEAR

GAS METER, FDC POV TO REMAIN.

COORDINATE W/ ME
INSTALL SILT SACK INLET
PROTECTION WITHIN EXISTING
CATCH BASIN, TYP.

FPA= 18.619+ S.F

- 17. IF IT APPEARS THAT SEDIMENT IS EXTRING THE SITE, SILT SACKS SHALL BE INSTALLED IN ALL CATCH BASINS ADJACENT TO THE SITE. SEDIMENT ACCUMULATION ON ALL ADJACENT CATCH BASIN INLETS SHALL BE REMOYED AND THE SILT SACK REPLACED IF TORN OR DAMAGED.
- 18. THE CONTRACTOR SHALL COMPLY WITH THE GENERAL AND EROSION NOTES AS SHOWN ON THE SITE DEVELOPMENT PLANS, SEE ALSO SHEET C-001.

GÇ16

EXISTING / HYDRANT J.B.R.


- EXISTING CATCH BASIN T.B.R.

EXISTING GAS & TELE/DATA
CONDUITS TO REMAIN.
COORDINATE CONNECTION TO
EXISTING BUJLDING AND
PROPOSED ADDITION W/ MEP.

EXISTING ELECTRICAL
CONDUIT TO BE REROUTED
TO ACCOMMODATE
RELOCATED TRANSFORMER,
SEE UTILITIES PLAN.


- EXISTING CATCH BASIN TO BE REMOVED.



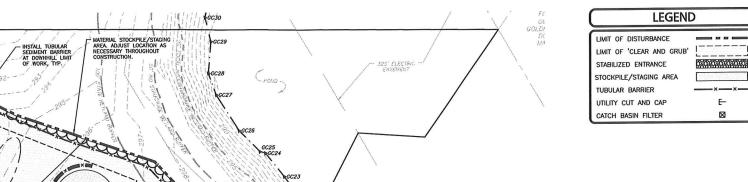

NOTES:

- 1. THE CONTRACTOR IS SPECIFICALLY CAUTIONED THAT THE LOCATION AND/OR ELEVATION OF EXISTING UTILITIES AND STRUCTURES AS SHOWN ON THESE PLANS IS BASED ON RECORDS OF VARIOUS UTILITY COMPANIES AND WHERE POSSIBLE, MEASUREMENTS TAKEN IN THE FIELD. THIS INFORMATION IS NOT TO BE RELIED ON AS BEING EXACT OR COMPLETE. THE LOCATION OF ALL UNDERGROUND UTILITIES AND STRUCTURES SHALL BE VERIFIED IN THE FIELD BY THE CONTRACTOR PRIOR TO THE START OF CONSTRUCTION.
- THE CONTRACTOR SHALL DETERMINE THE EXACT LOCATION OF ALL EXISTING UTILITIES BEFORE COMMENCING WORK, AND AGREES TO BE FULLY RESPONSIBLE FOR ANY AND ALL DAMAGES WHICH MIGHT BE OCCASIONED BY THE CONTRACTOR'S FAILURE TO EXACTLY LOCATE AND PRESERVE ANY AND ALL UNDERGROUND UTILITIES.
- 3. THE CONTRACTOR MUST CONTACT THE APPROPRIATE UTILITY COMPANY, ANY GOVERNING PERMITTING AUTHORITY, AND "DIGSAFE" AT LEAST 72 HOURS PRIOR TO ANY EXCAVATION WORK TO REQUEST EXACT FIELD LOCATION OF UTILITIES. THE ENGINEER SHALL BE NOTIFIED IN WRITING OF ANY UTILITIES INTERFERING WITH THE PROPOSED CONSTRUCTION AND APPROPRIATE REMEDIAL ACTION TAKEN BEFORE PROCEEDING WITH THE WORK. IT SHALL BE THE RESPONSIBILITY OF THE CONTRACTOR TO RELOCATE ALL EXISTING UTILITIES WHICH CONFLICT WITH THE PROPOSED IMPROVEMENTS SHOWN ON THE PLANS.
- 4. ALTHOUGH CERTAIN ITEMS HAVE BEEN NOTED ON THIS DRAWING FOR DEMOLITION, NO ATTEMPT HAS BEEN MADE TO DELINEATE EACH AND EVERY ITEM THAT REQUIRES DEMOLITION FOR THE COMPLETION OF THE PROJECT. HE CONTRACTOR WILL BE RESPONSIBLE FOR ALL NECESSARY DEMOLITION WORK TO COMPLETE THE PROJECT. ALLEN & MAJOR ASSOCIATES, INC. IS NOT RESPONSIBLE FOR SITE DEMOLITION ITEMS NOT SHOWN ON THE SURVEY, OR SPECIFICALLY NOTED. THE DEMOLITION NOTES AND ARROWS ON THIS PLAN ARE TYPICAL AND DO NOT REFLECT QUARTER.
- 5. THE ENGINEER SHALL BE NOTIFIED IN WRITING OF ANY UTILITIES INTERFERING WITH THE PROPOSED CONSTRUCTION AND APPROPRIATE REMEDIAL ACTION TAKEN BEFORE PROCEEDING WITH THE WORK, IT SHALL BE THE RESPONSIBILITY OF THE CONTRACTOR TO RELOCATE ALL EXISTING UTILITIES WHICH CONFLICT WITH THE PROPOSED IMPROVEMENTS SHOWN ON THE
- 6. EROSION CONTROL MEASURES SHALL BE INSTALLED PRIOR TO THE START OF CONSTRUCTION. IF IT ADDITIONAL MEASURES ARE NECESSARY DURRING CONSTRUCTION THEY SHALL BE INSTALLED IMMEDIATELY AND WITHOUT DELAY. SEE DETAIL SHEET C-501
- 7. INLET PROTECTION SHALL BE INSTALLED IN PROPOSED CATCH BASINS IMMEDIATELY UPON CONSTRUCTION.
- 8. THE INFORMATION SHOWN ON THIS PLAN IS THE SOLE PROPERTY OF ALLEN & MAJOR ASSOCIATES, INC. ITS INTENDED USE IS TO PROVIDE INFORMATION. ANY ALTERATION, MISUSE, OR RECALCULATION OF INFORMATION OR DATA WITHOUT THE EXPRESSED, WRITTEN CONSENT OF ALLEN & MAJOR ASSOCIATES, INC. IS STRICTLY PROHIBITED.

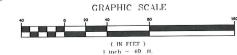



REV	DATE	DESCRIPTION
1	04-04-23	REVISION 1 PER PEER REVIEW
2	04-14-23	REVISION 2 PER DPW COMMENTS
3	05-01-23	REVISION 3 PER REVIEW COMMENTS
4	05-11-23	REVISION 4 PER REVIEW COMMENTS
5	05-18-23	REVISION 5 PER REVIEW COMMENTS
6	10-24-23	REVISED PER CONDITIONS OF APPROVA
7	12-14-23	ISSUED FOR SITE PLAN AMENDMENT

TMC HOLDINGS & DEVELOPMENT 2, LLC 24 WILLIAM WAY BELLINGHAM, MA 02019

25 FORGE PARKWAY FRANKLIN, MA

PROJECT NO.	2712-02A	DATE:	02-21-23
SCALE:	1" - 40'	DWG. NAME:	C-2712-02A
DESIGNED BY:	SM/JRG	CHECKED BY:	BDJ



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WOBURN MA 01801
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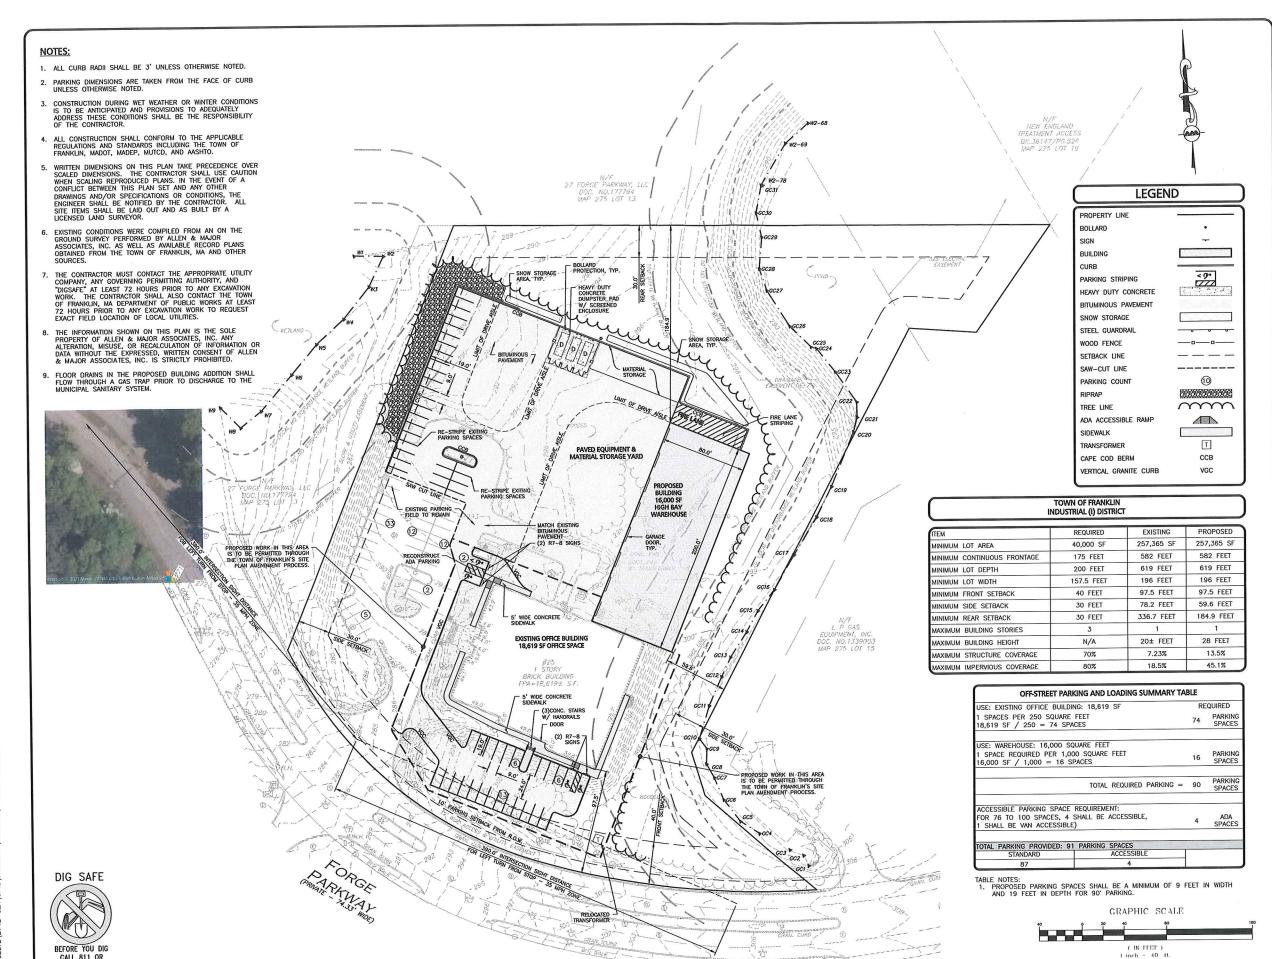
C-101

SITE PREPARATION PLAN

DIG SAFE

REFORE YOU DIG

CALL 811 OR 1-888-DIG-SAFE -888-344-7233





8	01-19-24	REVISED PER REVIEW COMMENTS
7	12-14-23	ISSUED FOR SITE PLAN AMENDMEN
6	10-24-23	REVISED PER CONDITIONS OF APPROVA
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25 FORGE PARKWAY FRANKLIN, MA

PROJECT NO.	2712-02A	DATE:	02-21-23
SCALE:	1" = 40'	DWG. NAME:	C-2712-02
DESIGNED BY:	SM/JRG	CHECKED BY:	BD
PREPARED BY:			



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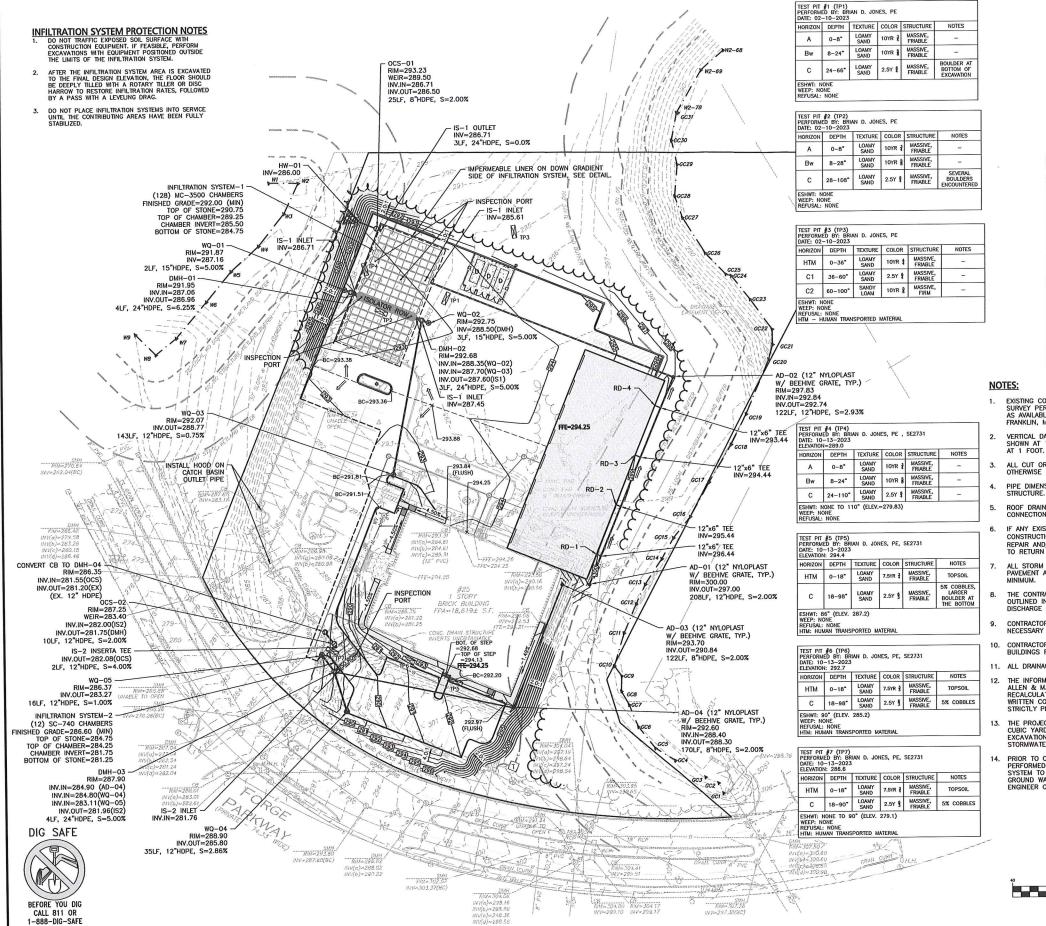
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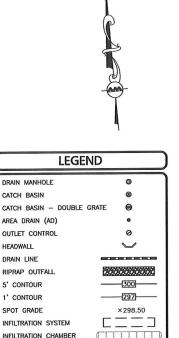
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LAYOUT & MATERIALS PLAN | C-102





 \Longrightarrow

- EXISTING CONDITIONS WERE COMPILED FROM AN ON THE GROUND SURVEY PERFORMED BY ALLEN & MAJOR ASSOCIATES, INC. AS WELL AS AVAILABLE RECORD PLANS OBTAINED FROM THE TOWN OF FRANKLIN, MA AND OTHER SOURCES.
- VERTICAL DATUM IS NAVD88. EXISTING GRADE CONTOUR INTERVALS SHOWN AT 1 FOOT. PROPOSED GRADE CONTOUR INTERVALS SHOWN AT 1 FOOT.
- ALL CUT OR FILL SLOPES SHALL BE 3:1 OR FLATTER UNLESS OTHERWISE NOTED.

ISOLATOR ROW

FLOW DIRECTION

- PIPE DIMENSIONS ARE MEASURED FROM THE INSIDE EDGE OF THE
- 5. ROOF DRAIN LOCATIONS TO BE BASED ON FINAL BUILDING PLANS. CONNECTION POINTS SHALL BE AS SHOWN HEREON.
- 6. IF ANY EXISTING STRUCTURES TO REMAIN ARE DAMAGED DURING CONSTRUCTION IT SHALL BE THE CONTRACTOR'S RESPONSIBILITY TO REPAIR AND/OR REPLACE THE EXISTING STRUCTURE AS NECESSARY TO RETURN IT TO EXISTING CONDITIONS OR BETTER.
- ALL STORM DRAIN MANHOLES IN PAVED AREAS SHALL BE FLUSH WITH PAVEMENT AND SHALL HAVE TRAFFIC BEARING RING & COVERS, H-20 MINIMUM.
- THE CONTRACTOR SHALL ADHERE TO ALL TERMS & CONDITIONS AS OUTLINED IN THE GENERAL N.P.D.E.S. PERMIT FOR STORMWATER DISCHARGE ASSOCIATED WITH CONSTRUCTION ACTIVITIES.
- CONTRACTOR SHALL ADJUST AND/OR CUT EXISTING PAVEMENT AS NECESSARY TO ENSURE A SMOOTH FIT AND CONTINUOUS GRADE.
- CONTRACTOR SHALL ENSURE POSITIVE DRAINAGE AWAY FROM BUILDINGS FOR ALL NATURAL AND PAVED AREAS.
- 11. ALL DRAINAGE SHALL CONFORM TO LOCAL REQUIREMENTS.
- 12. THE INFORMATION SHOWN ON THIS PLAN IS THE SOLE PROPERTY OF ALLEN & MAJOR ASSOCIATES, INC. ANY ALTERATION, MISUSE, OR RECALCULATION OF INFORMATION OR DATA WITHOUT THE EXPRESSED, WRITTEN CONSENT OF ALLEN & MAJOR ASSOCIATES, INC. IS
- THE PROJECT RESULTS IN A NET EXPORT OF APPROXIMATELY 7,300 CUBIC YARDS OF MATERIAL. THIS VALUE DOES NOT INCLUDE EXCAVATION REQUIRED FOR BUILDING FOUNDATION, UTILITIES, OR STORMWATER INFRASTRUCTURE.
- PRIOR TO CONSTRUCTION, ONE ADDITIONAL TEST PIT SHALL BE PERFORMED WITHIN THE FOOTPRINT OF THE PROPOSED INFILITRATION SYSTEM TO CONFIRM SEPARATION TO ESTIMATED SEASONAL HIGH GROUND WATER. THE TEST PIT SHALL BE OBSERVED BY THE ENGINEER OF RECORD.

GRAPHIC SCALE

1 inch - 40 ft.



PROFESSIONAL ENGINEER FOR ALLEN & MAJOR ASSOCIATES, INC.

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TMC HOLDINGS & DEVELOPMENT 2, LLC 24 WILLIAM WAY BELLINGHAM, MA 02019

25 FORGE PARKWAY FRANKLIN, MA

PROJECT NO.	2712-02A	DATE:	02-21-2
SCALE:	1" - 40'	DWG. NAME:	C-2712-02
DESIGNED BY:	SM/JRG	CHECKED BY:	В



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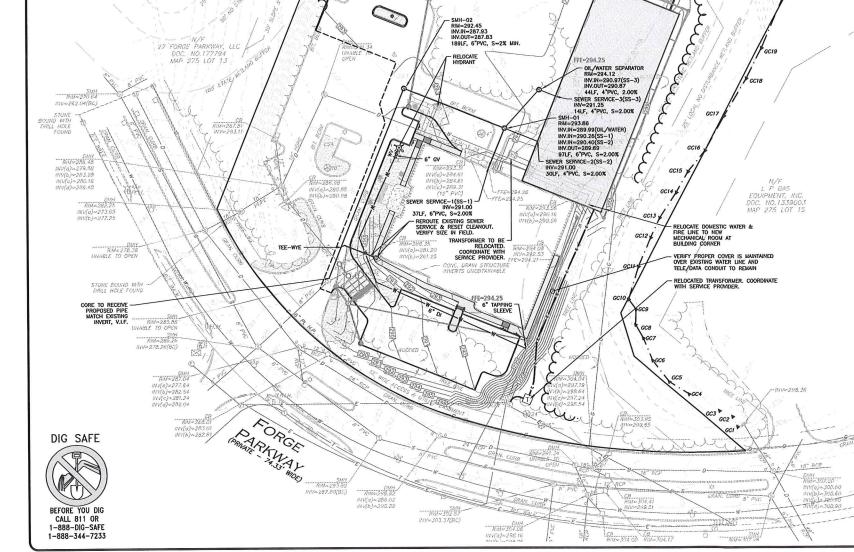
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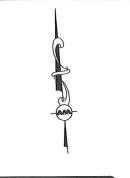
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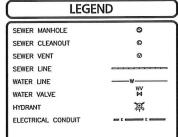
GRADING & DRAINAGE PLAN | C-103



N/F 27 FORGE PARKWAY, LLC DOC. NO.177794 MAP 275 LOT 13

/ W2-78 GC31





NOTES:

N/F NEW ENGLAND TREATMENT ACCESS BK.36147/PG.526 MAP 275 LOT 19

325" ELECTRIC EASEMENT

- EXISTING CONDITIONS WERE COMPILED FROM AN ON THE GROUND SURVEY PERFORMED BY ALLEN & MAJOR ASSOCIATES, INC. AS WELL AS AVAILABLE RECORD PLANS OBTAINED FROM THE TOWN OF FRANKLIN, MA AND OTHER SOURCES.
- VERTICAL DATUM IS NAVD8B. EXISTING GRADE CONTOUR INTERVALS SHOWN AT 1 FOOT. PROPOSED GRADE CONTOUR INTERVALS SHOWN AT 1 FOOT.
- PIPE DIMENSIONS ARE MEASURED FROM THE INSIDE EDGE OF THE STRUCTURE.
- 4. IF ANY EXISTING STRUCTURES TO REMAIN ARE DAMAGED DURING CONSTRUCTION IT SHALL BE THE CONTRACTOR'S RESPONSIBILITY TO REPAIR AND/OR REPLACE THE EXISTING STRUCTURE AS NECESSARY TO RETURN IT TO EXISTING CONDITIONS OR BETTER.
- ALL SEWER MANHOLES IN PAVED AREAS SHALL BE FLUSH WITH PAVEMENT AND SHALL HAVE TRAFFIC BEARING RING & COVERS, H-20 MINIMUM.
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- FLOOR DRAINS IN THE PROPOSED BUILDING ADDITION SHALL FLOW THROUGH A GAS TRAP PRIOR TO DISCHARGE TO THE MUNICIPAL SANITARY SYSTEM.
- ALL WATERLINE WORK SHALL CONFORM TO THE MOST RECENT FRANKLIN DPW WATERLINE MATERIALS AND INSTALLATION STANDARDS.
- ALL PROPOSED SANITARY SEWER CONNECTIONS TO EXISTING SEWER INFRASTRUCTURE ON SITE SHALL BE COORDINATED WITH THE MEP.

GRAPHIC SCALE

(IN FEET) 1 mch = 40 II.



PROFESSIONAL ENGINEER FOR ALLEN & MAJOR ASSOCIATES, INC.

REV	DATE	DESCRIPTION	

TMC HOLDINGS & DEVELOPMENT 2, LLC 24 WILLIAM WAY BELLINGHAM, MA 02019

25 FORGE PARKWAY FRANKLIN, MA

S	CALE:	1" - 40'	DWG. NAME:	C-2712-02A
D	ESIGNED BY:	SM/JRG	CHECKED BY:	BDJ




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UTILITIES PLAN



W2-78 GC31



7	12-14-23	ISSUED FOR SITE PLAN AMENDMENT
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LEGEND

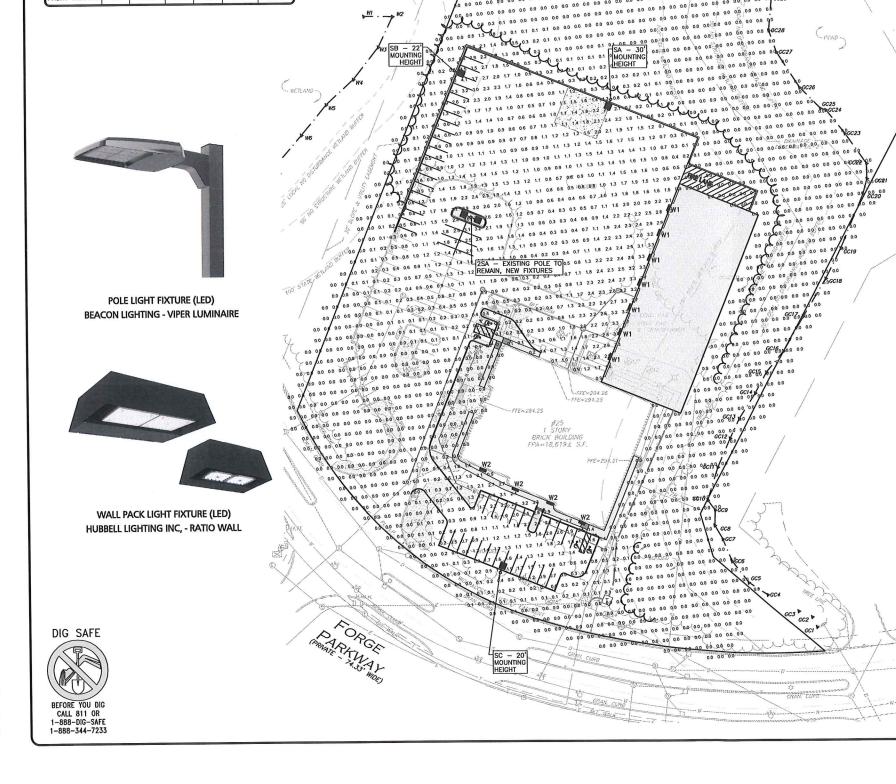0.0 0.1 0.2 0.4 0.

-SINGLE LUMINAIRE FIXTURE (AS PER PLAN)

-ANCHOR BOLTS FURNISHED BY THE ELECTRICAL CONTR. & INSTALLED BY GENERAL CONTR.

-CONDUITS BY ELECTRICAL CONTR.

#3 TIES @ 12" O.C. TOP TO BOTTOM (TYP.)

-5-INCH SQUARE STEEL LIGHT POLE 11 GUAGE COLOR: BLACK

-8-#6 BARS

SINGLE POLE LIGHT

WALL PACK LIGHT JGHTING LEVELS GIVEN IN FOOT-CANDLES

-DOUBLE LUMINAIRE FIXTURE (AS PER PLAN)

LIGHT POLE & BASE DETAIL

LIGHTING VENDOR CONTACT INFORMATION:
 CHRIS PECHALK
 SWANEY LIGHTING, INC.
 PHONE: 603-380-3400
 E-MAIL: CHRIS@SWANEYLIGHTING.COM

LIGHTS WITHIN THE PARKING AREAS AND ACCESS DRIVES SHALL OPERATE ON A PHOTO-CELL & PROGRAMABLE TIMER.

5. THE INFORMATION SHOWN ON THIS PLAN IS THE SOLE PROPERTY OF ALLEN & MAJOR ASSOCIATES, INC. IT'S INTENDED USE IS TO PROVIDE INFORMATION. ANY ALTERATION, MISUSE, OR RECALCULATION OF INFORMATION OR DATA WITHOUT THE EXPRESSED, WRITTEN CONSENT OF ALLEN & MAJOR ASSOCIATES, INC. IS STRICTLY PROHIBITED.

GRAPHIC SCALE

(IN FEET)

CONTROLS FOR ALL EXTERIOR LIGHTING BY BUILDING CONTRACTOR.

WIRING OF BUILDING MOUNTED FIXTURES BY BUILDING CONTRACTOR.

SEE PLAN FOR MOUNTING

HEIGHT

—5'-0" BELOW GROUND

NOTES:

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LIGHTING PLAN

C-105

LUMINAIRE SCHEDULE YMBOL QTY LABEL ARRANGEMENT

■ 4 W2 WALL PACK

LIGHTING LEVEL SUMMARY

FRONT PARKING Fc

Fc

W1 WALL PACK

1 2SA DOUBLE, POLE MOUNT 30'

0.34

1.28

1 SA SINGLE, POLE MOUNT

HEIGHT LUMENS WATTS DESCRIPTION

SB SINGLE, POLE MOUNT 22' 12189 105 VP-ST-1-36L-39-27K8-4F-UNIV-BC

13.00

3538

N.A.

25'

30'

UNITS AVERAGE MAX MIN AVG/MIN MAX/MII 4.1

0.0

2.6 0.2 6.40

• 1 SC SINGLE, POLE MOUNT 20' 8085 84 VP-ST-1-36L-85-3K7-4W

14'

5778 46 RWL2-160L-45-3K-4F

28 RWL1-48L-25-3K7-4W-U


14960 105 TWIN VP-ST-1-36L-105-3K7-4F


14960 105 VP-ST-1-36L-105-3L7-4F

LLEN & MAJOR ASSOCIATES, INC.'S WORK PR

DIG SAFE

BEFORE YOU DIG CALL 811 OR 1-888-DIG-SAFE

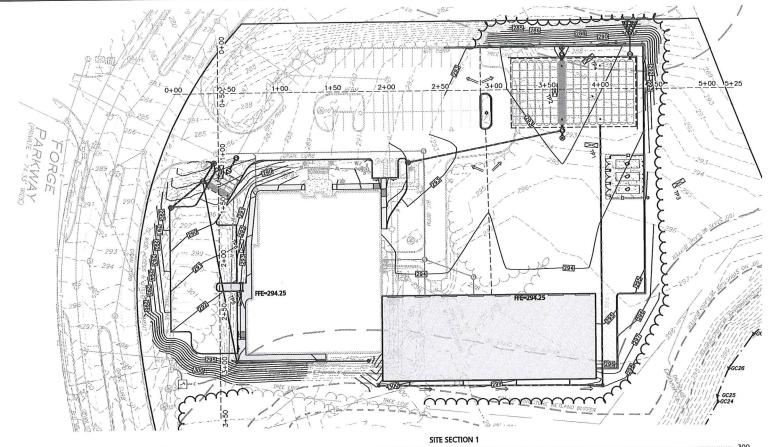

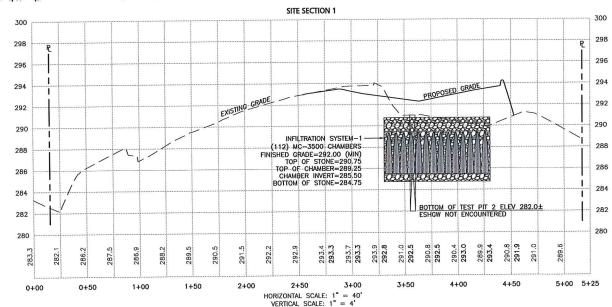

HORIZON	DEPTH	TEXTURE	COLOR	STRUCTURE	NOTES
Α	0-8"	LOAMY SAND	10YR ≩	MASSIVE, FRIABLE	=
Bw	8-24"	LOAMY SAND	10YR §	MASSIVE, FRIABLE	-
С	24-66"	LOAMY SAND	2.5Y 🛊	MASSIVE, FRIABLE	BOULDER AT BOTTOM OF EXCAVATION

HORIZON	DEPTH	TEXTURE	COLOR	STRUCTURE	NOTES
нтм	0-36"	LOAMY SAND	10YR ‡	MASSIVE, FRIABLE	-
C1	36-60"	LOAMY SAND	2.5Y \$	MASSIVE, FRIABLE	-
C2	60-100"	SANDY	10YR §	MASSIVE, FIRM	-

HORIZON	DEPTH	TEXTURE	COLOR	STRUCTURE	NOTES
Α	0-8"	LOAMY SAND	10YR ≩	MASSIVE, FRIABLE	-
Bw	8-28	LOAMY SAND	10YR §	MASSIVE, FRIABLE	=
С	28-108*	LOAMY SAND	2.5Y 🛊	MASSIVE, FRIABLE	SEVERAL BOULDERS ENCOUNTERED

HORIZON	DEPTH	TEXTURE	COLOR	STRUCTURE	NOTES
нтм	0-18"	LOAMY SAND	7.5YR 🚦	MASSIVE, FRIABLE	TOPSOIL
С	18-90"	LOAMY	2.5Y §	MASSIVE, FRIABLE	5% COBBLES




NOTES:


- 1. EXISTING CONDITIONS WERE COMPILED FROM AN ON THE GROUND SURVEY PERFORMED BY ALLEN & MAJOR ASSOCIATES, INC. AS WELL AS AVAILABLE RECORD PLANS OBTAINED FROM THE TOWN OF FRANKLIN, MA AND OTHER SOURCES.
- 2. VERTICAL DATUM IS NAVDBB. EXISTING GRADE CONTOUR INTERVALS SHOWN AT 1 FOOT. PROPOSED GRADE CONTOUR INTERVALS SHOWN AT 1 FOOT.
- ALL CUT OR FILL SLOPES SHALL BE 3:1 OR FLATTER UNLESS OTHERWISE NOTED.
- 4. IF ANY EXISTING STRUCTURES TO REMAIN ARE DAMAGED DURING CONSTRUCTION IT SHALL BE THE CONTRACTOR'S RESPONSIBILITY TO REPAIR AND/OR REPLACE THE EXISTING STRUCTURE AS NECESSARY TO RETURN IT TO EXISTING CONDITIONS OR BETTER.
- 5. THE INFORMATION SHOWN ON THIS PLAN IS THE SOLE PROPERTY OF ALLEN & MAJOR ASSOCIATES, INC. ANY ALTERATION, MISUSE, OR RECALCULATION OF INFORMATION OR DATA WITHOUT THE EXPRESSED, WRITTEN CONSENT OF ALLEN & MAJOR ASSOCIATES, INC. IS STRICTLY PROHIBITED.

LEGEND				
DRAIN MANHOLE	•			
CATCH BASIN	®			
CATCH BASIN - DOUBLE	GRATE ⊖			
AREA DRAIN (AD)	•			
OUTLET CONTROL	Ø			
HEADWALL	\smile			
DRAIN LINE				
RIPRAP OUTFALL	200000000			
5' CONTOUR				
1' CONTOUR	297			
SPOT GRADE	×298.50			
INFILTRATION SYSTEM				
INFILTRATION CHAMBER				
ISOLATOR ROW				

 \Longrightarrow

FLOW DIRECTION

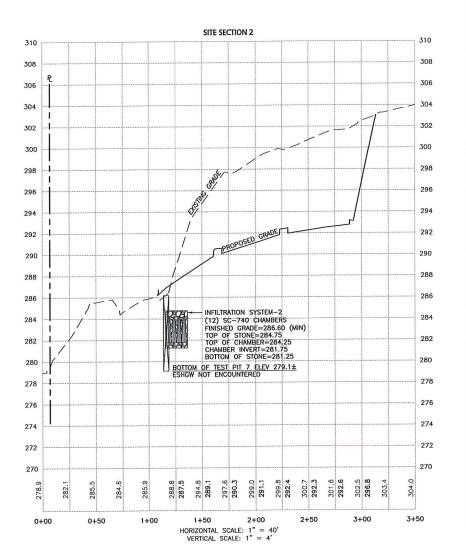

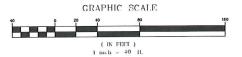



ł		
7	12-14-23	ISSUED FOR SITE PLAN AMENDMEN
6	10-24-23	REVISED PER CONDITIONS OF APPROVA
5	05-18-23	REVISION 5 PER REVIEW COMMENT
4	05-11-23	REVISION 4 PER REVIEW COMMENT
3	05-01-23	REVISION 3 PER REVIEW COMMENT
2	04-14-23	REVISION 2 PER DPW COMMENTS
1	04-04-23	REVISION 1 PER PEER REVIEW
REV	DATE	DESCRIPTION
ADDITION	ATT OUABLED.	

TMC HOLDINGS & DEVELOPMENT 2, LLC 24 WILLIAM WAY BELLINGHAM, MA 02019

25 FORGE PARKWAY FRANKLIN, MA

PROJECT NO.	2712-02A	DATE:	02-21-2
SCALE:	1" - 40'	DWG. NAME:	C-2712-02
DESIGNED BY:	SM/JRG	CHECKED BY:	ВС



civil engineering + land surveying ironmental consulting + landscape architec w w w . a 1 l e n m a j o r . c o m 100 COMMERCE WAY, SUITE 5 WOBURN MA 01801 TEL: (781) 935-6889 FAX: (781) 935-2896


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SITE PLAN & CROSS-SECTION C-201

1. ALL MATERIALS TO MEET MANUFACTURERS SPECIFICATIONS.

- 2. INSTALL WOODEN STAKES IN A CRISS-CROSS PATTERN EVERY 8' ON CENTER.
- 2. OVERLAP TUBULAR BARRIER SEGMENTS A MINIMUM OF 12".
- 3. THE CONTRACTOR SHALL MAINTAIN THE TUBULAR BARRIERS IN A FUNCTIONAL CONDITION AT ALL TIMES. THE CONTROLS SHALL BE ROUTINELY INSPECTED BY THE CONTRACTOR.
- 4. WHERE THE TUBULAR BARRIERS REQUIRE REPAIR OR SEDIMENT REMOVAL, IT WILL BE COMPLETED BY THE CONTRACTOR AT NO ADDITIONAL COST.
- 5. AT A MINIMUM, THE CONTRACTOR SHALL REMOVE SEDIMENTS COLLECTED AT THE BASE WHEN THEY REACH 1/3 THE EXPOSED HEIGHT OF THE BARRIER.

TUBULAR SEDIMENT BARRIE NOT TO SCALE

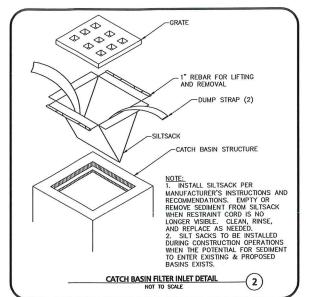

- FROSION CONTROL BARRIE INSTALLED DOWN SLOPE OF PROPOSED STOCKPILE AREA -ECB-PROPOSED STOCKPILE AREA

NOTES:

1. SOIL AND FILL STOCKPILES EXPECTED TO REMAIN IN PLACE FOR LESS THAN 90 DAYS SHALL BE COVERED WITH STRAW AND MULCH (AT 100LBS/1,000 SF), OR WITH AN ANCHORED TARP WITHIN 7 DAYS OR PRIOR TO ANY RAINFALL.

2. SOIL AND FILL STOCKPILES EXPECTED TO REMAIN IN PLACE FOR 90 DAYS OR MORE SHALL BE SEEDED WITH WINTER RYE (FOR FALL SEEDING AT 1LB/1,000 SF) OR OATS (FOR SUMMER SEEDING AT 2LB/1,000 SF) AND THEN COVERED WITH STRAW MULCH (AT 100LB/1,000 SF) OR AN ANCHORED TARP WITHIN 7 DAYS OR PRIOR TO ANY RAINFALL.

STOCKPILE PROTECTION DETAIL


NOT TO SCALE


DIVERSION RIDGE REQUIRED WHERE GRADE EXCEEDS 2% ROADWAY SECTION A SPILLWAY 12' (MIN.) MIN OF 6" THICK

ITES:
THE ENTRANCE SHALL BE MAINTAINED IN A CONDITION THAT WILL PREVENT TRACKING OF FLOWING OF SEDIMENT ONTO PUBLIC RICHT-OF-WAYS. THIS MAY REQUIRE TOP DRESSING REPAIR AID/OR CLEANOUT OF ANY MEASURES USED TO TRAP SEDIMENT.

- WHEN NECESSARY, WHEELS SHALL BE CLEANED PRIOR TO ENTERING THE PUBLIC RIGHT-OF-WAY. WHEN WASHING IS REQUIRED, IT SHALL BE DONE ON AN AREA STABIUZED WITH CRUSHED STONE THAT DRAINS INTO AN APPROVED SEDIMENT TRAP OR SEDIMENT BASIN.
- USE SANDBAGS, STRAW BALES, OR OTHER APPROVED METHODS TO CHANNELIZE RUNOFF TO BASIN AS REQUIRED.

TEMPORARY CONSTRUCTION ENTRANCE

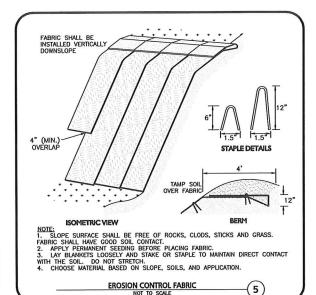


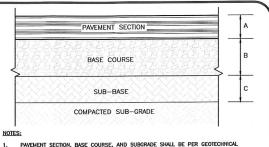



- MENT SECTION, BASE COURSE, AND SUBGRADE SHALL BE PER GEOTECHNICAL NEER'S RECOMMENDATIONS. IN THE ABSENCE OF A GEOTECHNICAL ENGINEER'S OMMENDATION, THE MATERIALS AND THICKNESS SHALL BE AS SHOWN HEREON.
- 3. EXISTING SUBSURFACE SOILS SHALL BE PROOF-ROLLED
- CLEANLY SAW CUT EXISTING PAVEMENT AND ENSURE A SMOOTH TRANSITION BETWEEN EXISTING AND PROPOSED PAVEMENT.


- A = 1.5" ASPHALT CONCRETE SURFACE COURSE (M3.11.0, TABLE A, TOP COURSE)
 2.5" ASPHALT CONCRETE BINDER COURSE (M3.11.0, TABLE A, BINDER COURSE)
- B = 6" PROCESSED GRAVEL BASE (MHD M2.01.7)
- C = 12" BANK RUN GRAYEL MHD M1.03.0 TYPE B)


ASPHALT PAVEMENT SECTION
NOT TO SCALE (6)

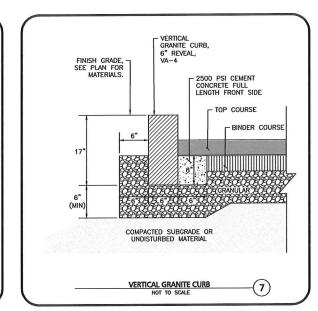

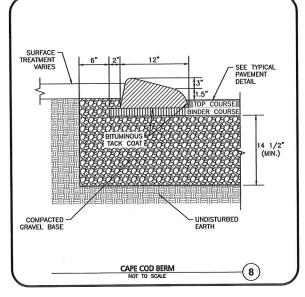

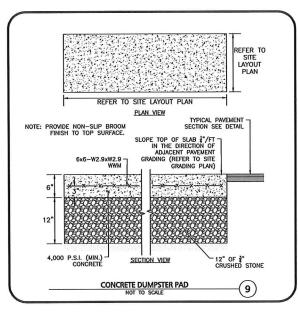

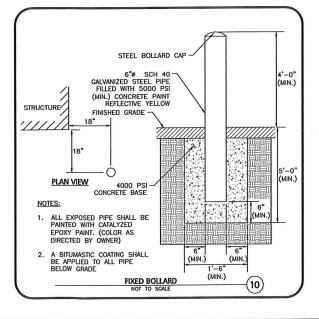

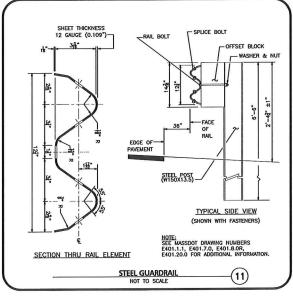



8	01-19-24	REVISED PER REVIEW COMMENTS
7	12-14-23	ISSUED FOR SITE PLAN AMENDMEN
6	10-24-23	REVISED PER CONDITIONS OF APPROVA
5	05-18-23	REVISION 5 PER REVIEW COMMENT
4	05-11-23	REVISION 4 PER REVIEW COMMENT
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REV	DATE	DESCRIPTION

TMC HOLDINGS & DEVELOPMENT 2, LLC 24 WILLIAM WAY BELLINGHAM, MA 02019

25 FORGE PARKWAY FRANKLIN, MA

PROJECT NO. 2712-02A DATE: 02-21-23 AS SHOWN DWG. NAME: C-2712-02/ SM/JRG CHECKED BY: DESIGNED BY:



civil engineering • land surveying somental consulting • landscape architect w w w a ll en m a jor.com 100 COMMERCE WAY, SUITE 5 WOBURN MA 01801 TEL. (781) 935-2896 FAX: (781) 935-2896

C-501

WOBDORN, MA & LAKEVILLE, MA & MANNETIESTER, WITH SPRANNING HAS BEEN PREPARED IN DIGITAL FORMAT, CLIENT/CLIENT'S REPRESENTATIVE OR CONSULTANTS MAY BE PROVIDED CORES OF DRAWNINGS AND SPECIFICATIONS FOR HIS PROPOSED OR SPECIFICATION FOR HIS PROBLET. DUE TO THE POTENTIAL THAT THE PROVIDED INFORMATION MAY BE MODIFIED UNINTERMONALLY OR OTHERWISE, ALLEH & MAJOR ASSOCIATES, INC. MAY REMOVE ALL INDICATION OF THE DOCUMENT AUTHORSHIP ON THE DIGITAL MEDIA, PRINTED REPRESENTATIONS ON DEPOTABLE DOCUMENT FORMAT OF THE DRAWNINGS AND SPECIFICATIONS ISSUED SHALL BE THE ONLY RECORD COPIES OF ALIEN A MAJOR ASSOCIATES, INC. MAY RECORD COPIES OF ALIEN AND MAJOR ASSOCIATES, INC. WAS RECORD. LLEN & MAJOR ASSOCIATES, INC.'S WORK PRO


		ACCEL TABLE THE WATER AD, STORMTER THE SEE		
	MATERIAL LOCATION	DESCRIPTION	AASHTO MATERIAL CLASSIFICATIONS	COMPACTION / DENSITY REQUIREMENT
D	FINAL FILL: FILL MATERIAL FOR LAYER 'D' STARTS FROM THE TOP OF THE 'C' LAYER TO THE BOTTOM OF FLEXIBLE PAVEMENT OR UNPAVED FINISHED GRADE ABOVE. NOTE THAT PAVEMENT SUBBASE MAY BE PART OF THE 'D' LAYER	ANY SOIL/ROCK MATERIALS, NATIVE SOILS, OR PER ENGINEER'S PLANS. CHECK PLANS FOR PAVEMENT SUBGRADE REQUIREMENTS.	N/A	PREPARE PER SITE DESIGN ENGINEER'S PLANS.
С	INITIAL FILL: FILL MATERIAL FOR LAYER 'C' STARTS FROM THE TOP OF THE EMBEDMENT STONE ('B' LAYER) TO 24" (600 mm) ABOVE THE TOP OF THE CHAMBER. NOTE THAT PAYEMENT SUBBASE MAY BE A PART OF THE 'C' LAYER.	GRANULAR WELL-GRADED SOIL/AGGREGATE MIXTURES, <35% FINES OR PROCESSED AGGREGATE. MOST PAVEMENT SUBBASE MATERIALS CAN BE USED IN LIEU OF THIS LAYER.	AASHTO M145' A-1, A-2-4, A-3 OR AASHTO M43' 3, 357, 4, 467, 5, 56, 57, 6, 67, 68, 7, 78, 8, 89, 9, 10	BEGIN COMPACTIONS AFTER 24" (600 mm) OF MATERIAL OVER THE CHAMBERS IS REACHED COMPACT ADDITIONAL LAYERS IN 12" (300 mm) MAX LIFTS TO A MIN. 95% PROCTOR DENSITY FOR WELL GRADEL MATERIAL AND 95% RELATIVE DENSITY FOR PROCESSED AGGREGATE MATERIALS.
В	EMBEDMENT STONE: FILL SURROUNDING THE CHAMBERS FROM THE FOUNDATION STONE ('A' LAYER) TO THE 'C' LAYER ABOVE.	CLEAN, CRUSHED, ANGULAR STONE	AASHTO M43¹ 3, 4	
Α	FOUNDATION STONE: FILL BELOW CHAMBERS FROM THE SUBGRADE UP TO THE FOOT (BOTTOM) OF THE CHAMBER.	CLEAN, CRUSHED, ANGULAR STONE	AASHTO M43¹ 3, 4	PLATE COMPACT OR ROLL TO ACHIEVE A FLAT SURFACE. ^{2,3}


- PLEASE NOTE:

 1. THE LISTED ASSHTO DESIGNATIONS ARE FOR GRADATIONS ONLY. THE STONE MUST ALSO BE CLEAN, CRUSHED, ANGULAR FOR EXAMPLE, A SPECIFICATION FOR #4 STONE WOULD STATE: "CLEAN, CRUSHED, ANGULAR NO. 4 (AASHTO MAS) STONE".

 2. STORMITCH COMPACTION REQUIREMENTS ARE MET FOR "A LOCATION MAINTENANCE WHEN PLACED AND COMPACTED IN 9" (230 mm) (MAX) LIFTS USING TWO FULL COMPACTED IN 9" (240 mm) (MAX) LIFTS USING TWO FULL COMPACTED IN 9" (240 mm) (MAX) LIFTS USING TWO FULL COMPACTED IN 9" (250 mm) (MAX) LIFTS USING TWO FULL COMPACTION OF COMPACTION FOR STANDARD DESIGN LOAD CONDITIONS, A FLAT SURFACE MAY BE ACHIEVED BY RAKING OF REMEMBER OF LANGE OF COMPACTION EQUIREMENTS.

 4. ONCE LARGE "C' IS PLACED, ANY SOLI/MATERNAL CAN BE FLACED IN LAYER "O' UP TO THE FINISHED EARD. MOST PAYEMENT SUBBASE SOILS CAN BE USED TO REPLACE THE MATERIAL REQUIREMENTS OF LAYER "C' OR "O' AT THE SITE DESIGN ENGINEER"S DISCRETION.

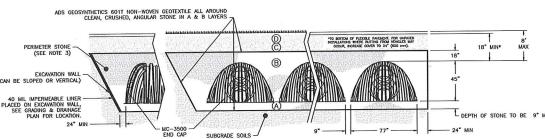

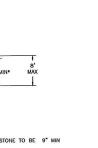

NOTE: INSPECTION PORTS MAY BE CONNECTED THROUGH ANY CHAMBER CORRUGATION VALLEY.

CONCRETE COLLAR NOT
REQUIRED FOR UNPAVED
APPLICATIONS
— 8 NYLOPLAST INSPECTION

PORT BODY (PART# 2708AG4IPKIT) OR TI RATED BOX W/SOLID LOCKING COVER 4" SDR 35

4" PVC INSPECTION PORT

STORMTECH CHAMBER -

NOTES:

- 1. CHAMBERS SHALL MEET THE REQUIREMENTS OF ASTM F2418, "STANDARD SPECIFICATION FOR POLYPROPYLENE (PP) CORRUGATED WALL STORMWATER COLLECTION CHAMBERS CHAMBER CLASSIFICATION 45x76 DESIGNATION SS.
- 2. MC-3500 CHAMBERS SHALL BE DESIGNED IN ACCORDANCE WITH ASTM F2787 "STANDARD PRACTICE FOR STRUCTURAL DESIGN OF THERMOPLASTIC CORRUGATED WALL STORMWATER

- COLLECTION CHAWBERS".

 3. PERIMETER STONE MUST BE EXTENDED HORIZONTALLY TO THE EXCAVATION WALL FOR BOTH VERTICAL AND SLOPED EXCAVATION WALLS.

 4. REQUIREMENTS FOR HANDLING AND INSTALLATION:

 TO MAINTAIN THE WIDTH OF CHAWBERS DURING SHIPPING AND HANDLING, CHAMBERS SHALL HAVE INTEGRAL, INTERLOCKING STACKING LUGS.

 TO ENSURE A SECURE JOINT DURING INSTALLATION AND BACKFILL, THE HEIGHT OF THE CHAWBER JOINT SHALL NOT BE LESS THAN 3C.

 TO ENSURE THE INTEGRITY OF THE ARCH SHAPE DURING INSTALLATION, a) THE ARCH STIFFNESS CONSTANT AS DEFINED IN SECTION 6.2.8 OF ASTM F2418 SHALL BE CHAMBERS SHALL BE PRODUCED FROM REFLECTIVE GOLD OR YELLOW COLORS.

MC-3500 - CROSS SECTION DETAIL

MC-3500 STORMTECH CHAMBER SPECIFICATIONS

- 2. CHAWBERS SHALL BE ARCH-SHAPED AND SHALL BE MANUFACTURED FROM VIRGIN, IMPACT-MODIFIED POLYPROPYLENE COPOLYMERS.
- CHAMBERS SHALL MEET THE REQUIREMENTS OF ASTM F2418, "STANDARD SPECIFICATION FOR POLYPROPYLENE (PP) CORRUGATED WALL STORMWATER COLLECTION CHAMBERS" CHAMBER CLASSIFICATION 45x76 DESIGNATION SS.
- CHAMBER ROWS SHALL PROVIDE CONTINUOUS, UNOBSTRUCTED INTERNAL SPACE WITH NO INTERNAL SUPPORTS THAT WOULD IMPEDE FLOW OR LIMIT ACCESS FOR INSPECTION.
- THE STRUCTURAL DESIGN OF THE CHAMBERS, THE STRUCTURAL BACKFILL, AND THE INSTALLATION REQUIREMENTS SHALL ENSURE THAT THE LOAD FACTORS SPECIFIED IN THE AMSHTO LEFF BRIDGE DESIGN SPECIFICATIONS, SECTION 12.12, ARE MET FOR: 1) LONG-DURATION DEAD LOADS AND 2) SHORT-DURATION LIVE LOADS, BASED ON THE AMSHTO DESIGN TRUCK WITH CONSIDERATION FOR IMPACT AND MULTIFLE VEHICLE PRESENCES.
- CHAMBERS SHALL BE DESIGNED, TESTED AND ALLOWABLE LOAD CONFIGURATIONS DETERMINED IN ACCORDANCE WITH ASTM F2787, "STANDARD PRACTICE FOR STRUCTURAL DESIGN OF THERMOPLASTIC CORRUGATED WALL STORMATER COLLECTION CHAMBERS". LOAD CONFIGURATIONS SHALL INCLUDE: 1) INSTANTANEOUS (<1 IMP) ASSHED DESIGN TRUCK LIVE LOAD ON MINIMUM COVER 2) MAXIMUM PERMANENT (75—YR) COVER LOAD AND 3) ALLOWABLE COVER WITH PARKED (1—NEEK). ASSHED DESIGN TRUCK.

- REQUIREMENTS FOR HANDLING AND INSTALLATION:

 TO MANTAIN THE WIDTH OF CHAMBERS DURING SHIPPING AND HANDLING, CHAMBERS SHALL HAVE INTEGRAL, INTERLOCKING STACKING LUGS.

 TO INSURE A SECURE SOUNT DURING INSTALLATION AND BACKFILL, THE HEIGHT OF THE CHAMBER JOINT SHALL NOT BE LESS THAN SJ.

 TO ENSURE THE INTEGRITY OF THE ARCH SHAPE DURING INSTALLATION, a) THE ARCH STIFFNESS CONSTANT SHALL BE GREATER THAN OR EQUAL TO 450
 LBS/F1/X. THE ASC IS DEFINED IN SECTION 6.2.8 DF ASTIM F2418. AND b) TO RESIST CHAMBER ORAZINON DURING INSTALLATION AT ELEVATED
 TEMPERATURES (ABOVE 73' F / 23' C), CHAMBERS SHALL BE PRODUCED FROM REFLECTIVE GOLD OR YELLOW COLORS.
- ONLY CHAMBERS THAT ARE APPROVED BY THE SITE DESIGN ENGINEER WILL BE ALLOWED, UPON REQUEST BY THE SITE DESIGN ENGINEER OR OWNER, THE CHAMBER MANUFACTURER SHALL SUBMIT A STRUCTURAL EVALUATION FOR APPROVAL BEFORE DELIVERING CHAMBERS TO THE PROJECT SITE AS FOLLOWS:


 THE STRUCTURAL EVALUATION SHALL BE SEALED BY A REGISTERED PROFESSIONAL ENGINEER THAN OR EQUAL TO 1.95 FOR DEAD LOAD AND 1.75 FOR LIVE LOAD, THE MINIMUM REQUIRED BY ASTM 72787 AND BY SECTIONS 3 AND 12.12 OF THE ASSHTO LRFD BRIDGE DESIGN SPECIFICATIONS FOR THERMOPHOLSTIC PIPE.

- THERMOPLASTIC PIPE.

 THE TEST DERIVED CREEP MODULUS AS SPECIFIED IN ASTM F2418 SHALL BE USED FOR PERMANENT DEAD LOAD DESIGN EXCEPT THAT IT SHALL BE THE 75-YEAR MODULUS USED FOR DESIGN.
- 9. CHAMBERS AND END CAPS SHALL BE PRODUCED AT AN ISO 9001 CERTIFIED MANUFACTURING FACILITY.




STORMTECH MC-3500 CHAMBER SYSTEM

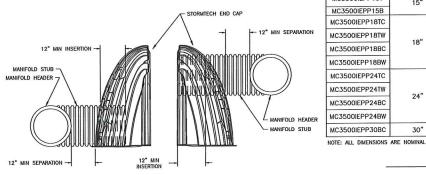


NOTE: MANIFOLD STUB MUST BE LAID HORIZONTAL FOR A PROPER FIT IN END CAP OPENING.

END CAP INSERTION DETAIL

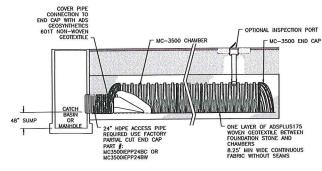

MC-3500 - ISOLATOR ROW PLUS DETAIL

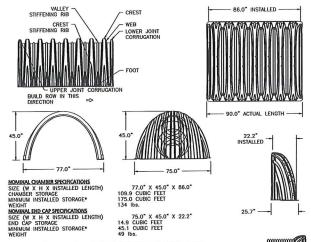

PARTIAL CUT HOLES AT BOTTOM OF END CAP FOR PART NUMBERS ENDING WITH "B" PARTIAL CUT HOLES AT TOP OF END CAP FOR PART NUMBERS ENDING WITH "T" END CAPS WITH A PREFABRICATED WELDED STUB END WITH "W" END CAPS WITH A WELDED CROWN PLATE END WITH "C"

PART#	STUB	В	С	c
MC3500IEPP06T	6"	33.21"		<u>+ www.ya//L/111</u>
MC3500IEPP06B			0.66"	CUSTOM PARTIAL CUT INVERTS
MC3500IEPP08T	8"	31.16"		ARE AVAILABLE UPON REQUEST. INVENTORIED MANIFOLDS INCLUDE 12-24
MC3500IEPP08B			0.81"	SIZE ON SIZE AND 15-48"
MC3500IEPP10T	10"	29.04"		ECCENTRIC MANIFOLDS. CUSTOM INVERT LOCATIONS ON THE MC-3500 END CAP CUT
MC3500IEPP10B			0.93"	IN THE FIELD ARE NOT RECOMMENDED FOR PIPE
MC3500IEPP12T	12"	26.36"		SIZES GREATER THAN 10". THE INVERT LOCATION IN
MC3500IEPP12B			1.35"	COLUMN 'B' ARE THE HIGHEST POSSIBLE FOR THE PIPE SIZE.
MC3500IEPP15T	15"	23.39"		
MC3500IEPP15B	CONTROL I		1.50"	
MC3500IEPP18TC		20.03"		
MC3500IEPP18TW	18"	20.00		
MC3500IEPP18BC	10		1.77"	
MC3500IEPP18BW		***		
MC3500IEPP24TC		14.48"		
MC3500IEPP24TW	24"	14.40		
MC3500IEPP24BC	24		2.06"	
MC3500IEPP24BW		Ampter City	2.30	
MC3500IEPP30BC	30"		2.75"	

TECHNICAL SPECIFICATIONS

INSPECTION & MAINTENANCE

- STEP 1) INSPECT ISOLATOR ROW PLUS FOR SEDIMENT
 A. INSPECTION PORTS (IF PRESENT)
 A.1. REMOYE/OPEN ID ON INTLOPLAST INLINE DRAIN
 A.2. REMOYE AND CLEAN FLEXSTORM FILER IF INSTALLED
 A.3. USING A FLEXSHIGHT AND STADAR ROB, MESSURE DEPTH OF SEDIMENT AND RECORD ON

 - LOWER A FIASHIGHT AND STADA ROD, MEASURE DEPTH OF SEDIMENT AND RECORD ON MAINTENANCE LOD

 A. LOWER A COMERN HITO ISOLATOR ROW PLUS FOR VISUAL INSPECTION OF SEDIMENT AND LOWER A COMERN HITO ISOLATOR ROW PLUS FOR SUBJECT IS AT INCIDENT INCIDEN
- STEP 2) CLEAN OUT ISOLATOR ROW PLUS USING THE JETVAC PROCESS
 A. A FIXED CULVERT CLEANING NOZZLE WITH REAR FACING SPREAD OF 45" (1.1 m) OR MORE IS PREFERRED.
- IS PREFERRED

 B. APPLY MULTIPLE PASSES OF JETVAC UNTIL BACKFLUSH WATER IS CLEAN
 C. VACUUM STRUCTURE SUMP AS REQUIRED
- STEP 3) REPLACE ALL COVERS, GRATES, FILTERS, AND LIDS; RECORD OBSERVATIONS AND ACTIONS
- STEP 4) INSPECT AND CLEAN BASINS AND MANHOLES UPSTREAM OF THE STORMTECH SYSTEM.

- INSPECT EVERY 6 MONTHS DURING THE FIRST YEAR OF OPERATION. ADJUST THE INSPECTION INTERVAL BASED ON PREVIOUS OBSERVATIONS OF SEDIMENT ACCUMULATION AND HIGH WATER ELEVATIONS.
- CONDUCT JETTING AND VACTORING ANNUALLY OR WHEN INSPECTION SHOWS THAT MAINTENANCE IS NECESSARY.



PROFESSIONAL ENGINEER FOR ALLEN & MAJOR ASSOCIATES, INC.

7	12-14-23	ISSUED FOR SITE PLAN AMENDMEN
6	10-24-23	REVISED PER CONDITIONS OF APPROV
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TMC HOLDINGS & DEVELOPMENT 2, LLC 24 WILLIAM WAY BELLINGHAM, MA 02019

25 FORGE PARKWAY FRANKLIN, MA

PRO	DJECT NO.	2712-02A	DATE:	02-21-23
sc	ALE:	AS SHOWN	DWG. NAME:	C-2712-02A
DES	IGNED BY:	SM/JRG	CHECKED BY:	BD.


ALLEN & MAJOR


ASSOCIATES, INC. civil engineering + land surveying
onmental consulting + landscape architec
w w w a llen m ajor.com
100 COMMERCE WAY, SUITE 5
WOBURN MA 01801
TEL: (781) 935-8889
FAX: (781) 935-2896


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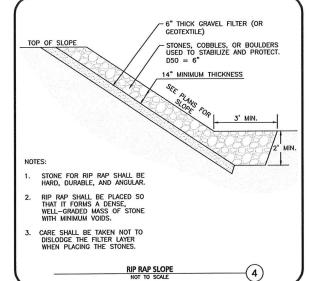
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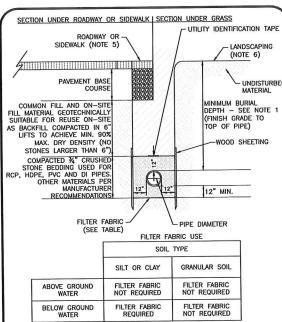






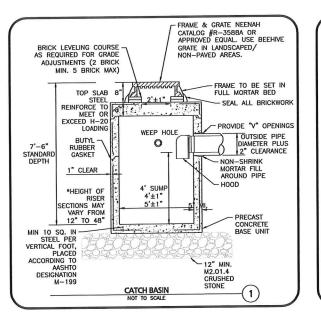

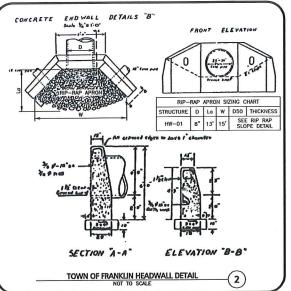

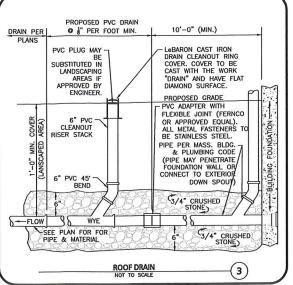

MINIMUM BURIAL DEPTH (FINISH GRADE TO TOP OF PIPE)

GRAVITY PIPE (SEWER & DRAIN) — SEE PLAN OR PROFILE, PROVIDE INSULATION WHERE COVER IS LESS THAN 4' OVER SEWER

INSULATION WHERE COVER IS LESS THAN 4' OVER SEWER

PRESSURE PIPE UNDER PAVING — 4'

PRESSURE PIPE BENEATH UNPAVED — 3'

WATER PIPE — 5'

WHERE BACKFILL IS DESIGNATED AS COMPACTED, THIS MEANS 90 TO 95% STANDARD PROCTOR. AASHTO T—99. ALL FILL PLACED BELOW PIPES AND STRUCTURES MUST MEET THIS REQUIREMENT.

TRENCHES WITHIN PUBLIC RIGHT OF WAY MAY REQUIRE FLOWABLE FILL. VERIFY WITH MUNICIPAL ENGINEER.

WHERE WASTE FILLS ARE ENCOUNTERED AT SUBGRADE LEVEL FOR NEW UTILITIES, THE FILL SHOULD BE OVER—EXCAMTED, THE SUBGRADE SHOULD BE RE—COMPACTED, AND BACKFILL CONSISTING OF PIPE BEDDING MATERIAL, CRUSHED STONE OR OTHER SUITABLE GRANULAR FILL SHOULD BE PLACED TO A SUFFICIENT DEPTH TO CREATE A FIRM AND STABLE SUBGRADE (TYPICALLY 12 TO 18 INCHES OVER—EXCAVATION).

REFER TO PAVING, CURBS, WALKS AND DRIVEWAY DETAILS.

REFER TO LANDSCAPING DETAILS.


SHEETING, WHEN REQUIRED, TO BE CUT OFF AT LEAST 5' BELOW STREET AND A MINIMUM OF 1' ABOVE TOP OF PIPE. WOOD SHEETING DRIVEN BELOW MID—DIAMETER OF THE PIPE SHALL BE LEFT IN PLACE.


SHEETING DRIVEN BELOW MID—DIAMETER MAY BE WITHDRAWN IF APPROVED IN WIRDING BY THE ENGINEER. FOR PVC PIPE ALL SHEETING DRIVEN BELOW MID—DIAMETER SHALL BE LEFT IN PLACE.


WHEN APPROVED BY THE ENGINEER. FOR PIPES OTHER THAN PVC, SELECTED GRAVEL FILL MATERIAL MAY BE USED FROM MID—DIAMETER FOR PIPE TO 12"


ABOVE TOP OF PIPE. NO STONES LARGER THAN 2" IN ANY DIMENSION WILL BE PERMITTED IN THIS SAREA—MASSDOT MATERIAL STANDARD M.1.0.3.0 TYPE C.

PROVIDE AT LEAST ONE IMPERVIOUS DAM IN GRAVEL BEDDING BETWEEN

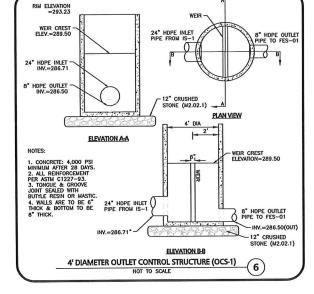

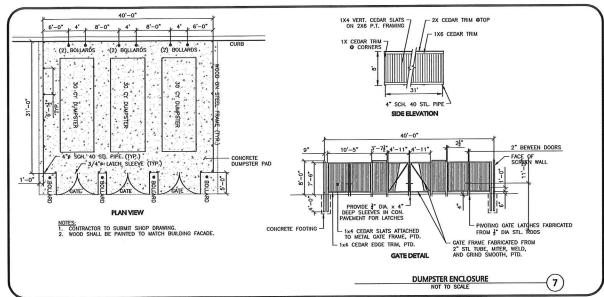

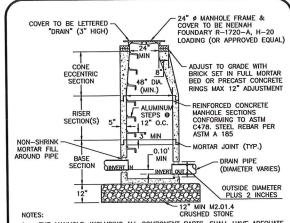

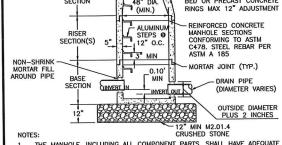

1. THE MANHOLE, INCLUDING ALL COMPONENT PARTS, SHALL HAVE ADEQUATE SPACE AND STRENGTH QUALITIES CONSIDERED NECESSARY FOR THE INTENDED SERVICE. SPACE REQUIREMENT AND CONFIGURATIONS SHALL BE AS SHOWN ON THE DRAWING. THE COMPLETE STRUCTURE SHALL BE OF SUCH MATERIAL AND QUALITY AS TO WITHSTAND (H-20 LOADING) WITHOUT FAILURE.

VERTICAL FOOT OF MANHOLE. DRAIN MANHOLE

FIBERGLASS SEPARATION FLOW OUTLET PIPE OIL BAFFLE-SEPARATION SCREEN PVC HYDRAULIC SHEAR PLATE ELEVATION A-A INSTALLATION NOTES

A. INSTALL PER MANUFACTURER'S RECOMMENDATIONS.
B. CONTRACTOR TO PROVIDE EQUIPMENT WITH SUFFICIENT LIFTING AND REACH CAPACITY TO LIFT AND SET E. CONTRACTOR TO FROMBE EQUIPMENT WITH SUFFICIENT LIFTING AND REACH CAPACITY TO LIFT THE COS MANHOL STRUCTURE. C. CONTRACTOR TO INSTALL JOINT SEALANT BETWEEN ALL STRUCTURE SECTIONS AND ASSEMBLE STRUCTURE.


WWW.ContechES.com
A. COS WATER QUALITY STRUCTURE SHALL BE IN ACCORDANCE WITH
ALL DESIGN DATA AND INFORMATION CONTRANED IN THIS DRAWING
CONTRACTOR TO CONTRIM STRUCTURE MEETS REQUIREMENTS OF
PROJECT.
STRUCTURE SHALL MEET AGSHTO HS20 LODD RATING, ASSUMING
EARTH COVER OF 0" 2", AND GROUNDWATER ELEVATION AT, OR
BELOW, THE OUTLET PIPE HUWERT ELEVATION. ENGINEER
RECORD TO CONTRIM ACTUAL GROUNDWATER LEVATION CONTRINGS
STALL MEET AASHTO MSGG AND BE CAST WITH THE CONTECH

SPEC. MELI MOSHIO MODE AND BE COST WITH THE CONTRICT.

SI PEQUINED, PYC HYDRAULIC SHEAP PLATE IS PLACED ON SHELF
AT BOTTOM OF SCREEN CYLINDER. REMOVE AND REPLACE AS
NECESSARY DURING MAINTENANCE CLEANING.

C. COS STRUCTURE SHALL BE PRECAST CONCRETE CONFORMING TO
ASTM C-478 AND ASSHOT LOAD FACTOR DESIGN METHOD.

PROPRIETARY WATER QUALITY DEVICE (CDS1515-3) (9)

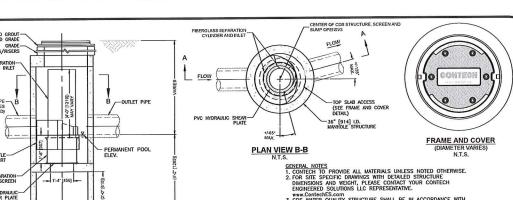

PROFESSIONAL FNGINEER FOR

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APPLICANT\OWNER:

TMC HOLDINGS & DEVELOPMENT 2, LLC 24 WILLIAM WAY BELLINGHAM, MA 02019

25 FORGE PARKWAY FRANKLIN, MA

02-21-23 PROJECT NO. 2712-02A DATE: SCALE-AS SHOWN DWG. NAME: C-2712-02A SM/JRG CHECKED BY: DESIGNED BY:



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100 COMMERCE WAY, SUITE 5
WOBURN MA 01801
TEL: (781) 935-6889
FAX: (781) 935-2896

DBURN, MA . LAKEVILLE, MA . MANCHESTER.

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PARTICIPATIONS DESCRIPTIONS OF THE DOCUMENT SOURCE.

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C-503 **DETAILS**

C. PROVIDE AT LEAST ONE IMPERVIOUS DAM IN GRAVEL BEDDING BETWEEN EACH MANHOLE WHERE DIRECTED, OR EVERY 300 FT, WHICHEVER IS LESS. BEDDING MATERIAL FOR PVC PIPE SHALL MEET THE REQUIREMENTS OF ASTM D2321 CLASS I OR CLASS II EMBEDMENT MATERIALS. UTILITY TRENCH DETAIL

STRUCTURE.

O. CONTRACTOR TO PROVOE, INSTALL, AND GROUT INLET AND OUTLET PIPE(S). MATCH PIPE INVERTS WITH ELEVATIONS SHOWN. ALL PIPE CENTERLINES TO MATCH PIPE OPENING CENTERLINES.

E. CONTRACTOR TO TAKE APPROPRIATE MEASURES TO ASSURE UNIT IS WHERE RIGHT, HOLDING WATER TO FLOWING INVERT MEASURES. THAT ALL JOINTS BELOW PIPE INVERTS ARE GROUTED.

PLEASE NOTE


- LEASE RULE:

 THE LISTED ASHTO DESIGNATIONS ARE FOR GRADATIONS ONLY. THE STONE MUST ALSO BE CLEAN, CRUSHED, ANGULAR, FOR EXAMPLE, A SPECIFICATION FOR #4 STONE WOULD STATE: "CLEAN, CRUSHED, ANGULAR NO. 4 (AASHTO M43) STONE".

 STORMITCH COMPACTION REQUIREMENTS ARE MET FOR "A" LOCATION MATERIALS WHEN PLACED AND COMPACTED IN 6" (MAX) LITS USING TWO FULL COVERAGES WITH A VIBRATORY COMPACTOR.


 WHERE INFLITEATION SURFACES MAY BE COMPROMISED BY COMPACTION, FOR STANDARD DESIGN LOAD CONDITIONS, A FLAT SURFACE MAY BE ACHIEVED BY RAKING OR DRAGGING WITHOUT COMPACTION EQUIPMENT. FOR SPECIAL LOAD DESIGNS, CONTACT STORMITECH FOR COMPACTION REQUIREMENTS.
- CONIACT SIGNATECH FOR COMPACTION REQUIREMENTS.

 4. ONCE LYTER 'C' IS PLACED, AIM' SOIL/MATERIAL CAN BE PLACED IN LAYER 'D' UP TO THE FINISHED GRADE. MOST PAVEMENT SUBBASE SOILS CAN BE USED TO REPLACE THE MATERIAL REQUIREMENTS OF LAYER 'C' OR 'D' AT THE SITE DESIGN ENGINEER'S DISCRETION.

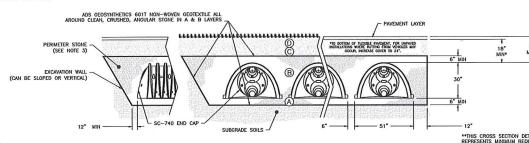

- CHAMBERS SHALL MEET THE REQUIREMENTS OF ASTM F2418, "STANDARD SPECIFICATION FOR POLYPROPYLENE (PP) CORRUGATED WALL STORMWATER COLLECTION CHAMBERS". 2. SC-740 CHAMBERS SHALL BE DESIGNED IN ACCORDANCE WITH ASTM F2787 "STANDARD PRACTICE FOR STRUCTURAL DESIGN OF THERMOPLASTIC CORRUGATED WALL
- STORMWATER COLLECTION CHAMBERS". 3. PERIMETER STONE MUST BE EXTENDED HORIZONTALLY TO THE EXCAVATION WALL FOR BOTH VERTICAL AND SLOPED EXCAVATION WALLS

- EMBRIER STORE WISH BE EXTENDED FOR NOTIONAL TO THE EXCENSION WALL FOR BOTH TEXTURE AND SECTED BY EXCENSION OF THE ARCHIVE STATE OF THE GREATER THAN OR EQUAL TO 550 LBS/FT/%, AND b) TO RESIST CHAMBER DEFORMATION DURING INSTALLATION AT ELEVATED TEMPERATURES (ABOVE 73° F / 23° C), CHAMBERS SHALL BE PRODUCED FROM REFLECTIVE GOLD OR YELLOW COLORS.

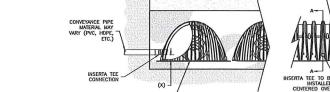

TOONTACT ADS ENGINEERING SERVICES IF INSERTA
TEE INLET MUST BE RAISED AS NOT ALL INVERTS
ADE POSSIBLE

SC-740 - CROSS SECTION DETAIL

SC-740 STORMTECH CHAMBER SPECIFICATIONS

1. CHAMBERS SHALL BE STORMTECH SC-740.

Systems, Inc.

- CHAMBERS SHALL BE ARCH-SHAPED AND SHALL BE MANUFACTURED FROM VIRGIN, IMPACT-MODIFIED POLYPROPYLENE COPOLYMERS.
- CHAMBER ROWS SHALL PROVIDE CONTINUOUS, UNOBSTRUCTED INTERNAL SPACE WITH NO INTERNAL SUPPORTS THAT WOULD IMPEDE FLOW OR LIMIT ACCESS FOR INSPECTION.

- THE TEST DERIVED CREEP MODULUS AS SPECIFIED IN ASTM F2418 SHALL BE USED FOR PERMANENT DEAD LOAD DESIGN EXCEPT THAT IT SHALL BE THE 75-YEAR MODULUS USED FOR DESIGN.

WATER QUALITY ONE LAYER OF ADSPLUS125 WOVEN GEOTEXTILE BETWEEN FOUNDATION STONE AND CHAMBERS 5' MIN WIDE CONTINUOUS FABRIC WITHOUT SEAL

SC-740 - ISOLATOR ROW PLUS DETAIL

CHAMBER SC-740

INSERTA-TEE SIDE INLET DETAIL

- CHAMBERS SHALL MEET THE REQUIREMENTS OF ASTM F2418, "STANDARD SPECIFICATION FOR POLYPROPYLENE (PP) CORRUGATED WALL STORMWATER COLLECTION CHAMBERS".
- THE STRUCTURAL DESIGN OF THE CHAMBERS, THE STRUCTURAL BACKFILL, AND THE INSTALLATION REQUIREMENTS SHALL ENSURE THAT THE LOAD FACTORS SPECIFIED IN THE AMSHTO LIRTD BRIDGE DESIGN SPECIFICATIONS, SECTION 1.21, ARE MET FOR: 1) LONG-DURATION FEAD LOADS AND 2) SHORT-DURATIO LIVE LOADS, BASED ON THE AMSHTO DESIGN TRUCK WITH CONSIDERATION FOR IMPACT AND MULTIPLE VEHICLE PRESENCES.
- 6. CHAMBERS SHALL BE DESIGNED, TESTED AND ALLOWABLE LOAD CONFIGURATIONS DETERMINED IN ACCORDANCE WITH ASTIM F2787. "STANDARD PRACTICE FOR STRUCTURAL DESIGN OF THERMOPASTIC CORRUGATED WALL STRUMMATER COLLECTION CHAMBERS". LOAD CONFIGURATIONS SHALL INCLUDE: 1) INSTANTANEOUS (51 MIN) ASSIMO DESIGN TRUCK LIVE LOAD ON MINIMUM COVER 2) MAXIMUM PERMA (75-WR) COVER LOAD AND 3) ALLOWABLE COVER WITH PARKE (11-WEEC) ASSIMO TESSIMI TRUCK.

- (75-11) COVER LOJO AND 3) ALCOMORDE COVER HIT PRICED ("HELEY) SAND DESIGN TROCKS.

 REQUIREMENTS FOR HANDLING AND INSTALLATION:

 10 MAINTAIN THE WIDTH OF CHAMBERS DURING SHIPPING AND HANDLING, CHAMBERS SHALL HAVE INTERCLALLY INTERCLALING STACKING LUGS.

 10 ENSURE A SECURE JOINT DURING INSTALLATION AND BACKFILL, THE HEIGHT OF THE CHAMBER JOINT SHALL NOT BE LESS THAN 2.0.

 10 ENSURE THE INTEGRITY OF THE ARCH SHAPE DURING INSTALLATION, 0) THE ARCH STIFFINESS CONSTANT SHALL BE GREATER THAN OR EQUAL TO 550 LBS/FT/%. THE ASC IS DEFINED IN SECTION 6.2.8 OF ASTM F2418. AND b) TO RESIST CHAMBER DEFORMATION DURING INSTALLATION AT LELYATED TEMPERATURES (MOVE 73" F / 23" C), CHAMBERS SHALL BE PRODUCED FROM REFLECTIVE GOLD OR YELLOW COLORS.
- ONLY CHAMBERS THAT ARE APPROVED BY THE SITE DESIGN ENGINEER WILL BE ALLOWED. UPON REQUEST BY THE SITE DESIGN ENGINEER OR OWNER, THE CHAMBER MANUFACTURER SHALL SUBMIT A STRUCTURAL EVALUATION FOR APPROVAL BEFORE DELIVERING CHAMBERS TO THE PROJECT SITE AS FOLLOWS:


 THE STRUCTURAL EVALUATION SHALL BE SEALED BY A REGISTRED PROFESSIONAL ENGINEER.

 HE STRUCTURAL EVALUATION SHALL DE SEALED BY A REGISTRED PROFESSIONAL ENGINEER.

 THE STRUCTURAL EVALUATION SHALL DEMONSTRATE THAT THE APICTY FACTORS ARE GREATER THAN OR EQUAL TO 1.55 FOR DEAD CLOS AND 1.75 FOR LIVE LOVO, THE MINIMINI REQUIRED BY ASTAM FACTOR OF THE APICTY OF THE ASSISTED LATED BRIDGE DESIGN SPECIFICATIONS FOR THE TEST DEPORT OFFSET HONLOWS.
- CHAMBERS AND END CAPS SHALL BE PRODUCED AT AN ISO 9001 CERTIFIED MANUFACTURING FACILITY

STORMTECH SC-740 CHAMBER SYSTEM

90.7" (2304 mm) ACTUAL LENGTH

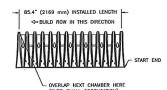







NOMINAL CHAMBER SPECIFICATIONS SIZE (W X H X INSTALLED LENGTH)

12" (300 mm) MIN WIDTH

NOTE: INSPECTION PORTS MAY BE CONNECTED THROUGH ANY CHAMBER CORRUGATION CREST.

4" PVC INSPECTION PORT

SIDE VIEW

MAX DIAMETER OF HEIGHT FROM BASE OF CHAMBER (X)

SC-740 END CAP

CONCRETE COLLAR

STORMTECH CHAMBER -

PAVEMENT

- CONCRETE COLLAR NOT REQUIRED FOR UNPAVED

PPLICATIONS

- 8* NYLOPLAST INSPECTION
PORT BODY (PART#
2708A94IPKIT) OR TRAFFIC
RATED BOX W/SOLID LOCKI
COVER
SDR 35 PIPE

TO BE CENTERED ON CORRUGATION CREST

*ASSUMES 6" STONE ABOVE, BELOW, AND BETWEEN CHAMBERS



PRE-FAB STUB AT BOTTOM OF END CAP WITH FLAWP END WITH "BR"
PRE-FAB STUBS AT BOTTOM OF END CAP FOR PART NUMBERS ENDING

PART #	STUB	A	В	С
SC740EPE06T / SC740EPE06TPC	6*	10.9"	18.5"	
SC740EPE06B / SC740EPE06BPC		10.9		0.5"
SC740EPE08T SC740EPE08TPC	22		16.5"	
SC740EPE08B / SC740EPE08BPC	8"	12.2"		0.6"
SC740EPE10T / SC740EPE10TPC			14.5"	
C740EPE10B / C740EPE10BPC	10*	13.4"		0.7
C740EPE12T / C740EPE12TPC	12"	44.75	12.5"	
C740EPE12B / C740EPE12BPC	12	14.7"		1.2"
C740EPE15T / C740EPE15TPC			9.0"	
C740EPE15B / C740EPE15BPC	15"	18.4"		1.3"
C740EPE18T / C740EPE18TPC	405	40.75	5.0"	
C740EPE18B / C740EPE18BPC	18"	19.7"		1.6"
SC740EPE24B*	24"	18.5"		0.1
C740EPE24BR*	24"	18.5"		0.1"

ALL STUBS, EXCEPT FOR THE SC740EPE24B/SC740EPE24BR ARE PLACED AT BOTTOM OF END CAP SUCH THAT THE OUTSIDE DWAFEER OF THE STUB IS FLUSH WITH THE BOTTOM OF THE END CAP, FOR ADDITIONAL INFORMATION CONTACT STORMETCH AT 1-888-892-2694.

NOTE: ALL DIMENSIONS ARE NOMINAL

SC-740 - TECHNICAL SPECIFICATIONS

INSPECTION & MAINTENANCE

STEP 1) INSPECT ISOLATOR ROW PLUS FOR SEDIMENT
A INSPECTION PORTS (IF PRESENT)
A.1. REMOVE/OPEN LID ON INTLOFLAST INLINE DRAIN
A.2. REMOVE AND CLEAN FLESSTORM FILTER IF INSTALLED
A.3. USING A FLASHLIGHT AND STADA ROD, MEASURE DEPTH OF SEDIMENT AND
RECORD ON MAINTENANCE LOG
A.4. LOWER A CAMERA INTO ISOLATOR ROW PLUS FOR VISUAL INSPECTION OF
SEDIMENT LEVELS (OPTIONAL)

, OR ABOVE, 3" (80 mm) PROCEED TO STEP 2. IF NOT,

VOLLEL PUPE.

JO MIRRORS ON POLES OR CAMERAS MAY BE USED TO AVOID A CONFINED SPACE ENTRY

I) FOLLOW OSHA REGULATIONS FOR CONFINED SPACE ENTRY IF ENTERING MANHOLE. B.3. IF SEDIMENT IS AT, OR ABOVE, 3" (80 mm) PROCEED TO STEP 2. IF NOT, PROCEED TO STEP 3.

STEP 2) CLEAN OUT ISOLATOR ROW PLUS USING THE JETVAC PROCESS
A. A FIXED CULYERT CLEANING NOZZLE WITH REAR FACING SPREAD OF 45" (1.1 m)
OR MORE IS PREFERRED
B. APPLY MULTIPLE PASSES OF JETVAC UNTIL BACKFLUSH WATER IS CLEAN
C. VACULUM STRUCTURE SUMP AS REQUIRED

STEP 3) REPLACE ALL COVERS, GRATES, FILTERS, AND LIDS; RECORD OBSERVATIONS AND ACTIONS.

STEP 4) INSPECT AND CLEAN BASINS AND MANHOLES UPSTREAM OF THE STORMTECH SYSTEM.

NOTES

INSPECT EVERY 6 MONTHS DURING THE FIRST YEAR OF OPERATION. ADJUST THE INSPECTION INTERVAL BASED ON PREVIOUS OBSERVATIONS OF SEDIMENT ACCUMULATION AND HIGH WATER ELEVATIONS.

CONDUCT JETTING AND VACTORING ANNUALLY OR WHEN INSPECTION SHOWS THAT MAINTENANCE IS NECESSARY.



PROFESSIONAL ENGINEER FOR ALLEN & MAJOR ASSOCIATES, INC.

REV	DATE	DESCRIPTION	
ADDITION	ADDITIONALLY CHARLED.		

TMC HOLDINGS & DEVELOPMENT 2, LLC 24 WILLIAM WAY BELLINGHAM, MA 02019

25 FORGE PARKWAY FRANKLIN, MA

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SCALE:	AS SHOWN	DWG. NAME:	C-2712-02A
DESIGNED BY:	SM/JRG	CHECKED BY:	BDJ




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C-504

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SPECIFICATIONS ESSENDED SALL BY THE ORDER OF THE DISCUSSION OF THE DISCUS

DETAILS

COVER ENTIRE ISOLATOR ROW PLUS WITH ADS GEOSYNTHETICS 601T NON-WOVEN

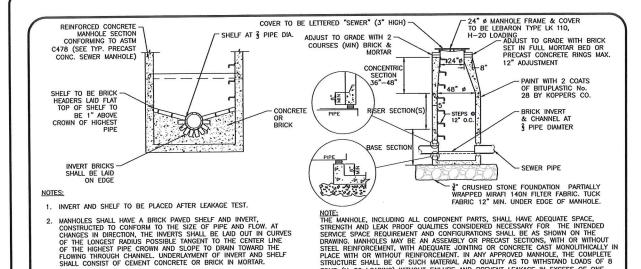


APPROVED PERFORMED RUBBER-LIKE GASKET ROLLS OUT RUBBER-LIKE BITUMASTIC SEALANT O-RING SET IN RECESS OF RECESS ASPHALT IMPREGNATED POLYURETHANE GASKET ROLL-N-LOK (OR EQUAL) POI YTITE BITUMASTIC (OR EQUAL) NOTES:


1. HORIZONTAL JOINTS BETWEEN SECTIONS OF PRECAST CONCRETE BARRELS SHALL BE OF A TYPE APPROVED BY THE ENGINEER, WHICH SHALL, IN GENERAL, DEPEND FOR WATER TIGHTNESS UPON AN ELASTOMERIC OR MASTIC—LIKE GASKET.

2. ALL GASKETS AND SEALANTS SHALL BE INSTALLED IN ACCORDANCE WITH MANUFACTURER'S WRITTEN INSTRUCTIONS.


3. FOR BITUMASTIC TYPE JOINTS THE AMOUNT OF SEALANT SHALL BE SUFFICIENT TO FILL AT LEAST 75% OF THE JOINT CAVITY.

SEWER MANHOLE JOINTING METHODS

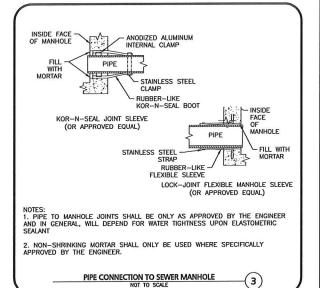


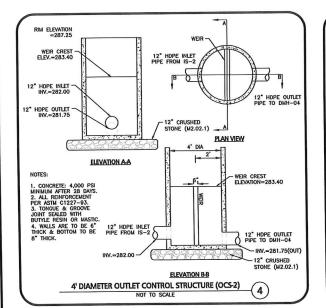



SHALL CONSIST OF CEMENT CONCRETE OR BRICK IN MORTAR

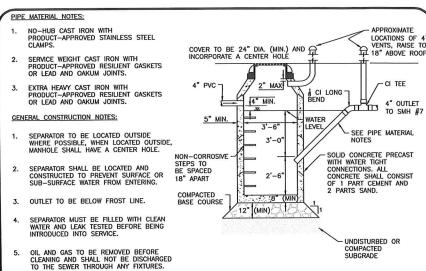

GAS AND OIL SEPARATOR

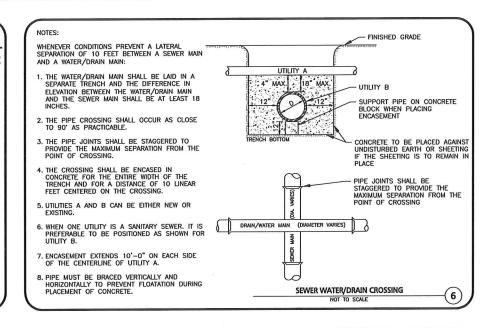

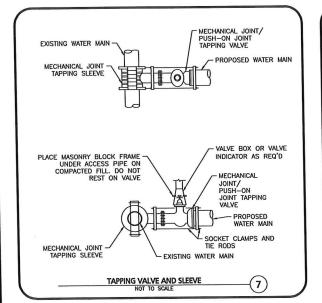


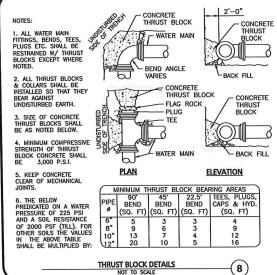


INLET SHALL BE SET A MINIMUM OF THREE FEET BELOW GRADE

TONS (H-20 LOADING) WITHOUT FAILURE AND PREVENT LEAKAGE IN EXCESS OF ONE GALLON PER DAY PER VERTICAL FOOT OF MANHOLE.

PRECAST CONCRETE SEWER MANHOLE
NOT TO SCALE

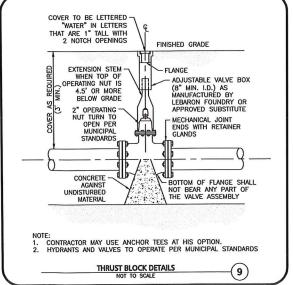

(5)

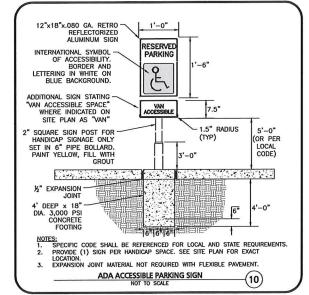



PROFESSIONAL ENGINEER FOR ALLEN & MAJOR ASSOCIATES, INC

1	01-19-24	REVISED PER REVIEW COMMENTS
REV	DATE	DESCRIPTION
APPLICAL	NT\OWNER:	

TMC HOLDINGS & DEVELOPMENT 2, LLC 24 WILLIAM WAY BELLINGHAM, MA 02019

25 FORGE PARKWAY FRANKLIN, MA

PROJECT NO.	2712-02A	DATE:	12-14-24
SCALE:	AS SHOWN	DWG. NAME:	C-2712-02A
DESIGNED BY:	SM/JRG	CHECKED BY:	BDJ



ASSOCIATES, INC.

civil engineering + land surveying rironmental consulting * lands averying
rironmental consulting * landscape architect
www.allenmajor.com
100 COMMERCE WAY, SUITE 5
WOBURN MA 01801
TEL: (781) 935-6889
FAX: (781) 935-2896

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RAWING TITLE: C-505 **DETAILS**


NOT TO SCALE



BEFORE YOU DIG

CALL 811 OR 1-888-DIG-SAFE

1-888-344-7233

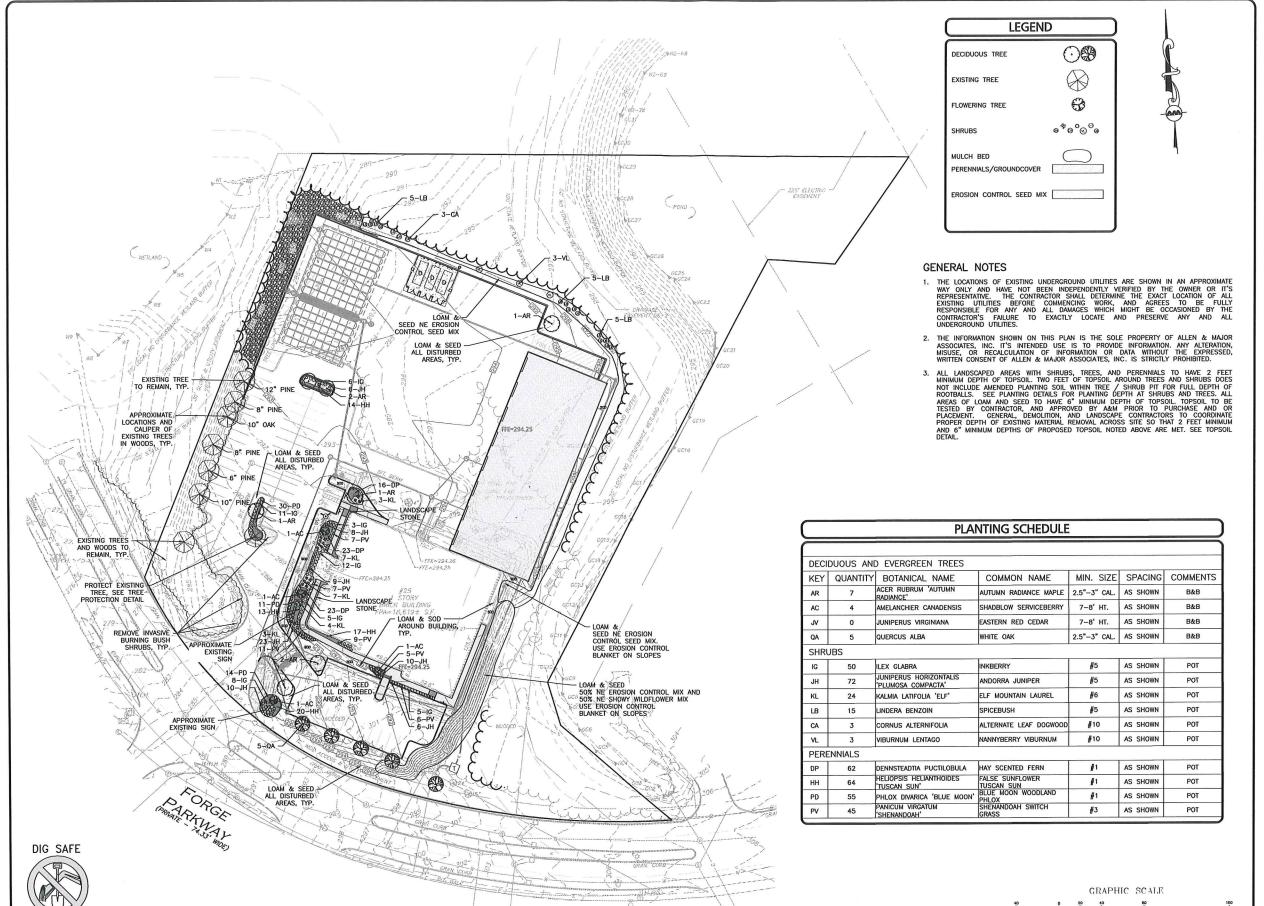



PROFESSIONAL LANDSCAPE ARCHITECT FOR ALLEN & MAJOR ASSOCIATES, INC.

8	01-19-24	REVISED PER REVIEW COMMENTS
7	12-14-23	ISSUED FOR SITE PLAN AMENDMENT
6	10-24-23	REVISED PER CONDITIONS OF APPROVAL
5	05-18-23	REVISION 5 PER REVIEW COMMENTS
4	05-11-23	REVISION 4 PER REVIEW COMMENTS
3	05-01-23	REVISION 3 PER REVIEW COMMENTS
2	04-14-23	REVISION 2 PER DPW COMMENTS
1	04-04-23	REVISION 1 PER PEER REVIEW
REV	DATE	DESCRIPTION

APPLICANT\OWNER:

TMC HOLDINGS & DEVELOPMENT 2, LLC 24 WILLIAM WAY BELLINGHAM, MA 02019

25 FORGE PARKWAY FRANKLIN, MA

PROJECT NO.	2712-02A	DATE:	02-21-23
SCALE:	1" = 40'	DWG. NAME:	L-2712-02/
DESIGNED BY:	BCD	CHECKED BY:	BD.



civil engineering + land surveying onmental consulting + landscape archited www.allenmajor.com 100 COMMERCE WAY, SUITE 5 WOBURN MA 01801 TEL: (781) 935-6889 FAX: (781) 935-2896

WOBURN, MA E. A.K.I.VILLE, MA & MANCHESTER, NI.

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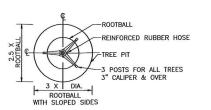
(IN FEET)

1 inch - 40 ff

L-101 LANDSCAPE PLAN

NOTES:

- 1. ALL TREES SHALL HAVE THE SAME RELATIONSHIP TO FINISH GRADE AFTER PLANTING AS THEY HAD AT THE ORIGINAL NURSERY SETTING. ROOT FLARE SHALL BE 2" ABOVE FINISH GRADE. REMOVE SOIL FROM TRUNK FLARE OF TREE TO DETERMINE ACTUAL ROOTBALL AREA.
- BACKFILL WITH PLANTING MIX. PLANT MIX TO BE: 50% NATIVE TOPSOIL, 20% COMPOST (LEAVES & ORGANIC MATERIAL, NO ASH) 20% PEAT MOSS, 10% SAND.
- ADD MYCORRHIZA SOIL ADDITIVES AND SLOW RELEASE FERTILIZER WHE PLANT HOLES ARE 50% FILLED AND WATER THOROUGHLY AT COMPLETION.



DECIDUOUS TREE PLANTING DETAIL NOT TO SCALE


(1)

2

REMOVE ARBORKNOT AFTER ONE GROWING SEASON ARBORKNOT BY DEEP ROOTS OR APPROVED EQUAL -3" BARK MULCH IN SAUCER - PLANT SAUCER, 4" CONTINUOUS WITH BARK MULCH - WARNING FLAG 18" ABOVE FINISH - FINISH GRADE - SET ANGLE OF GUYS TO ENTER GROUND AT LIMIT OF BRANCH WALLEY WALLEY -STEEL EYE STAKES BY DEEP ROOTS OR APPROVED EQUAL - PLANTING SOIL MIX: BACKELL IN LOOSE LIFTS OF 6"-8" DEPTH. SETTLE WITH
THOROUGH WATERING. SEE NOTES 3&4 3 X DIA. OF -CUT AND REMOVE BURLAP AND WIRE BASKETS ENTIRELY.

- 1. TREES SHALL BEAR SAME RELATIONSHIP TO FINISH GRADE AS IT BORE TO NURSERY OR FIELD GRADE. ROOT FLARE SHALL BE 2" ABOVE FINISH GRADE. REMOVE SOIL FROM TRUNK FLARE OF TREE TO DETERMINE ACTUAL TOP OF ROOTBALL AREA.
- 2. INSTALL THREE GUYS PER TREE; EQUALLY SPACED AROUND BALL.
- 3. ATTACH GUYS AT 2/3 HEIGHT OF TREE.
- 4. BACKFILL WITH PLANTING MIX. PLANT MIX TO BE: 50% NATIVE TOPSOIL, 20% COMPOST (LEAVES & ORGANIC MATERIAL, NO ASH) 20% PEAT MOSS, 10% SAND.
- ADD MYCORRHIZA SOIL ADDITIVES AND SLOW RELEASE FERTILIZER WHEN PLANT HOLES ARE 50% FILLED AND WATER THOROUGHLY AT COMPLETION.


EVERGREEN TREE DETAIL

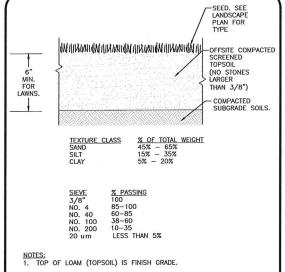



- ALL TOPSOIL (BOTH ONSITE AND OFFSITE SOURCES) SHALL BE COMPOSED OF A NATURAL, FERTILE, FRIABLE SOIL TYPICAL OF CULTWATED TOPSOILS OF THE LOCALITY. OFFSITE SOIL SHALL BE SUITABLE FOR THE GERMINATION OF SEEDS AND SUPPORT OF VEGETATIVE GROWTH, WITH ADDITIVES, IF REQUIRED, TO ACHIEVE PARTICLE DISTRIBUTION AND ORGANIC CONTENT BELLOW. TOPSOIL SHALL BE TAKEN FROM A WELL-DRAINED, ARABLE SITE, FREE OF SUBSOIL, LARGE STOMES, EARTH CLODS, STICKS, STUMPS, CLAY LUMPS, ROOTS, OTHER OBJECTIONABLE, EXTRANEOUS MATTER OR DEFRIES MOR CONTAIN TOXIC SUBSTANCES. DEBRIS NOR CONTAIN TOXIC SUBSTANCES.
- 3. THE CONTRACTOR SHALL PROVIDE THE OWNER / LANDSCAPE ARCHITECT WITH TOPSOIL TEST RESULTS (RECOMMEND UMASS AMHERST SOIL TESTING LAB) FOR APPROVAL PRIOR TO OBTAINING AND PLACING THE SOIL. IF ANY TOPSOIL IS PURCHASED OR PLACED PRIOR TO APPROVAL BY OWNER / LANDSCAPE ARCHITECT, IT IS AT CONTRACTORS RISK, AND IT CAN BE REMOVED AT NO ADDITIONAL CONTRACTORS RISK, AND IT CAN BE REMOVED AT NO ADDITIONAL COST TO THE OWNER. IF THE PLANTING SOIL (BOTH ONSITE AND OFFSITE SOURCES) DOES NOT FALL WITHIN THE REQUIRED SIEVE ANALYSIS, TEXTURAL CLASS, ORGANIC CONTENT, OR PH RANGE, IT SHALL BE ADJUSTED TO MEET THE SPECIFICATIONS THROUGH THE ADDITION OF SAND, COMPOST, LIMESTONE, OR ALUMINUM SULFATE TO BRING IT WITHIN THE SPECIFIED LIMITS AT NO ADDITIONAL COST TO THE OWNER.
- TOPSOIL SHALL HAVE A PH VALUE BETWEEN 5.5 AND 6.5. TOPSOIL SHALL CONTAIN BETWEEN 4% AND 8% ORGANIC MATTER OF TOTAL DRY WEIGHT AND SHALL CONFORM TO THE FOLLOWING GRADATION AND TEXTURE CLASS ABOVE.

TOPSOIL FOR LAWN, TREES, SHRUBS, & PERENNIALS

NOT TO SCALE

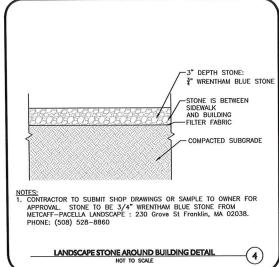

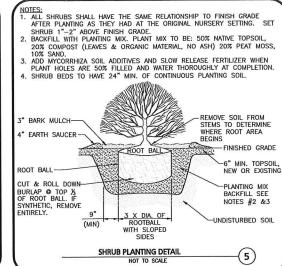

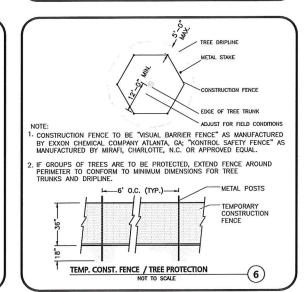



12-14-23	ISSUED FOR SITE PLAN AMENDMEN
10-24-23	REVISED PER CONDITIONS OF APPROV
05-18-23	REVISION 5 PER REVIEW COMMEN
05-11-23	REVISION 4 PER REVIEW COMMEN
05-01-23	REVISION 3 PER REVIEW COMMEN
04-14-23	REVISION 2 PER DPW COMMENTS
04-04-23	REVISION 1 PER PEER REVIEW
DATE	DESCRIPTION
	10-24-23 05-18-23 05-11-23 05-01-23 04-14-23 04-04-23

TMC HOLDINGS & DEVELOPMENT 2, LLC 24 WILLIAM WAY BELLINGHAM, MA 02019

25 FORGE PARKWAY FRANKLIN, MA

	PROJECT NO.	2712-02A	DATE:	02-21-2
	SCALE:	AS SHOWN	DWG. NAME:	L-2712-02
	DESIGNED BY:	BCD	CHECKED BY:	BD



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WOBURN MA 01801

TEL: (781) 935-6889 FAX: (781) 935-2896

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LANDSCAPE NOTES & DETAILS L-501

- 2. SOD IS TO BE A BLEND OF FOUR TO FIVE CURRENT AND IMPROVED HYBRID BLUEGRASS AND FESCUE MIXES APPROPRIATE FOR BOTH SEMI-SHADED AND AREAS OF SUN. HYBRIDS MAY INCLUDE: BLACKSTONE KENTUCKY BLUEGRASS, AWARD KENTUCKY BLUEGRASS, CHACKBURG II KENTUCKY BLUEGRASS OR COMPARABLE AND EQUAL BLUEGRASS HYBRIDS.
- 3. SOD SHALL BE HIGH QUALITY, NURSERY GROWN ON CULTIVATED MINERAL AGRICULTURAL SOILS. SOD SHALL BE MOIST AND MACHINE CUT AT A UNIFORM SOIL THICKNESS OF AT LEAST 5/8" AT TIME OF CUTTING. MEASUREMENT FOR THICKNESS SHALL INCLUDE TOP GROWTH AND THATCH. SOD SHALL BE FREE OF DISEASES, WEEDS, BARE SPOTS, OR INSECTS.
- SODDING TO BE COMPLETED "IN SEASON" BETWEEN APRIL 1 TO JUNE 15 OR AUGUST 15 TO OCTOBER 1, EXCEPT FOR RE-SODDING OF BARE SPOTS. IF UNABLE TO SOD WITHIN THESE TIMEFRAMES, CONTRACTOR TO INSTALL EROSION CONTROL MATS ON ALL SLOPES 3:1 AND OVER, HYDROSEED ALL EXPOSED AREAS, ADD SOIL STABILIZER "FLEXTERRA HP-FGM" AS MANUFACTURED BY "PROFILE" TO HYDROSEED (AT RATE OF 3,000 LBS PER ACRE). CONTRACTOR TO COMPLETE ALL ABOVE "OUT OF SEASON" REQUIREMENTS AND THEN ALSO BE RESPONSIBLE FOR RE-GRADING AND RE-SODDING ALL DISTURBED, ERODED, OR BARE SPOTS WITHIN NEXT CLOSEST PLANTING SEASON IN FALL OR SPRING.
- COMMERCIAL FERTILIZER SHALL BE APPLIED AT THE RATE OF 25 POUNDS PER 1000 SQ. FT. OR AS RECOMMENDED BY THE TESTING AGENCY. LIME TO BE SPREAD AT THE RATE OF 100 POUNDS PER 1000 SQ. FT OR AS RECOMMENDED BY THE TESTING ACENCY. COMMERCIAL FERTILIZER SHALL BE A COMPLETE FERTILIZER CONTAINING AT LEAST 50% OF THE NITROGEN OF WHICH IS DERIVED FROM NATURAL ORGANIZE SOURCES OF UREAFORM. IT SHALL CONTAIN THE FOLLOWING ORGANIZE SOURCES OF URLEFURM. IT SHALL CONTAIN THE FOLLOWING PERCENTAGES BY WEIGHT: NITROGEN (N) 10%, PHOSPHORUS (P) 6%, POTASH (K) 4%. LIME SHALL BE AN APPROVED AGRICULTURAL LIMESTONE CONTAINING NOT LESS THAN 85% OF TOTAL CARBONATES. LIMESTONE SHALL BE GROUND TO SUCH FINENESS THAT 50% WILL PASS A 100 MESH SIEVE AND 90% WILL PASS THROUGH
- CONTRACTOR RESPONSIBLE FOR WATERING, MOWING, AND RE-SODDING OF LAWN BARE SPOTS UNTIL A UNIFORM, HEALTHY STAND OF GRASS IS ESTABLISHED AND ACCEPTED.
- 7. IF PROPOSED IRRIGATION SYSTEM IS NOT OPERATIONAL, LANDSCAPE CONTRACTOR RESPONSIBLE TO WATER WITH TEMPORARY IRRIGATION OR WATER TRUCKS UNTIL IRRIGATION SYSTEM IS OPERATIONAL

SEED MIX:

NEW ENGLAND WETLAND PLANTS 820 WEST STREET, AMHERST, MA 01002 PHONE: 413-548-8000 FAX 413-549-4000
EMAIL: INFO@NEWP.COM WEB ADDRESS: WWW.NEWP.COM

NEW ENGLAND EROSION CONTROL/RESTORATION MIX FOR DRY SITES

BOTANICAL NAME	COMMON NAME	WETLAND INDICATOR
ELYMUS CANADENSIS	CANADA WILD RYE	FACU+
FESTUCA RUBRA	RED FESCUE	FACU
LOLIUM MULTIFLORUM	ANNUAL RYEGRASS	
LOLIUM PERENNE	PERRENIAL RYEGRASS	
PANICUM VIRGATUM	SWITCH GRASS	FAC
SORGHASTRUM NUTANS	INDIAN GRASS	UPL
SCHIZACHYRIUM SCOPARIUM	LITTLE BLUESTEM	FACU
ACROSTIS PERENNANS	LIPLAND BENTCRASS	FACIL

THE NEW ENGLAND EROSION CONTROL/RESTORATION MIX FOR DRY SITES PROVIDES AN APPROPRIATE SELECTION OF NATIVE AND NATURALIZED GRASSES TO ENSURE THAT DRY AND RECENTLY DISTURBED SITES WILL BE QUICKLY REVGETATED AND THE SOIL SURFACE STABILIZED. IT IS AN APPROPRIATE SEED MIX FOR ROAD CUTS, PIPELINES, STEEPER SLOPES, AND AREAS REQUIRING QUICK COVER DURING THE ECOLOGICAL RESTORATION PROCESS. THE MIX MAY BE APPLIED BY HYDRO-SEEDING, BY MECHANICAL SPREADER, OR ON SMALL SITES IT CAN BE SPREAD BY HAND. LIGHTLY RAKE, OR ROLL TO ENSURE PROPER SOIL—SEED CONTACT. BEST RESULTS ARE OBTAINED WITH A SPRING OR LATE SUMMER SEEDING, MIL BENEFIT FROM A LIGHT MULCHING OF WEED-FREE STRAW TO CONSERVE MOISTURE. IF CONDITIONS ARE DRIET THAN USUAL, WATERING WILL BE REQUIRED. FETRILIZATION IS ARE DRIER THAN USUAL, WATERING WILL BE REQUIRED, FERTILIZATION IS

REQUIRED UNLESS THE SOILS ARE PARTICULARLY INFERTILE. PREPARATION OF A CLEAN WEED FREE SEED BED IS NECESSARY FOR OPTIMAL RESULTS.

APPLY: 35 LBS/ACRE :1250 SQ FT/LB

EROSION CONTROL BLANKET FOR SLOPES SEE LANDSCAPE NOTES

LOAM AND SEED NOTES:

CONTRACTOR SHALL SEED ALL DISTURBED AREAS NOT NOTED TO RECEIVE OTHER MATERIALS, AND AT AREAS SHOWN ON THE PLAN PER SPECIFICATIONS BELOW

SCIENTIFIC NAME	COMMON NAME	PROPORTION BY WEIGHT	PERCENT PURITY	PERCENT GERMINATION
FESTUCA RUBRA "RUBRA"	CREEPING RED FESCUE	37%	95%	90%
LESCO DOUBLE EAGLE SEED BLEND	PERENNIAL RYEGRASS 3 VARIETIES	55%	100%	90%
FESTUCA RUBRA COMMUTATA WILMA	WLMA CHEWINGS	8%	95%	80%

COMMUTATA WILMA

1. SEED TO BE SPREAD AT MINIMUM RATE OF 5 LBS. PER 1000 SQ. FT.

2. SEEDING TO BE COMPLETED "IN SEASON" BETWEEN APRIL 1 TO JUNE 15 OR AUGUST 15 TO OCTOBER 1. EXCEPT FOR RESEEDING OF BARE SPOTS. IF UNABLE TO SEED WITHIN THESE TIMEFRAMES, CONTRACTOR TO INSTALL EROSION CONTROL MATS ON ALL SLOPES 3:1 AND OVER, HYDROSEED ALL EXPOSED AREAS, ADD SOIL STABILIZER "FLEXTERRA HP—FGM" AS MANUFACTURED BY "PROFILE" TO HYDROSEED (AT RATE OF 3,000 LBS PER ACRE). CONTRACTOR TO COMPLETE ALL ABOVE "OUT OF SEASON" REQUIREMENTS AND THEN ALSO BE RESPONSIBLE FOR RE—GRADING AND RE—SEEDING ALL DISTURBED, ERODED, OR BARE SPOTS WITHIN NEXT CLOSEST PLANTING SEASON IN FALL OR SPRING.

3. COMMERCIAL FERTILIZER SHALL BE APPLIED AT THE RATE OF 25 POUNDS PER 1000 SQ. FT. OR AS RECOMMENDED BY THE TESTING AGENCY. LIME TO BE SPREAD AT THE RATE OF 100 POUNDS PER 1000 SQ. FT. OR AS RECOMMENDED BY THE TESTING AGENCY. LIME TO SHALL BE ACCOMPLETE FERTILIZER SHALL BE ACCOMPLETE FERTILIZER CONTAINING AT LEAST 50% OF THE NITROGEN OF WHICH IS DERIVED FROM NATURAL ORGANIZE SOURCES OF UREAFORM. IT SHALL CONTAIN THE FOLLOWING PERCENTAGES BY WEIGHT: NITROGEN (N) 10%, PHOSPHORUS (P) 6%, POTASH (K) 4%. LIME SHALL BE AN APPROVED AGRICULTURAL LIMESTONE CONTAINING NOT LESS THAN 85% OF TOTAL CARBONATES. LIMESTONE SHALL BE GROUND TO SUCH FINENESS THAN 85% OF TOTAL CARBONATES. LIMESTONE SHALL BE GROUND TO SUCH FINENESS THAN 85% OF TOTAL CARBONATES. LIMESTONE SHALL BE GROUND TO SUCH FINENESS THAN 85% OF TOTAL CARBONATES. LIMESTONE SHALL BE GROUND TO SUCH FINENESS THAN 85% OF TOTAL CARBONATES. LIMESTONE SHALL BE GROUND TO SUCH FINENESS THAN 85% OF TOTAL CARBONATES. LIMESTONE SHALL BE GROUND TO SUCH FINENESS THAN 85% OF TOTAL CARBONATES. LIMESTONE SPER 1000 SURPER FEET.

5. CONTRACTOR RESPONSIBLE FOR WATERING, MOWING, AND RESEEDING OF LAWN BARE SPOTS UNTIL A UNIFORM, HEALTHY STAND OF GRASS IS ESTABLISHED AND ACCEPTED.



Ernst Conservation Seeds 8884 Mercer Pike Meadville, PA 16335 (800) 873-3321 Fax (814) 336-5191 www.ernstseed.com

Native Steep Slope Mix w/Grain Rye - ERNMX-181-2

	Botanical Name	Common Name	Price/Lb
40.00 %	Secale cereale, Variety Not Stated	Rye, Variety Not Stated	0.51
20.80 %	Sorghastrum nutans, PA Ecotype	Indiangrass, PA Ecotype	14.58
11.20 %	Andropogon gerardii, 'Niagara'	Big Bluestern, 'Niagara'	9.27
8.80 %	Elymus virginicus, Madison-NY Ecotype	Virginia Wildrye, Madison-NY Ecotype	10.45
8.00 %	Elymus canadensis	Canada Wildrye	9.57
3.10 %	Panicum virgatum, 'Shawnee'	Switchgrass, 'Shawnee'	11.96
2.40 %	Panicum clandestinum, Tioga	Deerlongue, Tioga	22.08
1.20 %	Echinacea purpurea	Purple Coneflower	43.20
1.10 %	Chamaecrista fasoculata, PA Ecotype	Partridge Pea, PA Ecotype	12.00
0.90 %	Heliopsis heliantholdes, PA Ecotype	Oxeye Sunflower, PA Ecotype	33.60
0.80 %	Coreopsis lanceolata	Lanceleaf Coreopsis	28.80
0.80 %	Rudbeckla hirta	Blackeyed Susan	31.20
0.30 %	Monarda fistulosa, Fort Indiantown Gap-PA Ecotype	Wild Bergamot, Fort Indiantown Gap-PA Ecotype	96.00
0.20 %	Asclepias syriaca, PA Ecotype	Common Milkweed, PA Ecotype	96.00
0.20 %	Solidago rugosa, PA Ecotype	Wrinkleleaf Goldenrod, PA Ecotype	264.00
0.10 %	Aster lateriflorus	Calico Aster	336.00
0.10 %	Aster pilosus, PA Ecotype	Heath Aster, PA Ecotype	264.00
100.00 %		Mix Price/Lb Bulk:	\$9.90

Seeding Rate: 75 lb per acre

Erosion Control & Revegetation; Grasses & Grass-like Species - Herbaceous Perennial; Herbaceous Flowering Species - Herbaceous Perennial;

Use this formula with grain rye as a cover crop (from August 1st-February 15th). Mix formulations are subject to change without notice depending on the availability of existing and new products. While the formula may change, the guiding philosophy and function of the mix will not.

LANDSCAPE NOTES

- ALL WORK SHALL BE IN ACCORDANCE WITH THE REQUIREMENTS OF THE CITY OF FRANKUN, MA.
- PLANTING PLAN IS DIAGRAMMATIC IN NATURE. FINAL PLACEMENT OF PLANTS TO BE APPROVED BY THE LANDSCAPE ARCHITECT IN THE
- 2. THE CONTRACTOR SHALL BE RESPONSIBLE FOR CONTACTING ALL UTILITY COMPANIES. ANY PERMITTING AGENCIES. AND "DIG-SAFE" (1-888-344-7233) AT LEAST 72 HOURS IN ADVANCE OF ANY WORK THAT WILL REQUIRE EXCAVATION. CONTRACTOR SHALL NOTIFY THE OWNERS REPRESENTATIVE OF NAY CONFLICTS IN WRITING
- 3. NO PLANT MATERIAL SHALL BE INSTALLED UNTIL ALL GRADING AND CONSTRUCTION HAS BEEN COMPLETED IN THE IMMEDIATE AREA, ANY TREES NOTED AS "SEAL OR SELECTED SPECIMEN" SHALL BE TAGGED AND SEALED BY THE LANDSCAPE ARCHITECT.
- 4. ALL TREES SHALL BE BALLED AND BURLAPPED (B&B) UNLESS OTHERWISE NOTED OR APPROVED BY THE OWNER'S REPRESENTATIVE AND LANDSCAPE ARCHITECT.
- 5. CONTRACTOR SHALL VERIFY QUANTITIES SHOWN ON PLANT LIST. QUANTITIES SHOWN ON PLANS SHALL GOVERN OVER PLANT LIST.
- 6. ANY PROPOSED PLANT SUBSTITUTIONS MUST BE APPROVED IN WRITING BY OWNER'S REPRESENTATIVE AND LANDSCAPE ARCHITECT.
- ALL PLANT MATERIALS INSTALLED SHALL MEET THE GUIDELINES ESTABLISHED BY THE STANDARDS FOR NURSERY STOCK PUBLISHED BY THE AMERICAN ASSOCIATION OF NURSERYMEN.
- ALL PLANT MATERIALS SHALL BE GUARANTEED FOR ONE YEAR FOLLOWING DATE OF ACCEPTANCE.
- ALL DISTURBED AREAS NOT OTHERWISE NOTED SHALL RECEIVE 6" OF SUITABLE LOAM & SEED LAWNS WITH 3:1 OR GREATER SLOPES SHALL BE PROTECTED WITH AN EROSION CONTROL BLANKET.
- ANY FALL TRANSPLANTING HAZARD PLANTS SHALL BE DUG IN THE SPRING AND STORED FOR FALL PLANTING.
- 12. TREES SHALL HAVE A MINIMUM CALIPER AS INDICATED ON THE PLANTING SCHEDULE TAKEN ONE FOOT ABOVE THE ROOT CROWN.
- 13. ALL PLANT BEDS AND TREE SAUCERS TO RECEIVE 3" OF PINE BARK MULCH. GROUND COVER AREAS SHALL RECEIVE 1" OF PINE BARK
- 14. ALL DECIDUOUS TREES ADJACENT TO WALKWAYS AND ROADWAYS SHALL HAVE A BRANCHING PATTERN TO ALLOW FOR A MINIMUM OF 7' OF CLEARANCE BETWEEN THE GROUND AND THE LOWEST BRANCH.
- 15. ALL TREE STAKES SHALL BE STAINED DARK BROWN.
- CONTRACTOR RESPONSIBLE FOR WATERING, AND RESEEDING OF BARE SPOTS UNTIL A UNIFORM STAND OF VEGETATION IS ESTABLISHED AND
- 17. ALL PARKING ISLANDS PLANTED WITH SHRUBS SHALL HAVE 24" OF TOP SOIL. FINISH GRADE SHALL BE EQUAL TO THE TOP OF CURB.
- 18. SOIL SAMPLES, TESTS, AND SHOP DRAWINGS SHALL BE PROVIDED TO THE LANDSCAPE ARCHITECT OR THE OWNER FOR APPROVAL PRIOR TO CONSTRUCTION.
- 19. ALL PROPOSED LANDSCAPE AREAS INCLUDING MOWED LAWNS, TREES, SHRUB BEDS, AND PERENNIALS SHALL BE PROVIDED WITH WATER EFFICIENT UNDERGROUND IRRIGATION. DESIGN AND INSTALLATION OF IRRIGATION SYSTEM TO BE PERFORMED BY AN APPROVED IRRIGATION DESIGN BUILD CONTRACTOR OR BY AN APPROVED EQUAL, TO BE DETERMINED BY THE OWNERS REPRESENTATIVE AND LANDSCAPE ARCHITECT. IRRIGATION SYSTEM IS TO BE DESIGNED FOR EFFICIENT WATER USAGE INCLUDING: USE OF DRIP IRRIGATION FOR SHRUBS AND PERENNIALS, IRRIGATION SYSTEM WITH HEAD—TO—HEAD COVERAGE, A CENTRAL SHUT—OFF VALVE, SEPARATE ZONES FOR EACH TYPE OF BEDDING AREA BASED ON WATERING NEEDS, AND A RAIN SENSOR TO SHUT OFF IRRIGATION DURING RAIN EVENTS.



PROFESSIONAL LANDSCAPE ARCHITECT FOR ALLEN & MAJOR ASSOCIATES, INC.

7	12-14-23	ISSUED FOR SITE PLAN AMENDMEN
6	10-24-23	REVISED PER CONDITIONS OF APPROVA
5	05-18-23	REVISION 5 PER REVIEW COMMENT
4	05-11-23	REVISION 4 PER REVIEW COMMENT
3	05-01-23	REVISION 3 PER REVIEW COMMENT
2	04-14-23	REVISION 2 PER DPW COMMENTS
1	04-04-23	REVISION 1 PER PEER REVIEW
REV	DATE	DESCRIPTION

APPLICANT\OWNER:

TMC HOLDINGS & DEVELOPMENT 2, LLC 24 WILLIAM WAY BELLINGHAM, MA 02019

25 FORGE PARKWAY FRANKLIN, MA

	PROJECT NO.	2712-02A	DATE:	02-21-23
	SCALE:	AS SHOWN	DWG. NAME:	L-2712-02A
	DESIGNED BY:	PCD.	CHECKED BY-	BDI



civil engineering + land surveying civii engineering * land scape architec: www.allen major.com 100 COMMERCE WAY, SUITE 5 WOBURN MA 01801 TEL: (781) 935-2896 FAX: (781) 935-2896

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ANDSCAPE NOTES & DETAILS L-502

LLEN & MAJOR ASSOCIATES, INC.'S WORK PR

Town of Franklin

355 East Central Street Franklin, Massachusetts 02038-1352



Phone: (508) 520-4907 www.franklinma.gov

DEPARTMENT OF PLANNING AND COMMUNITY DEVELOPMENT

MEMORANDUM

DATE: February 21, 2024

TO: Franklin Planning Board

FROM: Department of Planning and Community Development

RE: 25 Forge Parkway

Site Plan - Endorsement

General:

1. The Planning Board voted to approve the Site Plan for 25 Forge Parkway on February 5, 2024.

2. The Certificate of Vote has been added to the Site Plans.

DPCD has no further comment.