

THERMO FISHER SCIENTIFIC, INC.

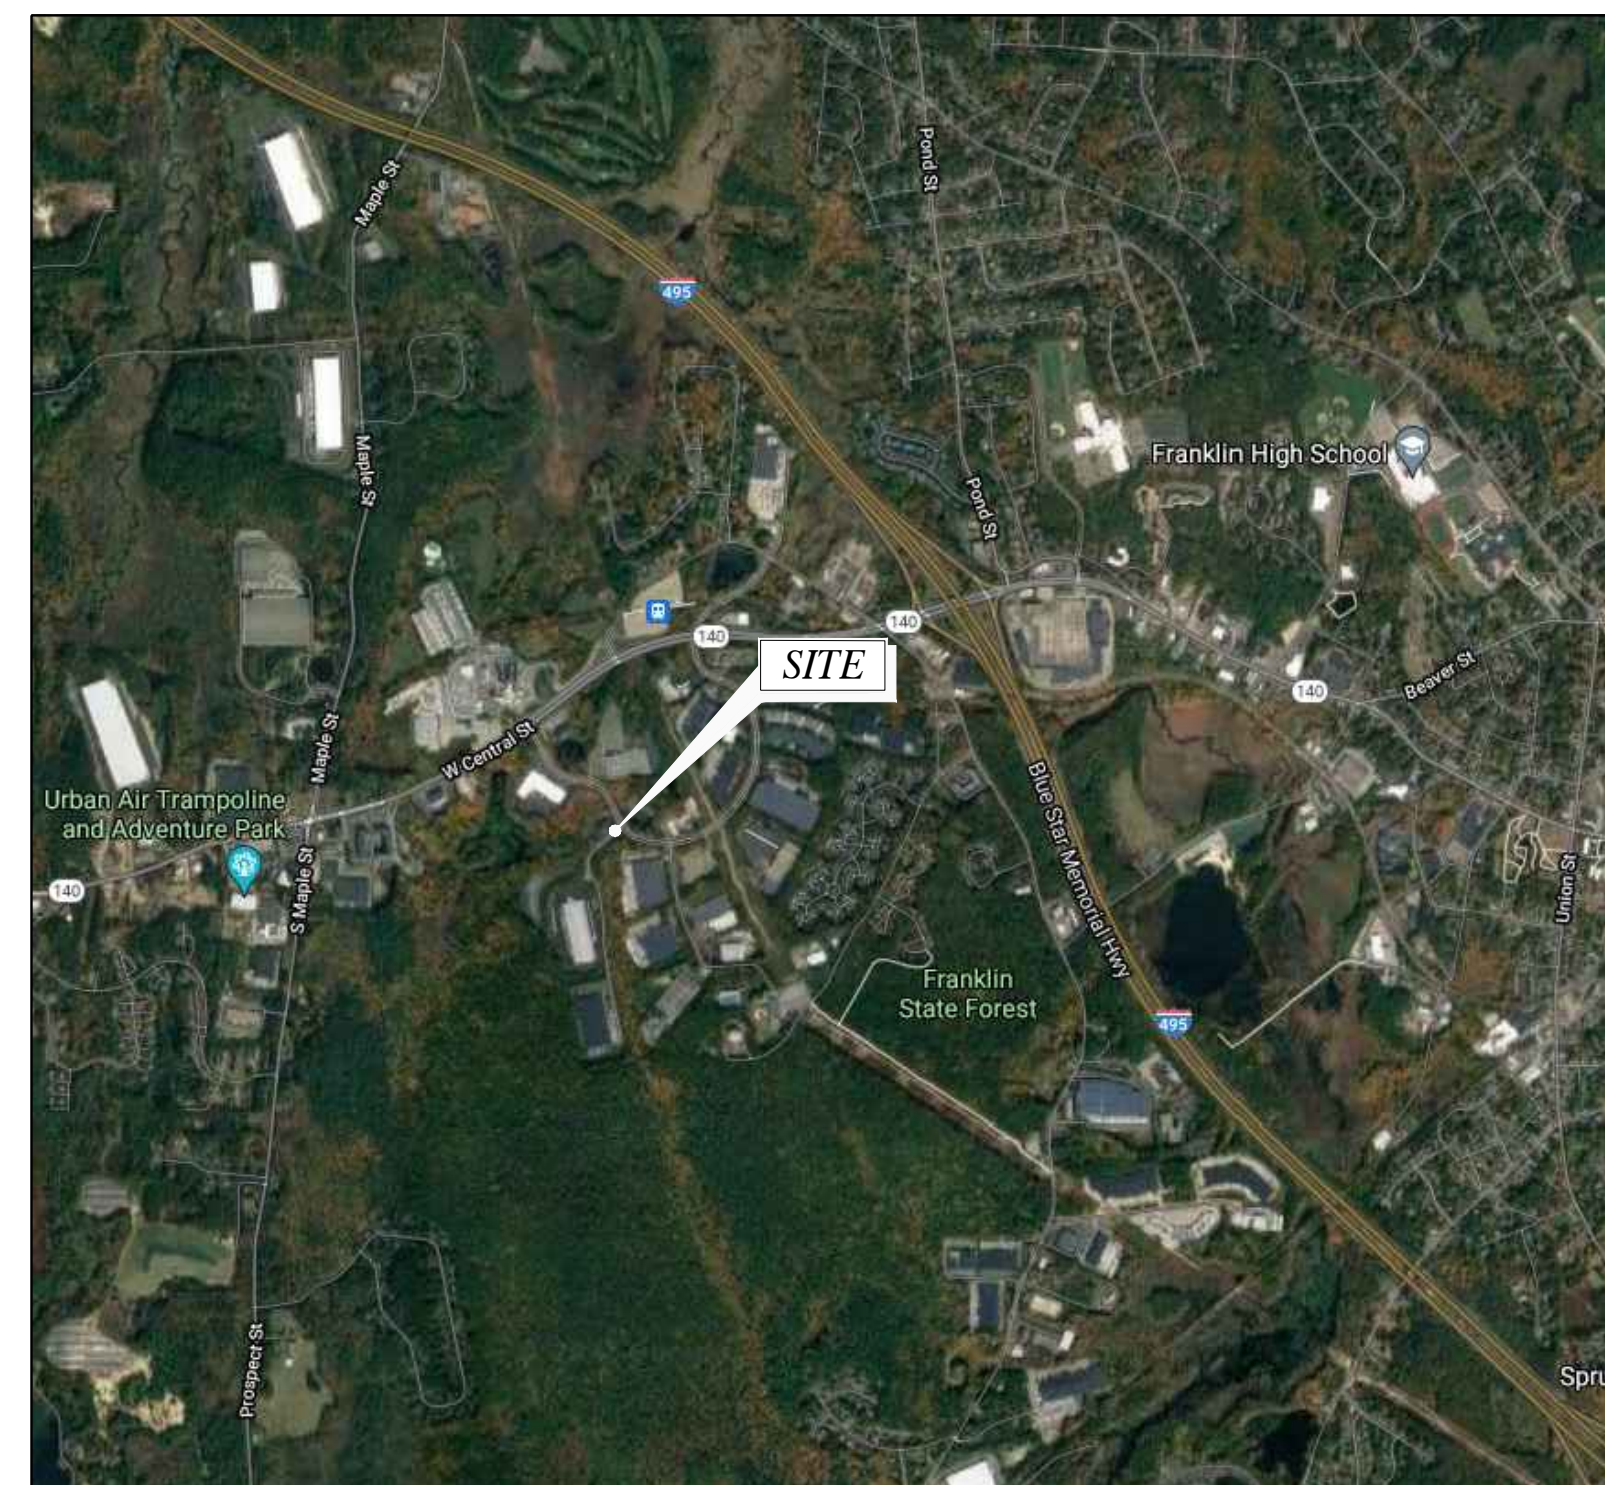
SITE PLAN MODIFICATION 27 FORGE PARKWAY FRANKLIN, MASSACHUSETTS

REQUEST FOR DETERMINATION

- REQUEST FOR DETERMINATION FOR PARKING FROM SECTION 185-21A (4)
- REQUEST FOR DETERMINATION FOR PARKING FROM SECTION 185-21B (3)
- REQUEST FOR DETERMINATION FOR PARKING FROM SECTION 185-21C (6)

NOTES

1. ALL CONSTRUCTION SHALL CONFORM TO THE TOWN OF FRANKLIN STANDARDS.
2. THE SITE SHALL CONFORM TO ALL RULES AND REGULATIONS AND APPROVALS FROM THE BOARD OF HEALTH, DESIGN REVIEW COMMISSION, DPW, POLICE, AND FIRE DEPARTMENTS.
3. ALL PARKING STRIPING SHALL BE PAINTED WITH WHITE ACRYLIC PAINT
4. PROPERTY IS CURRENTLY ZONED INDUSTRIAL.
5. A PRE-CONSTRUCTION MEETING SHALL BE SCHEDULED PRIOR TO COMMENCEMENT OF ANY CONSTRUCTION ACTIVITIES.
6. ALL EROSION CONTROL MITIGATION MEASURES SHALL BE IN PLACE PRIOR TO MAJOR CONSTRUCTION OR SOIL DISTURBANCE COMMENCING ON SITE.
7. IF ANY DEBRIS IS CARRIED ONTO ANY PUBLIC WAY, THE OWNER/APPLICANT AND HIS ASSIGNS SHALL BE RESPONSIBLE FOR ALL CLEANUP ON THE ROADWAY. ALL CLEANUPS SHALL OCCUR WITHIN 24 HOURS AFTER FIRST WRITTEN NOTIFICATION.
8. THE BUILDING OFFSETS AS SHOWN ON THIS PLAN ARE NOT TO BE USED FOR THE ESTABLISHMENT OF PROPERTY LINES OR FOR THE ESTABLISHMENT OF ANY PROPOSED CONSTRUCTION UNLESS SAID CONSTRUCTION IS SHOWN HEREON.
9. THIS PLAN WAS PREPARED FOR THE EXCLUSIVE USE AND PURPOSE OF THE PARTY STATED HEREON AND SHALL NOT BE USED BY ANY THIRD PARTY WITHOUT THE EXPRESSED WRITTEN PERMISSION.
10. SEE CERTIFICATE OF VOTE DATED OCTOBER 27, 2008 BY THE FRANKLIN BOARD TO APPROVE WITH CONDITIONS A LIMITED SITE PLAN MODIFICATION FOR PARKING DETERMINATION.
11. SEE ABBREVIATED NOTICE OF RESOURCE AREA DELINEATION DATED JANUARY 27, 2009 PREPARED BY BEALS ASSOCIATES, INC. 98 NORTH WASHINGTON ST., BOSTON, MA.
12. SEE ORDER OF RESOURCE AREA DELINEATION NO. CE 159-980.
13. WETLANDS WERE FLAGGED BY GODDARD CONSULTING IN AUGUST 2018 AND LOCATIONS REVISED IN FEBRUARY 2019. BY GUERRIERE AND HALNON, INC.
14. SEE CERTIFICATE OF VOTE GRANTED BY THE FRANKLIN PLANNING BOARD DATED, JULY 14, 2009.
15. THIS SITE IS NOT LOCATED WITHIN A FLOOD HAZARD ZONE, SEE FIRM NUMBER 25021C0304E EFFECTIVE DATE JULY 17, 2012.
16. THIS SITE IS NOT LOCATED WITHIN A WATER RESOURCE DISTRICT.
17. THIS SITE IS NOT LOCATED WITHIN THE NATURAL HERITAGE ENDANGERED PROTECTION ZONE.



LOCATION MAP

SCALE: 1" = 2000'

SHT. NO.	DESCRIPTION
T-1	TITLE SHEET, DRAWING INDEX, LOCATION MAP
C-1	OVERALL SITE PLAN
C-2	ENLARGED SITE PLANS
C-3	OVERALL DRAINAGE & GRADING PLANS
C-4	ENLARGED DRAINAGE & GRADING PLAN
C-5	EROSION & SEDIMENT CONTROL
C-6	DETAILS

NOTES

CONSTRUCTION ON THIS LOT IS SUBJECT TO ANY EASEMENTS, RIGHTS-OF-WAY, RESTRICTIONS OR OTHER LIMITATIONS WHICH MAY BE REVEALED BY AN EXAMINATION OF THE TITLE.

"WARNING" EXISTING UTILITY LINES INDICATED OR NOTED ON THESE DRAWINGS ARE SHOWN AS OBTAINED FROM EXISTING INFORMATION AND ARE ONLY APPROXIMATE IN LOCATION. THE CONTRACTOR SHALL TAKE CAUTION IN THESE AREAS TO AVOID DAMAGE TO EXISTING UTILITY LINES AND / OR HARM TO PERSONNEL ENGAGED IN WORKING IN THESE AREAS. CALL "DIG SAFE" 1-888-DIG-SAFE. (1-888-344-7233). EXISTING LINES OTHER THAN THOSE INDICATED ON THESE DRAWINGS MAY BE ON THE SITE. THE CONTRACTOR IS WARNED TO PROCEED WITH CAUTION WITH ALL WORK, ESPECIALLY EXCAVATION WORK, AND TO MAKE ALL POSSIBLE INVESTIGATIONS AS TO POSSIBLE UNMARKED UTILITY LINES.

PROJECT DATA

SITE ADDRESS: 27 FORGE PARKWAY
FRANKLIN, MA 02308

ZONING: INDUSTRIAL ZONE

OWNER(S)/APPLICANT:

27 FORGE PARKWAY LLC
27 FORGE PARKWAY
FRANKLIN, MA 02038
A.M. 272 LOTS 13 & 14
A.M. 275 LOTS 13 & 21
CERTIFICATE NO. 177794

DATE:	DATE:
APPROVED DATE:	FRANKLIN PLANNING BOARD
SIGNATURE DATE:	BEING A MAJORITY

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ORIGINAL SIZE IN INCHES


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1	7/6/21	PER COMMENTS		Purpose	Released by	Date
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OVERALL SITE PLAN			
THERMOFISHER 27 FORGE PARKWAY TOWN OF FRANKLIN COUNTY OF NORFOLK, MASSACHUSETTS			
Date 04/28/2021	Work Order 10734.THERMOFISHER	Drawing No. T1	Rev 1
Scale 1" = ##'			



OVERALL SITE PLAN

PARKING NOTES

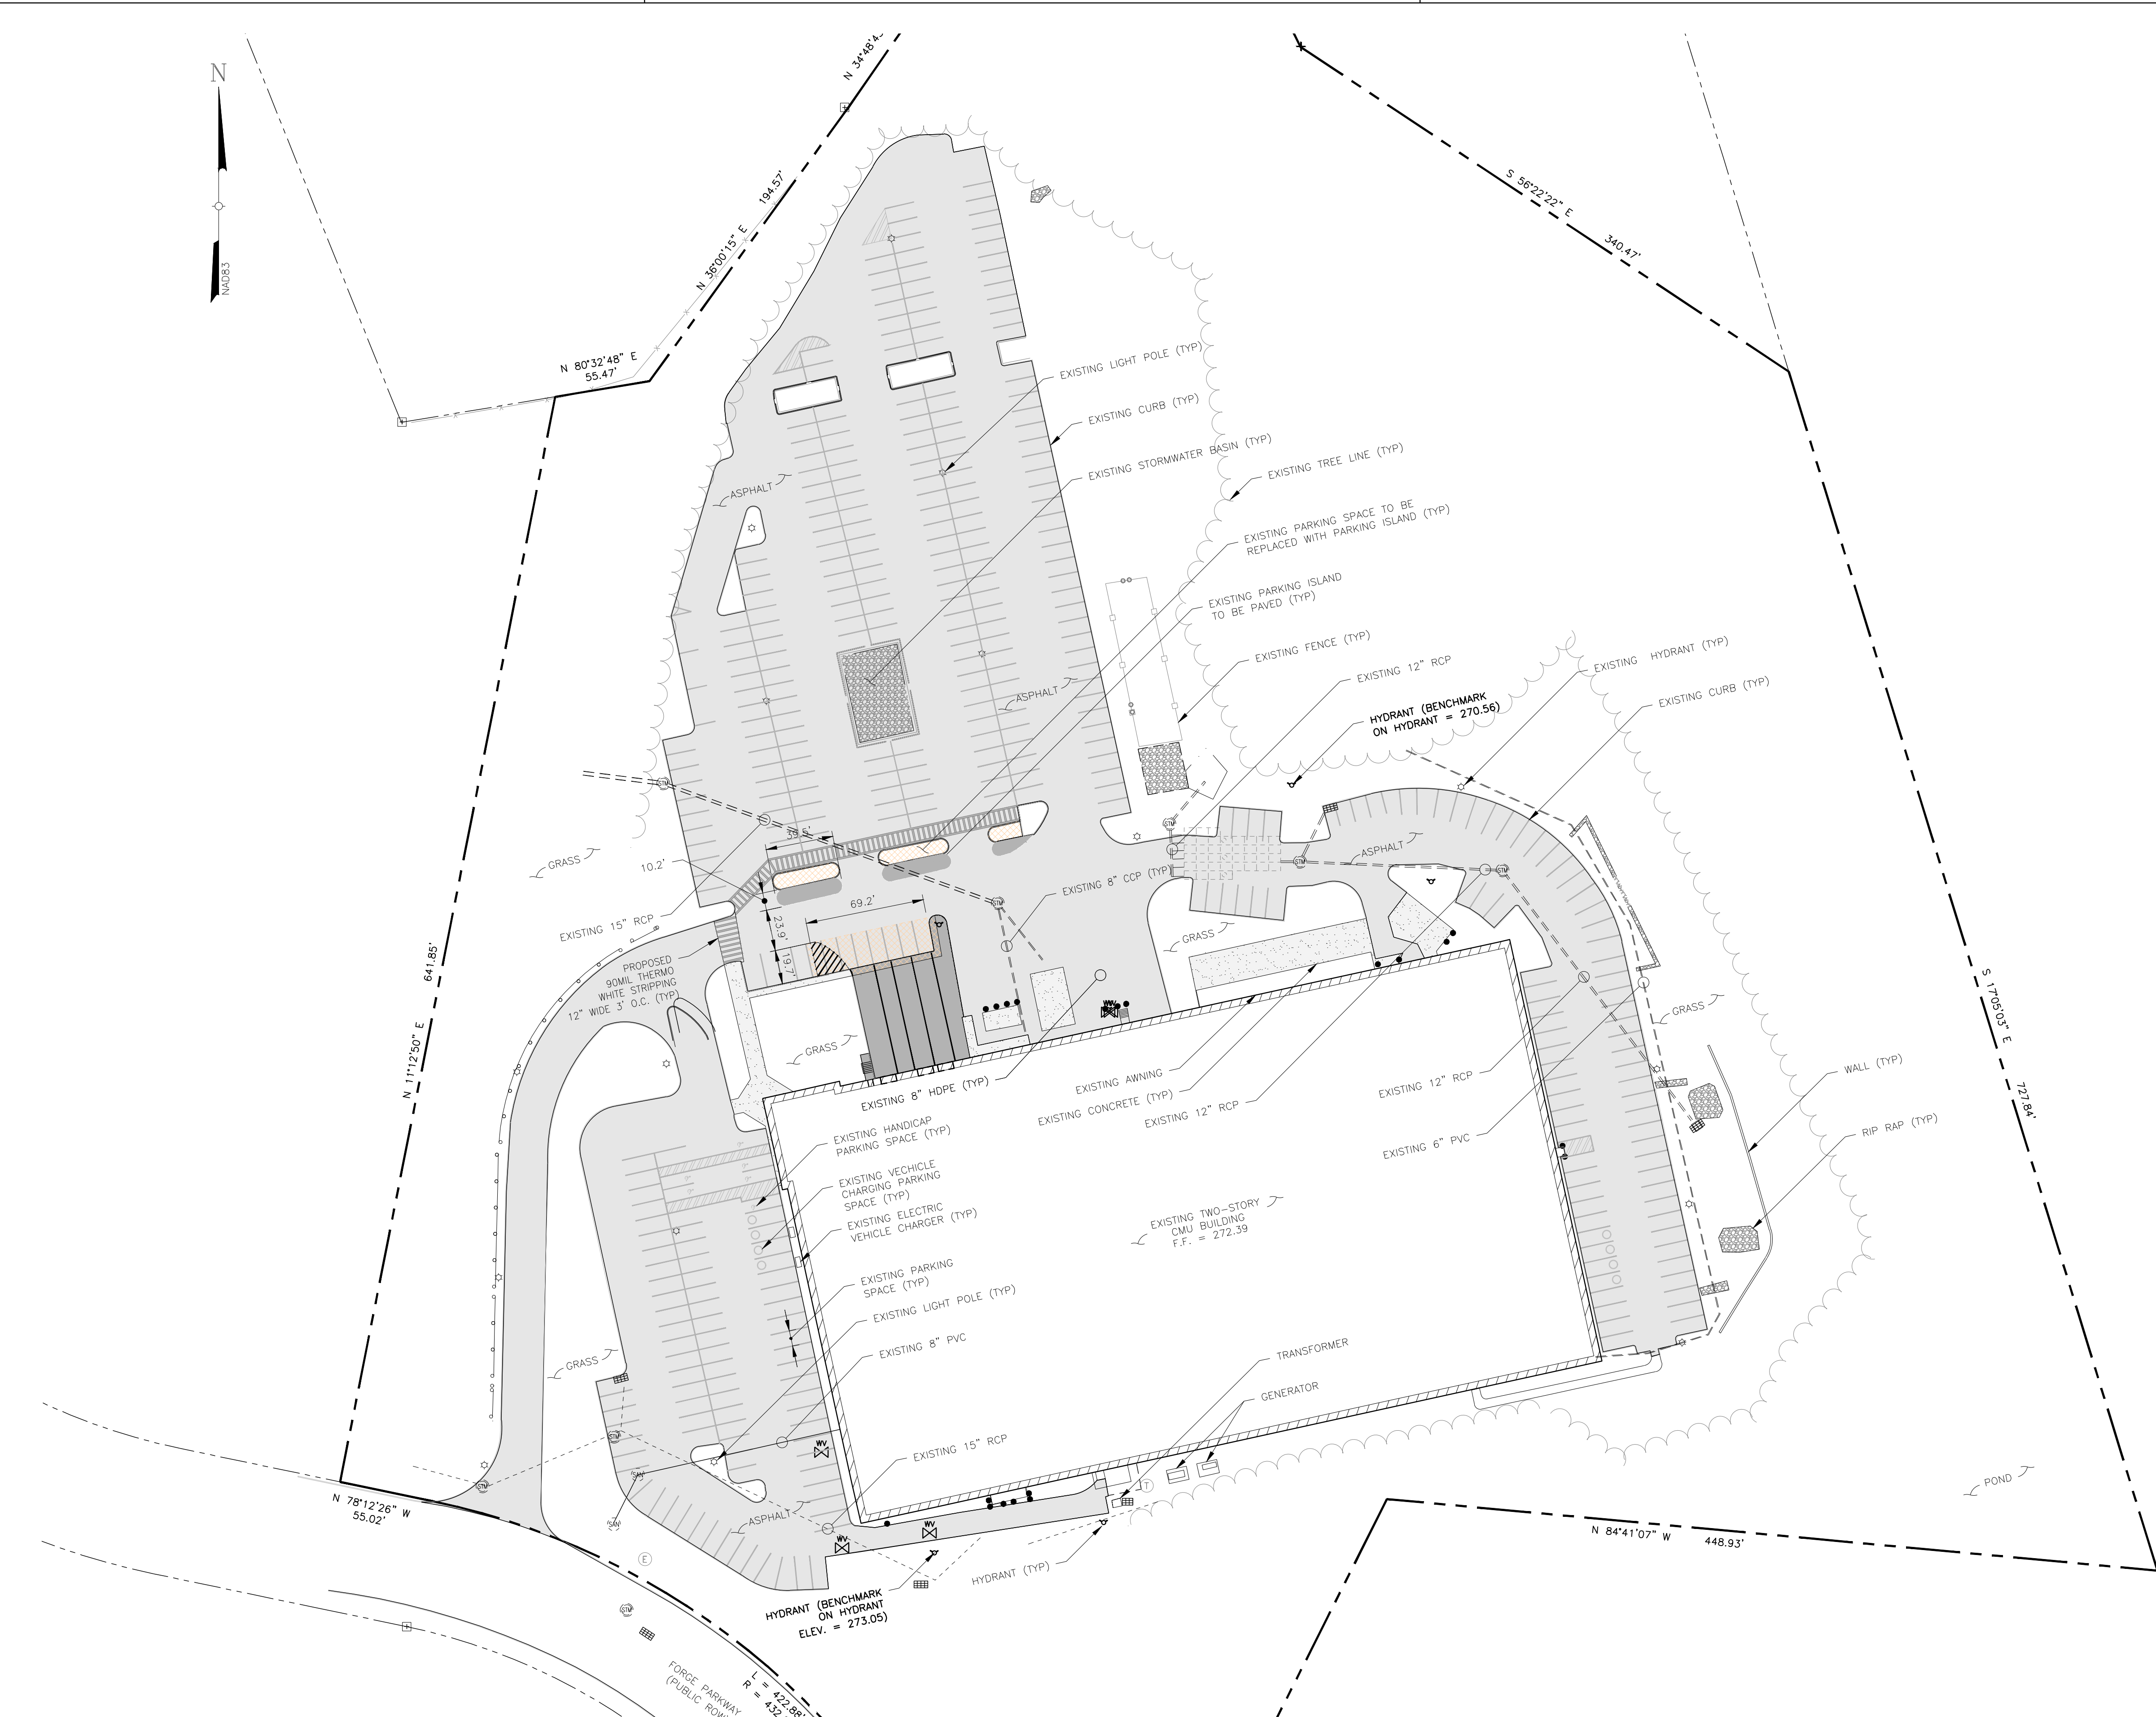TOTAL BUILDING AREA = 110,000.0± SF
 OFFICE SPACE (1) SPACE PER 250 SF
 MANUFACTURING (1) SPACE PER 400 SF
 LABORATORY (1) SPACE PER 400 SF
 WAREHOUSE (1) SPACE PER 1,000 SF

DESIGNATION	AREA	PER SF	SPACES REQUIRED
OFFICE	65,143 SF	/250	261
MANUFACTURING	30,022 SF	/400	76
LABORATORY	3,985 SF	/400	10
MANUFACTURING	30,022 SF	/1000	11
TOTAL PARKING SPACES REQUIRED			358
EXISTING PARKING SPACES			379
SPACES REMOVED FOR PAVING & PEDESTRIAN WALKWAYS			19
TOTAL PARKING SPACES PROVIDED			360

*EXISTING HANDICAP PARKING SPACES = 6
 *EXISTING VEHICLE CHARGING SPACE = 9
 (INCLUDED IN TOTAL PARKING COUNT)

BULK TABLE

INDUSTRIAL
 FRANKLIN ZONING BYLAW SECTION 185
 ATTACHMENT 9; LAST AMENDED 11-16-2016
 BY AMENDMENT 16-771

	REQUIRED	EXISTING	PROPOSED
OFFICE	65,143 SF	40,000 SF	811,378 SF
MANUFACTURING	30,022 SF	175'	608.25'
LABORATORY	3,985 SF	200'	1,038±'
MANUFACTURING	30,022 SF	157.5'	603±'

MINIMUM YARDS
 FRONT 40' 98.2' 98.2'
 SIDE 30'⁵ 51.7' 51.7'
 REAR 30'⁵ 367.5' 367.5'

% OF LOT UPLAND COVERED BY:
 STRUCTURES 70 13.5% 13.5%
 STRUCTURE & PAVING 80 32.5% 36.7%

⁵INCREASE BY THE COMMON BUILDING HEIGHT OF THE STRUCTURE, WHEN ABUTTING A RESIDENTIAL DISTRICT OF USE.

SEE APPROVED SITE PLAN DATED MAY 11, 2009, REVISED TO JULY 14, 2009 FOR THERMO FISHER SCIENTIFIC, INC. SITE PLAN MODIFICATION 27 FORGE PARKWAY FRANKLIN, MASSACHUSETTS, BY GUERRIERE & HALNON, INC.

PROPOSED BUILDING COVERAGE FOR THIS PROJECT:	00.0 SF
PROPOSED PAVT/CONC WITH THIS PROJECT:	4,837.8 SF
EXISTING PAVT/CONC TO BE REMOVED FOR THIS PROJECT:	988.9 SF
NET DISTURBANCE AREA FOR THIS PROJECT:	5,826.7 SF

LEGEND

	PROPERTY LINE		MONUMENT FOUND
	ADJOINING PROPERTY LINE		CROSS CUT FOUND
	EASEMENT LINE		IRON ROD FOUND
	INDEX CONTOUR LINE		BOLLARD
	CONTOUR LINE		GATEPOST
	CHAIN LINK FENCE		UTILITY POLE
	STOCKADE FENCE		CATCH BASIN
	CURB LINE		FIELD INLET (SQUARE)
	EDGE OF CONCRETE		ROOF DRAIN
	EDGE OF GRAVEL		CLEAN OUT
	EDGE OF PAVEMENT		MANHOLE (DRAIN)
	EDGE OF WATER/SWALE		MANHOLE (ELECTRIC)
	GUIDE RAIL		MANHOLE (SAN. SEWER)
	PAINTED TRAFFIC LINES		MANHOLE (UNKNOWN)
	EDGE OF WETLANDS		WATER VALVE
	STORM SEWER		HYDRANT
	TREE LINE		LIGHT POST
	STRUCTURE		WETLAND FLAG
	BOTTOM/TOP OF CURB ELEVATION		
	BOTTOM/TOP OF WALL ELEVATION		
	DOOR SILL ELEVATION		
	SPOT ELEVATION		

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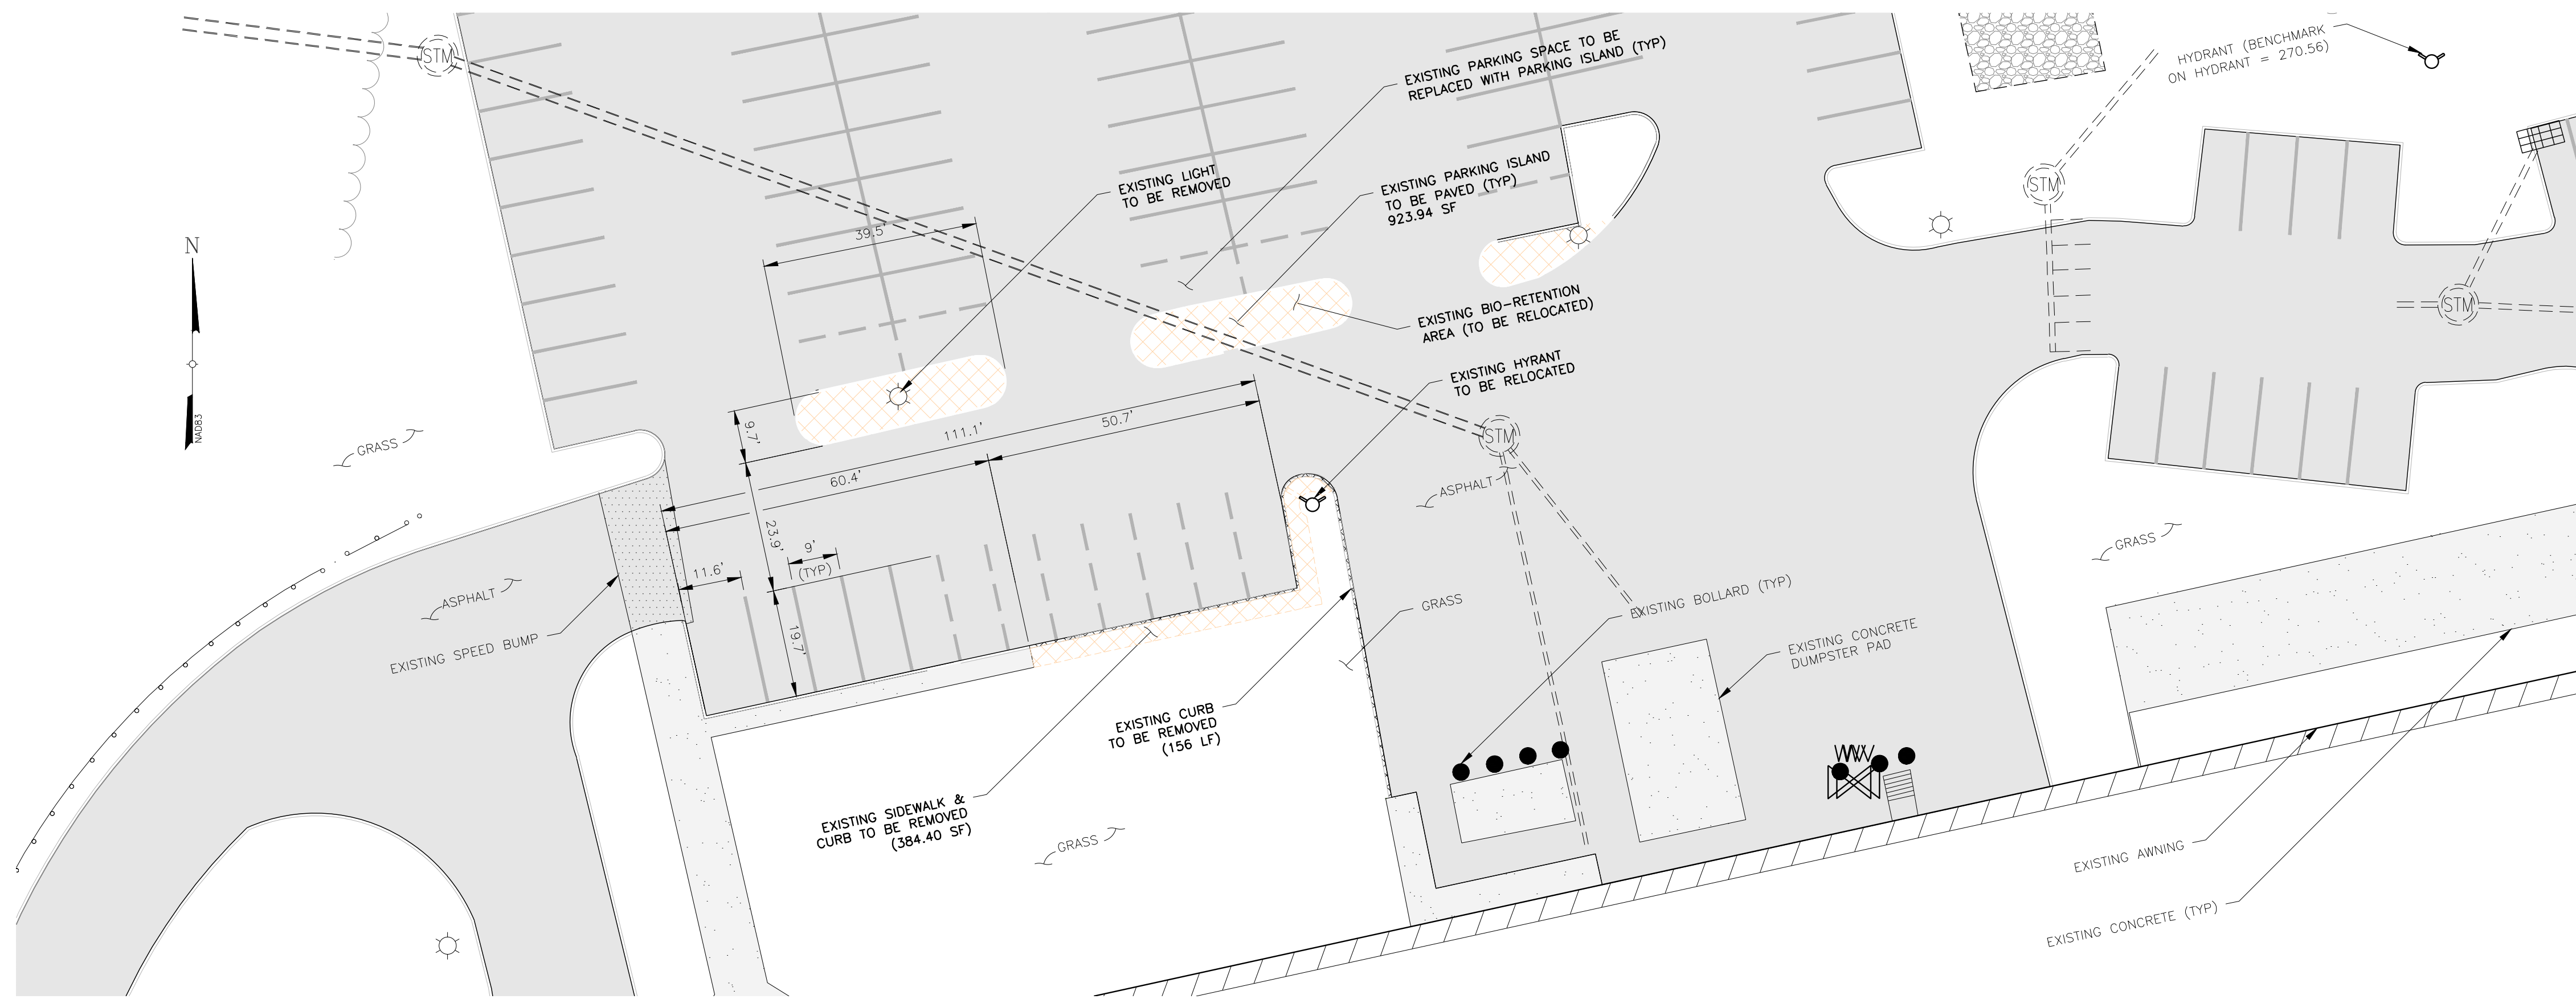
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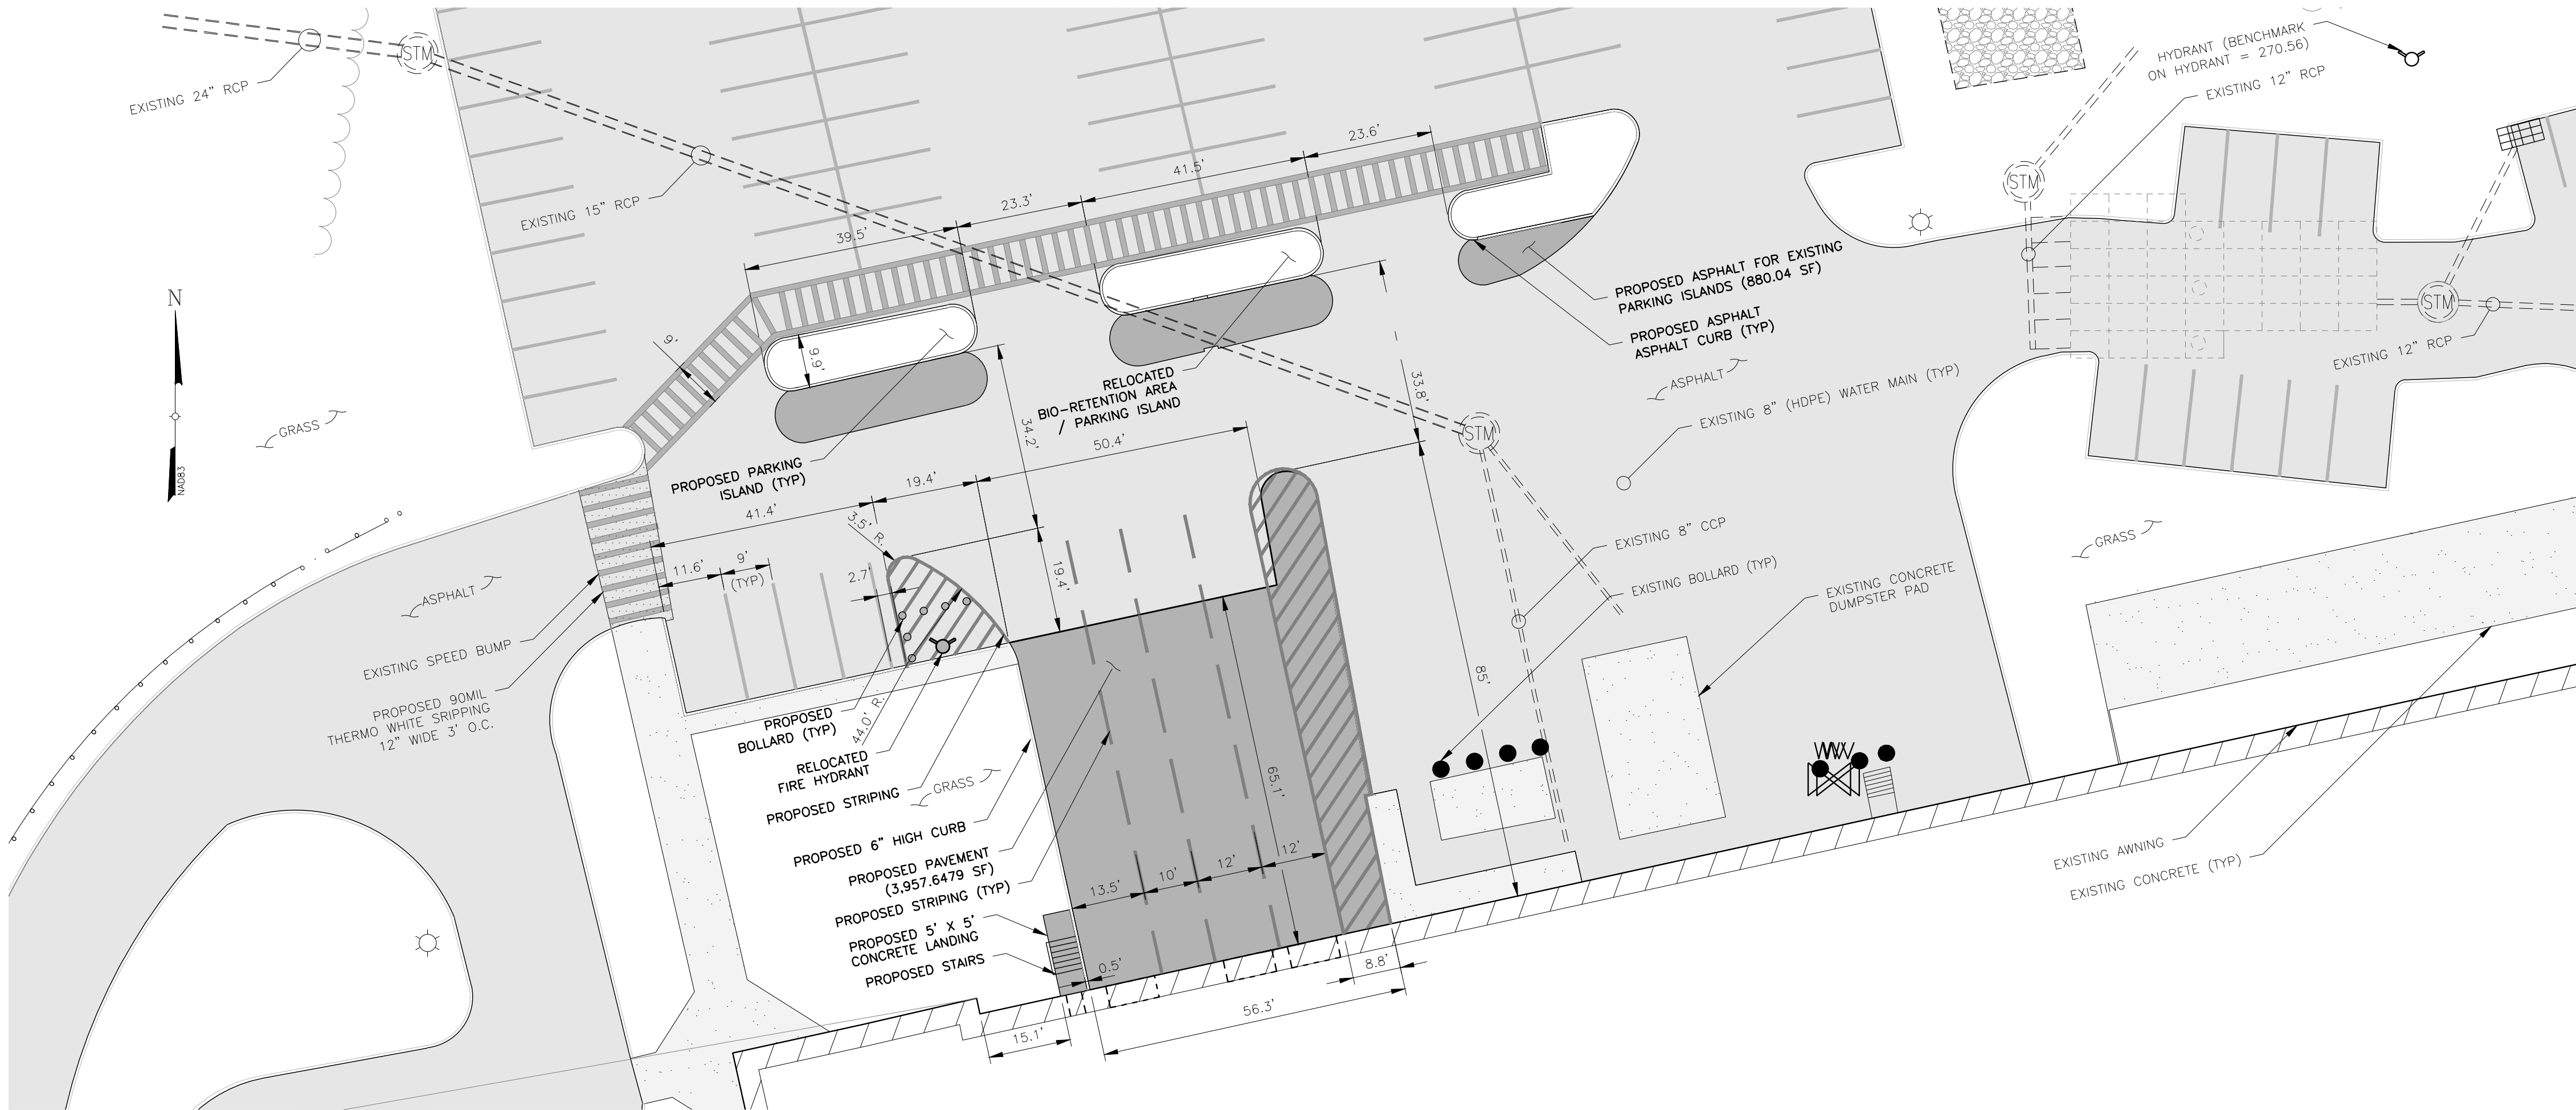
OVERALL SITE PLAN
 THERMOFISHER
 27 FORGE PARKWAY
 TOWN OF FRANKLIN
 COUNTY OF NORFOLK, MASSACHUSETTS

Date	Work Order	Drawing No.	Rev
04/28/2021			
Scale	10734.THERMOFISHER	C1	1

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EXISTING ENLARGED SITE PLAN



PROPOSED ENLARGED SITE PLAN

LEGEND			
	PROPERTY LINE		MONUMENT FOUND
	ADJOINING PROPERTY LINE		CROSS CUT FOUND
	EASEMENT LINE		IRON ROD FOUND
	INDEX CONTOUR LINE		BOLLARD
	CONTOUR LINE		GATEPOST
	CHAIN LINK FENCE		UTILITY POLE
	STOCKADE FENCE		CATCH BASIN
	CURB LINE		FIELD INLET (SQUARE)
	EDGE OF CONCRETE		ROOF DRAIN
	EDGE OF GRAVEL		CLEAN OUT
	EDGE OF PAVEMENT		MANHOLE (DRAIN)
	EDGE OF WATER/SWALE		MANHOLE (ELECTRIC)
	GUIDE RAIL		MANHOLE (SAN SEWER)
	PAINTED TRAFFIC LINES		MANHOLE (UNKNOWN)
	EDGE OF WETLANDS		WATER VALVE
	STORM SEWER		HYDRANT
	TREE LINE		LIGHT POST
	STRUCTURE		WETLAND FLAG
	BOTTOM/TOP OF CURB ELEVATION		
	BOTTOM/TOP OF WALL ELEVATION		
	DOOR SILL ELEVATION		
	SPOT ELEVATION		

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ENLARGED SITE PLANS			
THERMOFISHER 27 FORGE PARKWAY TOWN OF FRANKLIN COUNTY OF NORFOLK, MASSACHUSETTS			
Date	Work Order	Drawing No.	Rev
04/28/2021	10734.THERMOFISHER	C2	1
Scale 1" = 20'			



OVERALL DRAINAGE & GRADING PLAN

LEGEND			
	PROPERTY LINE		MONUMENT FOUND
	ADJOINING PROPERTY LINE		CROSS CUT FOUND
	EASEMENT LINE		IRON ROD FOUND
	INDEX CONTOUR LINE		BOLLARD
	CONTOUR LINE		GATEPOST
	CHAIN LINK FENCE		UTILITY POLE
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	PAINTED TRAFFIC LINES		WATER VALVE
	EDGE OF WETLANDS		HYDRANT
	STORM SEWER		LIGHT POST
	TREE LINE		WETLAND FLAG
	STRUCTURE		FLOW ARROW
	BOTTOM/TOP OF CURB ELEVATION		
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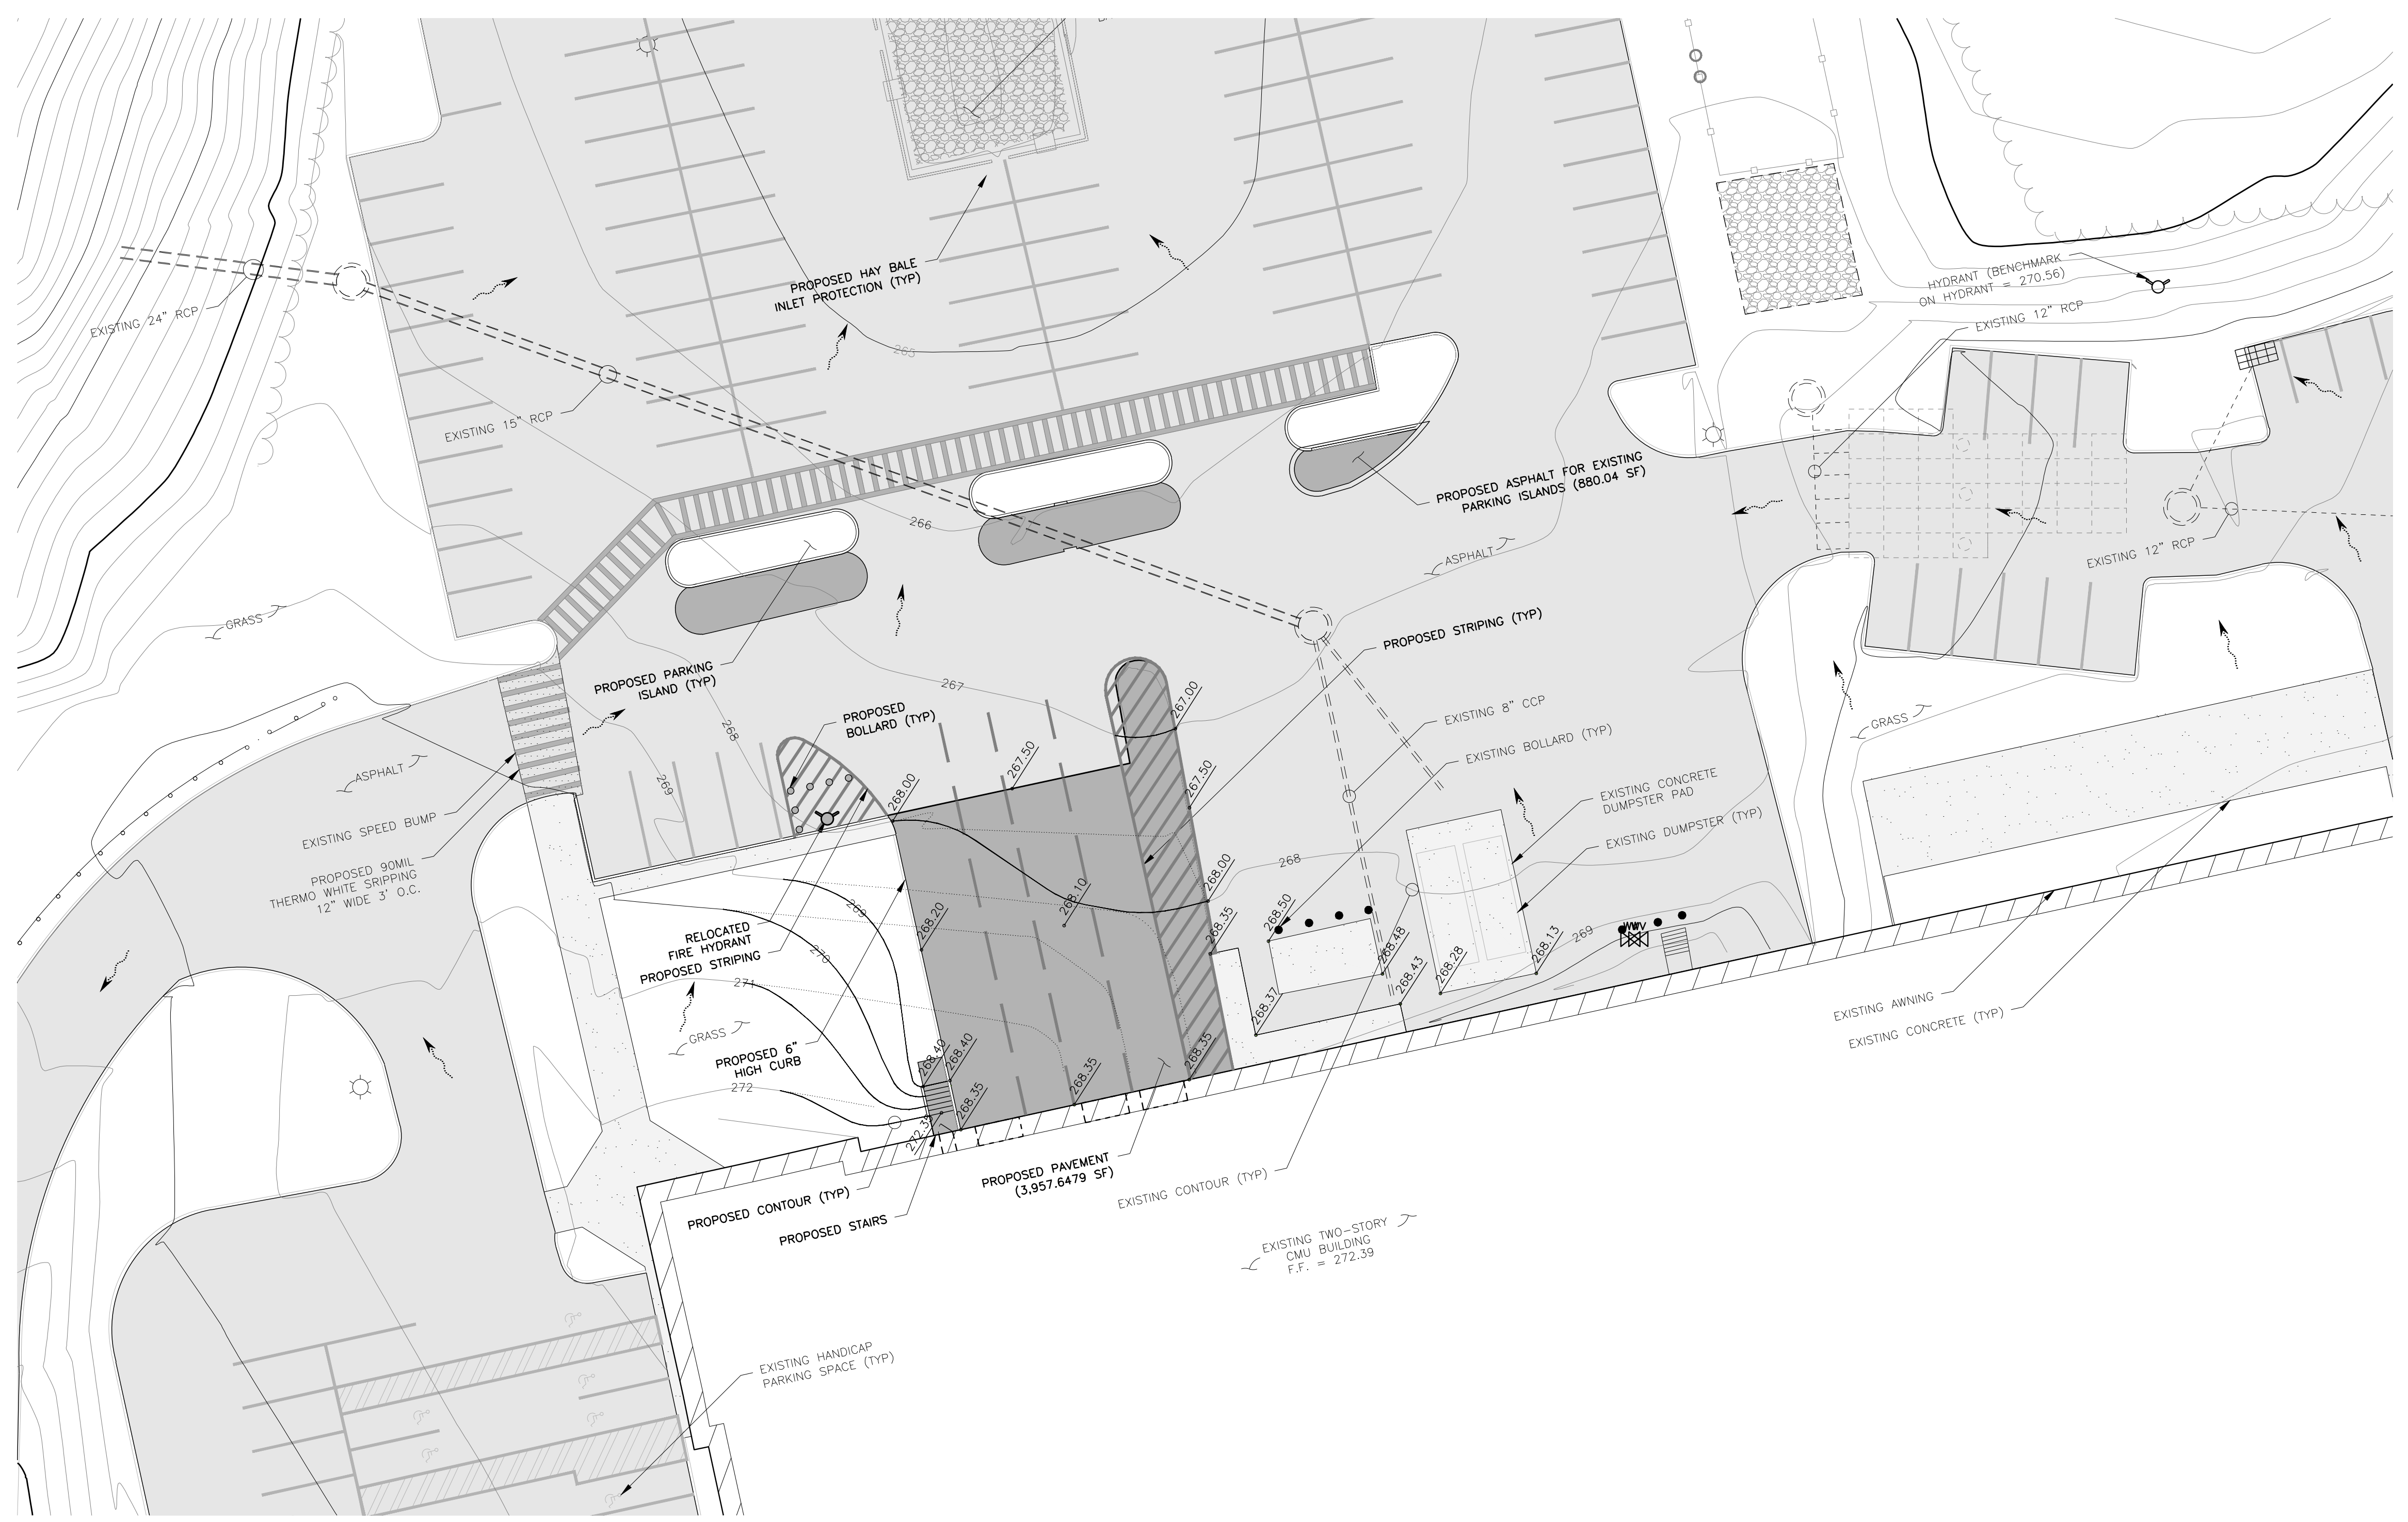
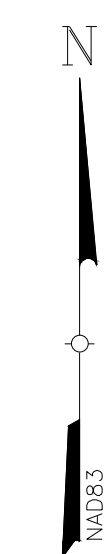
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OVERALL DRAINAGE & GRADING PLAN			
THERMOFISHER 27 FORGE PARKWAY TOWN OF FRANKLIN COUNTY OF NORFOLK, MASSACHUSETTS			
Date 04/28/2021	Work Order 10734.THERMOFISHER	Drawing No. C3	Rev 1
Scale 1" = 50'			



PROPOSED ENLARGED DRAINAGE & GRADING PLAN

LEGEND			
	PROPERTY LINE		MONUMENT FOUND
	ADJOINING PROPERTY LINE		CROSS CUT FOUND
	EASEMENT LINE		IRON ROD FOUND
	INDEX CONTOUR LINE		BOLLARD
	CONTOUR LINE		GATEPOST
	CHAIN LINK FENCE		UTILITY POLE
	STOCKADE FENCE		CATCH BASIN
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	EDGE OF WETLANDS		WATER VALVE
	STORM SEWER		HYDRANT
	TREE LINE		LIGHT POST
	STRUCTURE		WETLAND FLAG
	BOTTOM/TOP OF CURB ELEVATION		FLOW ARROW
	BOTTOM/TOP OF WALL ELEVATION		
	DOOR SILL ELEVATION		
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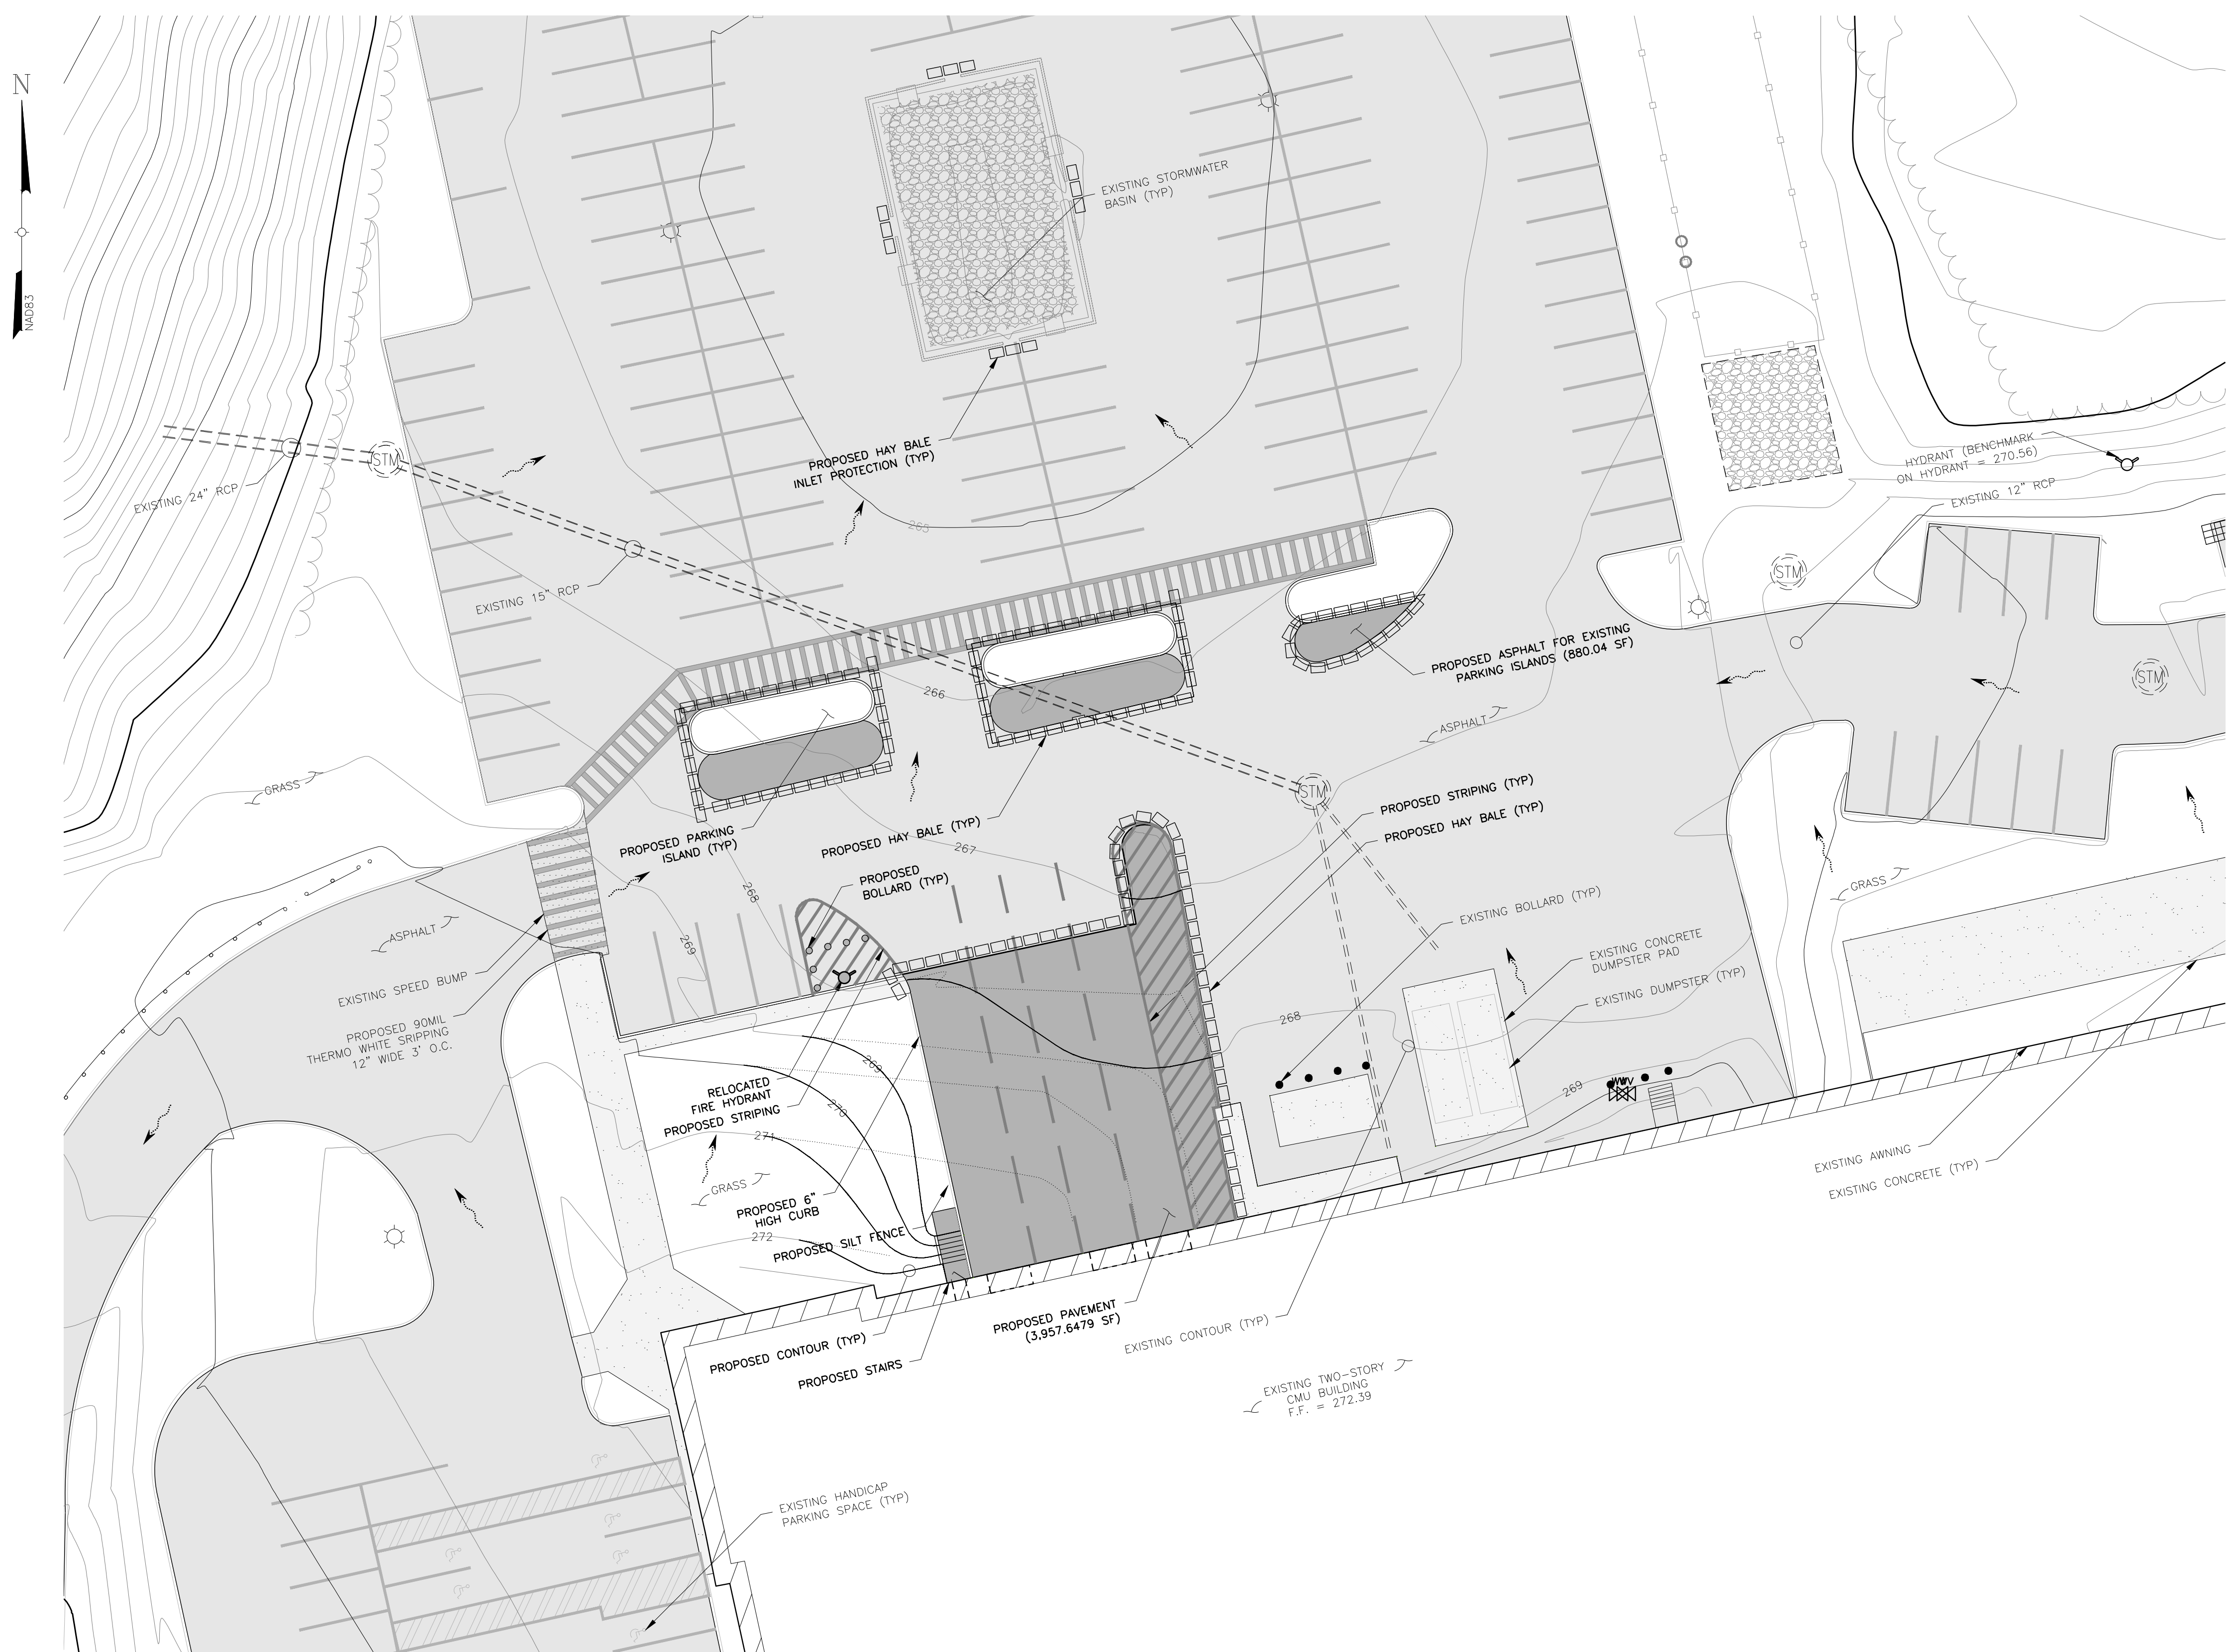
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ENLARGED DRAINAGE & GRADING PLAN			
THERMOFISHER 27 FORGE PARKWAY TOWN OF FRANKLIN COUNTY OF NORFOLK, MASSACHUSETTS			
Date	Work Order	Drawing No.	Rev
04/28/2021			
Scale	10734.THERMOFISHER	C4	1
1" = 20'			



PROPOSED EROSION & SEDIMENT CONTROL PLAN

LEGEND			
	PROPERTY LINE		MONUMENT FOUND
	ADJOINING PROPERTY LINE		CROSS CUT FOUND
	EASEMENT LINE		IRON ROD FOUND
	INDEX CONTOUR LINE		BOLLARD
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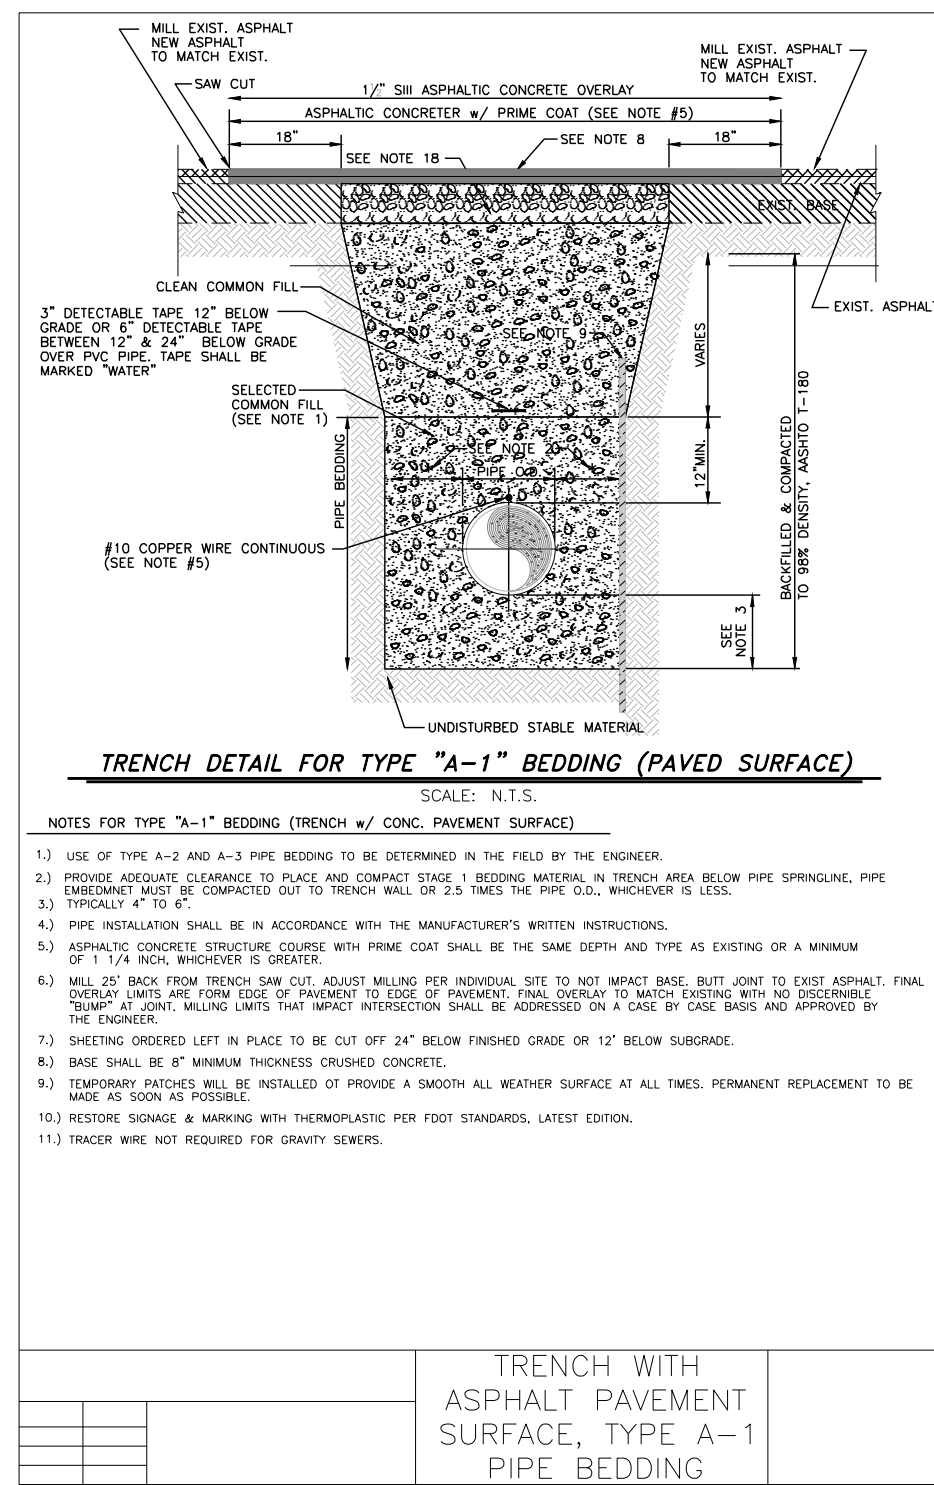
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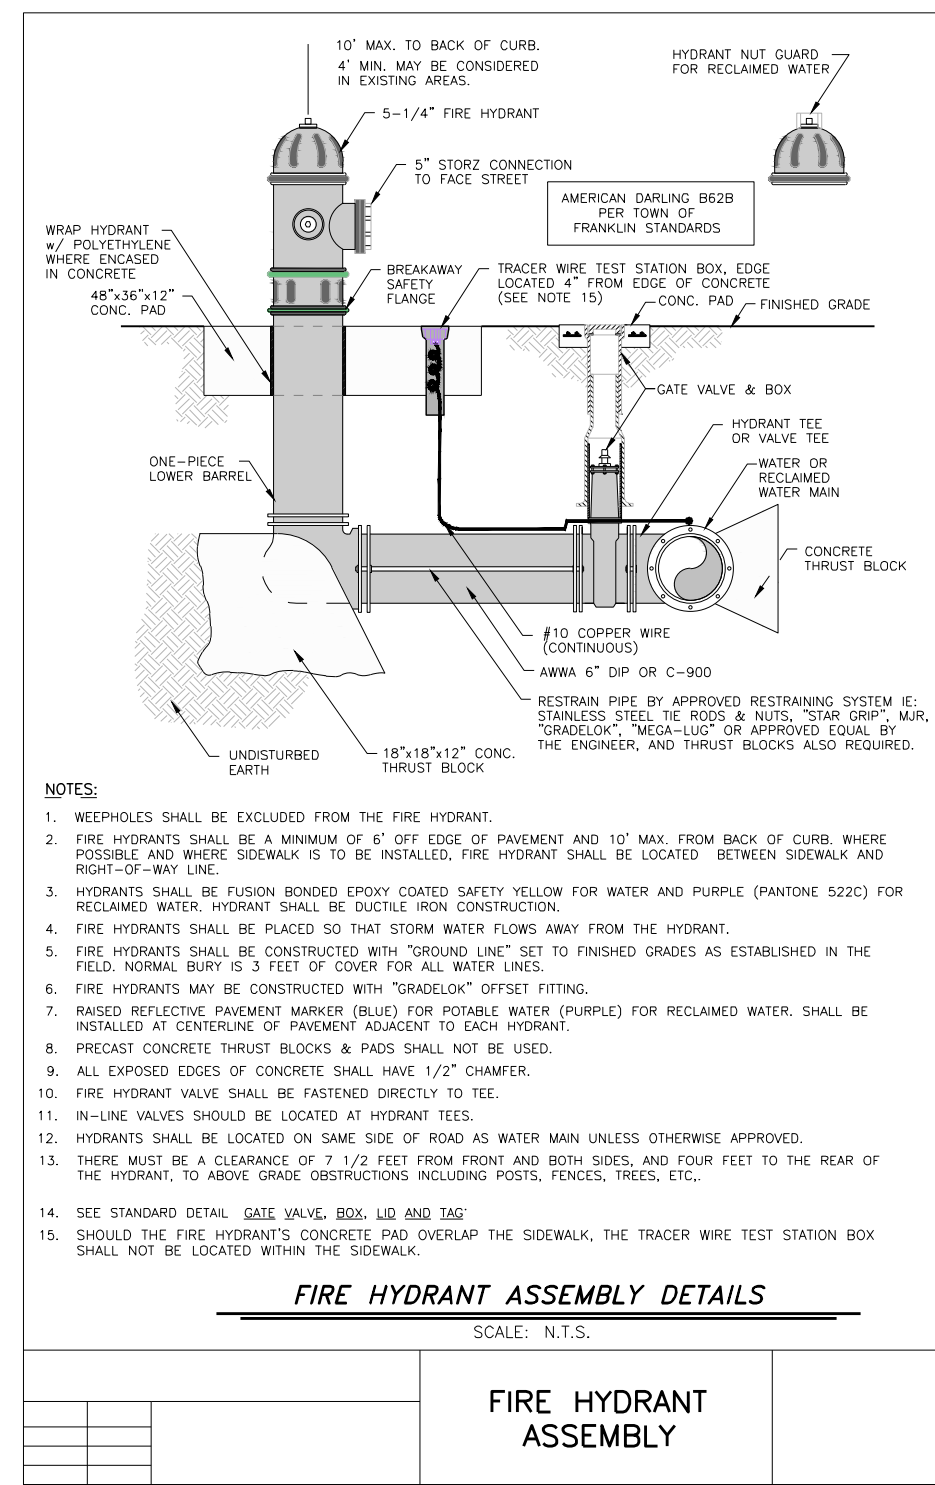
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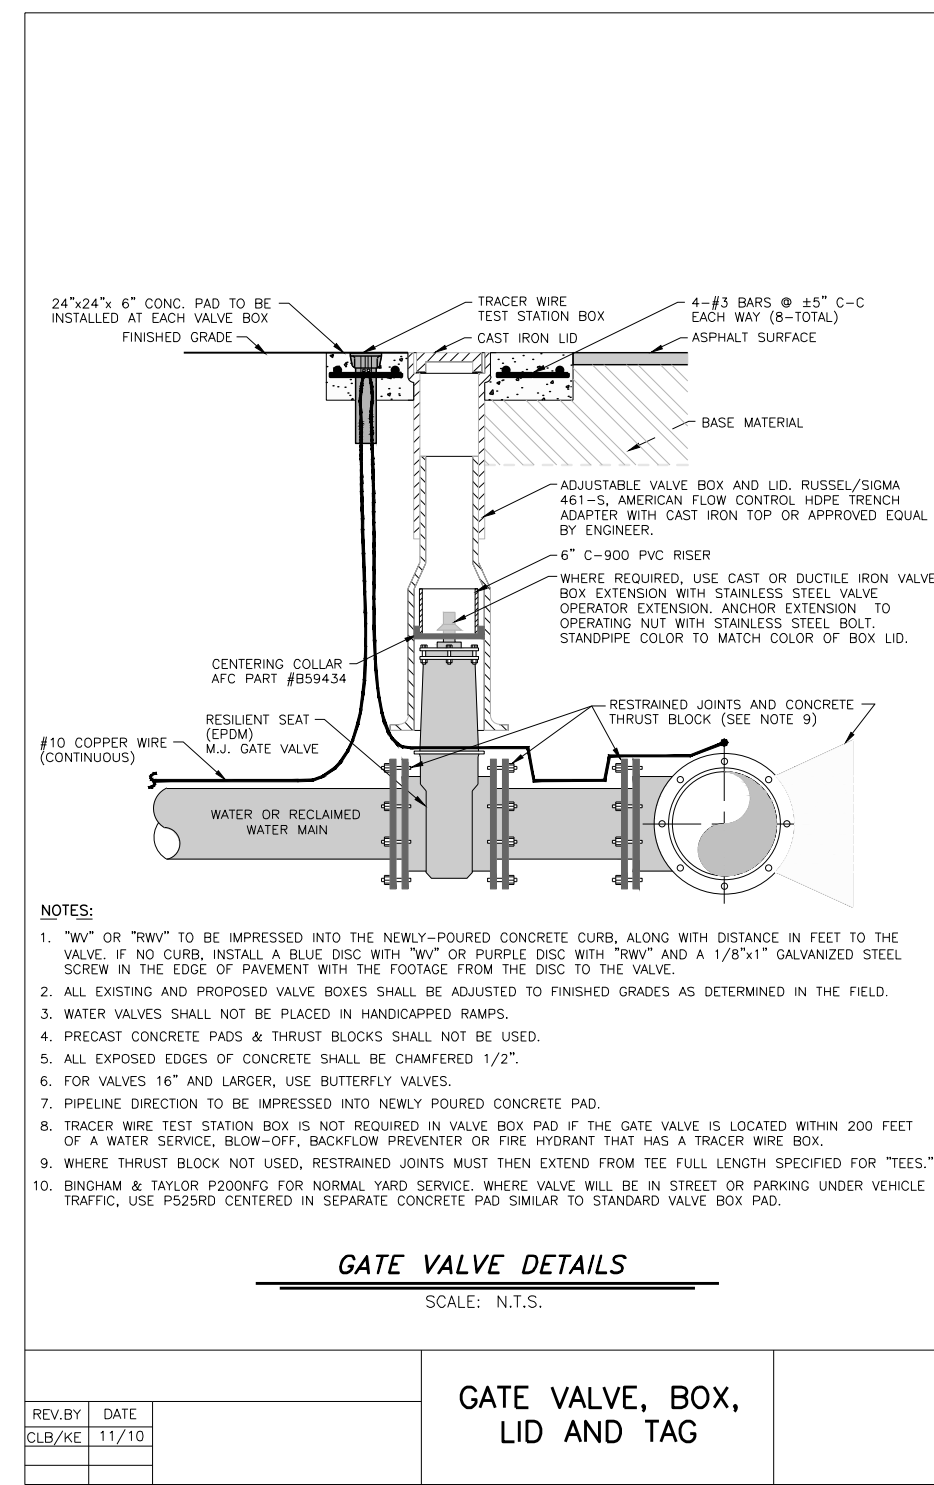
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Scale: 1" = 20'			




TRENCH DETAIL
NTS




FIRE HYDRANT DETAIL
NTS



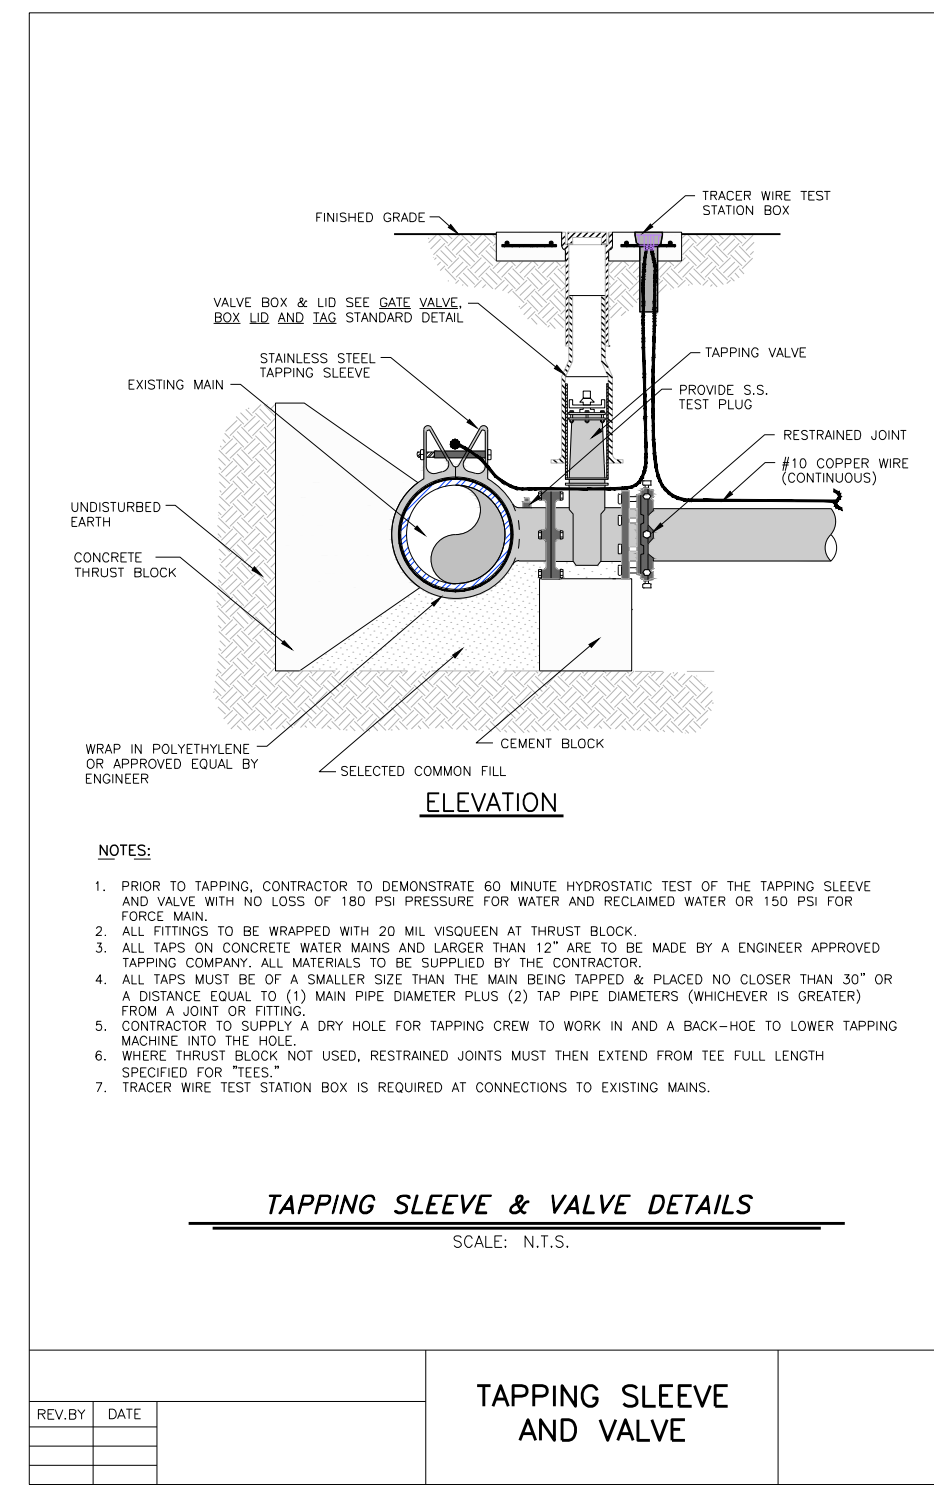
GATE VALVE DETAIL
NTS




TAPPING SLEEVE & VALVE DETAIL
NTS

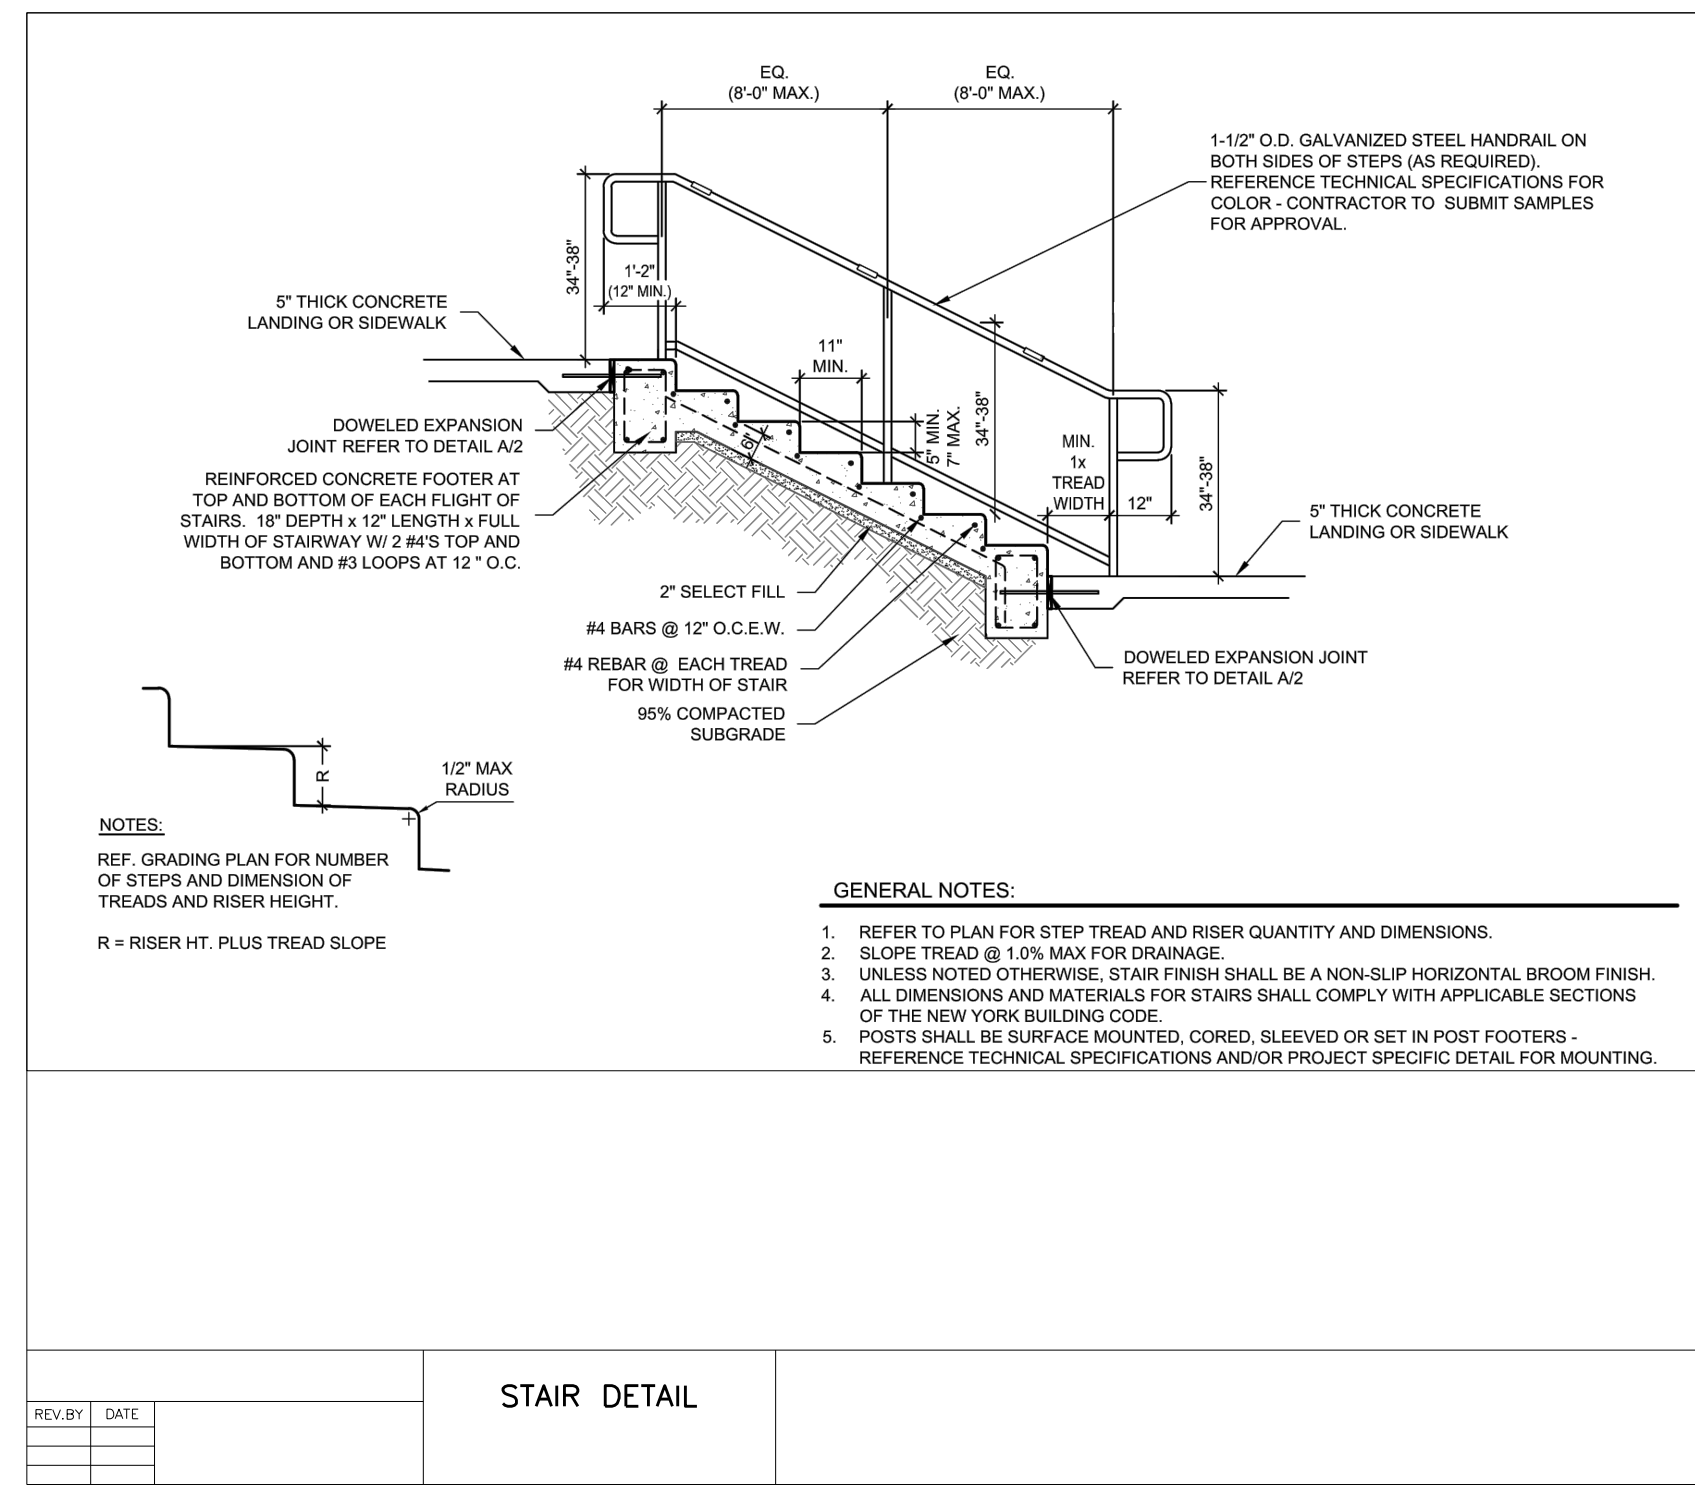


STAIR DETAIL
NTS

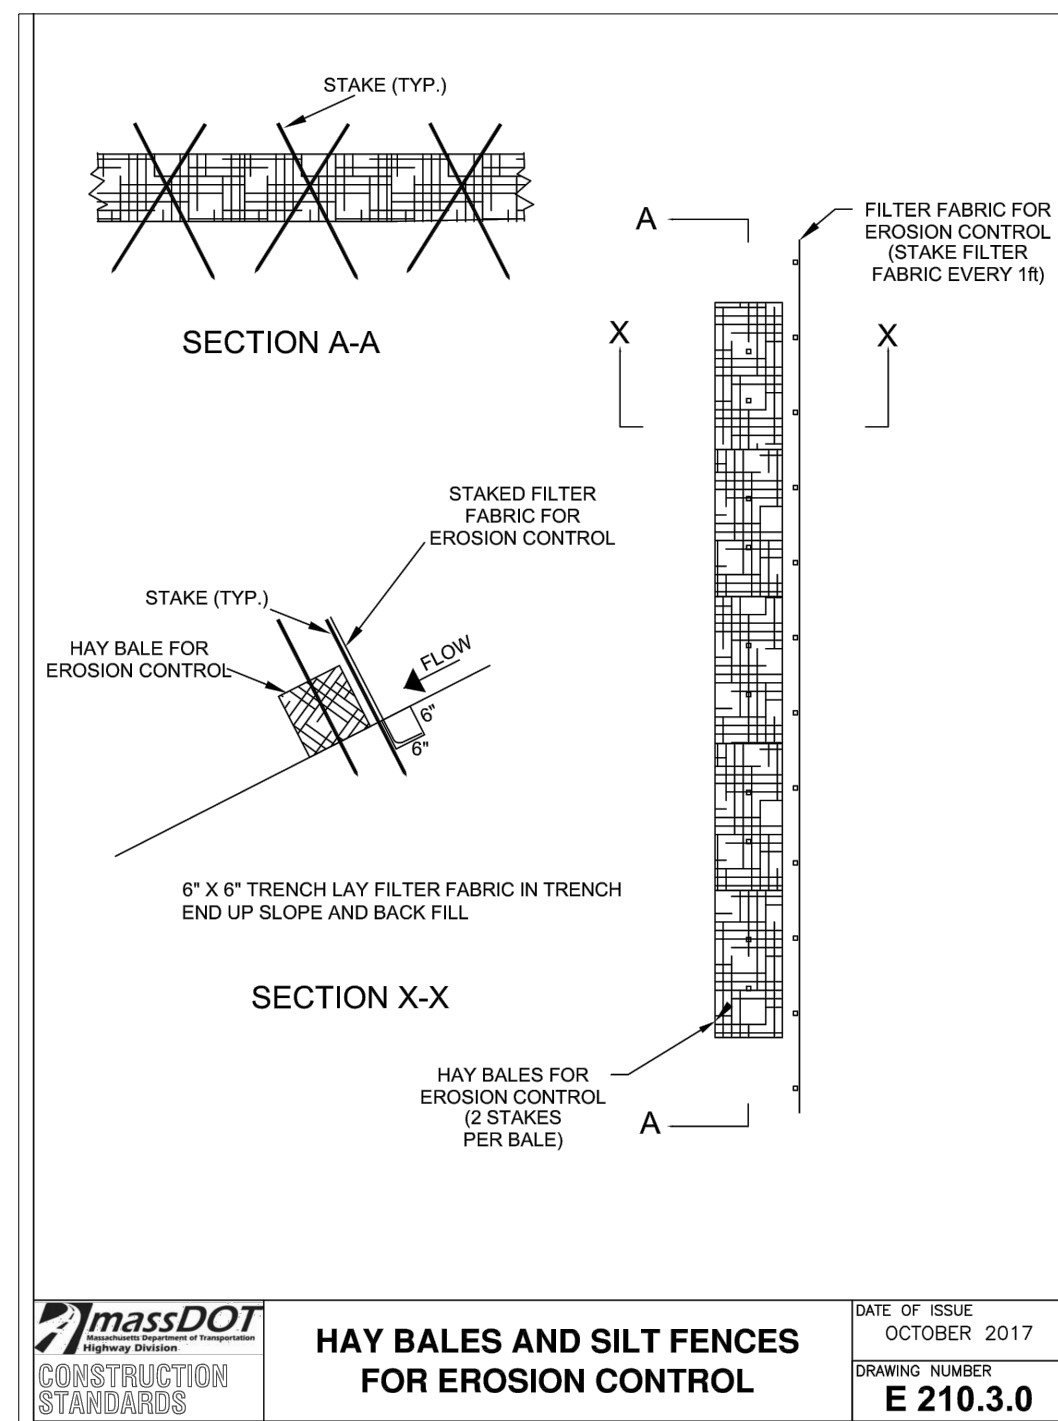


HAY BALE DETAIL
NTS

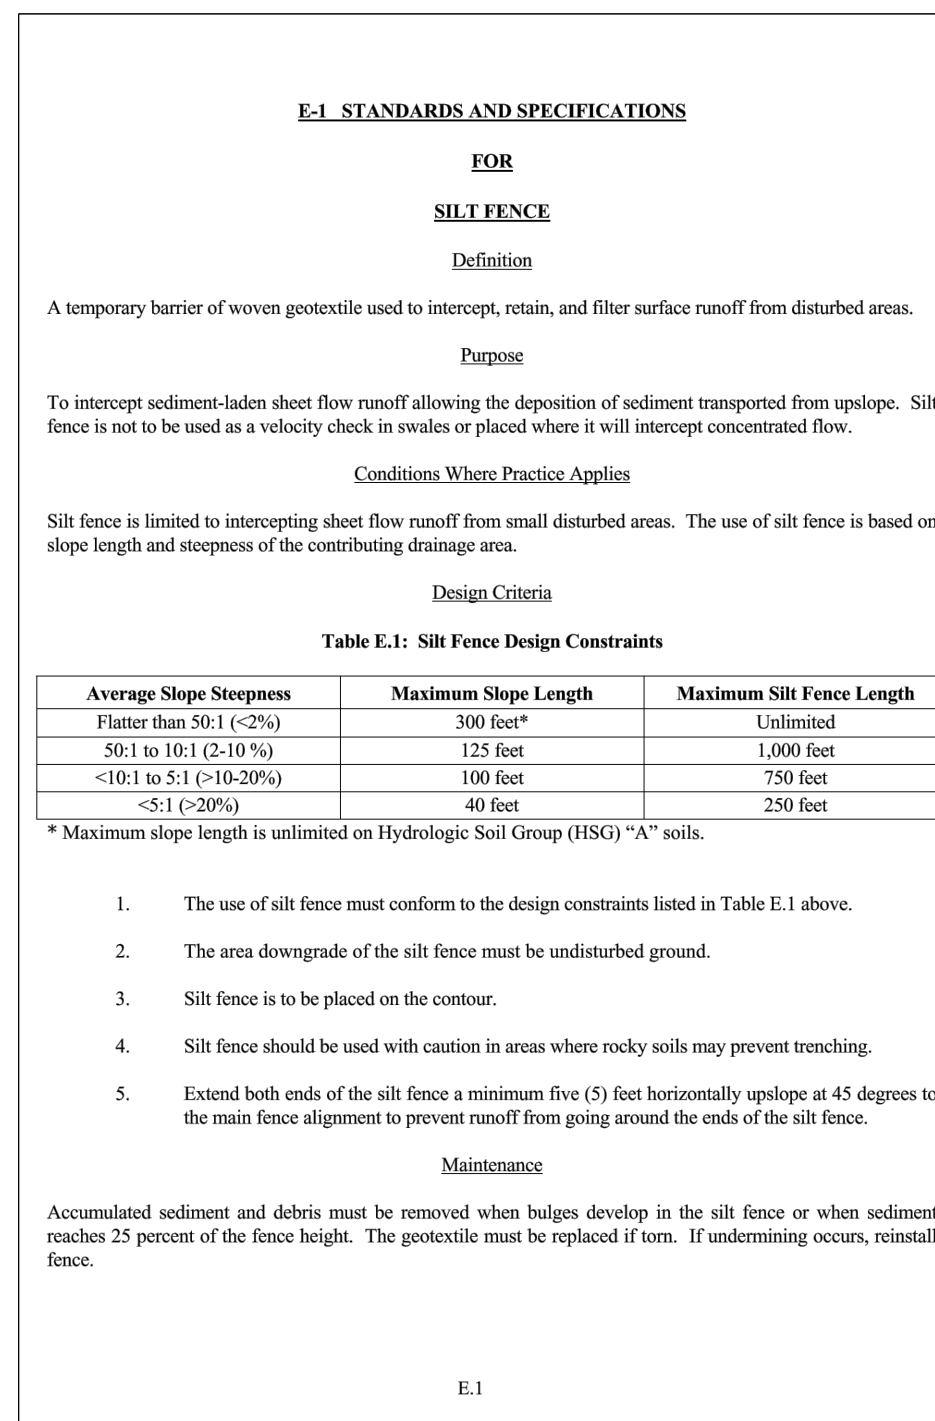


E.1

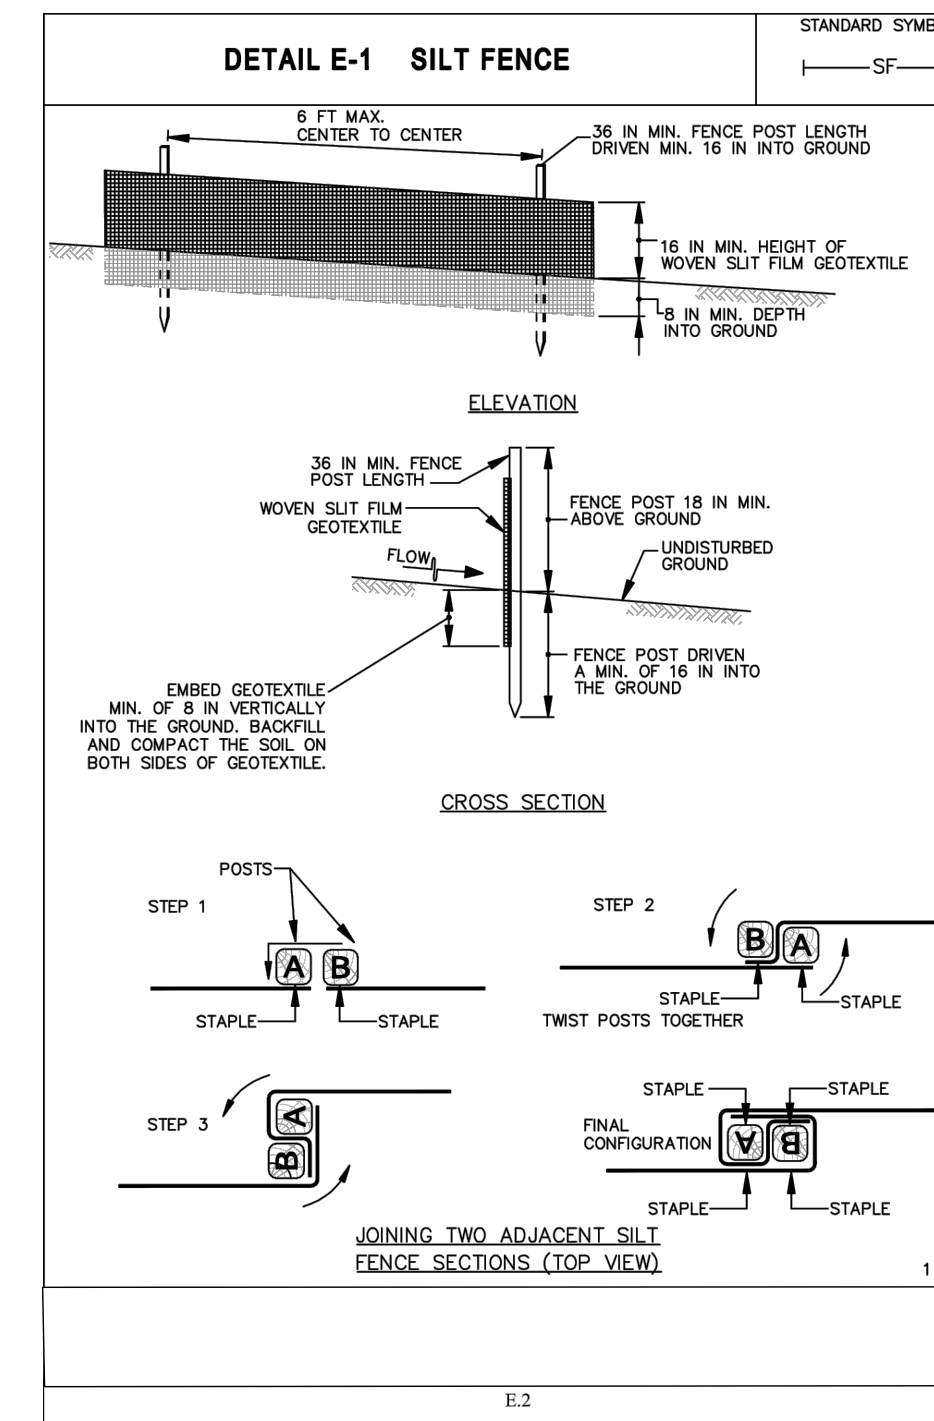


SILT FENCE DETAIL
NTS

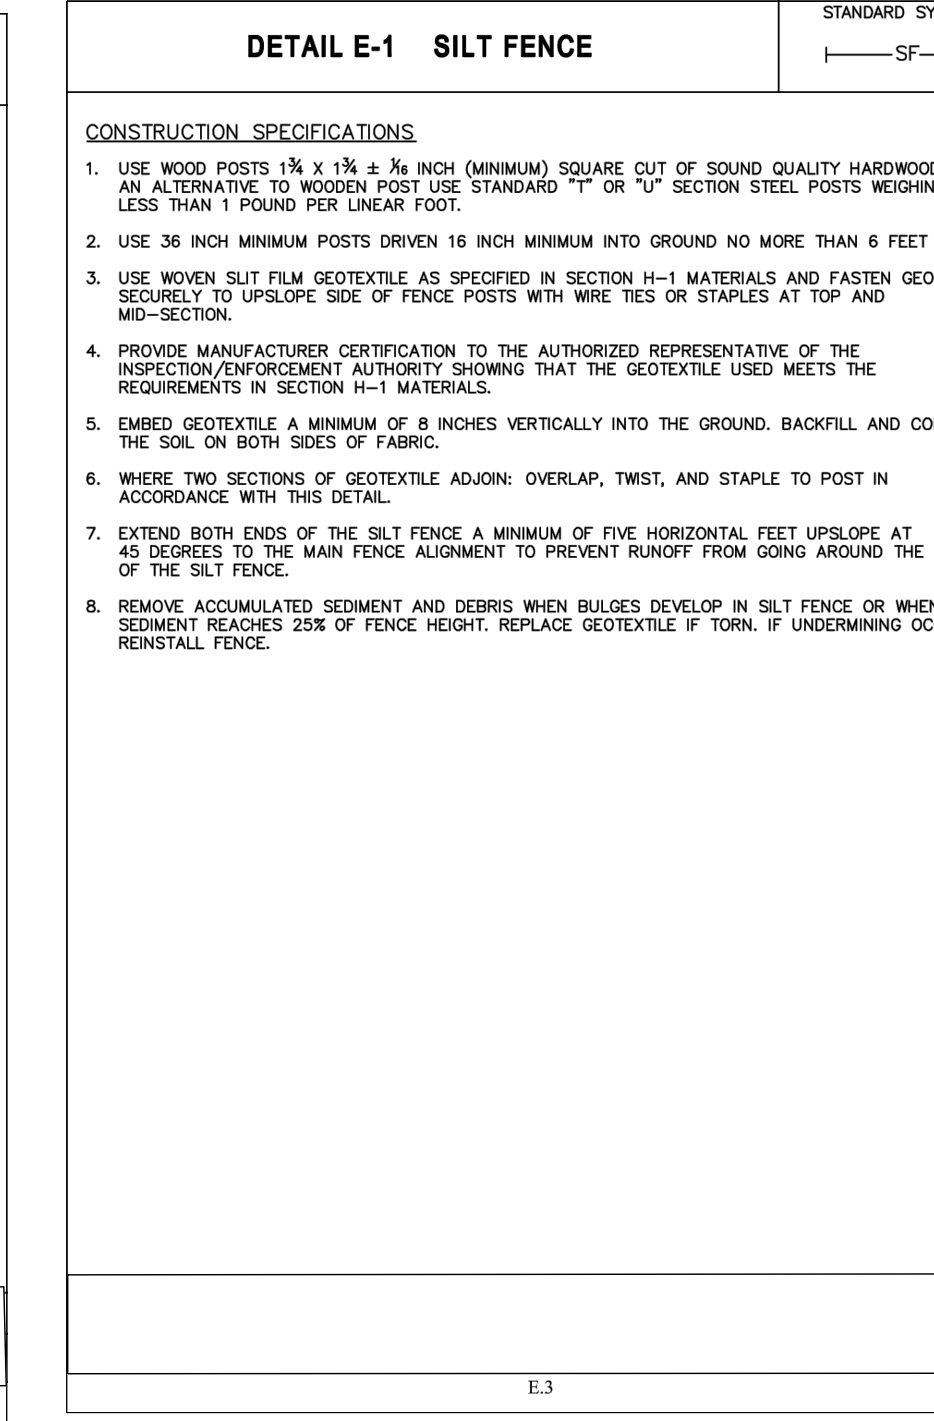

E.3

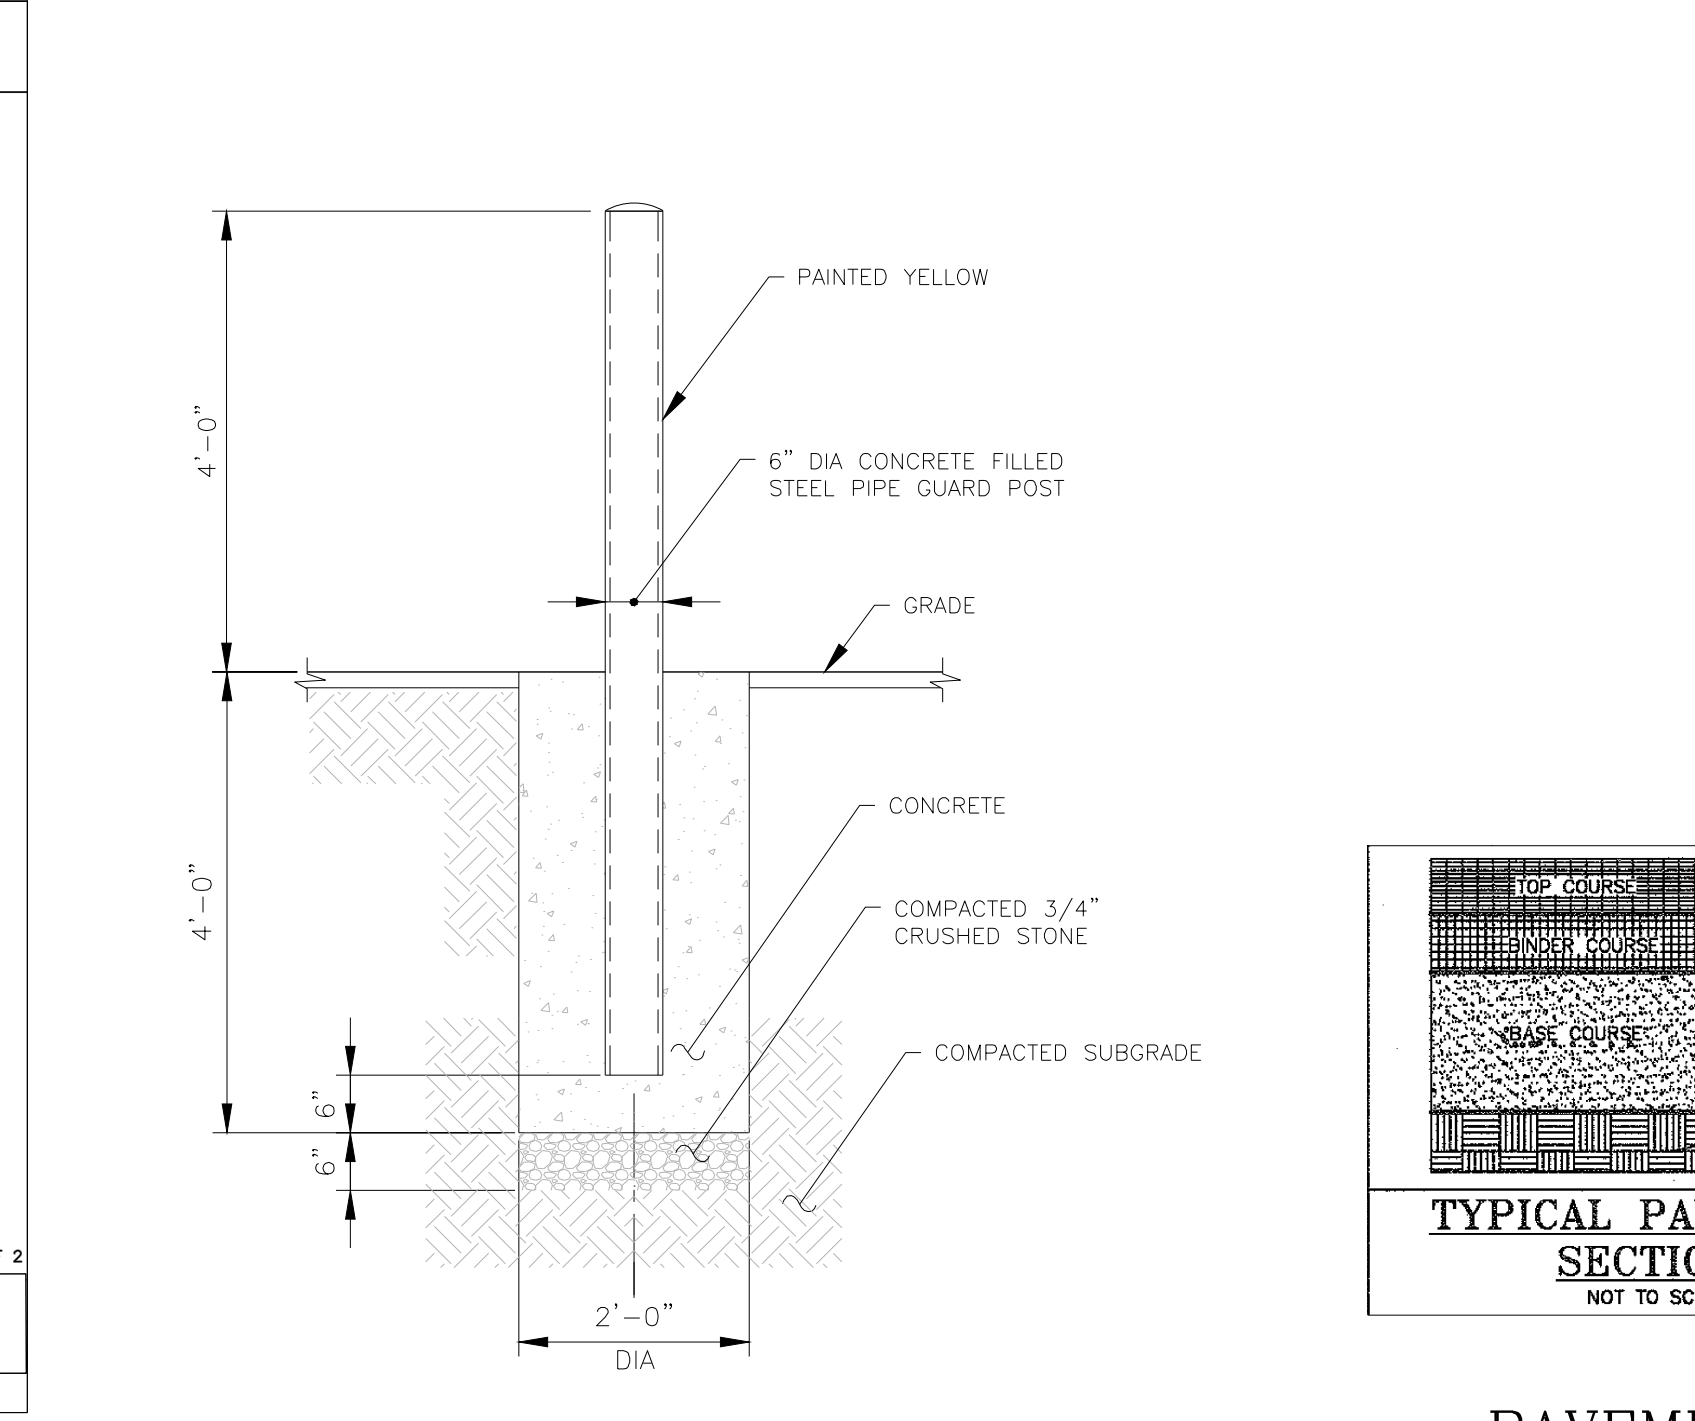

BOLLARD DETAIL
NTS

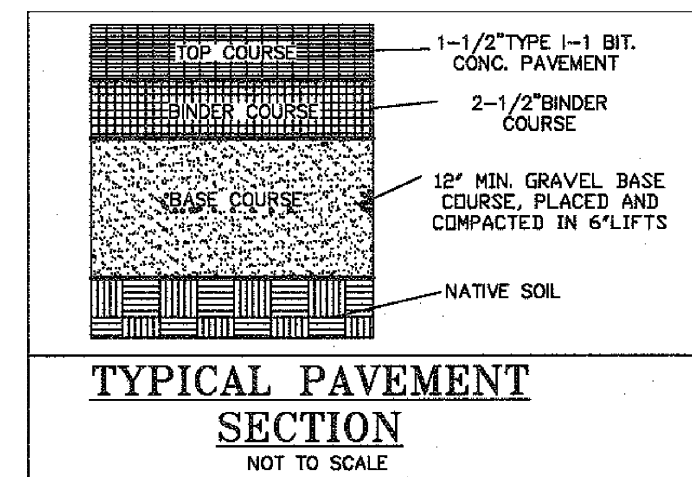

PAVEMENT DETAIL
NTS

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0 1 2 3
ORIGINAL SIZE IN INCHES

Rev	Date	Revision	Approved	Designed by	Drawn by	Checked by
0	06/15/21	ISSUED		N/A	Grant Bogue	JMP
1	7/6/2021	PER COMMENTS				


For Comment
 For Approval
 For Bid
 For Construction

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Mountaintown, NY 10953 www.tectonicengineering.com

DETAILS			
THERMOFISHER 27 FORGE PARKWAY TOWN OF FRANKLIN COUNTY OF NORFOLK, MASSACHUSETTS			
Date 04/28/2021	Work Order 10734.THERMOFISHER	Drawing No. C6	Rev 1
Scale 1" = 20'			

ARRAY LEGEND			
ARRAY	CONFIG	MODULE COUNT	SIZE kW-DC
1	6 X 55	330	132.00
2	6 X 72	432	172.80
3	6 X 96	576	230.40
4	6 X 55	330	132.00
TOTAL		1668	667.20
TALESON TD6G72M 400W			

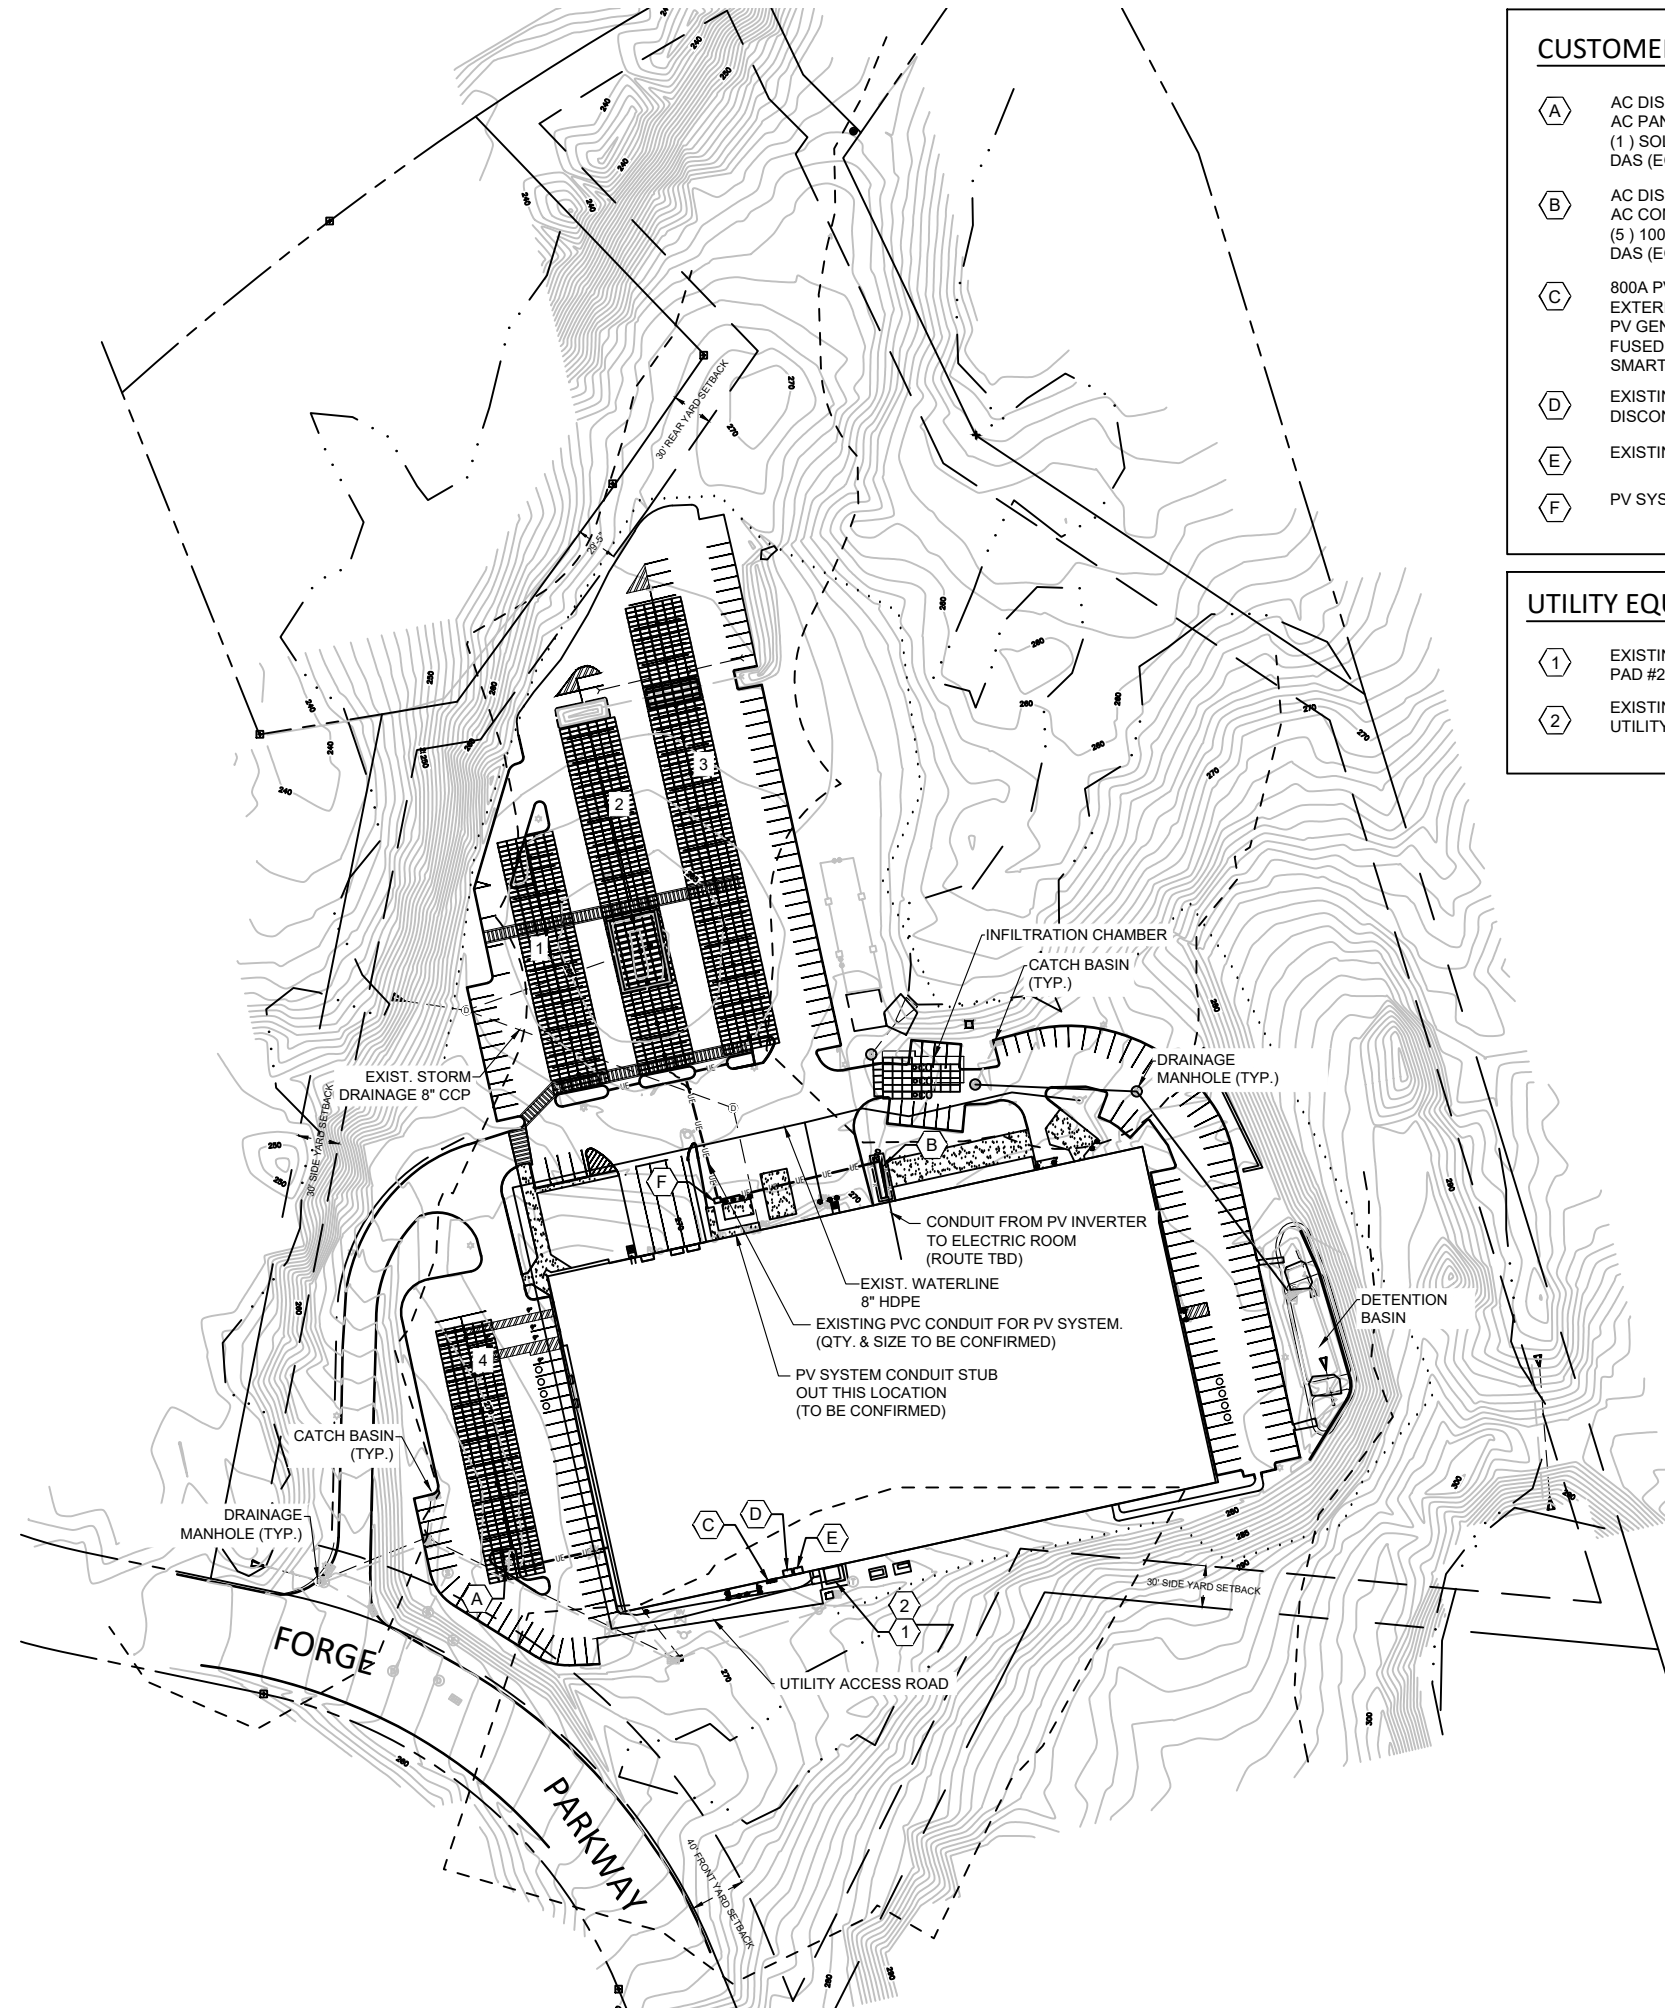

CUSTOMER EQUIPMENT KEY:

- (A) AC DISCONNECT SWITCH (PV SYSTEM)
AC PANELBOARD
(1) SOLAREEDGE INVERTER
DAS (ECONODE)
- (B) AC DISCONNECT SWITCH (PV SYSTEM)
AC COMBINER PANEL
(5) 100kW SOLAREEDGE INVERTER
DAS (ECONODE)
- (C) 800A PV AC MAIN DISCONNECT ON SOUTH
EXTERIOR OF BUILDING
PV GENERATOR DISCONNECT (UTILITY ACCESSIBLE 24/ 7)
FUSED AC COMBINER
SMART METER
- (D) EXISTING 2000A SWITCHBOARD WITH 2000A MAIN
DISCONNECT #1 FOR BUILDING SERVICE
- (E) EXISTING 800AMP ATS WITH 800A MAIN DISCONNECT #2
- (F) PV SYSTEM DISCONNECT SWITCH

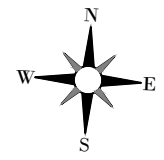
UTILITY EQUIPMENT KEY:

- (1) EXISTING TXFRMR 1000KVA, PAD MOUNTED
PAD #21-95 (PCC)
- (2) EXISTING BUILDING SERVICE UTILITY METER AND
UTILITY OWNED SERVICE

GENERAL NOTES:
 1. EXISTING ACCESS ROAD FOR UTILITY TRANSFORMER IS 13' WIDE.

LINETYPE LEGEND:

- APPROXIMATE PROPERTY LINE
- - - PROPERTY LINE SETBACK
- x-x-x- PROPOSED CHAINLINK FENCE
- OE-OE- OVERHEAD ELECTRIC
- UE-UE- UNDERGROUND ELECTRIC
- . . . - APPROXIMATE WETLAND BOUNDARY GIS
- - - - - WETLAND 100' BUFFER



ECOGY ENERGY
 315 FLATBUSH AVENUE, #393
 BROOKLYN, NY 11217
 assetmanagement@ecogyenergy.com
 (718)-304-0945

Ecogy MA VI LLC
 Project Name:
THERMO FISCHER FRANKLIN
667.2 kW-DC PV SYSTEM
 Project Site:
27 FORGE PARKWAY
FRANKLIN, MA 02038

Account No: xxxxx
 New Service Case #: xxxxx

NO.	REVISION DESCRIPTION	DATE	BY
1	RECONFIGURED ARRAY LAYOUT PER NEW LOADING DOCK	6/30/2021	SCG

Professional Stamp
PRELIMINARY


SHEET NAME:
SITE MAP

PROJECT NUMBER: ---	DRAWN BY: SCG	CHECKED BY: ---
DATE: 04/21/2021	DWG. NUMBER: ---	
SHEET NUMBER: - of -	PV-100	



ECOGY ENERGY
 315 FLATBUSH AVENUE, #393
 BROOKLYN, NY 11217
 assetmanagement@ecogyenergy.com
 (718)-304-0945

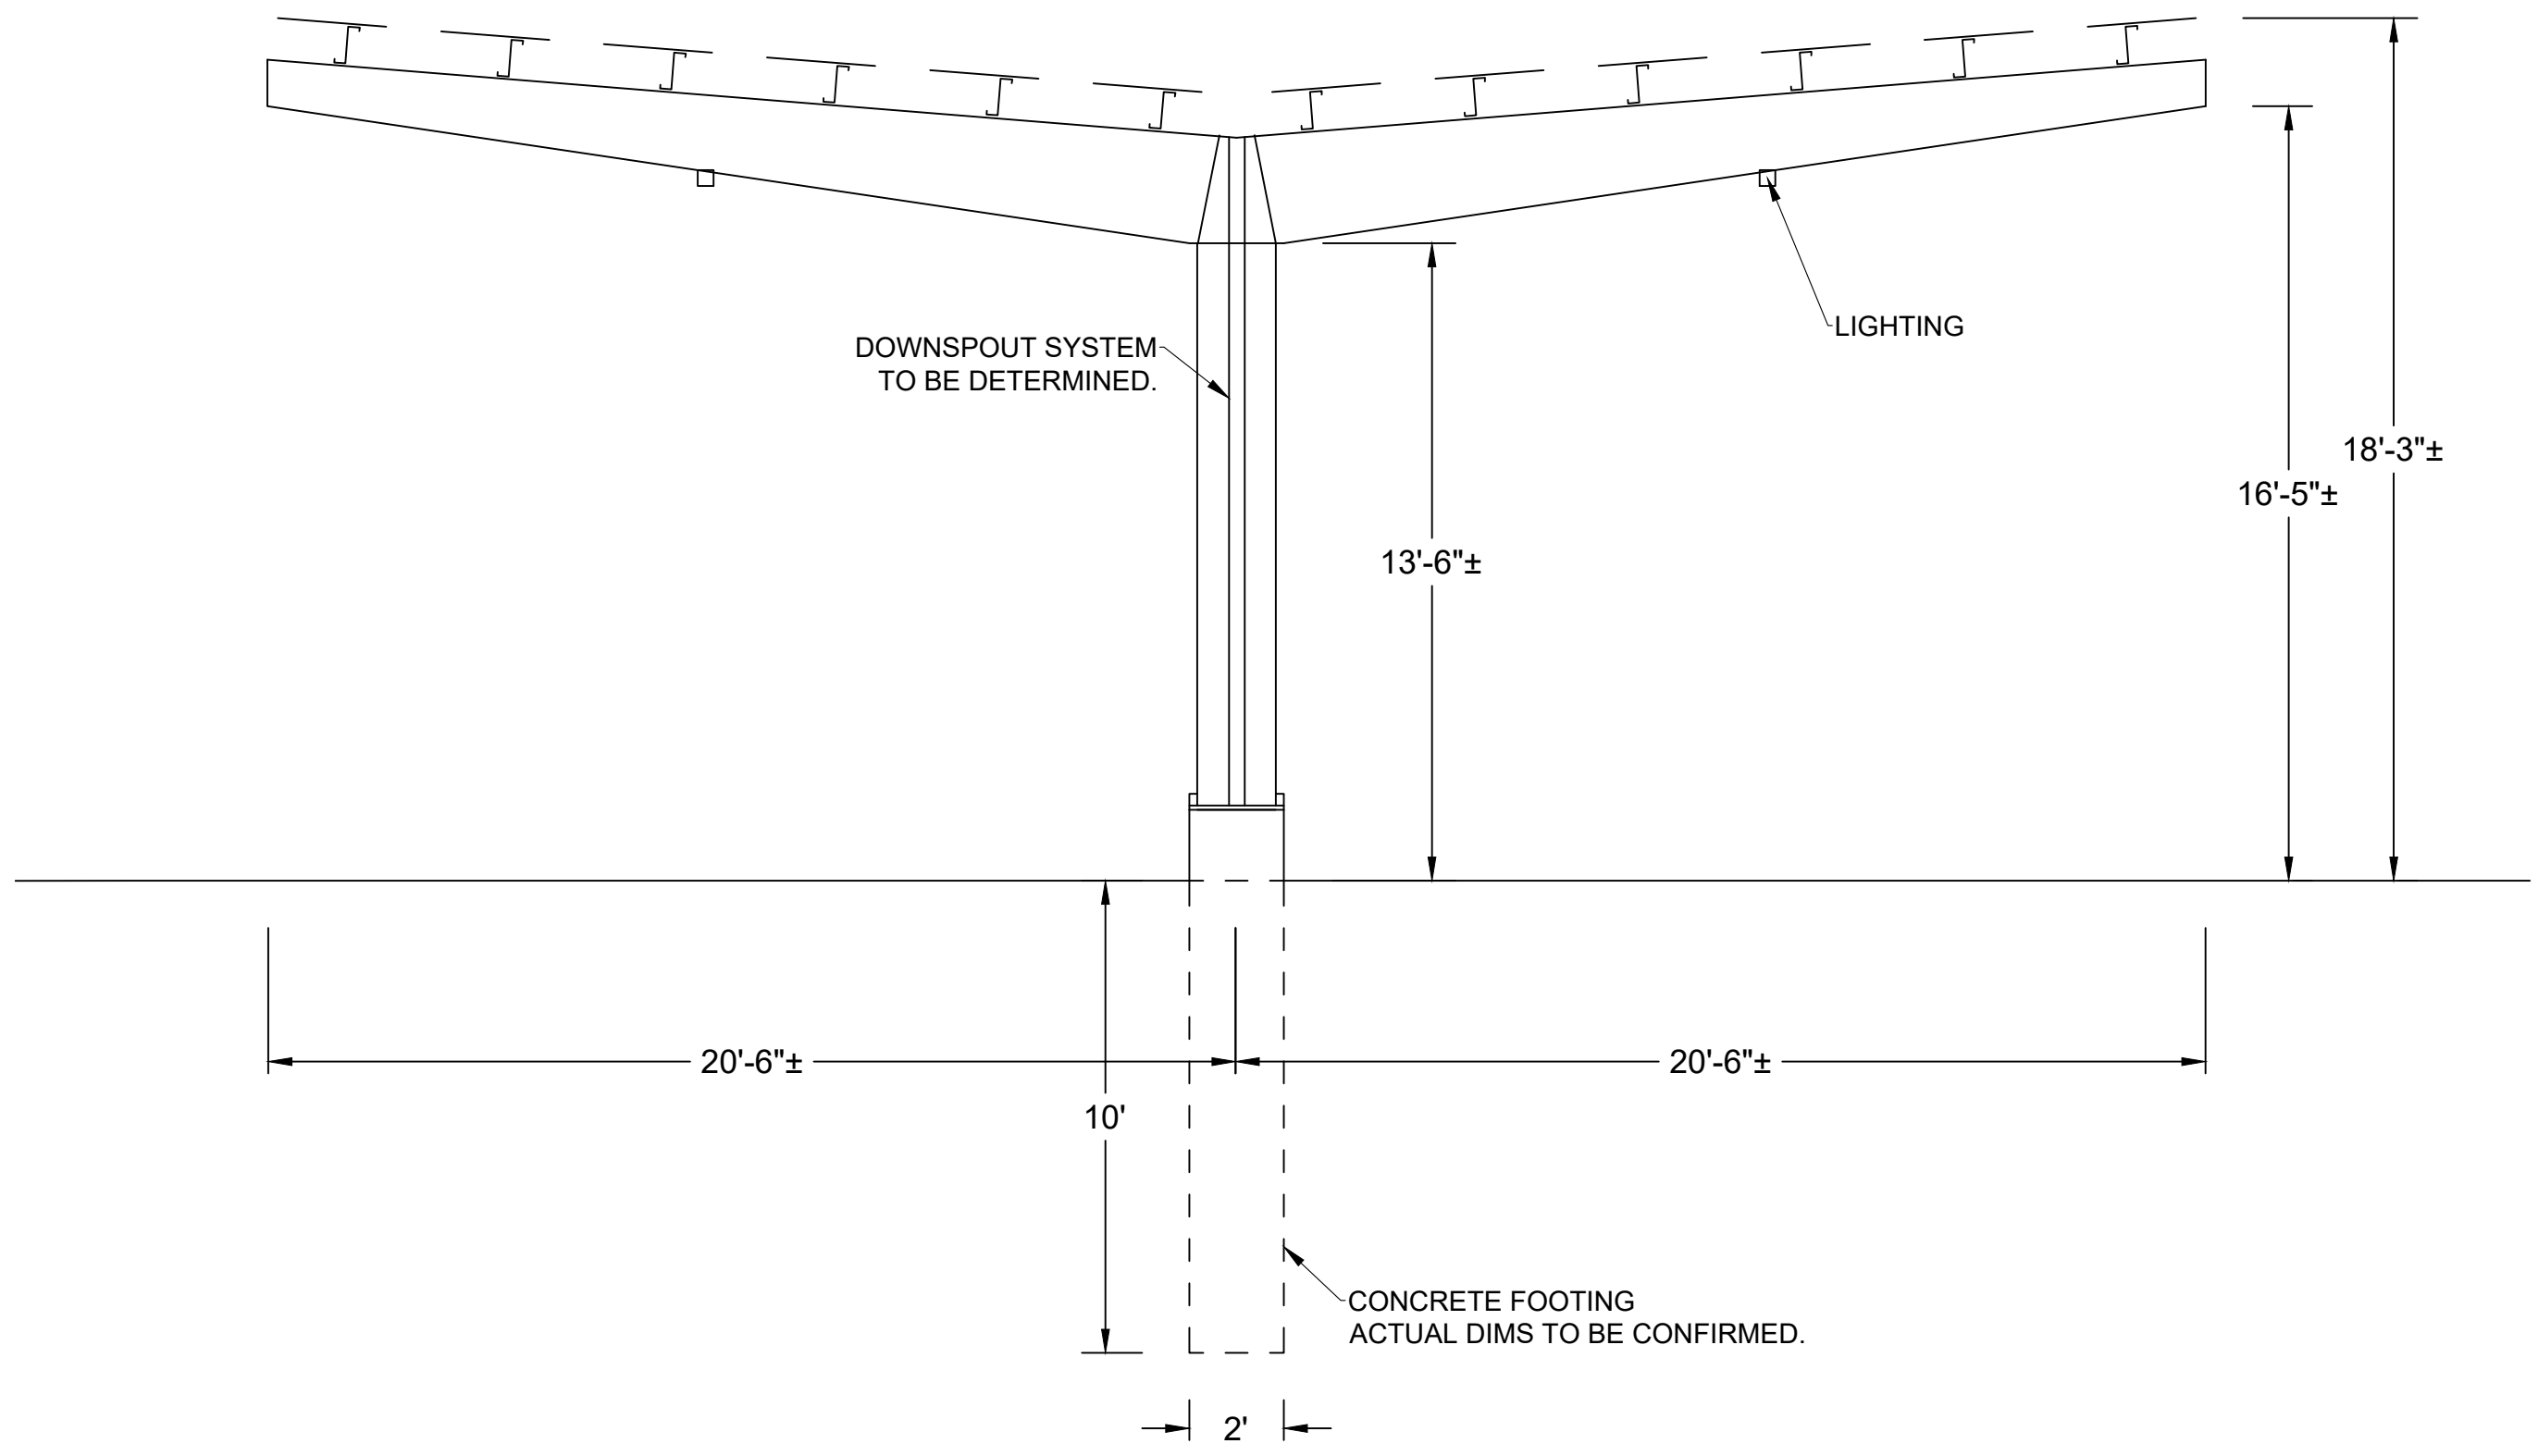Ecogy MA VI LLC
 Project Name:
**THERMO FISCHER
 FRANKLIN
 667.2 kW-DC PV SYSTEM**
 Project Site:
**27 FORGE PARKWAY
 FRANKLIN, MA 02038**
 Account No: xxxxx
 New Service Case #: xxxxx



#	REVISION DESCRIPTION	DATE	BY

Professional Stamp
PRELIMINARY

SHEET NAME:
**CANOPY
 ELEVATION**
 PROJECT NUMBER: --- DRAWN BY: SCG CHECKED BY: ---
 DATE: 04/21/2021 DWG. NUMBER:
 SHEET NUMBER: - of - **PV-200**

NOTE:
 MAX. ALLOWABLE ELEVATION 20 FEET.



TOWN OF FRANKLIN

DEPARTMENT OF PUBLIC WORKS

Franklin Municipal Building
257 Fisher Street
Franklin, MA 02038-3026

July 21, 2021

Mr. Anthony Padula, Chairman
Members of the Franklin Planning Board
355 East Central Street
Franklin, MA 02038

RE: Site Plan Modification – #27 Forge Parkway, Thermo Fisher Scientific

Dear Mr. Chairman and Members:

We have reviewed the revised materials for the subject project and offer the following comments:

1. The updated plans show 12” spacing between solar panels over the existing bioretention areas. As previously noted, we still recommend that the solar canopies be positioned so as to skip over the bioretention areas completely so that they may continue to be exposed to full sun.
2. We also note that detail for the canopy shows a downspout system that is “to be determined.” Currently, the storm water runoff from the pavement is directed to the existing bioretention areas. It is unclear how the downspout system associated with proposed solar panels will affect the current drainage.
3. The previously noted parking lot island relocations are not shown on the current plan.

Should you have any questions or require additional information, please do not hesitate to contact me.

Sincerely,

Michael Maglio, P.E.
Town Engineer



**FRANKLIN PLANNING & COMMUNITY
DEVELOPMENT**

355 EAST CENTRAL STREET, ROOM 120
FRANKLIN, MA 02038-1352
TELEPHONE: 508-520-4907

MEMORANDUM

DATE: July 20, 2021
TO: Franklin Planning Board
FROM: Department of Planning and Community Development
RE: 27 Forge Parkway
Site Plan Modification and Limited Site Plan

The DPCD has reviewed the above referenced Site Plan Modification application for the Monday, July 26, 2021 Planning Board meeting and offers the following commentary:

General:

1. The applicant has filed a Site Plan Modification to add solar canopies in the parking lot and has filed a Limited Site Plan Modification to remove a loading dock and 3 parking spaces.
2. Applicant is not required to file with the Conservation Commission.
3. DPCD has asked BETA to review the plan.
4. Mike Maglio, Town Engineer has provided a review on the Site Plan Modification.

Comments:

1. The Planning Board requested that the Site Plan and Limited Site Plan modifications be presented together.
2. The Applicant last presented at the February 22, 2021 Planning Board meeting. The Planning Board requested that Stormwater Management report be submitted. Applicant has submitted the report.
3. DPCD recommends Site Plans be reviewed and stamped by a professional engineer.
4. DPCD will refer to the Town Engineer's comments.

DPCD has no further comments.



FRANKLIN FIRE DEPARTMENT

To : DPCD

FROM : J. S. BARBIERI, DEPUTY FIRE CHIEF

DATE : 12 FEBRUARY 2021

RE : SITE PLAN MODIFICATION – 27 FORGE PARKWAY

Thank you for the opportunity to review the above referenced plan.

We have spoken with the project engineer who has assured us that the proposed structures will have adequate clearances for our vehicles. The layout provided meets our access requirements around the property.

Accordingly, we have no additional comments at this time. Please contact me should you have any questions or require any additional information.

cc: file

**Thermo Fisher Scientific, Inc.
27 Forge Parkway
Franklin, MA
Stormwater Basin Analysis**

In the 2019 stormwater design for the parking addition on the east side of the building, there was approximately 11,465 sf of existing impervious area (sub-basin EX-1) draining from their project area to the existing stormwater basin (AP-1) in the middle of the parking area. As part of the stormwater design for the parking addition and based on current survey topography; it appears that approximately 3,306 sf of that impervious area is now directed to the existing underground stormwater chamber system which discharges into the wetland to the north (AP-2), instead of the stormwater basin (AP-1) in the middle of the parking lot.

As such, there is approximately 3,306 sf of impervious area that is no longer draining to the existing stormwater basin. Accounting for this existing “credit”, as well as the existing pavement that is being removed as part of this project, the net increase of impervious cover draining to the existing stormwater basin (AP-1) is 0.012 Ac (543.2 sf). This 0.5% increase is most likely to be considered de-minimis relative to the +/-2.5 Ac of existing parking lot currently draining to it.

Pavement/concrete proposed with this project: 4,837.8 sf
Existing pavement/concrete removed from basin area (AP-1) by previous project: 3,305.6 sf
Existing pavement/concrete to be removed as part of this project: 988.9 sf
Total net increase of impervious surface draining to the existing stormwater basin: **543.2 sf**

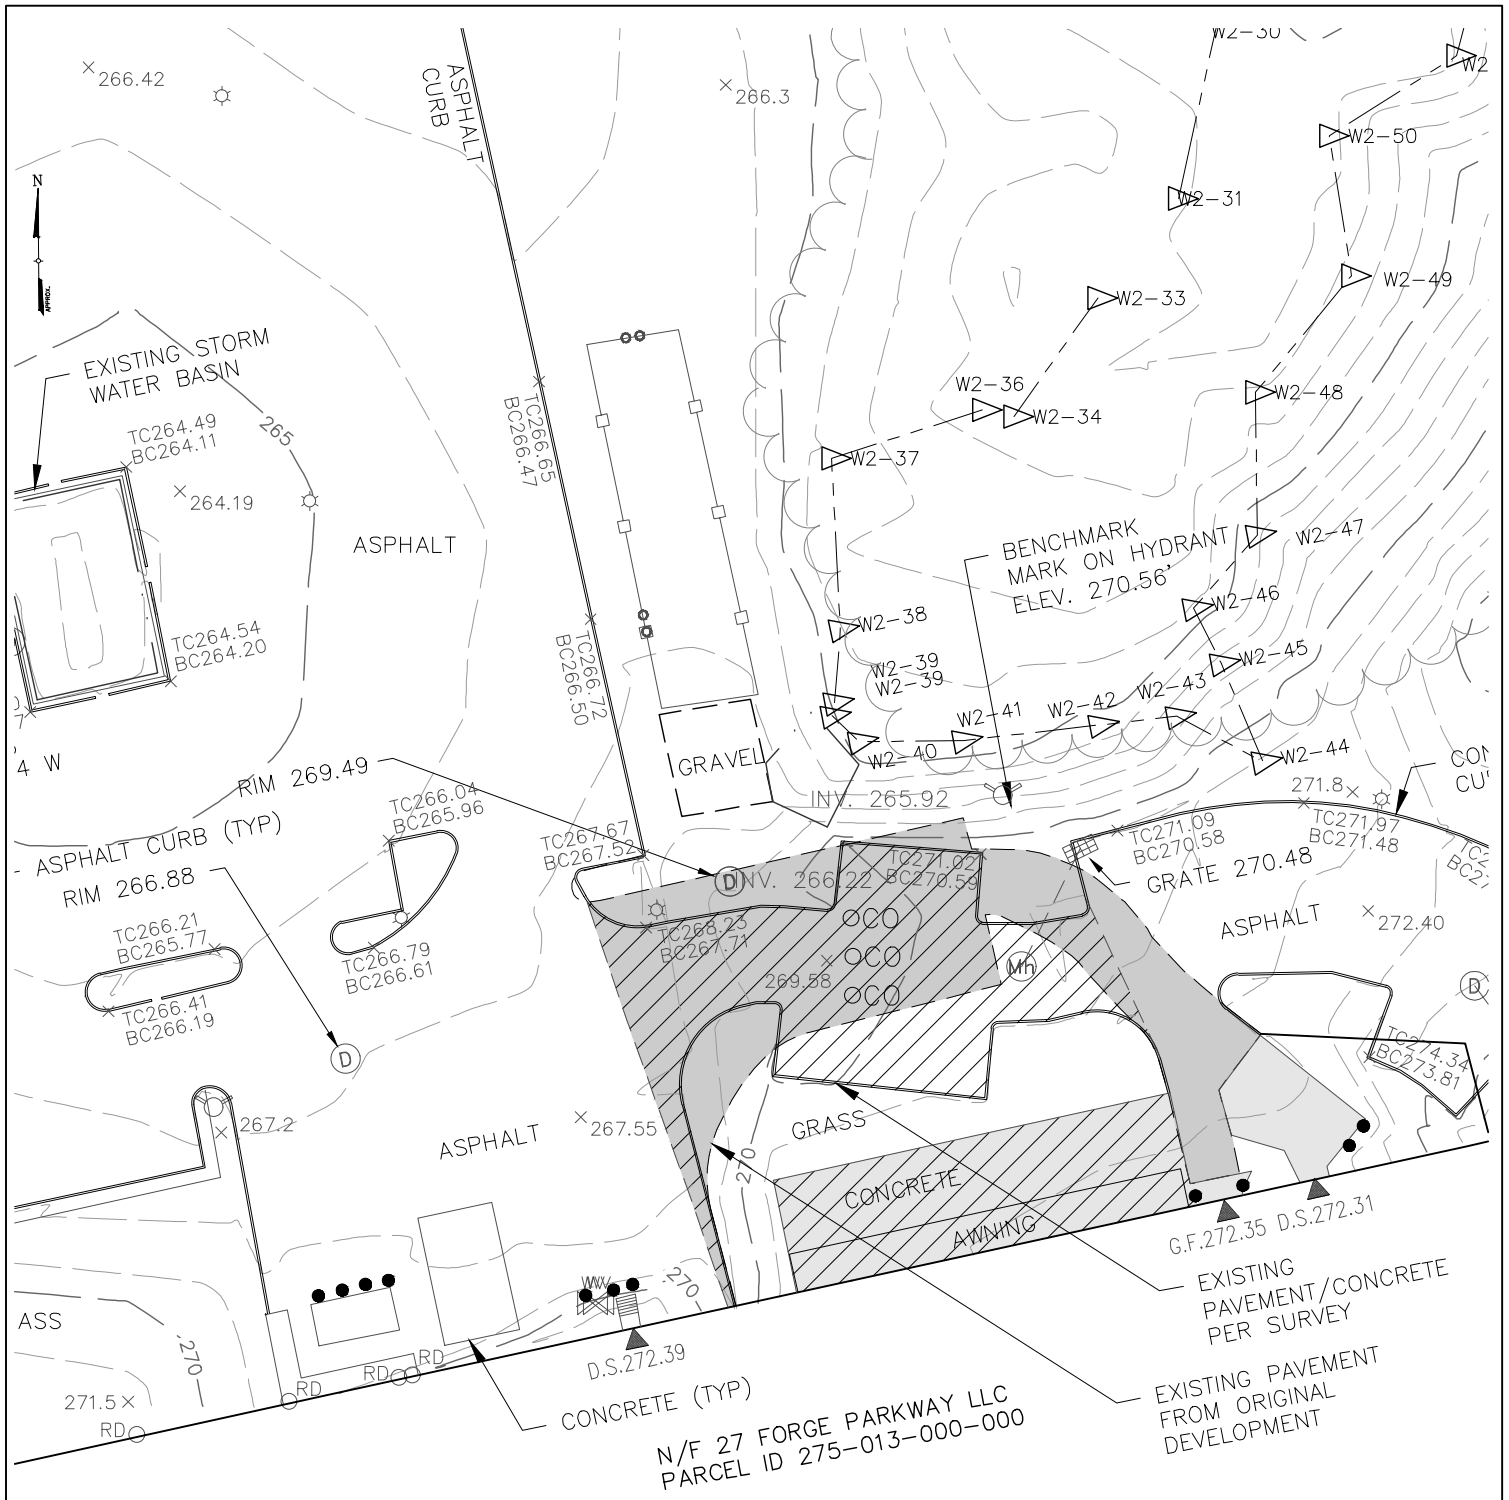
Any inquiries or questions regarding this analysis should be directed to:

J. Mark Privette
Manager of Engineering
Tectonic Engineering and Surveying Consultants

Project Contact Info

1420 Bristol Street North, Suite 210 | Newport Beach, CA 92660
949.502.8555 Tel | 949.502.8557 Fax


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1 ADD/REMOVE IMPERVIOUS AREAS
D-1 SCALE: NTS

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 Project Contact Info
 429 Lithia Pinecrest Road
 Brandon, FL 33511 Phone: (813) 374-9177

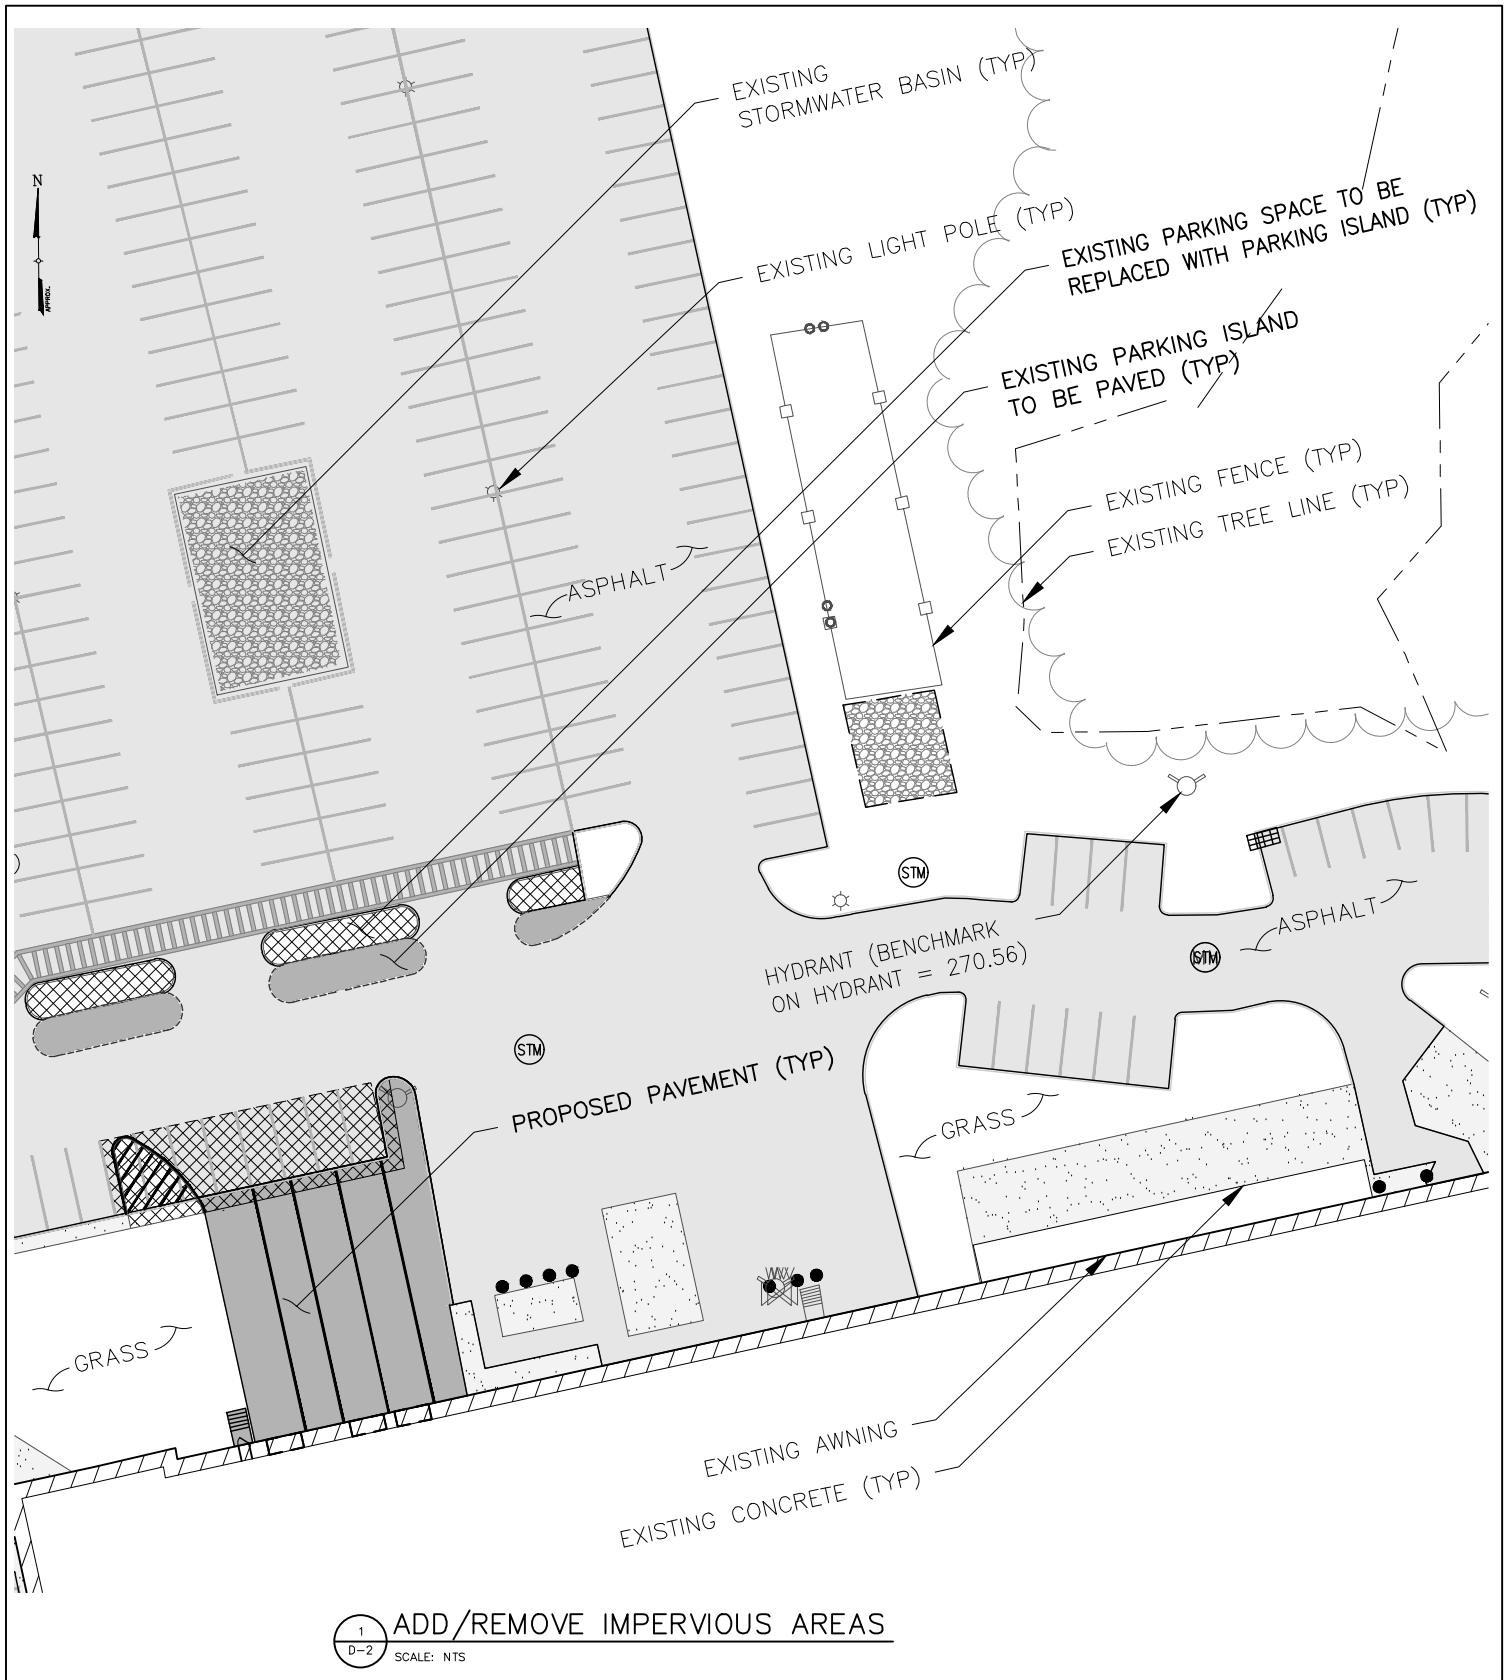THERMOFISHER
 27 FORGE PARKWAY
 TOWN OF FRANKLIN
 COUNTY OF NORFOLK, MASSACHUSETTS



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