

# THE ENGINE YARD


# SITE REDEVELOPMENT 40 ALPINE ROW FRANKLIN, MASSACHUSETTS

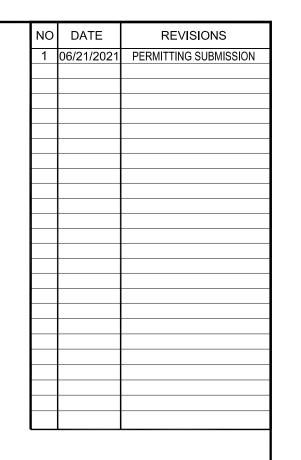

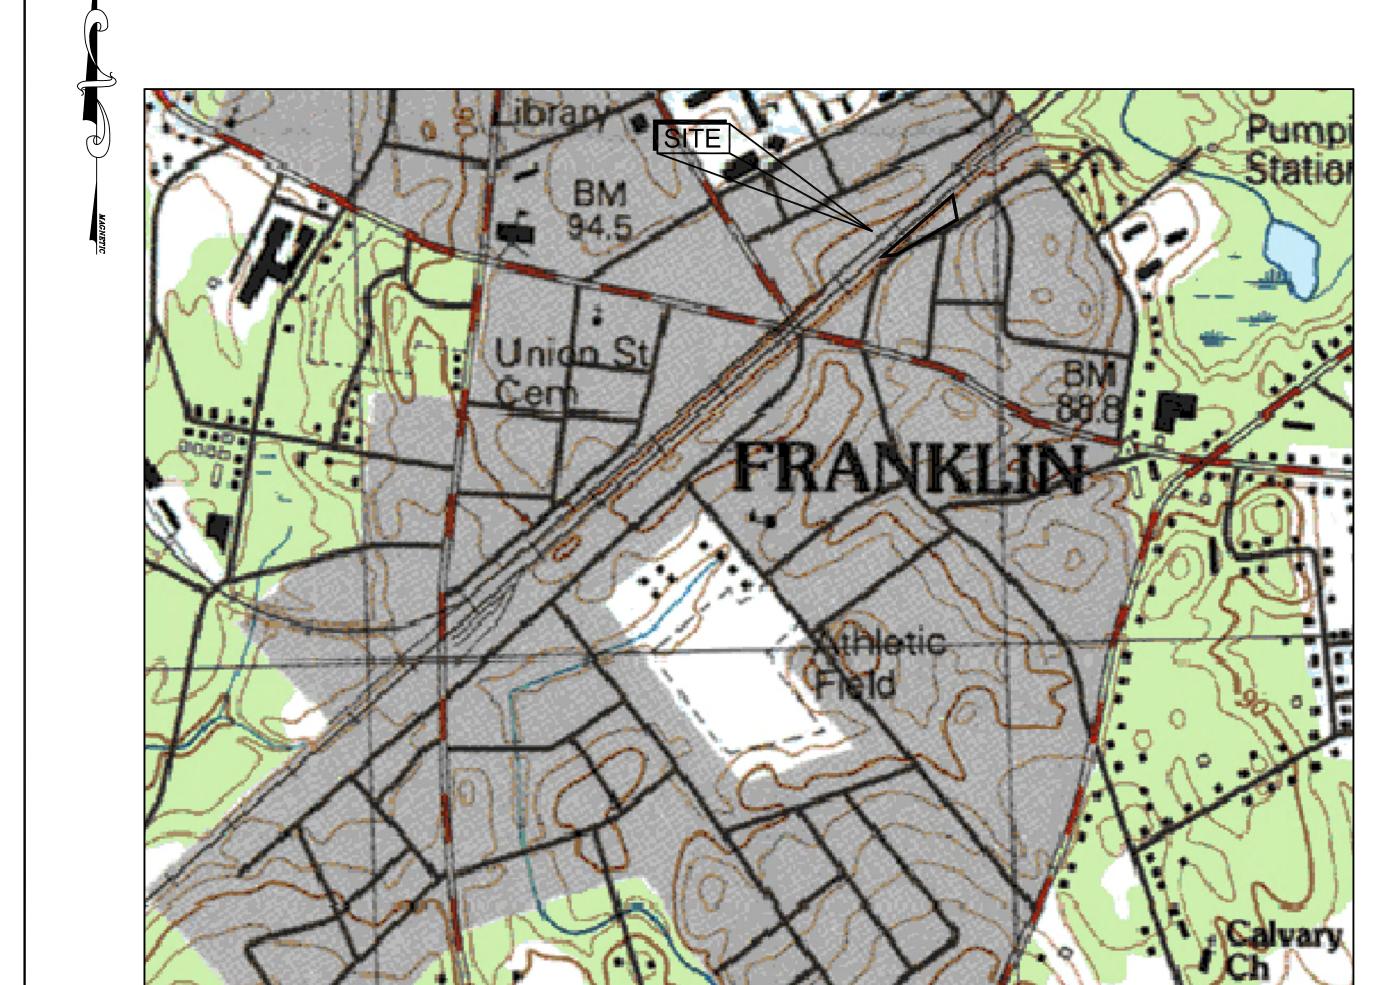

**USGS MAP** 

SCALE: 1"= 1,000'±

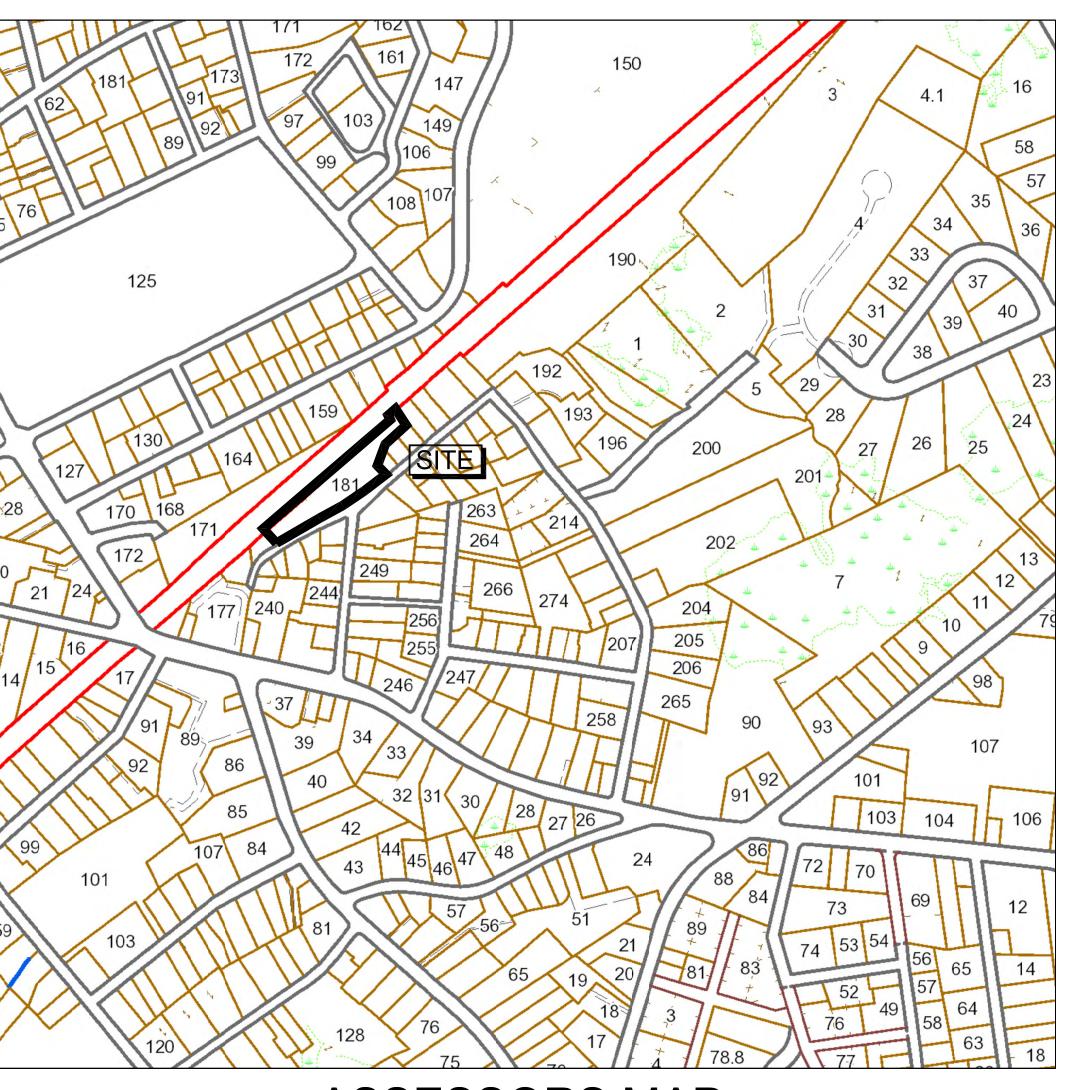

**ASSESSORS MAP** 

SCALE: 1"= 250'±

#### APPLICANT:

WALKER DEVELOPMENT & CONSTRUCTION 5 MT. ROYAL AVE MARLBOROUGH, MA 01752

## CIVIL ENGINEER:

CIVIL ENGINEERING / LAND SURVEYING 249 SOUTH STREET UNIT 1 PLAINVILLE, MA 02762 TEL. (508) 695-2221 FAX. (508) 695-2219

#### PROPERTY ADDRESS:

40 ALPINE ROW FRANKLIN, MASSACHUSETTS

ASSESSORS MAP/PARCEL:

279-181-000-000

ZONING DISTRICT:
DOWNTOWN COMMERCIAL

#### DRAWING LIST:

C-0.0 COVER


C-1.0 EXISTING CONDITIONS
C-2.0 LAYOUT AND MATERIALS
C-3.0 GRADING AND UTILITIES
C-3.1 EROSION CONTROL
C-4.0 TYPICAL DETAILS
C-4.1 TYPICAL DETAILS
LA-01-LA-04 LANDSCAPE PLANS


AL-001 PHOTOMETRIC
A031 EXISTING BUILDING ELEVATIONS


A200 EXTERNAL ELEVATIONS
A201 EXTERNAL ELEVATIONS
A202 EXTERNAL ELEVATIONS

A210 EXTERNAL SIGNAGE
A910 PROPOSED BUILDING RENDERINGS

LEGEND  EXISTING PROPOSED	
CONTOUR — 100 1. EXISTING CONDITIONS WERE OBTAINED FROM PLANS PREPARED BY GUERRIERE & HALNON,  STORM DRAIN — 100 1. EXISTING CONDITIONS WERE OBTAINED FROM PLANS PREPARED BY GUERRIERE & HALNON,  INC. FRANKLIN, MA, ENTITLED "SITE PLAN AND SPECIAL PERMIT, AS—BUILT BREWING, 40  ALPINE ROW, FRANKLIN, MASSACHUSETTS" DATED MAY 6, 2019, AS AMENDED JULY 12, 2019.	NO DATE REVISIONS  1 06/21/2021 PERMIT SUBMISSION
WATER WATER ALPINE ROW, FRANKLIN, MASSACHUSETIS DATED MAY 6, 2019, AS AMENDED JULY 12, 2019.	
SYSTEM IN ALPINE PRIOR TO CROSSING THE PROPERTY. THE EXISTING CB'S WE UTILIZED AS	
A "KNOWN" FOR PURPOSES OF THIS INVESTIGATION.  S — SANITARY SEWER ————— 2. THE LOCATION OF EXISTING UTILITIES IS APPROXIMATE, THE CONTRACTOR SHALL VERIFY THE	
HYDRANT NOTIFY  "DIG-SAFE" AT 1-888-344-7233 AT LEAST 72 HOURS PRIOR TO ANY SITE DEMOLITION OR  SEWER MANHOLE START OF CONSTRUCTION. NOTIFY  EXCAVATION.	
© DRAIN MANHOLE   ✓ VALVE   ✓ VALVE	
CURB	
429x5 SPOT GRADE 429.5	
SEDIMENTATION x X CONTROL BARRIER	SEAL 6/21/202)
□ LIGHT POLE     □ TREE     □ UTILITY POLE	DANIEL R. CAMPBELL CIVIL
POST INDICATOR VALVE PRV  TRAFFIC DIRECTION	No. 46245
TRAFFIC BIRCOTION ————————————————————————————————————	TONAL EN CO
	DATE : JUNE 21, 2021  DRAWN : DRC  SCALE : 1" = 20'
RAIL ROAD BASELINE	
<u> </u>	
MASSACHUSETTS BAY TRANSPORTATION	
AN PLBK.252 PL.804A,B  Qu. Pole  Qu. Pole	
X X X X X X X X X X X X X X X X X X X	
(set)	ting Containment Walls
1st Floor=305.47  AREA= 6,061± SF.  Existing   Containment   Walls   St.   St.	S S S S S S S S S S S S S S S S S S S
CONVERTED COMMERCIAL USE  1st Floor=304.94    304.7   303.1	
302.41 APEA-57.500+CE	
No. 40  No. 40	
O. Wells 303.99  Solution	
## 306.20  1" PEX WATER LINE  1" PEX WATER LINE  1" PEX WATER LINE  1" PEX WATER LINE  296.18  296.18  296.18  296.18	
ONE W. 302.99	
ALPINIC -	PERTIES LLC FRANKLIN PROPERTIES LL PROPERTIES LL
INH H DINH 80 COT. 298 HALLICAN PROV	
LINH H. DINH & TOP OF Wall=302.08  305.6  TOP OF Wall=302.08  305.6  TOP OF Wall=302.08  305.6  TOP OF Wall=302.08  307.63  SOLUTION TOP OF Wall=302.08  307.63  SOLUTION TOP OF Wall=302.08  307.63  SOLUTION TOP OF Wall=302.08	
T LE HANH  No.35  N/F  ALPINE ROW, LLC  SO2.30  ALPINE ROW, LLC  SO2.30  SO3.63  SO3.6	No.68
T LE HANH  No.35  N/F  ALPINE ROW, LLC  SO2.79  No.64	
T LE HANH  No.35  LE HANH  No.35  ALPINE ROW, LLC  TO SOLUTION  SO	COMME PARCE 40 ALPI FRANK
T LE HANH  No.35  N/F  ALPINE ROW, LLC  N/F  GERALD F. NEWELL  SOLUTION  SOL	PARC FRAN
No.35 No.41  No.35 No.41  No.35 No.64  No.41  No.64  No.65  No.64  No.66  No.64  No.64  No.64  No.64  No.66  No.64  No.66  No.66	LEVEL SIGN GROUP CIVIL ENGINEERING / LAND SURVEYING
No. 35  No. 35  No. 35  No. 36  No. 36  No. 36  No. 36  No. 37  No. 30  No. 36  No. 37  No. 38  No. 30  No. 30	LEVEL SIGN GROUP CIVIL ENGINEERING / LAND SURVEYING
T LE HANH  No.35  NF  ALPINE ROW, LLC  NO.41  NO.40  NO.40	DESIGN GROUP CIVIL ENGINEERING / LAND SURVEYING 249 SOUTH STREET UNIT 1 PLAINVILLE, MA 02762 TEL. (508) 695-2221 FAX. (508) 695-2219
ALPINE PLACE  No.40  SEE HANH  NO.40  NO.40  SEE HANH  NO	LEVEL SIGN GROUP CIVIL ENGINEERING / LAND SURVEYING
NO. 40  NO. 67  NO. 67  NO. 67  NO. 67  NO. 67	LEVEL  DESIGN GROUP  CIVIL ENGINEERING / LAND SURVEYING  249 SOUTH STREET  UNIT 1  PLAINVILLE, MA 02762  TEL. (508) 695-2221 FAX. (508) 695-2219  EXISTING  CONDITIONS
NO.35  ALFORE ROW, LLC  NO.41  GERALD F. NEWELL  STEPHAN M. ACCAD  NO.67  NO.66	EXISTING CONDITIONS  EXISTING CONDITIONS
NE ALPINE ROW, LLC  NO. 40  CERALD F. NEWELL  SOCIETY OF THE PLACE  NO. 40  STEPHAN M. ACCAD  NO. 67  NO. 67	LEVEL  DESIGN GROUP  CIVIL ENGINEERING / LAND SURVEYING  249 SOUTH STREET  UNIT 1  PLAINVILLE, MA 02762  TEL. (508) 695-2221 FAX. (508) 695-2219  EXISTING  CONDITIONS
NATE OF THE PLACE  NO.41  STEPHAN M. ACCAD  NO.62  NO.63  NO.64  NO.65  NO.66	EVEL  Design group CIVIL ENGINEERING / LAND SURVEYING 249 SOUTH STREET UNIT 1 PLAINVILLE, MA 02762 TEL. (508) 695-2221 FAX. (508) 695-2219  EXISTING CONDITIONS  TO SHEET 2 OF 7

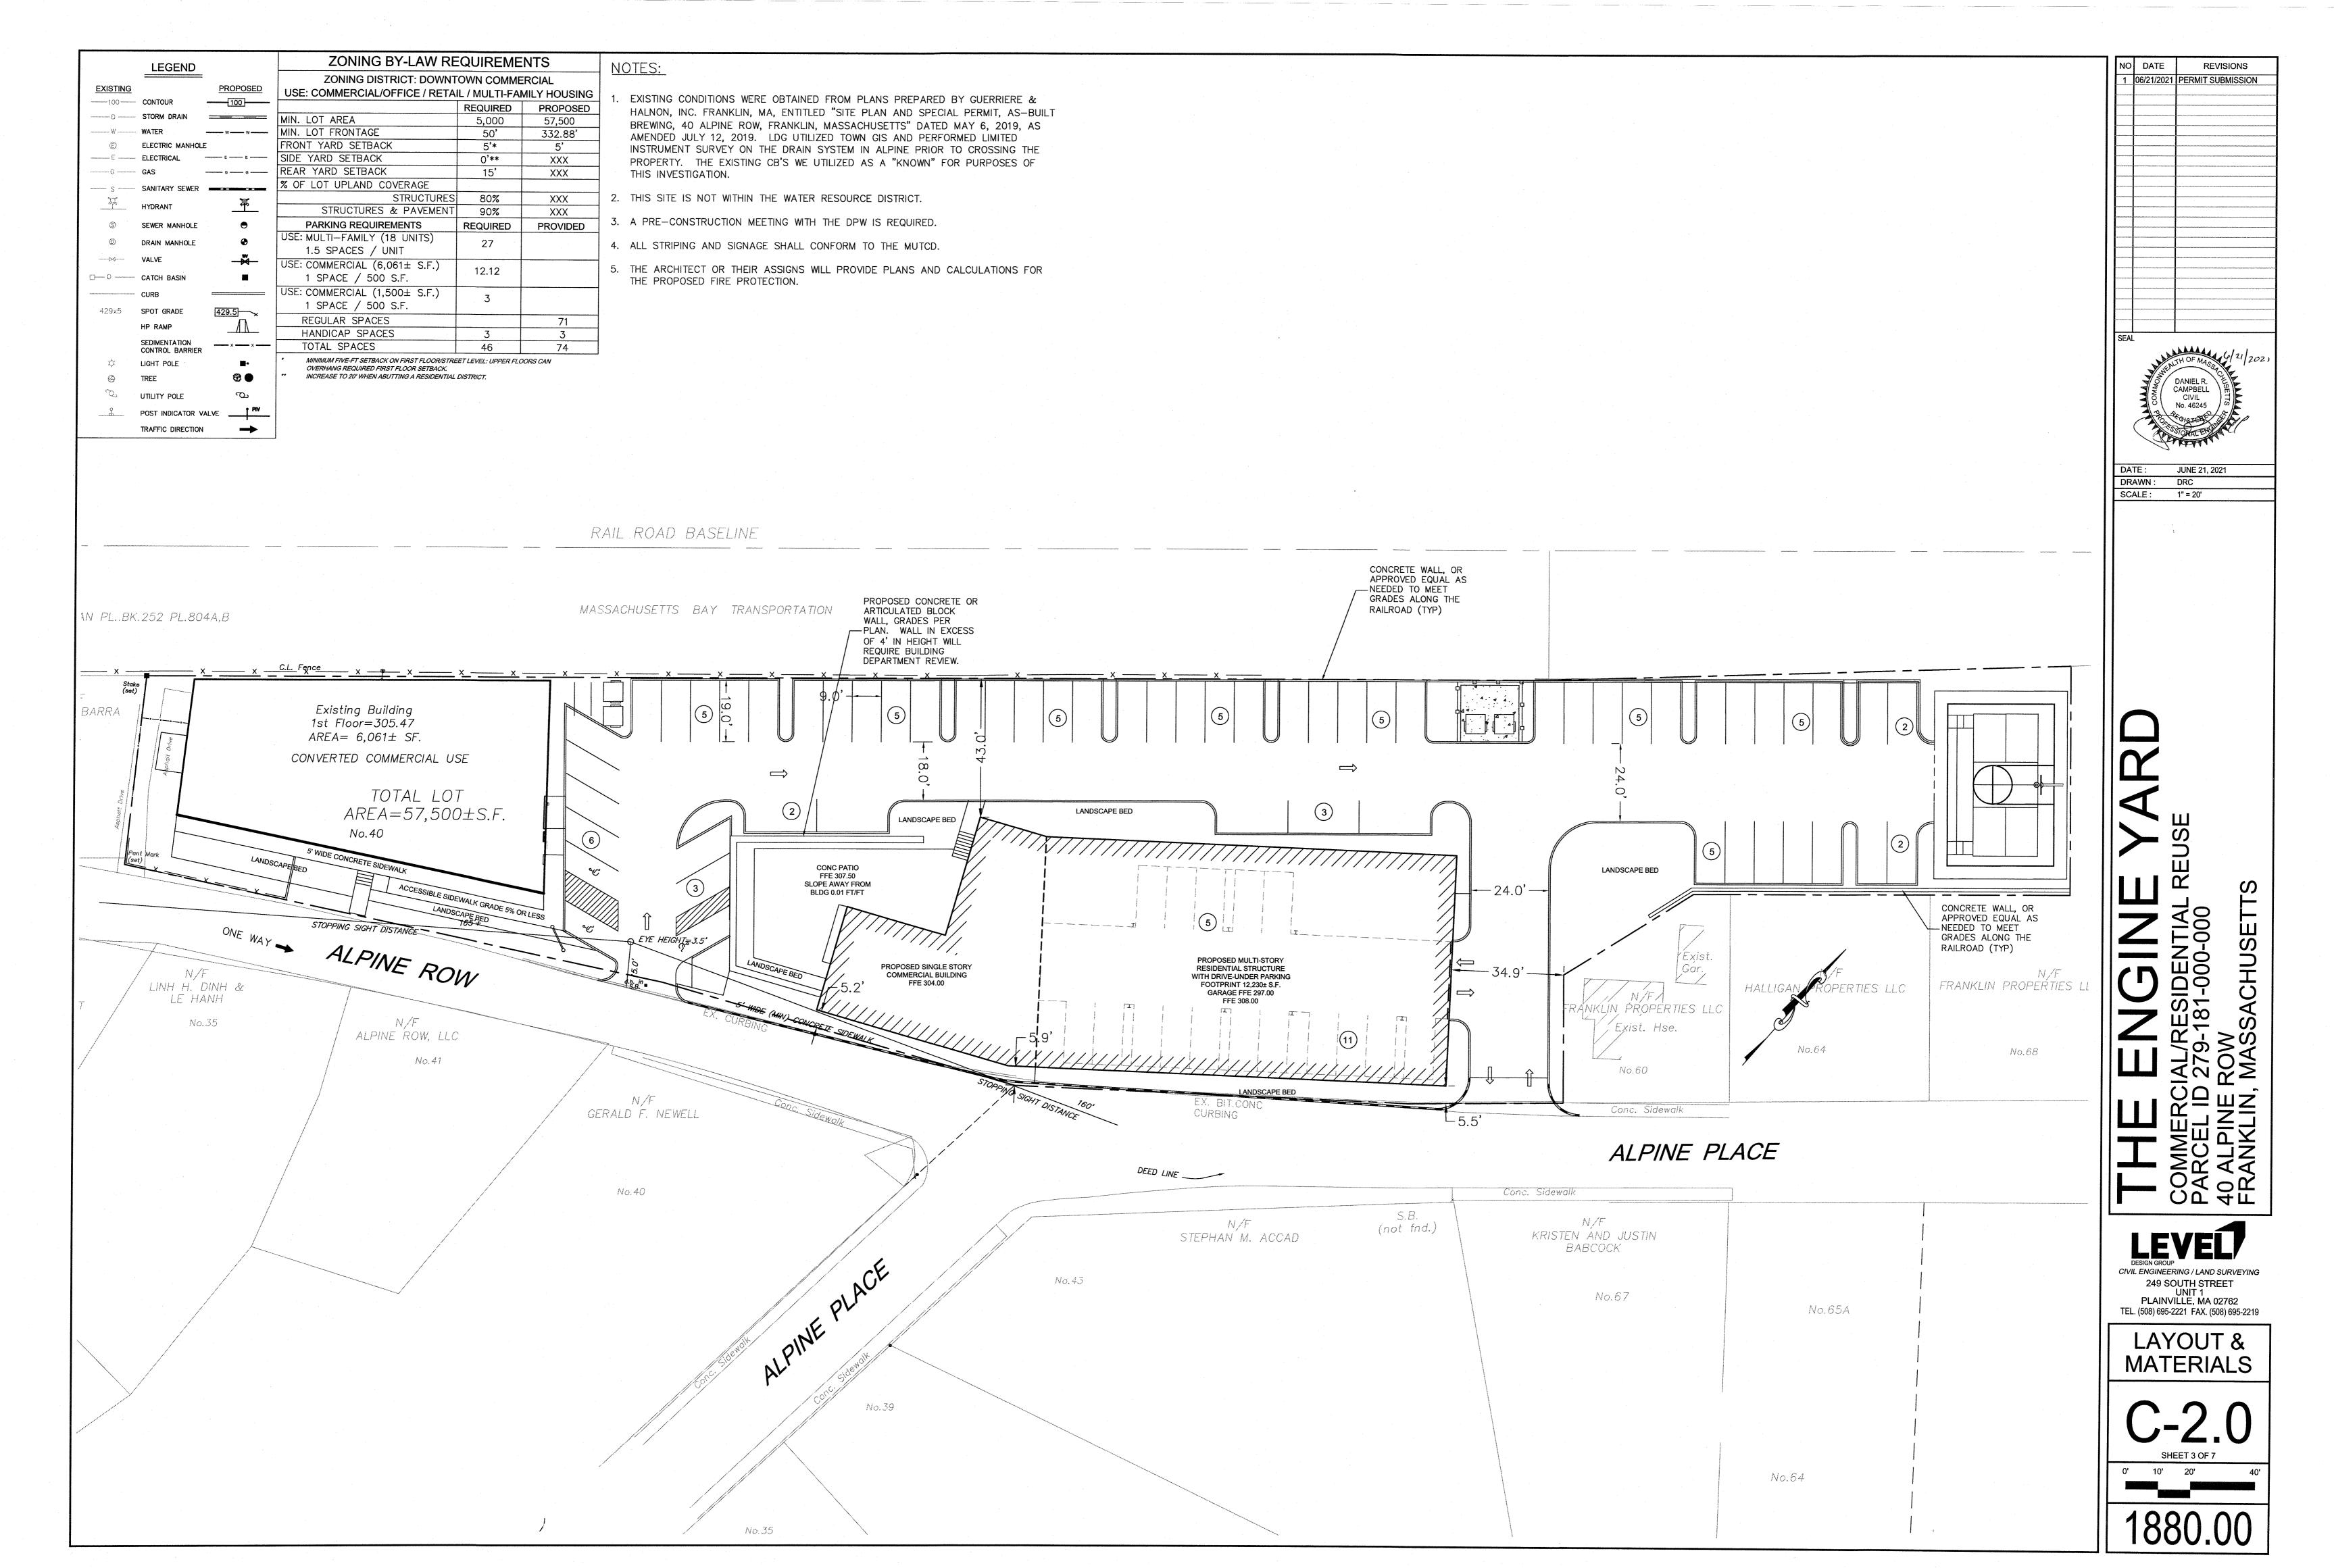

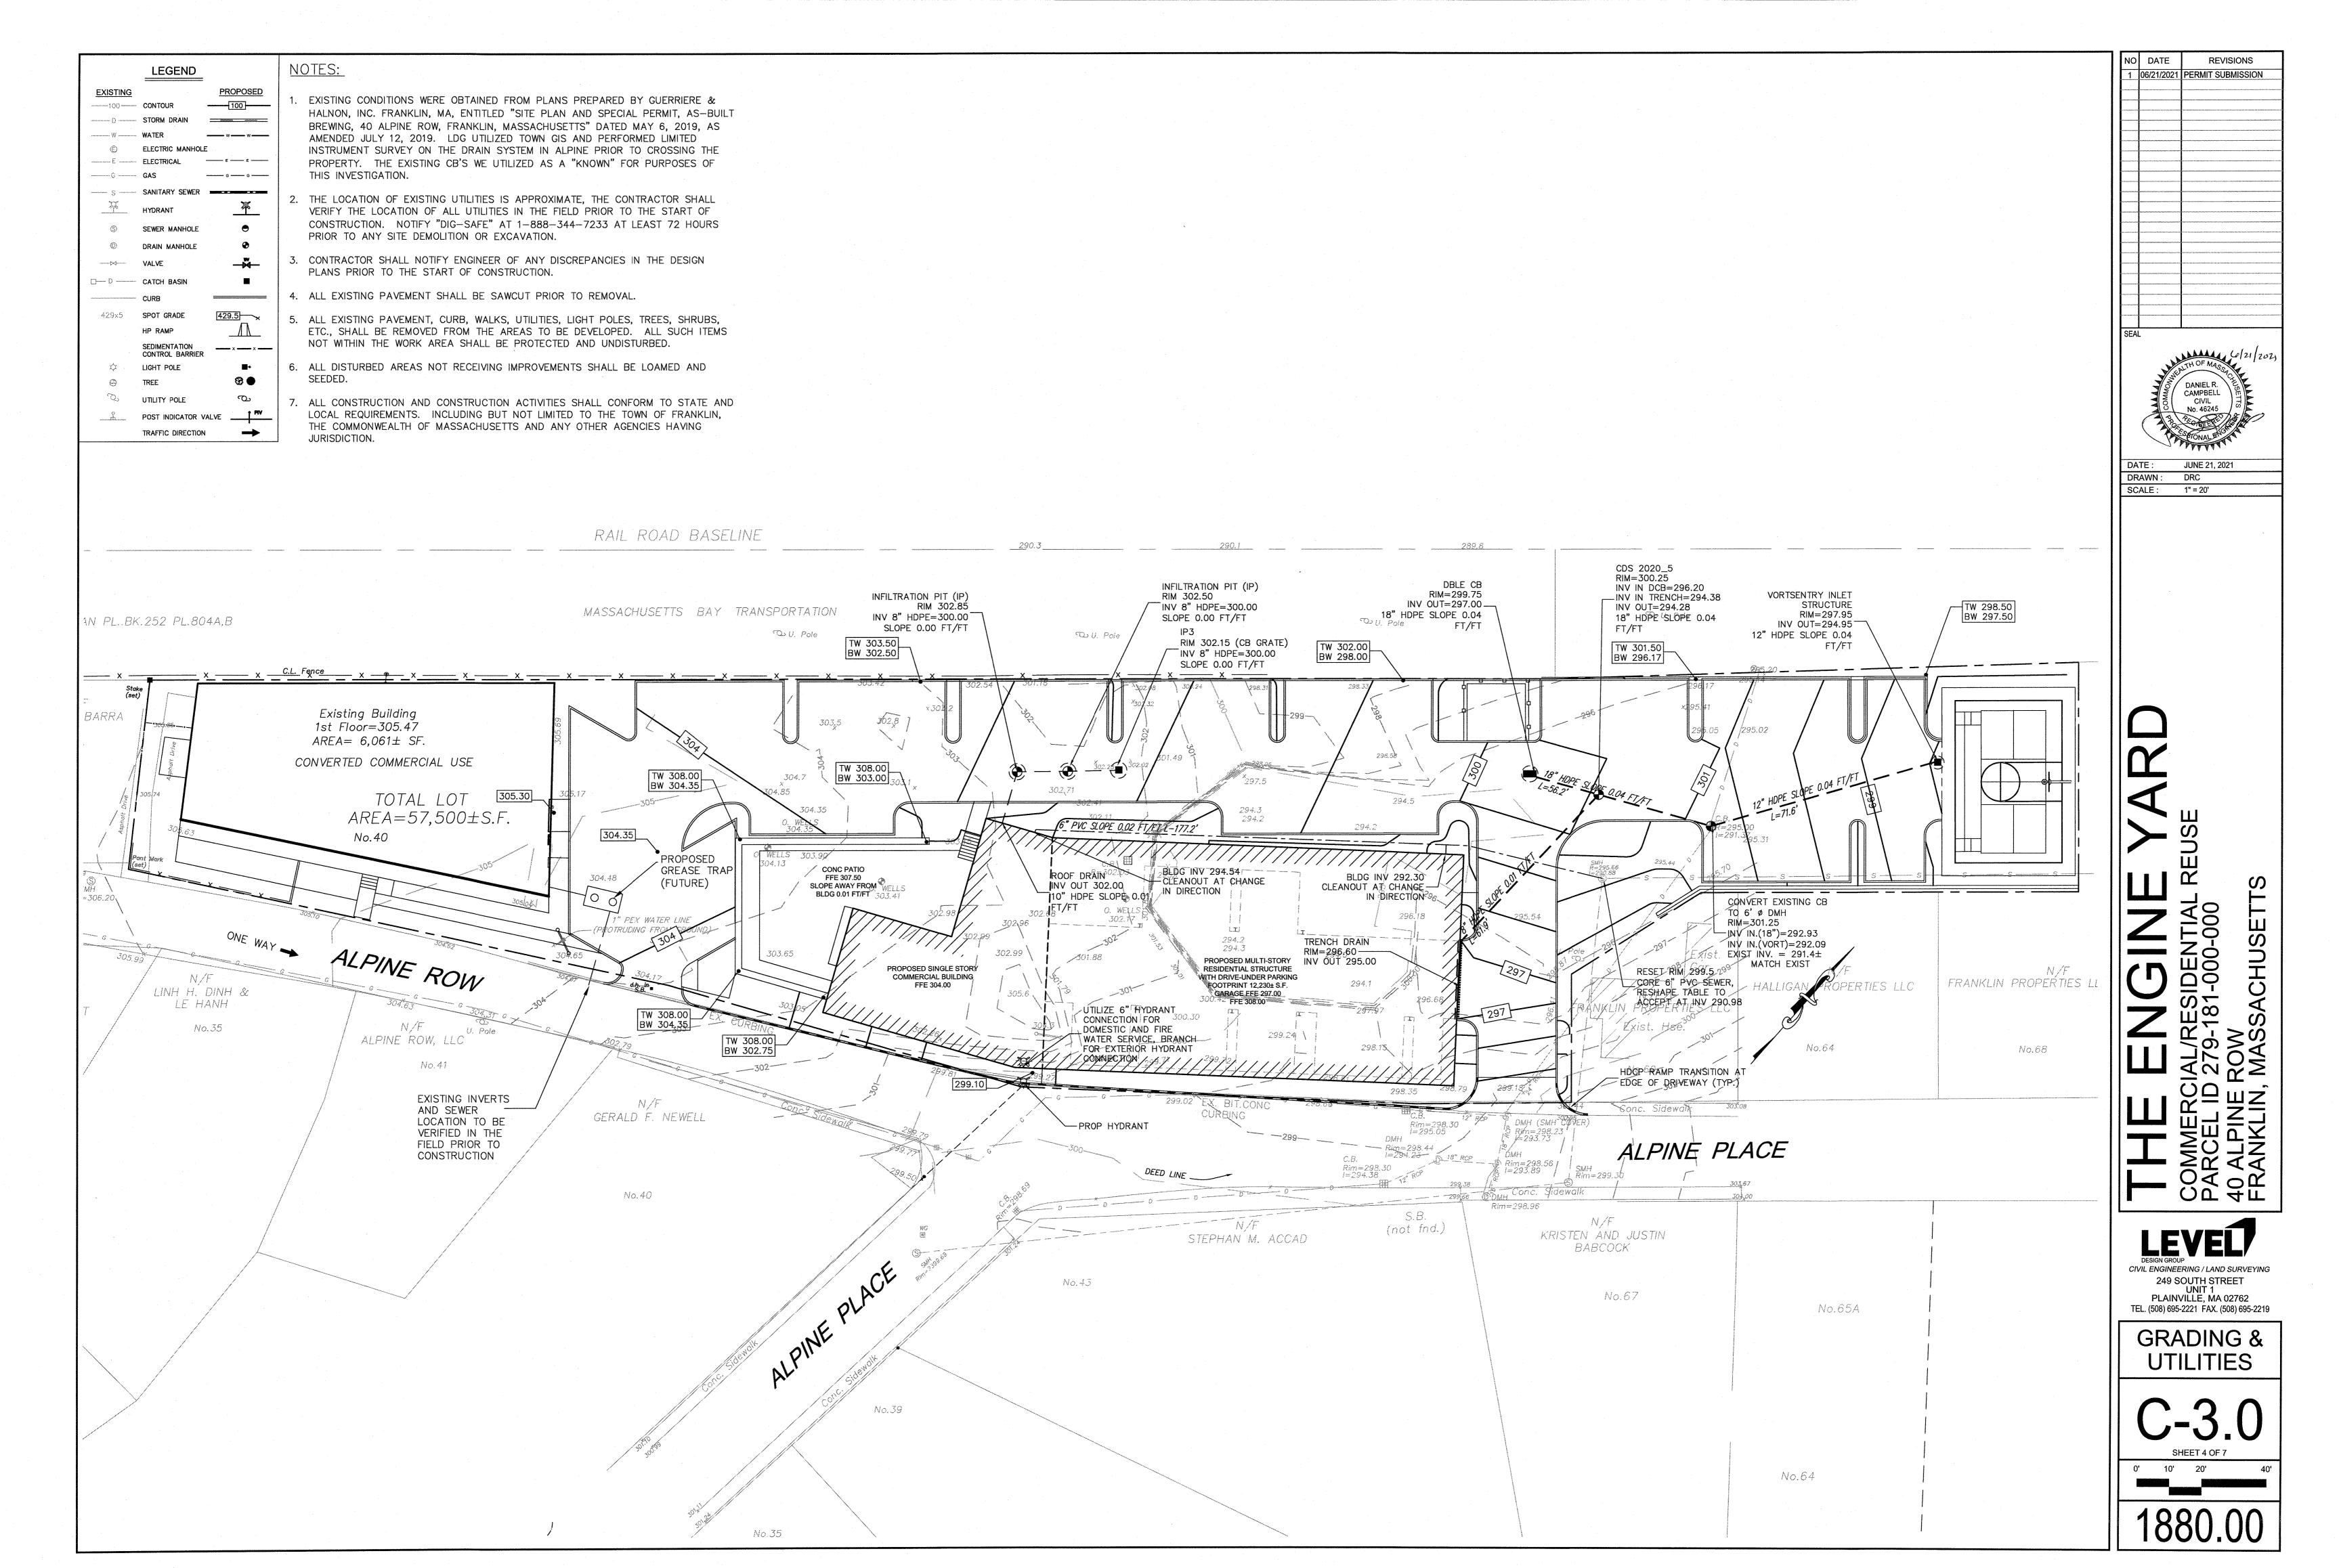

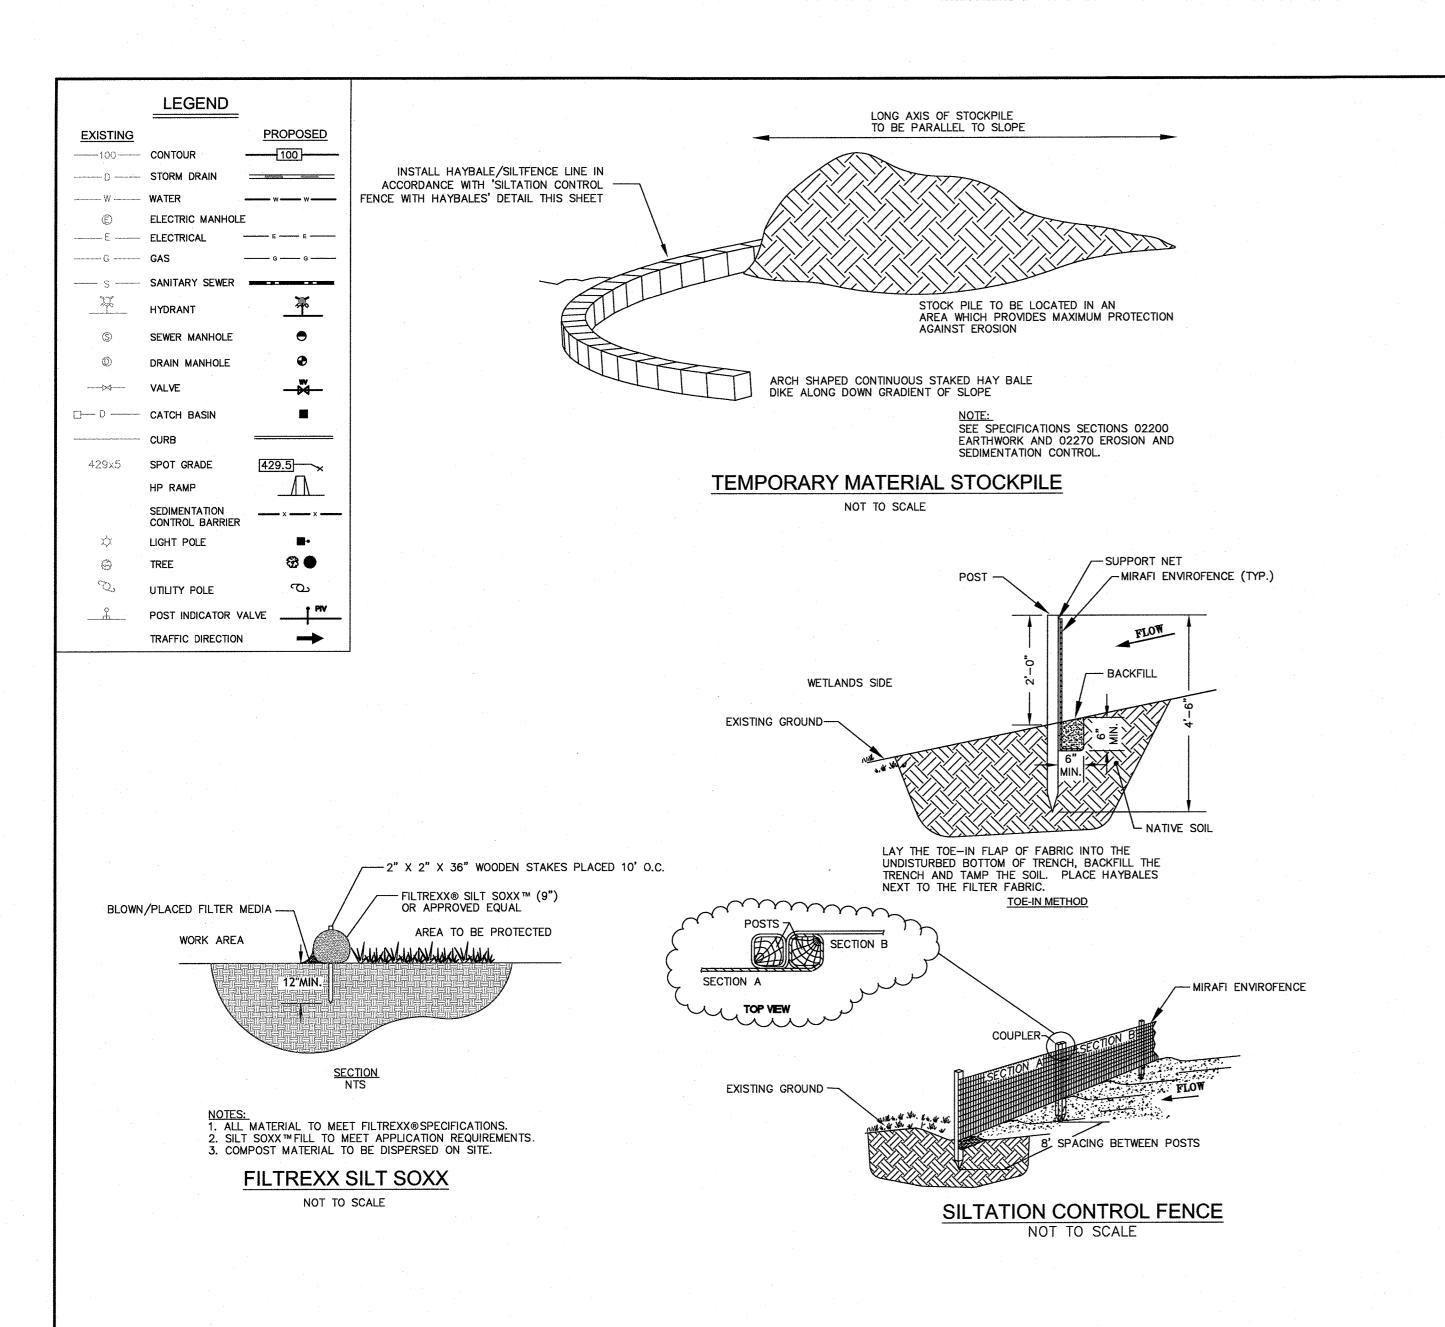


RAIL ROAD BASELINE

GENERAL NOTES:

- REFER TO SHEET C-1.0 FOR EXISTING CONDITIONS AND PROPERTY BOUNDARY NOTES.
- REFER TO SHEET C-2.0 FOR CONSTRUCTION SEQUENCE AND NOTES.

2 % OR GREATER

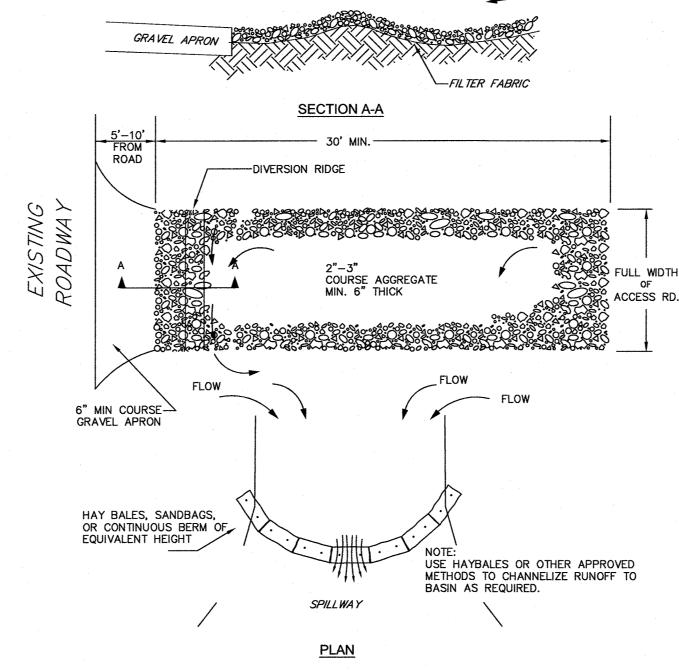

DIVERSION RIDGE REQUIRED

WHERE GRADE EXCEEDS 2%

NOTES:

1. THE ENTRANCE SHALL BE MAINTAINED IN A CONDITIONS THAT WILL PREVENT TRACKING OR FLOWING OF SEDIMENT ONTO PUBLIC RIGHT—OF—WAYS. THIS MAY REQUIRE TOP DRESSING, REPAIR AND/OR CLEANOUT OF ANY MEASURES USED TO TRAP SEDIMENT.

2. WHEN NECESSARY, WHEELS SHALL BE CLEANED PRIOR TO ENTRANCE ONTO PUBLIC RIGHT-OF-WAY.

3. WHEN WASHING IS REQUIRED IT SHALL BE DONE ON AN AREA STABILIZED WITH CRUSHED STONE WHICH DRAINS TO AN APPROVED SEDIMENT TRAP OR

TEMPORARY CONSTRUCTION
ENTRANCE/EXIT DETAIL
NOT TO SCALE

SILTFENCE ALONG RAILROAD 9" COMPOST SOCK MASSACHUSETTS BAY TRANSPORTATION N PL..BK.252 PL.804A,B TW 302.00 BW 298.00 TW 301.50 BW 296.17 Existing Building 1st Floor=305.47 BARRA AREA = 6,061 ± SF. CONVERTED COMMERCIAL USE TW 308.00 BW 304.35 TOTAL LOT 305.30  $AREA = 57,500 \pm S.F.$ ALPINE ROW FRANKLIN PROPERTIES LLC OPERTIES LLC N/F No.35 ALPINE ROW, LLC No.68 GERALD F. NEWELL SILT SACK (TYP.) ALPINE PLACE (not fnd.) KRISTEN AND JUSTIN STEPHAN M. ACCAD BABCOCK No.65A

#### **EROSION CONTROL NOTES**

SILTATION CONTROL USING EROSION CONTROL FENCE WITH STRAW WATTLE, OR APPROVED EQUEROSION CONTROL LINE IS TO BE VISUALLY INSPECTED AFTER EVERY RAIN FALL AND REPAIRS MAD AS REQUIRED TO THE SILTATION CONTROL FENCE AND STRAW WATTLE AFTER EACH RAIN FALL. CLEANOUT OF ACCUMULATED SEDIMENT BEHIND THE WATTLE IS NECESSARY IF ½ OF THE ORIGINAL HEIGHT OF THE WATTLE APPEARS TO HAVE BEEN INUNDATED WITH SEDIMENT.

#### PRESERVE TOPSOIL

SITE OWNERS AND OPERATORS MUST PRESERVE EXISTING TOPSOIL ON THE CONSTRUCTION SITE TO MAXIMUM EXTENT FEASIBLE AND AS NECESSARY TO SUPPORT HEALTHY VEGETATION, PROMOTE SOIL STABILIZATION, AND INCREASE STORMWATER INFILTRATION RATES IN THE POST—CONSTRUCTION PHAS OF THE PROJECT.

#### STABILIZATION OF SOILS

UPON COMPLETION AND ACCEPTANCE OF SITE PREPARATION AND INITIAL INSTALLATION OF EROSION, RUNOFF, AND SEDIMENT CONTROLS AND TEMPORARY POLLUTION PREVENTION MEASURES, THE OPERATOR SHALL INITIATE APPROPRIATE TEMPORARY OR PERMANENT STABILIZATION PRACTICES DURING ALL PHASES OF CONSTRUCTION ON ALL DISTURBED AREAS AS SOON AS POSSIBLE, BUT NO MORE THAN FOURTEEN (14) DAYS AFTER THE CONSTRUCTION ACTIVITY IN THAT AREA HAS TEMPORARILY OR PERMANENTLY CEASED. SLOPES IN EXCESS OF 3:1 SHALL HAVE 22 MONTH EROSIC CONTROL FABRIC INSTALLED OVER A SLOPE MIX SEED MIX WITH TACKIFIER UNLESS OTHERWISE SPECIFIED.

ANY DISTURBED AREAS THAT WILL NOT HAVE ACTIVE CONSTRUCTION ACTIVITY OCCURRING WITHIN 14 DAYS MUST BE STABILIZED USING THE CONTROL MEASURES DEPICTED IN SITE PLANS, IN ACCORDANCE WITH THE STORMWATER POLLUTION PREVENTION PLAN, AND PER MANUFACTURER PRODUCT SPECIFICATIONS.

ONLY AREAS THAT CAN BE REASONABLY EXPECTED TO HAVE ACTIVE CONSTRUCTION WORK BEING PERFORMED WITHIN 14 DAYS OF DISTURBANCE WILL BE CLEARED/GRUBBED AT ANY ONE TIME. IT IS NOT ACCEPTABLE TO CLEAR AND GRUB THE ENTIRE CONSTRUCTION SITE IF PORTIONS WILL NOT BE ACTIVE WITHIN THE 14-DAY TIME FRAME. PROPER PHASING OF CLEARING AND GRUBBING ACTIVITIES SHALL INCLUDE TEMPORARY STABILIZATION TECHNIQUES FOR AREAS CLEARED AND GRUBBED THAT WILL NOT BE ACTIVE WITHIN THE 14-DAY TIME FRAME.

#### STORMWATER INLET PROTECTION

INLET PROTECTION — WILL BE UTILIZED TO PREVENT SOIL AND DEBRIS FROM ENTERING STORM DRAIN INLETS AND SHALL BE INSTALLED WITHIN BASINS DOWNSTREAM OF DISTURBANCE WITHIN 200' OF THE PROPOSED DISTURBANCE. THESE MEASURES ARE USUALLY TEMPORARY AND ARE IMPLEMENTED BEFORE A SITE IS DISTURBED.

MAINTENANCE — THE OPERATOR MUST CLEAN, OR REMOVE AND REPLACE THE INLET PROTECTION MEASURES AS SEDIMENT ACCUMULATES, THE FILTER BECOMES CLOGGED, AND/OR AS PERFORMANCE IS COMPROMISED. ACCUMULATED SEDIMENT ADJACENT TO THE INLET PROTECTION MEASURES SHOULD BE REMOVED BY THE END OF THE SAME WORK DAY IN WHICH IT IS FOUND OR BY THE END OF THE FOLLOWING WORK DAY IF REMOVAL BY THE SAME WORK DAY IS NOT FEASIBLE.

STORMWATER BASINS — ALL AREAS CONTAINING STORMWATER BASINS (ABOVE OR BELOW GROUND) SHALL BE PROTECTED THROUGHOUT CONSTRUCTION. THESE ARES ARE NOT BE USED FOR MATERIAL STOCKPILES OR FOR PARKING EQUIPMENT. SURFACE BASINS ARE TO BE ROUGH GRADED AND PROTECTED UNTIL STABILIZED AND BROUGHT ON—LINE FOR STORMWATER MANAGEMENT OF THE STABILIZED SITE.

#### ONSTRUCTION ENTRANCES

CONSTRUCTION ENTRANCES SHALL BE USED IN CONJUNCTION WITH THE STABILIZATION OF CONSTRUCTION ROADS TO REDUCE THE AMOUNT OF SEDIMENT TRACKING OFF THE PROJECT. ANY CONSTRUCTION SITE ACCESS POINT MUST EMPLOY THE CONTROL MEASURES ON THE APPROVED SITE PLANS AND IN ACCORDANCE WITH THE STORMWATER POLLUTION PREVENTION PLAN. CONSTRUCTION ENTRANCES SHALL BE USED IN CONJUNCTION WITH THE STABILIZATION OF CONSTRUCTION ROADS TO REDUCE THE AMOUNT OF MUD PICKED UP BY CONSTRUCTION VEHICLES. ALL CONSTRUCTION ACCESS ROADS SHALL BE CONSTRUCTED PRIOR TO ANY ROADWAY ACCEPTING CONSTRUCTION TRAFFIC.

THE SITE OWNER AND OPERATOR MUST WILL RESTRICT VEHICLE USE TO PROPERLY DESIGNATED EXIT POINTS, USE PROPERLY DESIGNED AND CONSTRUCTED CONSTRUCTION ENTRANCES AT ALL POINTS THAT EXIT ONTO PAVED ROADS SO THAT SEDIMENT REMOVAL OCCURS PRIOR TO VEHICLE EXIT. WHEN AND WHERE NECESSARY, USE ADDITIONAL CONTROLS TO REMOVE SEDIMENT FROM VEHICLE TIRES PRIOR TO EXIT (I.E. WHEEL WASHING RACKS, RUMBLE STRIPS, AND RATTLE PLATES). WHERE SEDIMENT HAS BEEN TRACKED OUT FROM THE CONSTRUCTION SITE ONTO THE SURFACE OF OFF—SITE STREETS, OTHER PAVED AREAS, AND SIDEWALKS, THE DEPOSITED SEDIMENT MUST BE REMOVED BY THE END OF THE SAME WORK DAY IN WHICH THE TRACK OUT OCCURS. TRACK—OUT MUST BE REMOVED BY SWEEPING, SHOVELING, OR VACUUMING THESE SURFACES, OR BY USING OTHER SIMILARLY EFFECTIVE MEANS OF SEDIMENT REMOVAL.

#### STOCKPILE CONTAINMENT

SHALL BE USED ONSITE TO MINIMIZE OR ELIMINATE THE DISCHARGE OF SOIL, TOPSOIL, BASE MATERIAL OR RUBBLE, FROM ENTERING DRAINAGE SYSTEMS OR SURFACE WATERS. ALL STOCKPILES MUST BE LOCATED WITHIN THE LIMIT OF DISTURBANCE, PROTECTED FROM RUN—ON WITH THE USE OF TEMPORARY SEDIMENT BARRIERS AND PROVIDED WITH COVER OR STABILIZATION TO AVOID CONTACT WITH PRECIPITATION AND WIND WHERE AND WHEN PRACTICAL. STOCK PILE MANAGEMENT CONSISTS OF PROCEDURES AND PRACTICES DESIGNED TO MINIMIZE OR ELIMINATE THE DISCHARGE OF STOCKPILED MATERIAL (SOIL, TOPSOIL, BASE MATERIAL, RUBBLE) FROM ENTERING DRAINAGE SYSTEMS OR SURFACE WATERS.


FOR ANY STOCKPILES OR LAND CLEARING DEBRIS COMPOSED, IN WHOLE OR IN PART, OF SEDIMENT OR SOIL, YOU MUST COMPLY WITH THE FOLLOWING REQUIREMENTS — LOCATE PILES WITHIN THE DESIGNATED LIMITS OF DISTURBANCE OUTSIDE OF THE 100—FOOT BUFFER ZONE, PROTECT FROM CONTACT WITH STORMWATER (INCLUDING RUN—ON) USING A TEMPORARY PERIMETER SEDIMENT BARRIER; WHERE PRACTICABLE, PROVIDE COVER OR APPROPRIATE TEMPORARY VEGETATIVE OR STRUCTURAL STABILIZATION TO AVOID DIRECT CONTACT WITH PRECIPITATION OR TO MINIMIZE SEDIMENT DISCHARGE; NEVER HOSE DOWN OR SWEEP SOIL OR SEDIMENT ACCUMULATED ON PAVEMENT OR OTHER IMPERVIOUS SURFACES INTO ANY STORMWATER CONVEYANCE, STORM DRAIN INLET, OR SURFACE WATER; TO THE MAXIMUM EXTENT PRACTICABLE, CONTAIN AND SECURELY PROTECT FROM WIND.

#### TEMPORARY SEDIMENT BASINS

IF REQUIRED, ADDITIONAL TEMPORARY SEDIMENT BASINS SHALL BE CONSTRUCTED TO MITIGATE THE POTENTIAL SEDIMENT LOADING TO THE ADJACENT RESOURCE AREAS. TEMPORARY SEDIMENT BASINS ARE TO BE LOCATED OUTSIDE OF THE 50—FOOT BUFFER ZONE TO THE BORDERING VEGETATED WETLANDS AND SHALL NOT BE LOCATED IN AN AREA WHERE AN INFILTRATION BASIN IS PROPOSED. TEMPORARY SEDIMENT BASIN GRADING LOCATION SHALL BE DICTATED BY THE DESIGN ENGINEER. AT A MINIMUM THE THE VOLUME OF THE TEMPORARY SEDIMENT BASIN, AS MEASURED FROM THE BOTTOM OF THE BASE TO THE ELEVATION OF THE CREST OF THE PRINCIPAL SPILLWAY SHALL BE AT LEAST 3,600 CUBIC FEET PER ACRE OF DRAINAGE AREA. THIS 3,600 CUBIC FEET IS EQUIVALENT TO 1.0 INCH OF SEDIMENT PER ACRE OF DRAINAGE AREA. ADDITIONAL STORAGE IN THE FORM OF A PERMANENT WET POOL SHALL BE PROVIDED WHENEVER PRACTICABLE, BUT MAY NOT BE USED TO FULFILL THE TEMPORARY STORAGE VOLUME REQUIREMENT.

SEDIMENT BASINS SHALL BE CLEANED OUT WHEN THE VOLUME REMAINING AS DESCRIBED ABOVE IS REDUCED BY SEDIMENTATION TO 1,800 CUBIC FEET PER ACRE OF DRAINAGE AREA (50 PERCENT FULL). IN NO CASE SHALL THE SEDIMENT LEVEL BE PERMITTED TO BUILD UP HIGHER THAN ONE FOOT BELOW THE PRINCIPAL SPILLWAY CREST. AT THIS ELEVATION, CLEANOUT SHALL BE PERFORMED TO RESTORE THE ORIGINAL DESIGN VOLUME TO THE SEDIMENT BASIN. THE ELEVATION OF THE MAXIMUM ALLOWABLE SEDIMENT LEVEL SHALL BE DETERMINED AND SHALL BE STATED IN THE DESIGN DATA AS A DISTANCE BELOW THE TOP OF THE RISER AND BE CLEARLY MARKED ON THE RISER. NO AREA OF DETENTION SHALL BE UTILIZED FOR TEMPORARY EROSION CONTROL OR DEWATERING ACTIVITIES.

	NO	DATE	REVISIONS
UAL	1	06/21/2021	PERMIT SUBMISSION
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DATE: JUNE 21, 2021

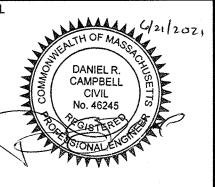DRAWN: DRC

SCALE: 1" = 20'

# E ENGINE YAR ERCIAL/RESIDENTIAL REUSE L ID 279-181-000-000

LEVEL DESIGN GROUP

CIVIL ENGINEERING / LAND SURVEYING 249 SOUTH STREET


PLAINVILLE, MA 02762
TEL. (508) 695-2221 FAX. (508) 695-2219

EROSION
CONTROL

C-3.1

SHEET 5 OF 7

1000 000

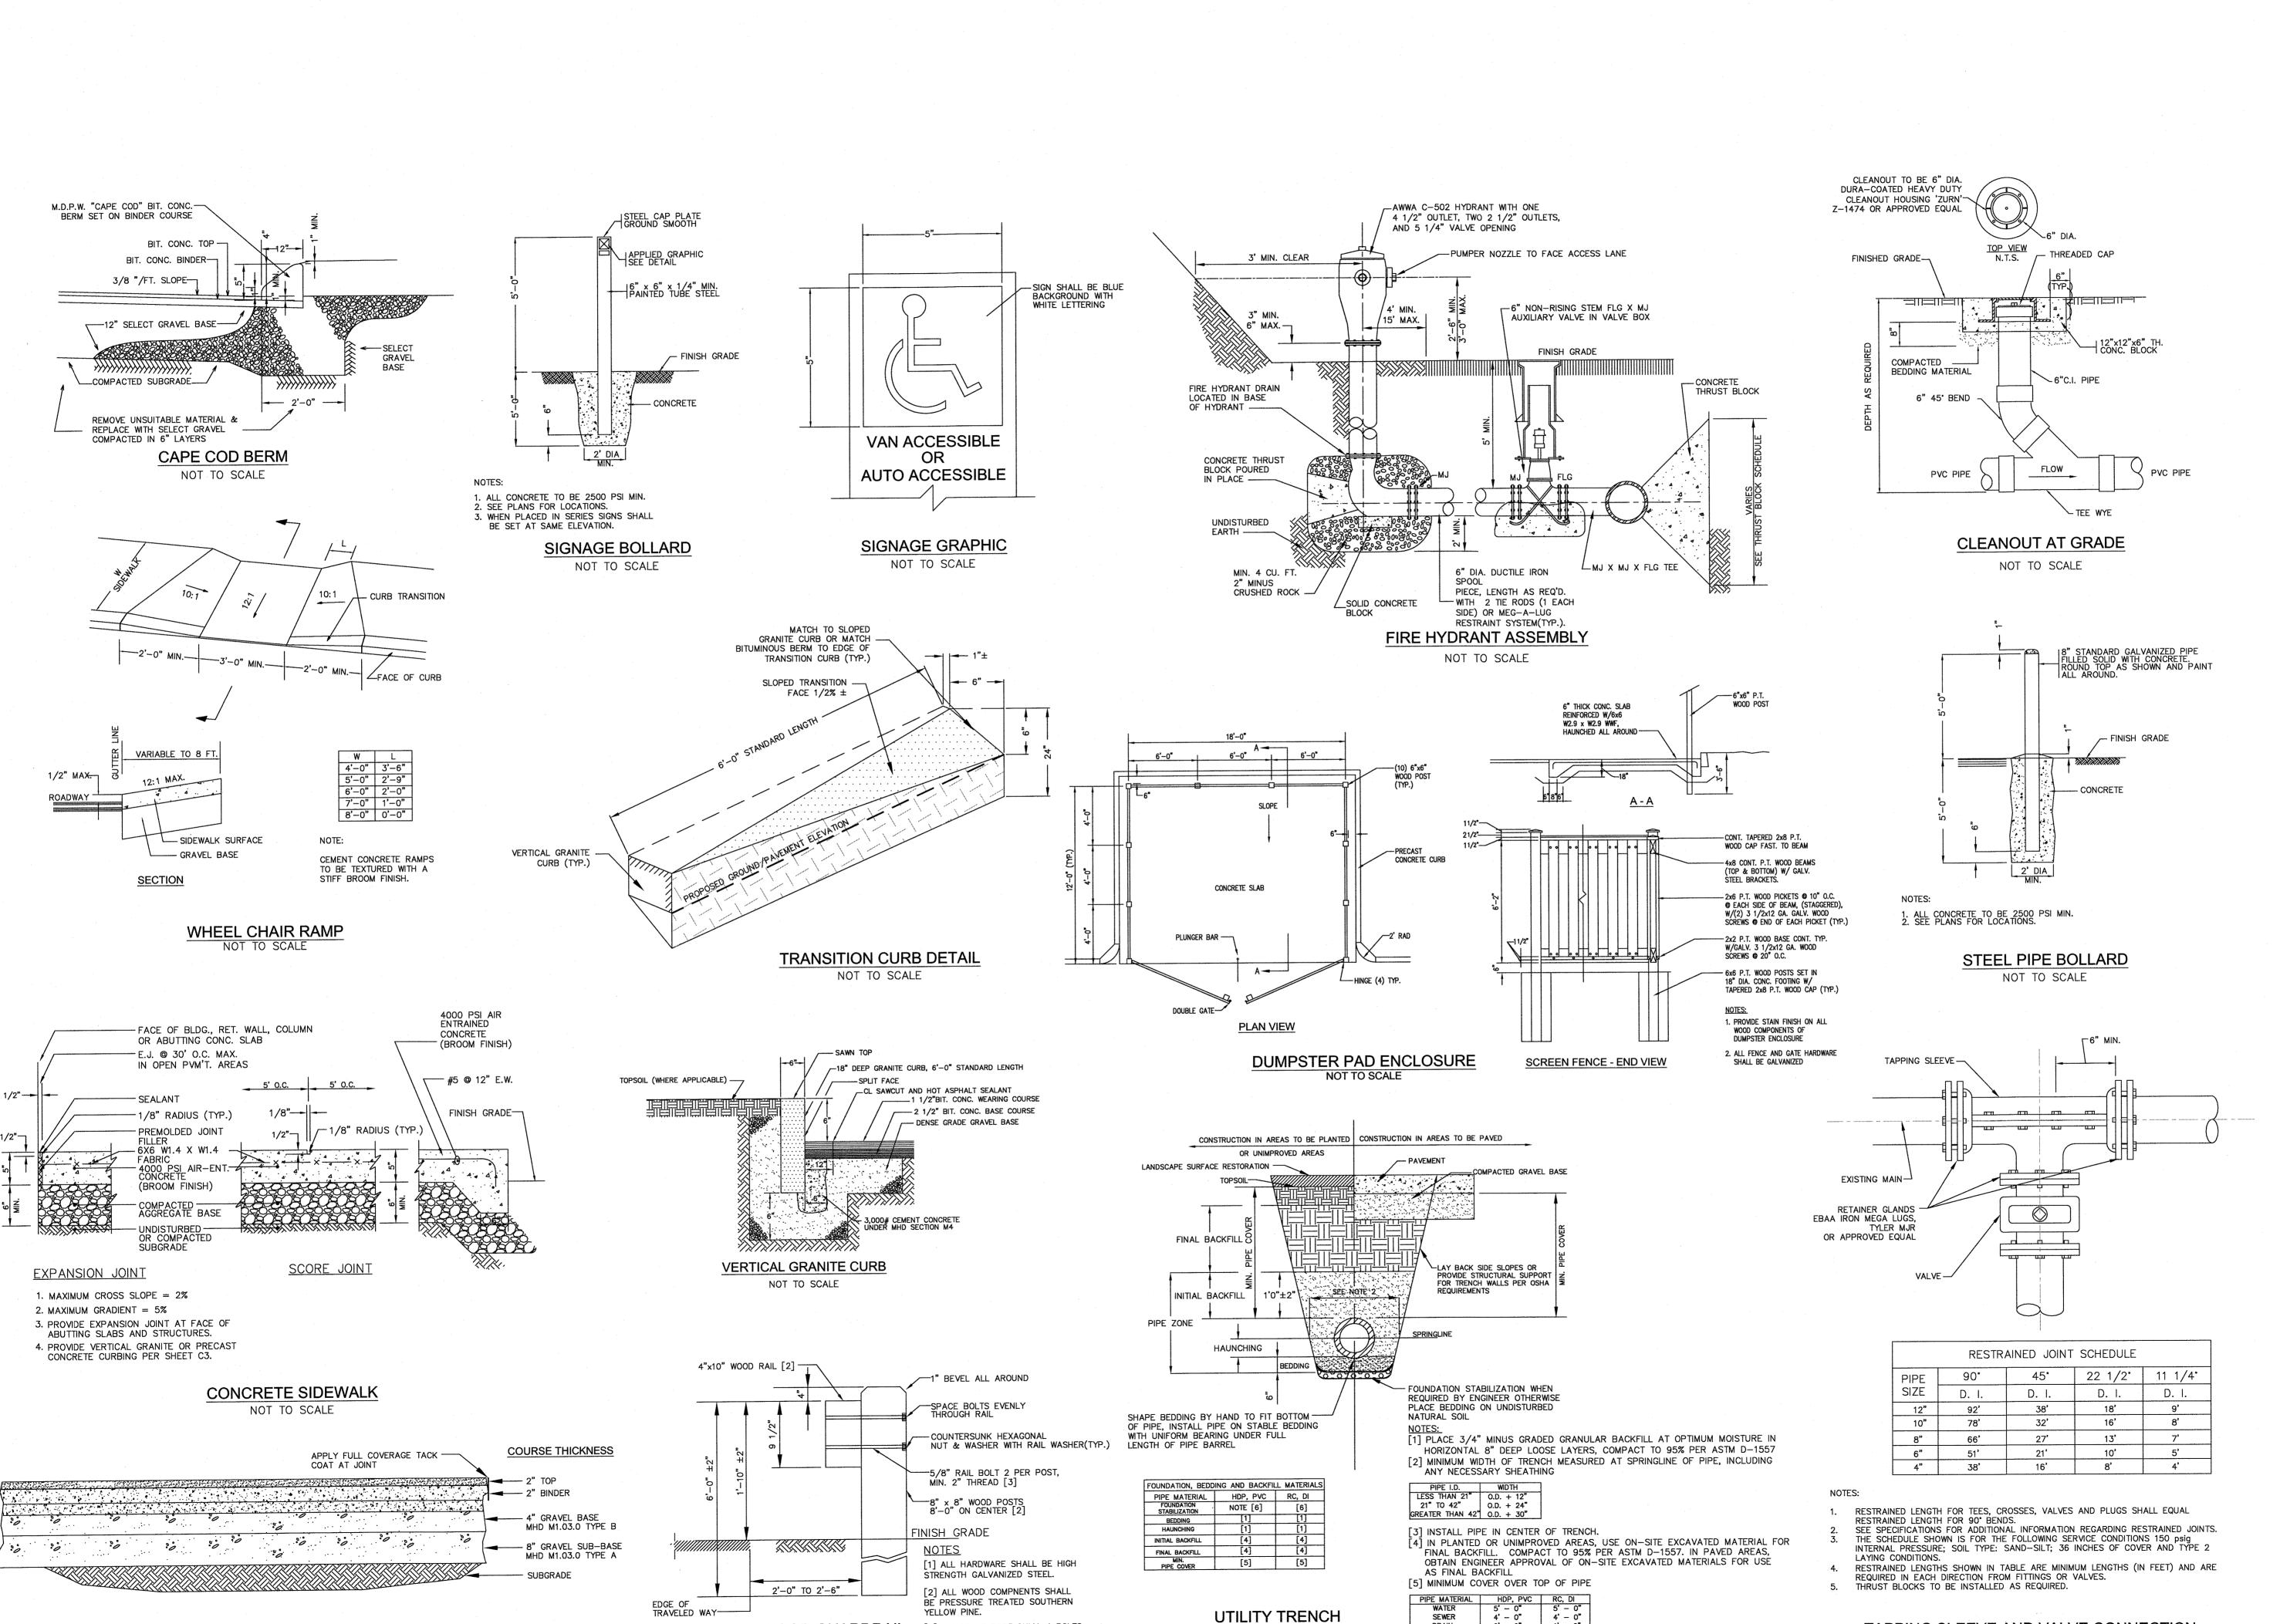

WOOD GUARDRAIL

NOT TO SCALE

TRUCK AREAS - BITUMINOUS CONCRETE PAVEMENT

NOT TO SCALE

[3] SPLICE AT POST ONLY, 4 BOLTS

EACH SPLICE POST.

CAMPBELL CIVIL No. 46245 DATE: JUNE 21, 2021 DRAWN: DRC SCALE: 1" = 20'

NO DATE

REVISIONS

1 06/21/2021 PERMIT SUBMISSION

O D CIVIL ENGINEERING / LAND SURVEYING

249 SOUTH STREET PLAINVILLE, MA 02762 TEL. (508) 695-2221 FAX. (508) 695-2219

**TYPICAL DETAILS** 

SHEET 6 OF 7


TAPPING SLEEVE AND VALVE CONNECTION NOT TO SCALE


4' - 0"


[6] FOR FOUNDATION STABILIZATION, USE 2" MINUS CRUSHED STONE


SEWER

NOT TO SCALE

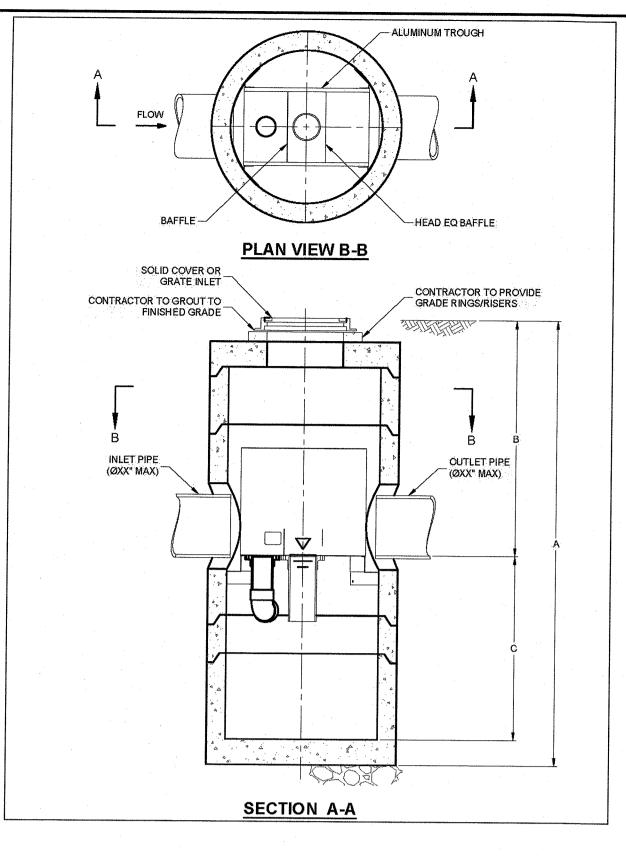

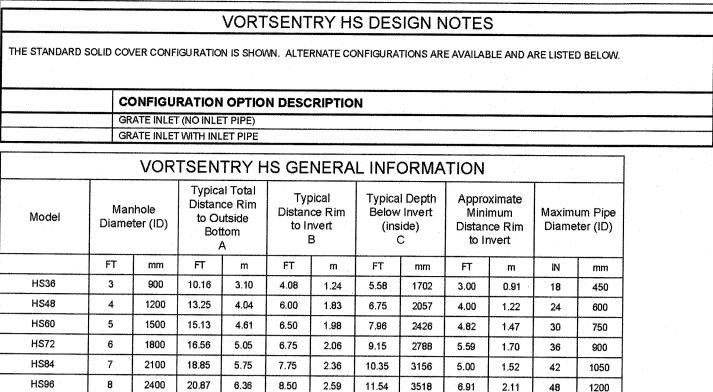

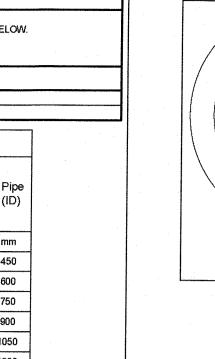

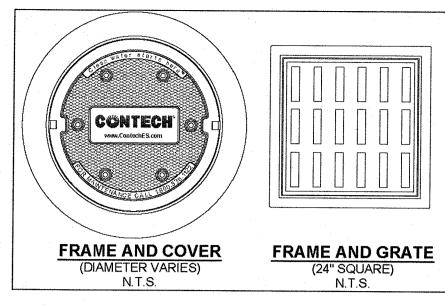


DIMENSIONS MARKED WITH ( ) ARE REFERENCE DIMENSIONS. ACTUAL DIMENSIONS MAY WARY FOR FABRICATION DRAWINGS WITH DETAILED STRUCTURE DIMENSIONS AND WEIGHT, PLEASE CONTACT YOUR CONTECH ENGINEERED SOLUTIONS LLC REPRESENTATIVE. www.ContechES.com 1. VORTSENTRY HS WATER QUALITY STRUCTURE SHALL BE IN ACCORDANCE WITH ALL DESIGN DATA AND INFORMATION CONTAINED IN THIS DRAWING. 5. STRUCTURE SHALL MEET AASHTO HS20 AND CASTINGS SHALL MEET AASHTO M306 LOAD RATING, ASSUMING GROUNDWATER ELEVATION AT, OR BELOW, THE OUTLET PIPE INVERT ELEVATION. ENGINEER OF RECORD TO CONFIRM ACTUAL GROUNDWATER ELEVATION. INSTALLATION NOTES

1. ANY SUB-BASE, BACKFILL DEPTH, AND/OR ANTI-FLOTATION PROVISIONS ARE SITE-SPECIFIC DESIGN CONSIDERATIONS 2. CONTRACTOR TO PROVIDE EQUIPMENT WITH SUFFICIENT LIFTING AND REACH CAPACITY TO LIFT AND SET THE VORTSENTRY HS MANHOLE STRUCTURE (LIFTING CLUTCHES PROVIDED). 3. CONTRACTOR TO INSTALL JOINT SEALANT BETWEEN ALL STRUCTURE SECTIONS AND ASSEMBLE STRUCTURE. 4. CONTRACTOR TO PROVIDE, INSTALL, AND GROUT PIPES. MATCH PIPE INVERTS WITH ELEVATIONS SHOWN. 5. CONTRACTOR TO TAKE APPROPRIATE MEASURES TO ASSURE UNIT IS WATER TIGHT, HOLDING WATER TO FLOWLINE INVERT MINIMUM. IT IS SUGGESTED THAT ALL JOINTS BELOW PIPE INVERTS ARE GROUTED.


GENERAL NOTES

1. CONTECH TO PROVIDE ALL MATERIALS UNLESS NOTED OTHERWISE.

VORTSENTRY DETAILS AND SPECIFICATIONS NOT TO SCALE

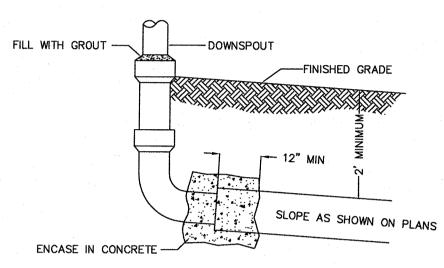

DOWNSPOUT CONNECTION TO DRAINAGE OUTLET NOT TO SCALE

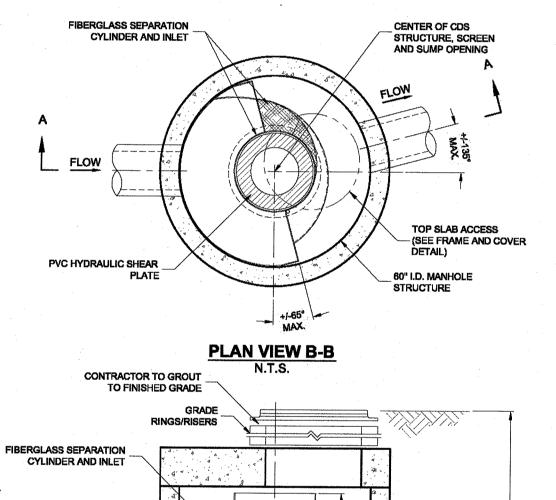

INLET PIPE

OIL BAFFLE SKIRT -


**SEPARATION** SCREEN

PVC HYDRAULIC SHEAR


STORAGE SUMP

(MULTIPLE INLET PIPES MAY


BE ACCOMMODATED)

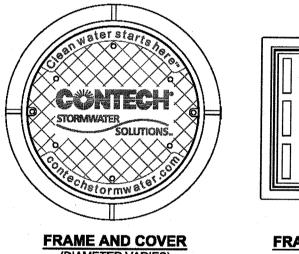

N.T.S.

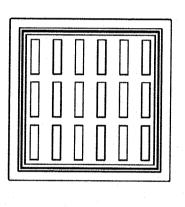

FRAME AND GRATE N.T.S.

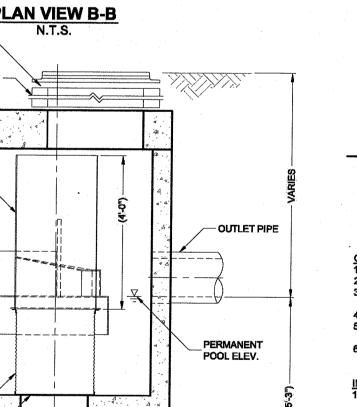

SENERAL NOTES


1. CONTECH TO PROVIDE ALL MATERIALS UNLESS NOTED OTHERWISE

2. DIMENSIONS MARKED WITH () ARE REFERENCE DIMENSIONS. ACTUAL DIMENSIONS MAY VARY. 3. FOR FABRICATION DRAWINGS WITH DETAILED STRUCTURE DIMENSIONS AND WEIGHTS, PLEASE CONTACT YOUR CONTECH CONSTRUCTION PRODUCTS REPRESENTATIVE. www.contech-cpi.com
4. CDS WATER QUALITY STRUCTURE SHALL BE IN ACCORDANCE WITH ALL DESIGN DATA AND INFORMATION CONTAINED IN THIS DRAWIN


2. CONTRACTOR TO PROVIDE EQUIPMENT WITH SUFFICIENT LIFTING AND REACH CAPACITY TO LIFT AND SET THE CDS MANHOLE STRUCTURE


3. CONTRACTOR TO ADD JOINT SEALANT BETWEEN ALL STRUCTURE SECTIONS, AND ASSEMBLE STRUCTURE. SUGGESTED THAT ALL JOINTS BELOW PIPE INVERTS ARE GROUTED.


#### 5. STRUCTURE SHALL MEET AASHTO HS20 AND CASTINGS SHALL MEET AASHTO M306 LOAD RATING, ASSUMING GROUNDWATER ELEVATION AT, OR BELOW, THE OUTLET PIPE INVERT ELEVATION. ENGINEER OF RECORD TO CONFIRM ACTUAL GROUNDWATER ELEVATION. 6. PVC HYDRAULIC SHEAR PLATE IS PLACED ON SHELF AT BOTTOM OF SCREEN CYLINDER. REMOVE AND REPLACE AS NECESSARY DURING INSTALLATION NOTES 1. ANY SUB-BASE, BACKFILL DEPTH, AND/OR ANTI-FLOTATION PROVISIONS ARE SITE-SPECIFIC DESIGN CONSIDERATIONS AND SHALL BE SPECIFIED (LIFTING CLUTCHES PROVIDED). CONTRACTOR TO PROVIDE, INSTALL, AND GROUT PIPES. MATCH PIPE INVERTS WITH ELEVATIONS SHOWN. CONTRACTOR TO TAKE APPROPRIATE MEASURES TO ASSURE UNIT IS WATER TIGHT, HOLDING WATER TO FLOWLINE INVERT MINIMUM. IT IS

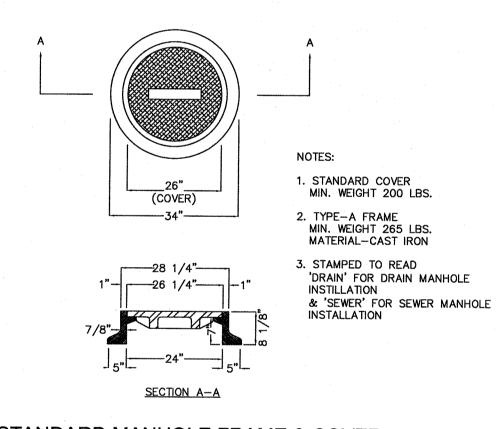



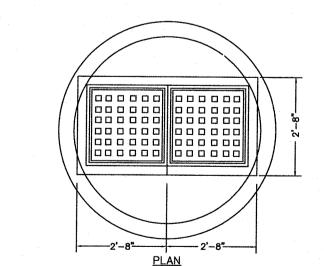

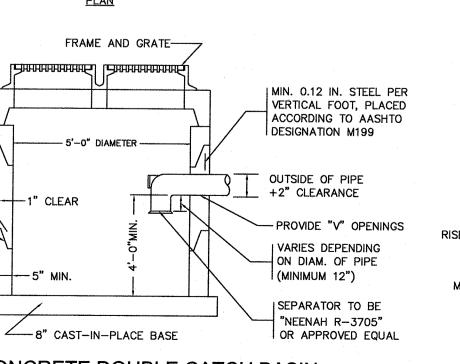

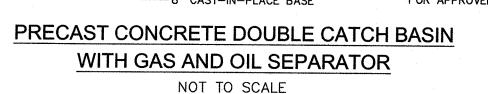

MORTAR ALL


HEIGHT OF

VARY FROM

1' TO 4'

RISER SECTIONS

JOINTS

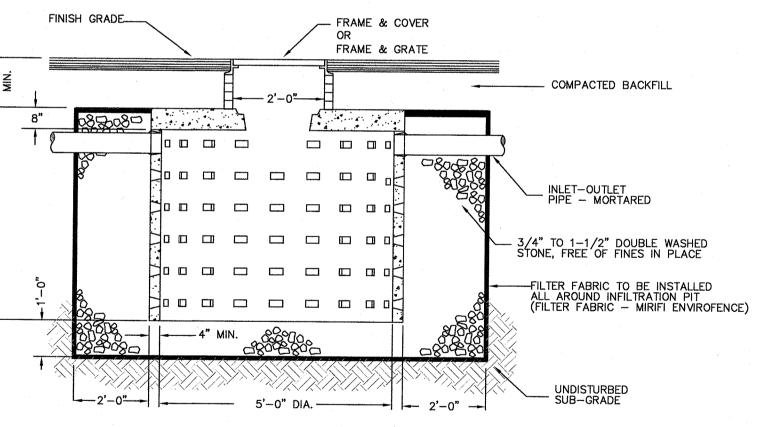


4TH FLANGE WHEN REQUIRED

1'-11 3/4" 1 1/4" 2 1/2"

SECTION A-A

**INFILTRATION PIT W/ OVERFLOW** H-20 LOADING NOT TO SCALE

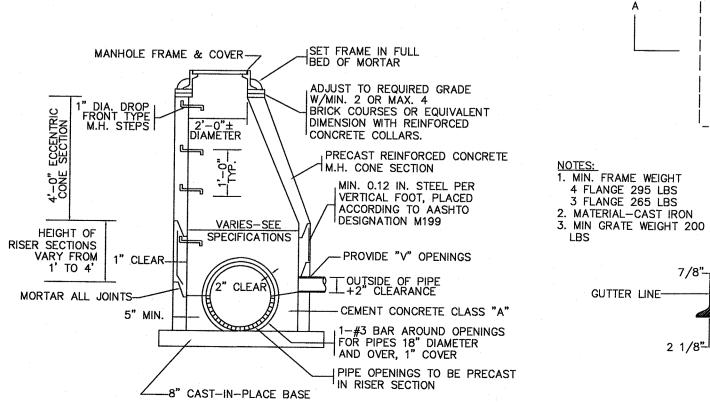

STANDARD CATCH BASIN FRAME & GRATE PRECAST CONCRETE DRAIN MANHOLE NOT TO SCALE NOT TO SCALE

JUNE 21, 2021 DRAWN: DRC SCALE: 1" = 20'

NO DATE

REVISIONS

06/21/2021 PERMIT SUBMISSION

TIAI -000-**∭**∞

CIVIL ENGINEERING / LAND SURVEYING 249 SOUTH STREET

PLAINVILLE, MA 02762 TEL. (508) 695-2221 FAX. (508) 695-2219 **TYPICAL DETAILS** 


SHEET 7 OF 7


CDS 2020-5-G UNIT (STANDARD)

**ELEVATION A-A** 

CDS2020-5-C DESIGN NOTES
CDS2020-5-C RATED TREATMENT CAPACITY IS 2.2 CFS, OR PER LOCAL REGULATIONS.
THE STANDARD CDS2020-5-C CONFIGURATION IS SHOWN. ALTERNATE CONFIGURATIONS ARE AVAILABLE AND ARE LISTED BELOW. SOME CONFIGURATIONS MAY BE COMBINED TO SUIT SITE REQUIREMENTS.
CONFIGURATION DESCRIPTION
GRATED INLET ONLY (NO INLET PIPE)
GRATED INLET WITH INLET PIPE OR PIPES
CURB INLET ONLY (NO INLET PIPE)
CURB INLET WITH INLET PIPE OR PIPES
SEPARATE OIL BAFFLE (SINGLE INLET PIPE REQUIRED FOR THIS CONFIGURATION)
SEDIMENT WEIR FOR NJDEP / NJCAT CONFORMING UNITS

CDS UNIT DETAILS AND SPECIFICATIONS

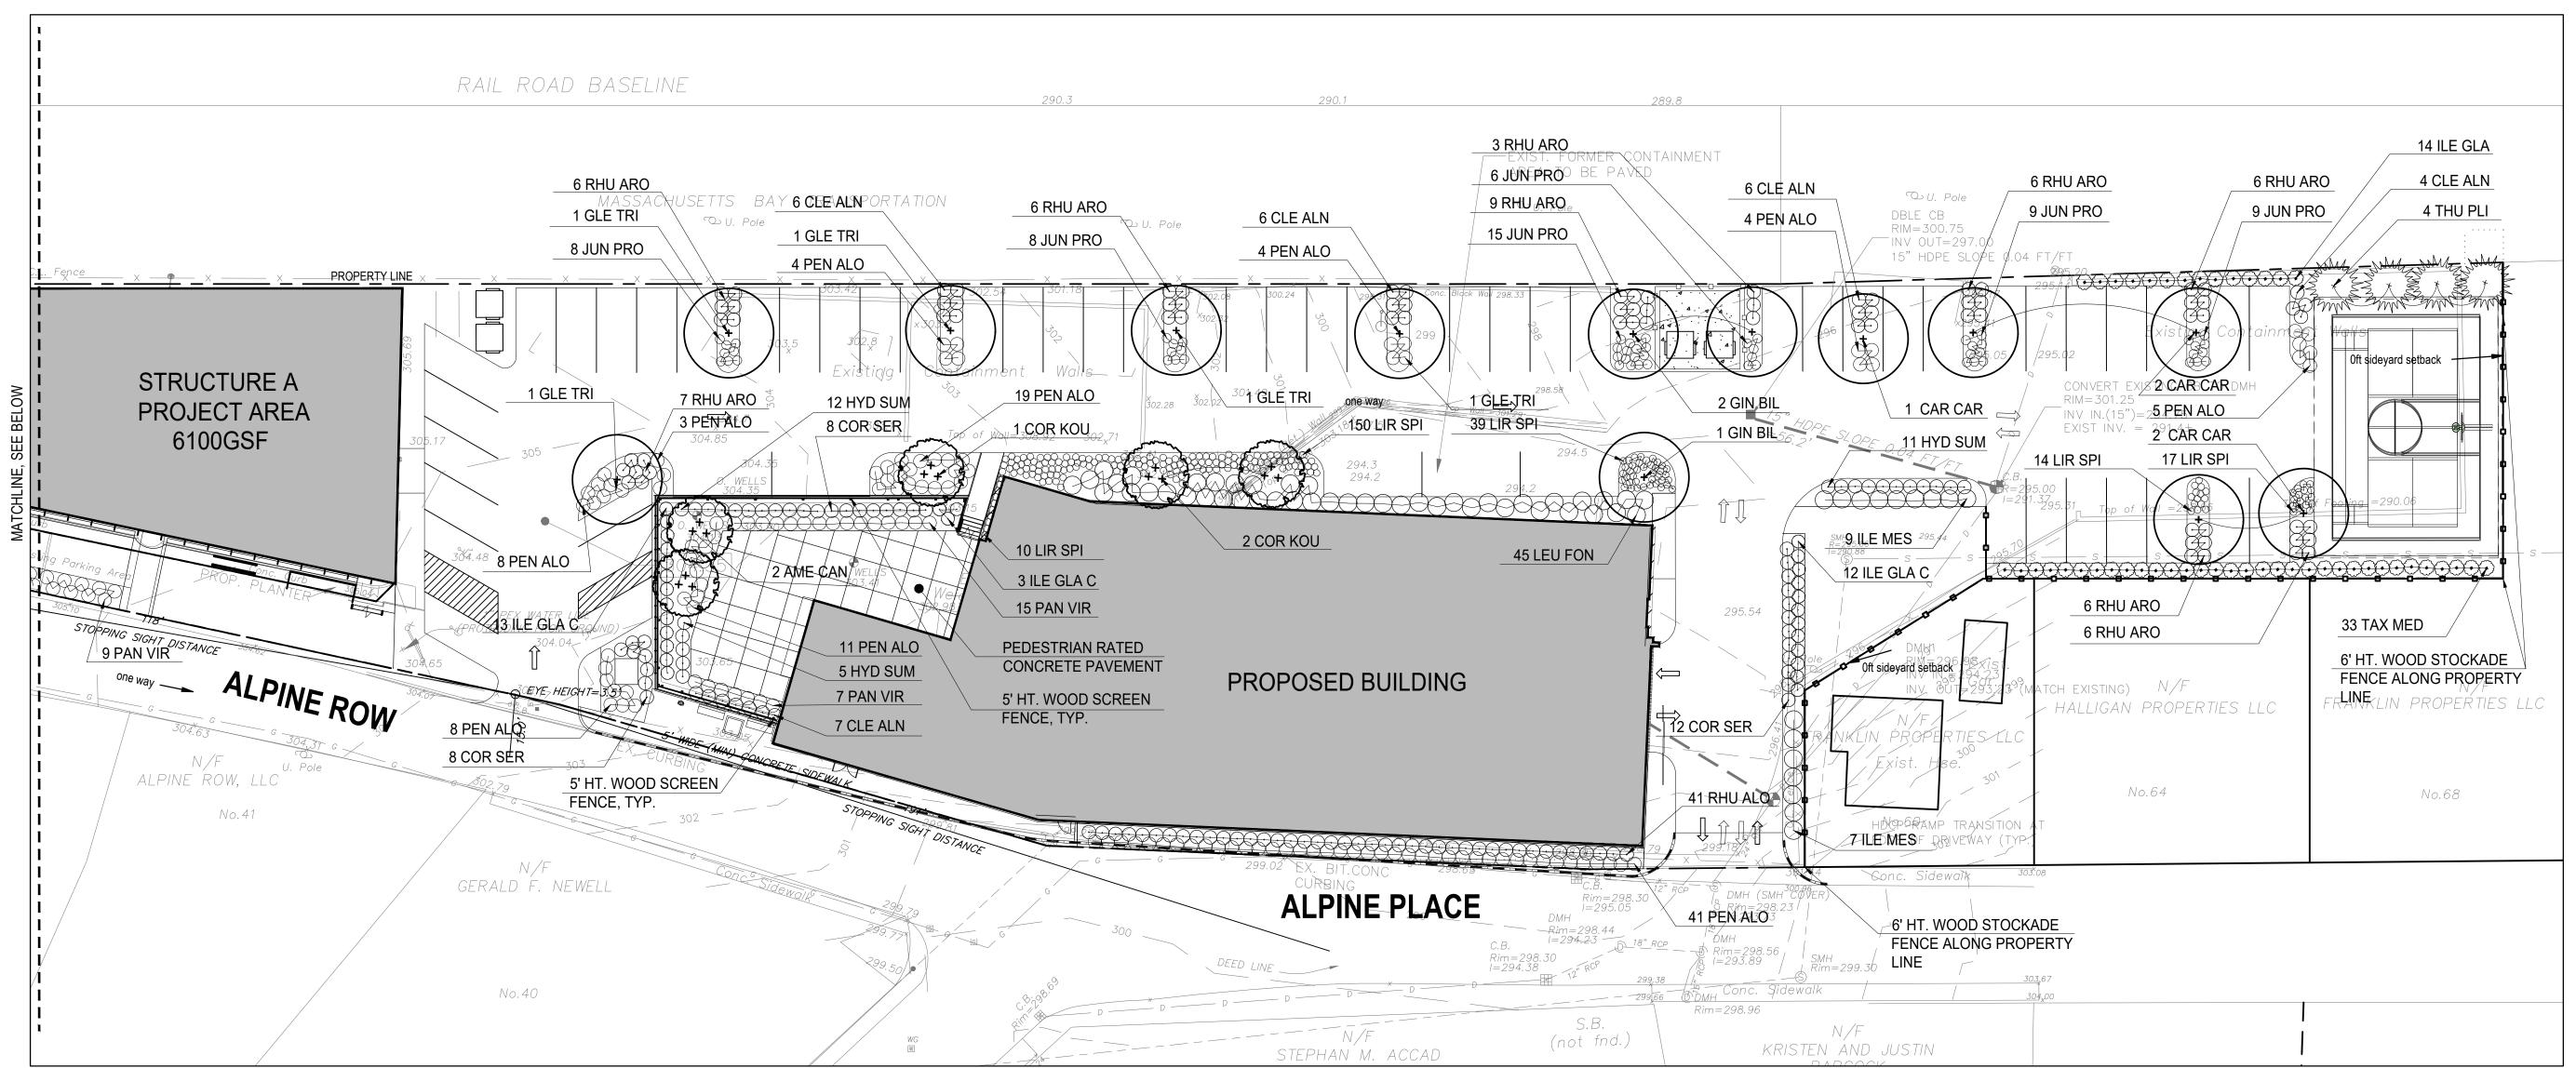

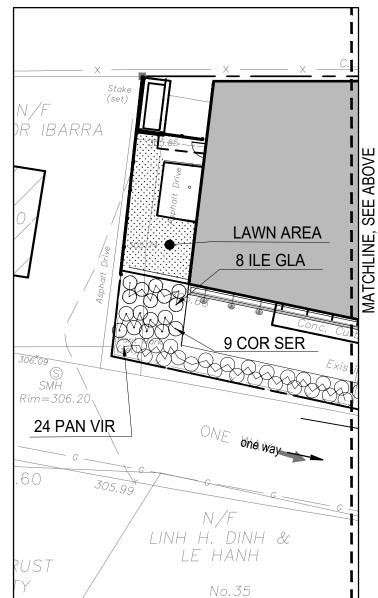

#### PLANTING NOTES

- 1. BASE FILE SURVEY INFORMATION PROVIDED BY JOE THE ARCHITECT, MAY 05, 2021.
- 2. IF DISCREPANCIES EXIST BETWEEN THE NUMBER OF PLANTS DRAWN ON THE PLANTING PLAN AND THE NUMBER OF PLANTS IN THE PLANT LIST, THE PLANTING PLAN SHALL GOVERN.
- 3. ALL NEW PLANT MATERIAL SHALL CONFORM TO THE MINIMUM GUIDELINES ESTABLISHED FOR NURSERY STOCK PUBLISHED BY THE AMERICAN NURSERY AND LANDSCAPE ASSOCIATION. IN ADDITION, ALL NEW PLANT MATERIAL FOR THE PROJECT SHALL BE OF SPECIMEN QUALITY.
- 4. ALL NEW PLANTS TO BE BALLED AND BURLAPPED OR CONTAINER-GROWN, UNLESS OTHERWISE NOTED ON THE PLANT LIST.
- 5. THE CONTRACTOR SHALL SUPPLY ALL NEW PLANT MATERIAL IN QUANTITIES SUFFICIENT TO COMPLETE THE PLANTING SHOWN ON THE DRAWINGS.
- 6. ANY PROPOSED SUBSTITUTIONS OF PLANT SPECIES SHALL BE MADE WITH PLANTS OF EQUIVALENT OVERALL FORM, HEIGHT, BRANCHING HABIT, FLOWER, LEAF, COLOR, FRUIT AND CULTURE, AND ONLY AFTER WRITTEN APPROVAL OF THE LANDSCAPE ARCHITECT.
- 7. CONTRACTOR SHALL LOCATE AND VERIFY ALL EXISTING UTILITY LINES PRIOR TO PLANTING AND SHALL REPORT ANY CONFLICTS TO THE LANDSCAPE ARCHITECT.
- STAKE LOCATION OF ALL PROPOSED PLANTING FOR APPROVAL BY OWNER'S REP PRIOR TO THE COMMENCEMENT OF PLANTING.
- 9. NEW SHRUBS AND GROUND COVER SHALL BEAR THE SAME RELATIONSHIP TO GRADE AS IT BORE TO PREVIOUS GRADE. TREES SHALL BE SET 3" HIGHER THAN PREVIOUS GRADE. NO TREES SHALL BE PLANTED BEFORE ACCEPTANCE OF ROUGH GRADING.
- 10. ALL PLANT BEDS TO RECEIVE THREE INCHES (3") OF BARK MULCH AS PER THE SPECIFICATIONS.
- 11. ALL EXISTING TREES TO REMAIN SHALL BE PROPERLY PROTECTED DURING CONSTRUCTION. PROTECTION TECHNIQUES SHALL BE REVIEWED AND APPROVED BY THE OWNER'S REP.
- 12. PRUNE EXISTING AND NEW TREES IN ACCORDANCE WITH THE SPECIFICATIONS.
- 13. CONTRACTOR SHALL PROVIDE FULL DEPTHS OF LOAM AS NOTED ON DETAILS AND AS SPECIFIED, FOR ALL PLANTING.
- 14. ALL TREES TO BE REMOVED FROM SCOPE OF WORK SHALL INCLUDE GRINDING OF STUMP AND REMOVAL OFF-SITE.
- 15. ANY EXISTING TREES AFFECTED BY CONSTRUCTION SHALL HAVE ROOTS PRUNED PER THE SPECIFICATIONS.

LANIII	10 2C	HEDULE			
SYM	QTY	BOTANICAL NAME	COMMON NAME	SIZE	SPACING/NOTES
SHADE TREES			<b>-</b>		<b>!</b>
GIN BIL	3	Ginkgo biloba	Ginkgo	2 - 2 ½" CAL	B&B
GLE TRI	5	Gleditsia triacanthos	Honeylocust	2 - 2 ½" CAL	B&B
CAR CAR	5	Carpus carolinia	American Hornbeam	2 - 2 ½" CAL	B&B, NATIVE
ORNAMENTAL 1	TREES	•	•	•	
AME CAN	2	Amelanchier canadensis	Serviceberry	8-10' HT.	B&B Multi-stem, NATIVE
COR KOU	3	Cornus kousa	Kousa Dogwood	8-10' HT.	B&B Multi-stem
EVERGREEN TR	REES		•	•	
THU PLI	4	Thuja plicata 'Nana'	Dwarf Western Arbovitae	8-10' HT.	B&B
EVERGREEN	SHRUBS	•		•	
ILE GLA C	28	llex glabra 'compacta'	Compact Inkberry	24"-36" HT	36" O.C. NATIVE
ILE GLA	22	llex glabra	Inkberry	24"-36" HT	42" O.C. NATIVE
ILE MES	16	Ilex meserveae 'Blue Prince'	Blue Prince Holly	24"-36" HT	48" O.C.
LEU FON	45	Leucothoe fontanesiana 'Compacta'	Compact Drooping Leucothoe	2 Gal.	48" O.C. NATIVE
TAX MED	33	Taxus media 'Hill's Upright'	Hill's Upright Yew	36"-48" HT	36" O.C.
DECIDUOUS SH	IRUBS	•	•	•	
CLE ALN	29	Clethra alnifolia 'Compacta;	Compact Summersweet	3 Gal.	48" O.C. NATIVE
COR SER	37	Cornus Sericea 'kelseyi'	Kelsey Dogwood	3 Gal.	48" O.C. NATIVE
HYD SUM	28	Hydrangea 'Endless Summer'	Endless Summer Hydrangea	3 Gal.	36" O.C.
RHU ARO	90	Rhus aromatica 'Gro Low'	Gro-Low Fragrant Sumac	3 Gal.	36" O.C.
ORNAMENTAL (	GRASSES A	ND PERENNIALS	•	•	
JUN PRO	37	Juniperus procumbens 'Nana'	Dwarf Juniper	1 Gal.	24" O.C.
LIR SPI	230	Liriope spicata	Lily Turf	1 Gal.	18" O.C.
PAN VIR	55	Pannicum virgatum 'Shenandoah'	Switch Grass	1 Gal.	36" O.C. NATIVE
PEN ALO	107	Pennisetum alopecuroides 'hameln'	Hameln Fountain Grass	1 Gal.	36" O.C.



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www.joethearchitect.com



WALKER DEVELOPMENT

5 MT. ROYAL AVENUE, MARLBOROUGH, MA 01752

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**KEY PLAN** 

PROJECT INFORMATION
THE ENGINE YARD

40 ALPINE ROW FRANKLIN, MA 02038

FOR ZONING

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**ISSUE CHART** 

06/23/2021	DESIGN REVIEW	2	
06/23/2021	PLANNING BOARD	1	
DATE	ISSUE	N	
PROJECT NUMBER	440	·	
CHECKED	Checker		
APPROVED	Approver		

SITE LANDSCAPE PLAN


SHEET NUMBER

SHEET NAME

LA-01


### 4 PERENNIAL/GROUNDCOVER PLANTING SCALE: NTS

SCALE: NTS

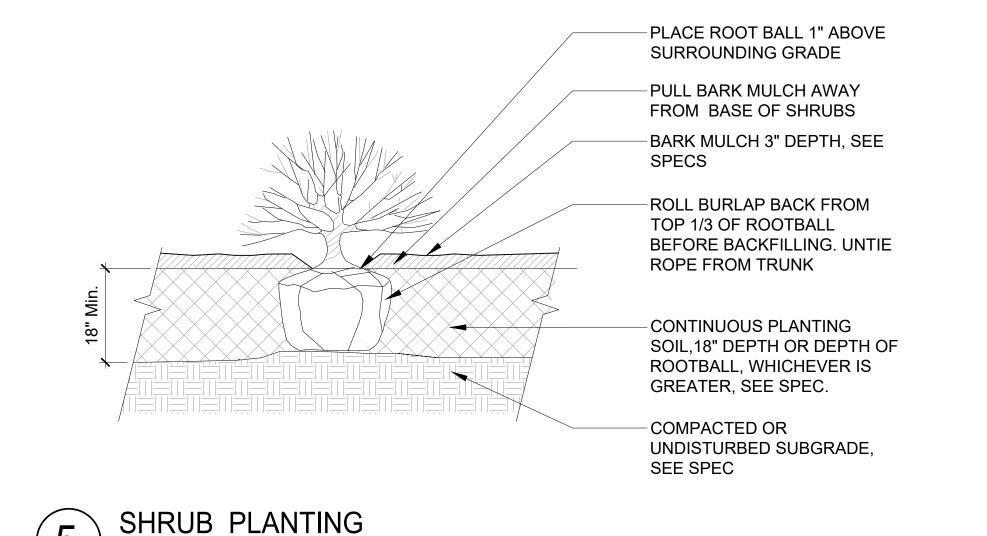


INSTALL TREE PLUMB TOP OF ROOTBALL SHALL BEAR SAME RELATIONSHIP TO FINISHED GRADE AS TO PREVIOUS EXISTING GRADE ROOT FLARE SHALL BE EXPOSED; MULCH SHOULD NOT BE WITHIN 4" OF TREE TRUNK PLACE BALL ON SUBSOIL. REMOVE AND DISCARD BURLAP EXCEPT UNDER BALL. REMOVE ALL SYNTHETIC SOIL WRAPPING MATERIALS (TREATED BURLAP, NYLON TWINE, WIRE BASKETS, ETC.) AND DISCARD 3" BARK MULCH, AS SPECIFIED EXCAVATE HOLE TO DIAMETER 3X WIDER THAN ROOTBALL. BACKFILL HOLE WITH PLANTING LOAM AS SPECIFIED -DECOMPACTED SUBGRADE **EXCAVATE SUBSOIL AS REQUIRED TO** PLACE ROOTBALL TO PROPER ELEVATION. PLACE ROOTBALL DIRECTLY ON COMPACTED OR UNDISTURBED SUBSOIL. EQ. TREE STABILIZATION, TYP.

DECIDUOUS TREE PLANTING

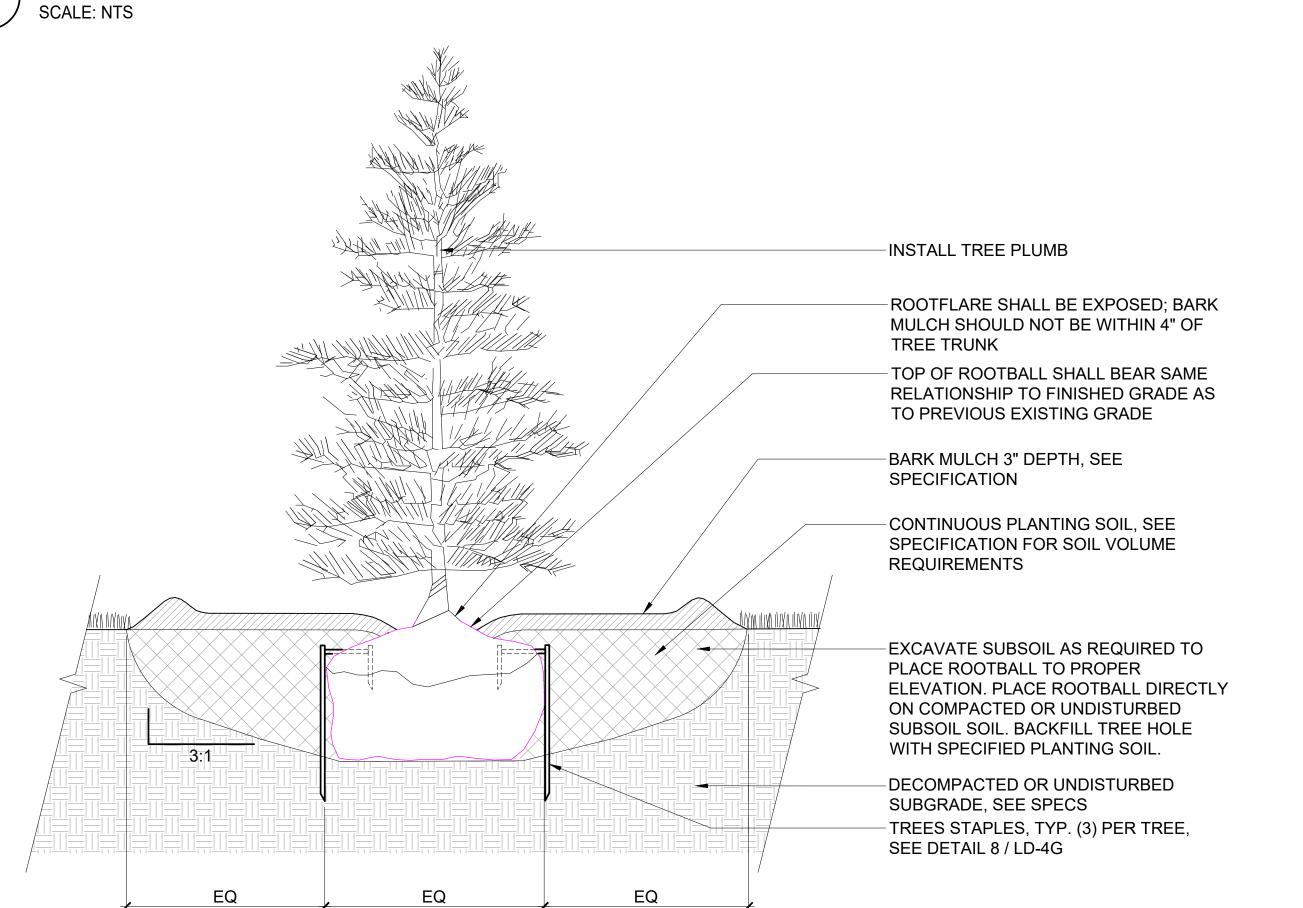

2 EVERGREEN TREE PLANTING
SCALE: NTS

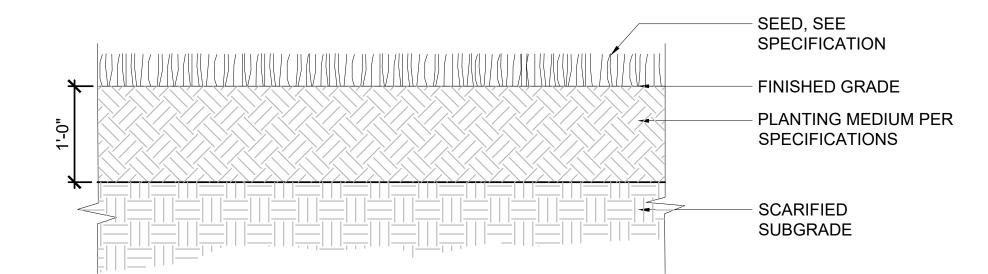

SEEDED LAWN
SCALE: NTS

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BOSTON MASS

KEY PLAN

PROJECT INFORMATION

THE ENGINE YARD

40 ALPINE ROW FRANKLIN, MA 02038

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ISSUE CHART

06/23/20	DESIGN REVIEW	2	
06/23/20	PLANNING BOARD	1	•
DA	ISSUE	N	
PROJECT NUMB	440	-	
CHECK	Checker		
APPROV	Approver		
SCA			

# SITE LANDSCAPE DETAILS


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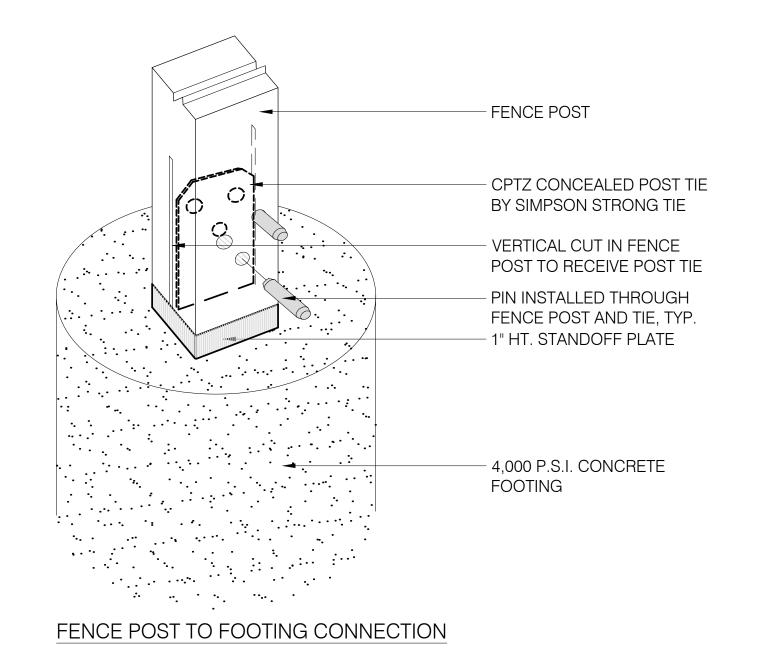
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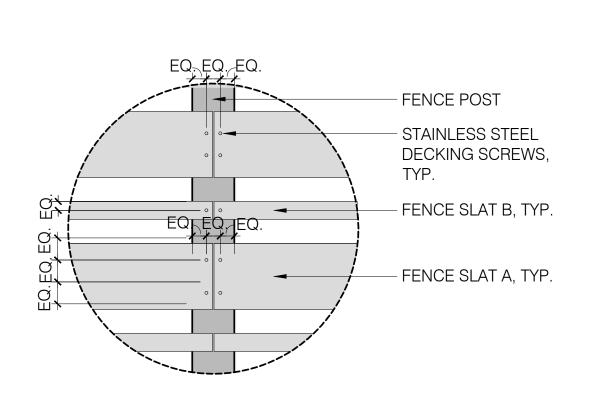
LA-02

5/22/2021 10:18:23 PM SE

6' HT. WOOD STOCKADE FENCE





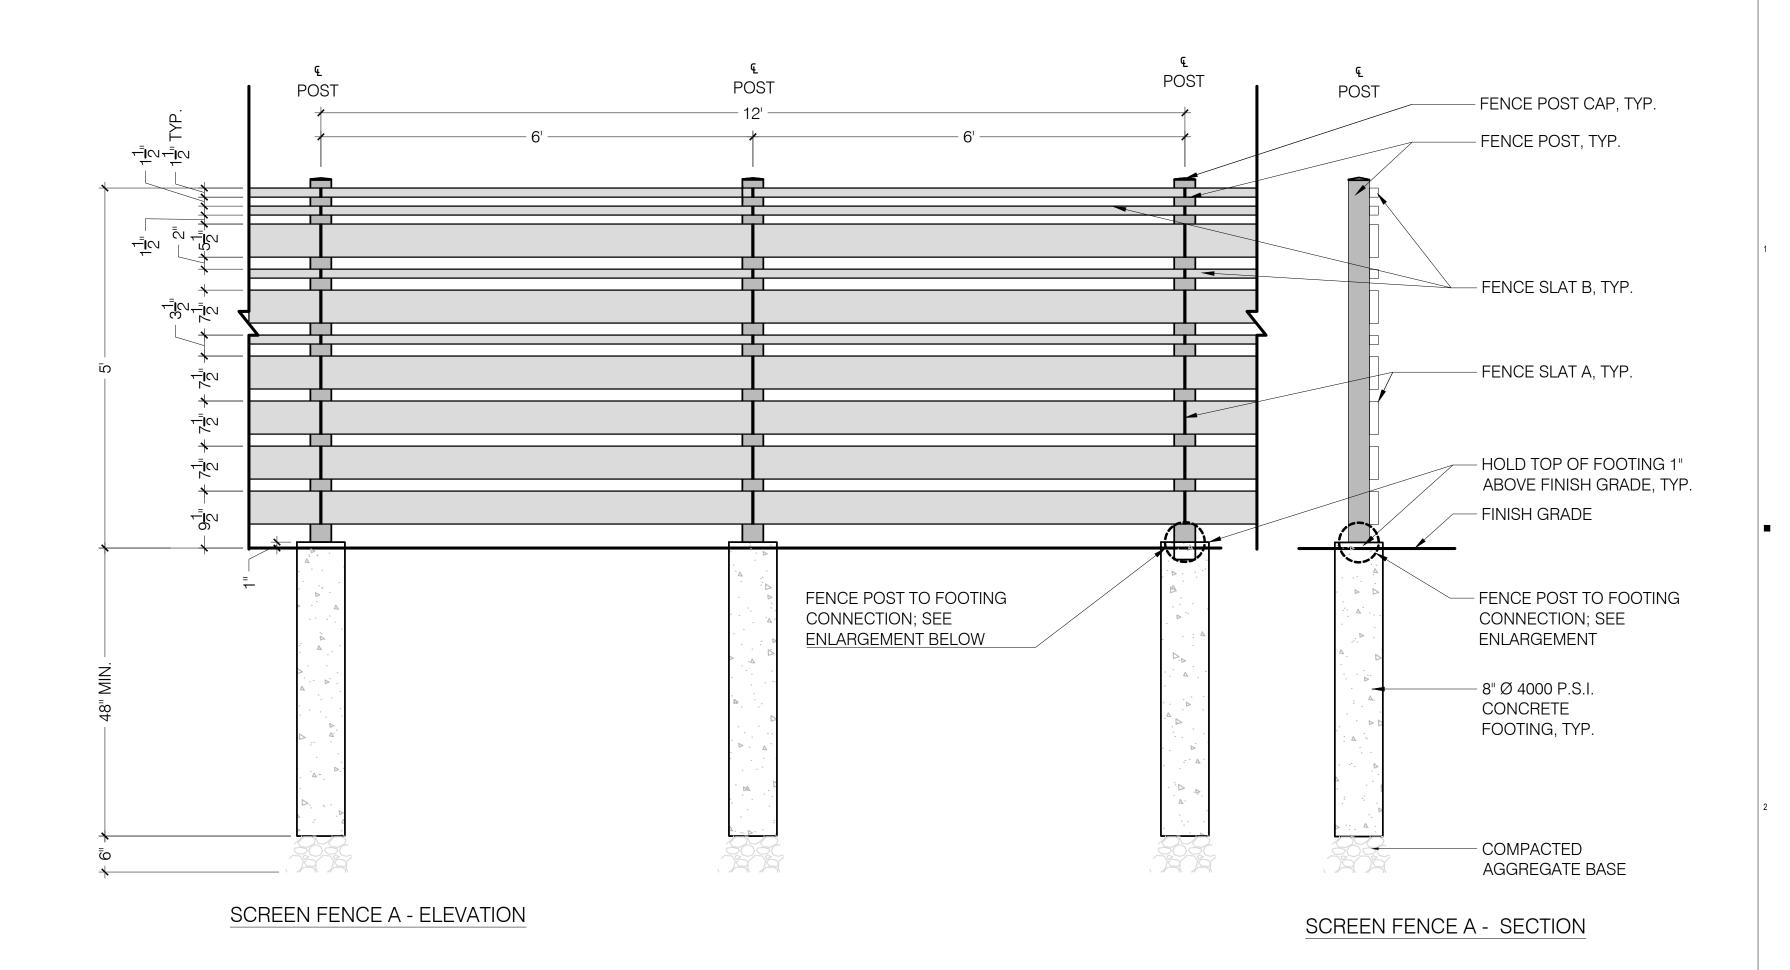

FENCE SLAT CONNECTION

- 1. FENCE POST SHALL BE 4X4 NOM. EASTERN RED CEDAR POST
- FENCE SLAT 'A' SHALL BE 2X6 NOM. EASTERN RED CEDAR BOARD FENCE SLAT 'B' SHALL BE 2X2 NOM. EASTERN RED CEDAR BOARD
- 4. GAPS BETWEEN FENCE SLATS SHALL BE 2" CLEAR, TYP. EXCEPT
- WHERE SHOWN ON THE DETAIL
- 5. ALL FENCE PANELS SHALL BE INSTALLED PARALLEL WITH VARYING HORIZONTAL, AND LINEAR OFFSETS.
- 6. PROVIDE SHOP DRAWINGS PRIOR TO FABRICATION.



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**KEY PLAN** 

PROJECT INFORMATION THE ENGINE YARD

FRANKLIN, MA 02038

**40 ALPINE ROW** 

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DESIGN REVIEW PLANNING BOARD 06/23/2021 ISSUE PROJECT NUMBER CHECKED Checker APPROVED Approver

> SITE LANDSCAPE **DETAILS**

SCALE

SHEET NAME











DECIDUOUS TREES -

Carpinus caroliniana





American Hornbeam

Thornless Honeylocust

Dwarf Western Arbovitae

Maidenhair Tree

Serviceberry

Kousa Dogwood





PD SD DD CD CA





Taxus media 'Hill's Upright' Hill's Upright Yew Ilex glabra 'Compacta' Compact Inkberry llex glabra Inkberry Blue Prince Holly

llex meserveae 'Blue Prince' DECIDUOUS SHRUBS -

Hydrangea macrophylla 'Endless Summer' Endless Summer Hydragea

Rhus aromatica 'Gro-low' Gro-low Fragrant Sumac Clethra alnifolia Summersweet Clethra Cornus sericia Redtwig Dogwood

PERENNIALS/GRASSES/GROUNDCOVER -Blue Lilyturf Liriope muscari

Fountain Grass Pennisetum alopecuroides Panicum virgatum 'Shenandoah' Shenandoah Switch Grass Juniperus procumbens 'Nana' Dwarf Japanese Juniper





JO LILARCIIII CI





PD SD DD CD CA



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WALKER DEVELOPMENT

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KEY PLAN

PROJECT INFORMATION THE ENGINE YARD

> 40 ALPINE ROW FRANKLIN, MA 02038

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**ISSUE CHART** 

PROJECT NUMBER

SITE LANDSCAPE **PLAN IMAGERY** 

SHEET NUMBER

SHEET NAME



SCALE

DRAWN BY: DATE: 06/23/21 NOTES:

• 0.0 | • 0 .0 • 0 TOTAL LOT 0 0.0 0.1 0.3 0.4 0. AREA=57,500%%pS.F 1.5 MH: 15 2.7 2.0 1.3 2<u>.2</u> 3.2 2.9 2.0 1.3 WL3 2.5 2.4 1.8 1.2 MH 115 0.00.0 0.0KRISTEN AND JUSTIN No.40No.67 No.65ANo.43 No.39 No.64

Calculation Summary

BASKETBALL COURT

STRUCTURE A STORAGE AREA

STRUCTURE A STREET AREA

**GREEN SPACE** 

PARKING LOT

SIDEWALK

SPILL LIGHT

TRACKS

CalcType

Illuminance

Illuminance

Illuminance

Illuminance

Illuminance

Illuminance

Illuminance

Illuminance

Units

Fc

Fc

Fc

Fc

0.86

1.05

1.61 7.3

1.34 5.9

1.48 4.4

0.00 0.1 0.0

0.0

0.0

0.0

0.2

0.0

Avg/Min Max/Min

N.A.

N.A.

N.A.

N.A.

N.A.

29.50

N.A.

N.A.


N.A.

6.70

N.A.

N.A.

Luminaire Scl	uminaire Schedule					
Symbol	Qty	Label	Arrangement	LLF	Description	Lum. Lumens
$\odot$	2	LL1	SINGLE	0.900	FL1A-BLT(BLACK)-RND-C4-K1-118-0 / M	428
$\odot$	3	WL1	SINGLE	0.900	H18110-91(BLACK)-1-2-HL-A-91(BLACK)	1295
$\odot$	12	DL1	SINGLE	0.900	FM-W9100-FINISH	924
	4	WL3	SINGLE	0.900	RWL1-48L-25-3K7-3-U	3587
+	10	SL4	SINGLE	0.900	RAR-1-80L-50-3K7-4W-BC	3663
$\overline{\cdot}$	1	WL5	SINGLE	0.900	SG1-10-3K	1346
•	5	BL1	SINGLE	0.900	S-KK0103US-16A-0870007A-730-16US	1255
	1	WALL LIGHT	SINGLE	0.900	RWL1-48L-45-3K7-4W-U	5484

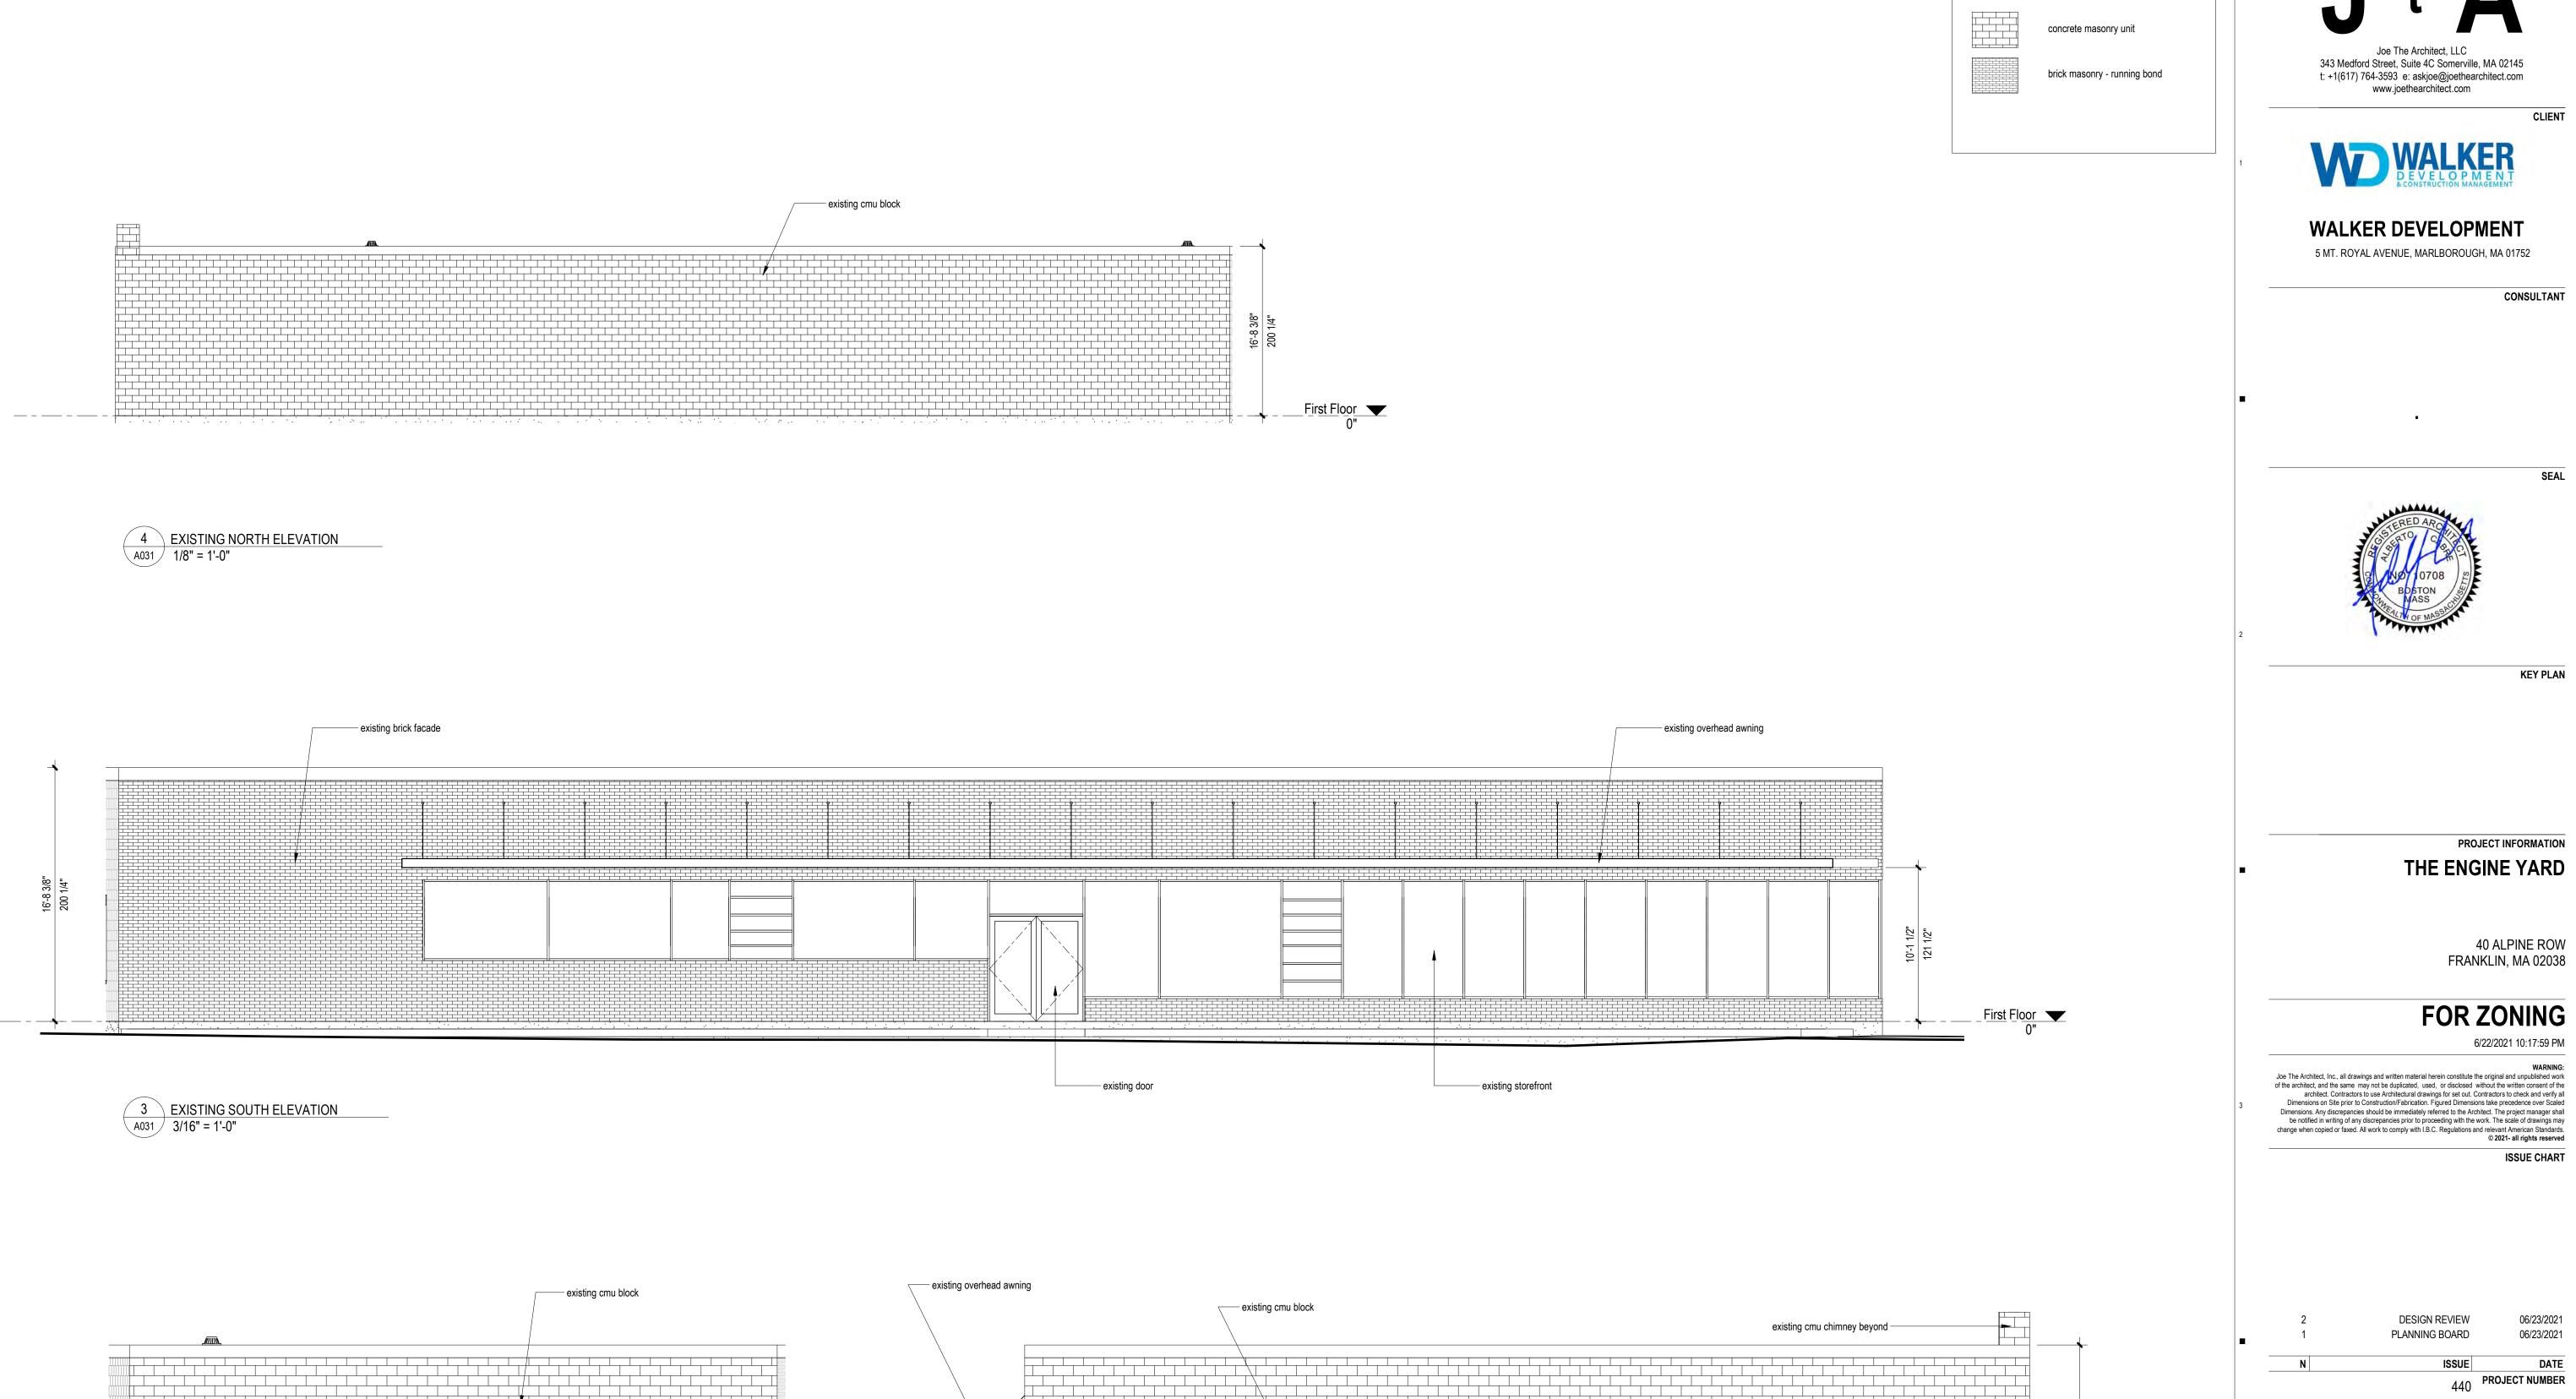

existing concrete curb -

- existing gas main into building

existing bollard -

2 EXISTING WEST ELEVATION
3/16" = 1'-0"

existing concrete foundation wall

1 EXISTING EAST ELEVATION
A031 3/16" = 1'-0"

**EXISTING BUILDING** First Floor

**EXISTING BUILDING FINISH** 

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WALKER DEVELOPMENT

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CLIENT

**KEY PLAN** 

PROJECT INFORMATION

40 ALPINE ROW FRANKLIN, MA 02038

06/23/2021

CHECKED

APPROVED

SHEET NAME

PROJECT NUMBER

FOR ZONING

**DESIGN REVIEW** 

PLANNING BOARD

ISSUE

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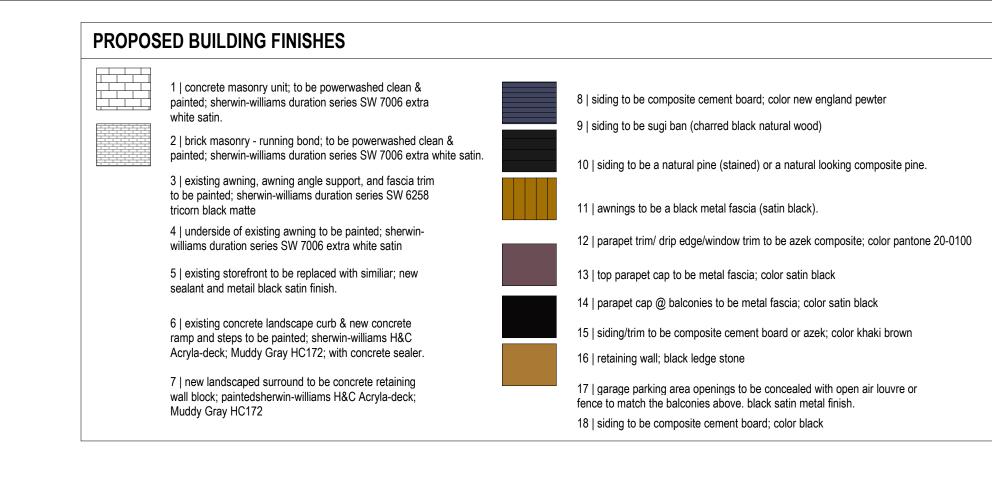
Approver

**ELEVATIONS** 

As indicated

THE ENGINE YARD

SHEET NUMBER





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WALKER DEVELOPMENT

5 MT. ROYAL AVENUE, MARLBOROUGH, MA 01752

existing overhead door to remain existing masonry vent WL3 loading zone for non-business hours

new door within new window within existing lintel existing lintel ----PROPOSED WEST ELEVATION -4 STRUCTURE A

A200 1/8" = 1'-0"

PROPOSED EAST ELEVATION - STRUCTURE A

 existing masonry chimney TENANT SIGNAGE HERE

PROJECT INFORMATION THE ENGINE YARD

40 ALPINE ROW FRANKLIN, MA 02038

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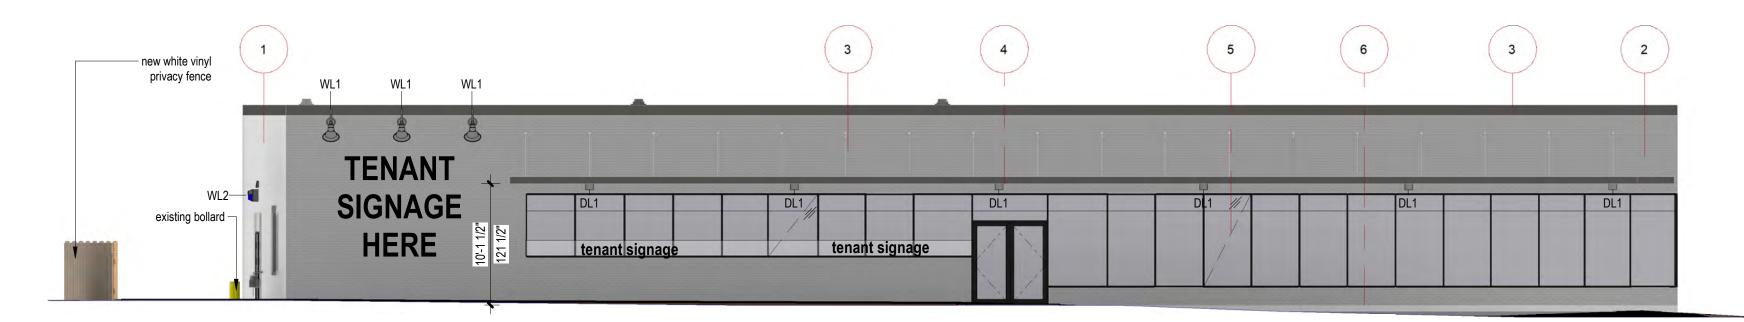
**DESIGN REVIEW** 

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**ISSUE CHART** 

PROPOSED NORTH ELEVATION STRUCTURE A
1/8" = 1'-0"




PLANNING BOARD 06/23/2021 ISSUE PROJECT NUMBER CHECKED Checker Approver 1/8" = 1'-0" SHEET NAME

> **EXTERNAL ELEVATIONS**

> > SHEET NUMBER

PROPOSED SOUTH ELEVATION STRUCTURE A
1/8" = 1'-0"

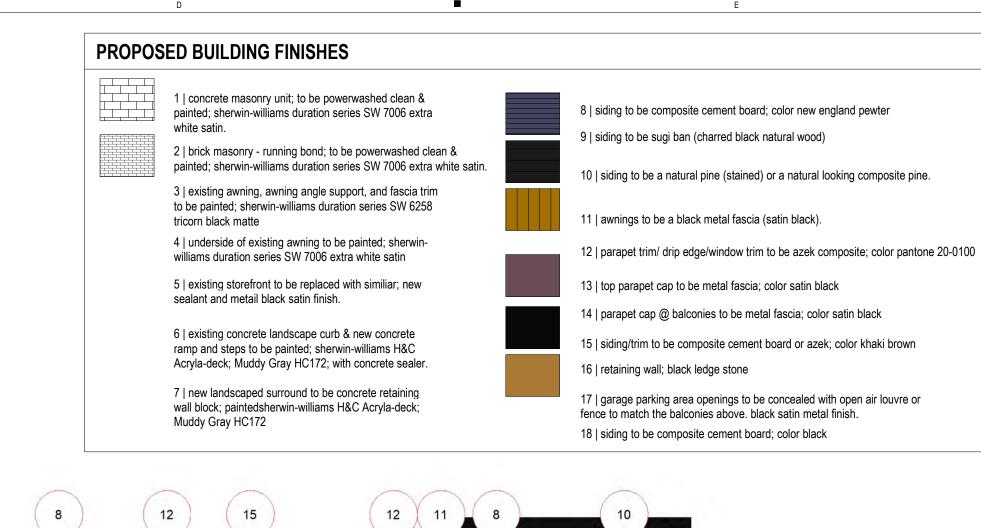





PROPOSED ELEVATION NORTH B -3 STRUCTURE B \ A201 \ \ 1/8" = 1'-0"

PROPOSED ELEVATION NORTH A -2 STRUCTURE B

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#### WALKER DEVELOPMENT

5 MT. ROYAL AVENUE, MARLBOROUGH, MA 01752

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**KEY PLAN** 

PROJECT INFORMATION THE ENGINE YARD

> **40 ALPINE ROW** FRANKLIN, MA 02038

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**ISSUE CHART** 

06/23/2021 06/23/2021	DESIGN REVIEW PLANNING BOARD	2
DATE	ISSUE	N
PROJECT NUMBER	440	
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APPROVED	Approver	
SCALE	1/8" = 1'-0"	
SHEET NAME		-

B1 Parking 🔻 -9'-5 5/8"

#### **EXTERNAL ELEVATIONS**

SHEET NUMBER



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#### WALKER DEVELOPMENT

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**KEY PLAN** 

PROJECT INFORMATION

THE ENGINE YARD

**40 ALPINE ROW** FRANKLIN, MA 02038

#### **FOR ZONING**

6/22/2021 10:18:17 PM

WARNING: Joe The Architect, Inc., all drawings and written material herein constitute the original and unpublished work of the architect, and the same may not be duplicated, used, or disclosed without the written consent of the architect. Contractors to use Architectural drawings for set out. Contractors to check and verify all Dimensions on Site prior to Construction/Fabrication. Figured Dimensions take precedence over Scaled Dimensions. Any discrepancies should be immediately referred to the Architect. The project manager shall be notified in writing of any discrepancies prior to proceeding with the work. The scale of drawings may

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**ISSUE CHART** 

DESIGN REVIEW PLANNING BOARD 06/23/2021

ISSUE PROJECT NUMBER CHECKED **APPROVED** 

> 1/8" = 1'-0" SHEET NAME

B1 Parking 🔻 -9'-5 5/8"


**EXTERNAL ELEVATIONS** 

SHEET NUMBER

PROPOSED ELEVATION SOUTH A -

1 STRUCTURE B

A202 1/8" = 1'-0"

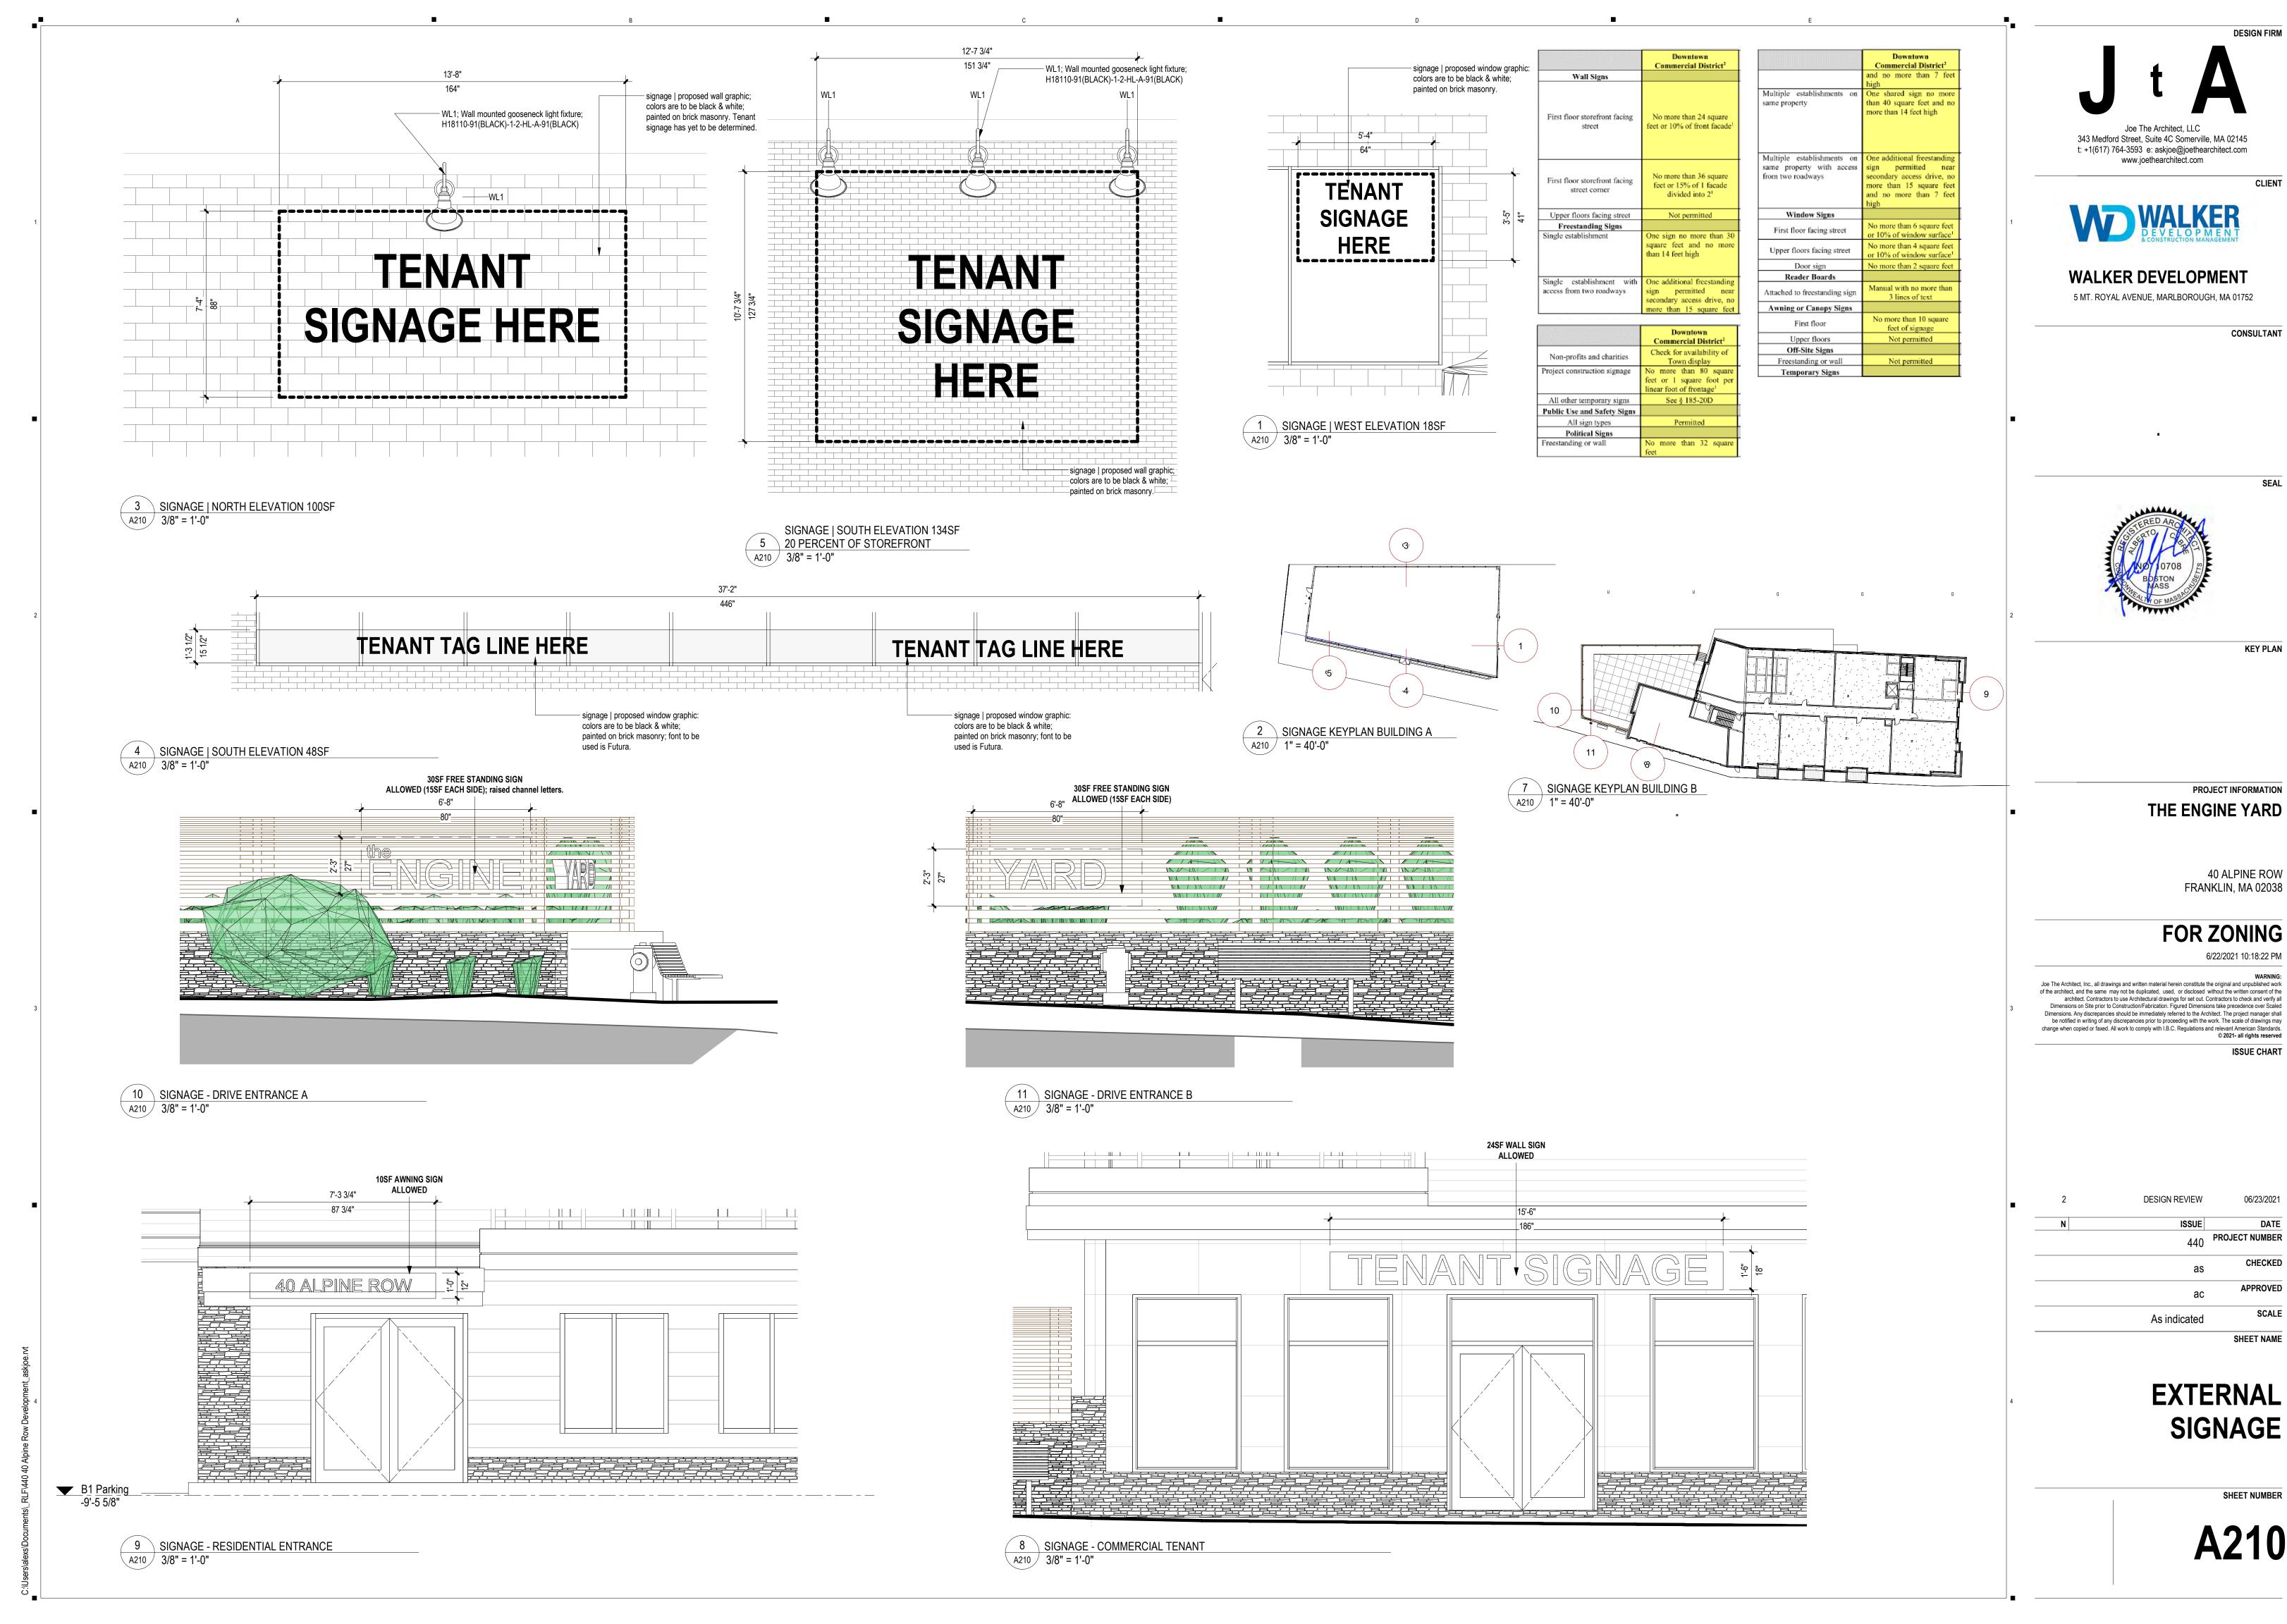

**SIGNAGE** 

**PROJECT NUMBER** 

**APPROVED** 

SHEET NAME

**DESIGN FIRM** 

CLIENT

CONSULTANT

**KEY PLAN** 

PROJECT INFORMATION

40 ALPINE ROW FRANKLIN, MA 02038

#### LOCUS MAP | IMAGE LOCATION KEY



#### GENERAL NOTES AND LEGENDS 3D VIEWS/RENDERING DISCLAIMER

the 3d views, photographs, and renderings on this sheet are to be used for general reference only. the contents of this sheet should not be used for any means of construction for the project. the contents of this sheet are strictly to provide a general idea of design intent. refer to the construction document technical drawings for specific information.
 landscaping is shown for illustration only. refer to landscape drawings for detailed information.



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#### WALKER DEVELOPMENT

5 MT. ROYAL AVENUE, MARLBOROUGH, MA 01752

CONSULTANT

CLIENT



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PROJECT INFORMATION THE ENGINE YARD

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**DESIGN REVIEW** PLANNING BOARD

12" = 1'-0"

**PROPOSED** 

**RENDERINGS** 

**BUILDING** 

06/23/2021

SHEET NAME

PROJECT NUMBER







SHEET NUMBER