

SITE PLAN MODIFICATION 70, 72, 88 AND 94 EAST CENTRAL STREET

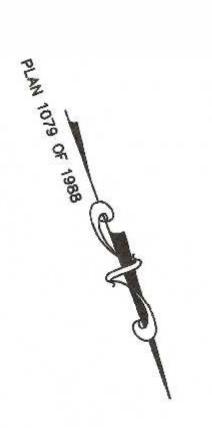

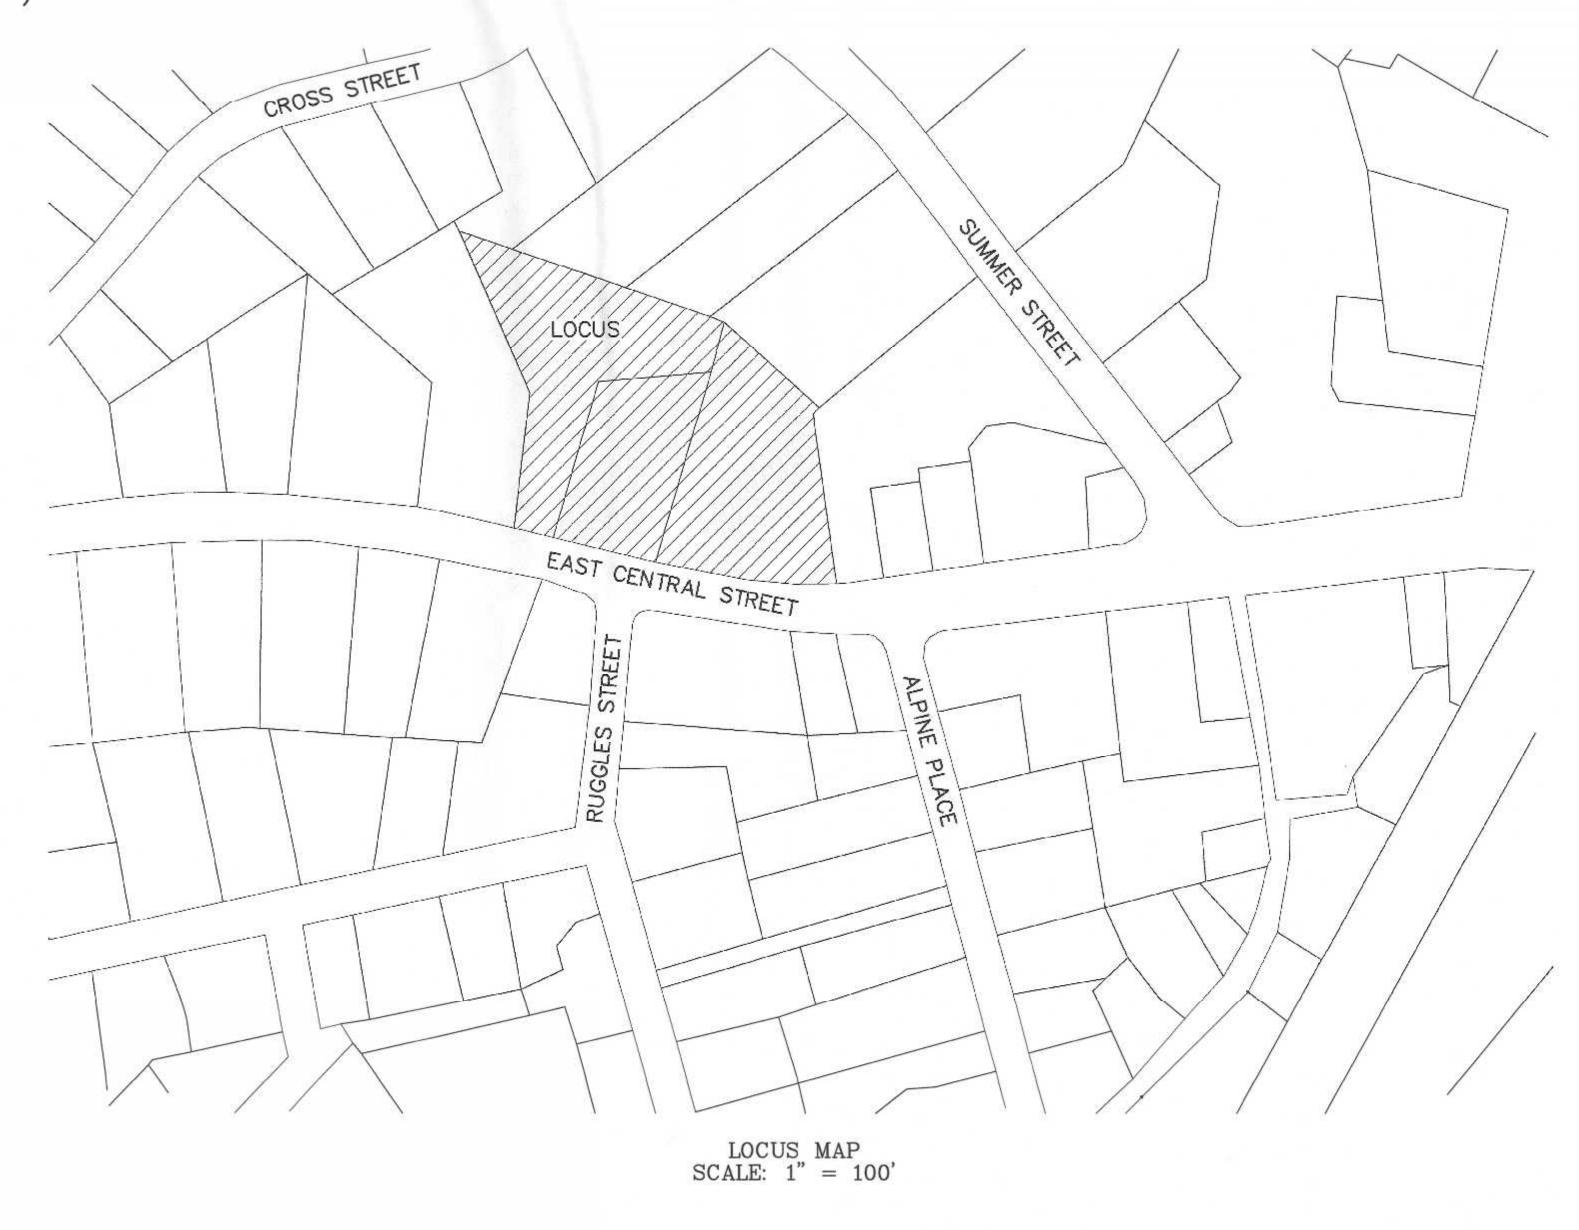

 ALL EROSION CONTROL MITIGATION MEASURES SHALL BE IN PLACE PRIOR TO MAJOR CONSTRUCTION OR SOIL DISTURBANCE COMMENCING ON THE SITE.

WAIVER REQUESTS:

1. TO ALLOW LESS THAN 42" OF COVER OVER THE RCP DRAIN PIPE. PROPOSED CLASS V RCP.

2. TO ALLOW THE USE OF HPDE PIPE FROM CATCH BASIN 92 TO THE UNDERGROUND POND, FROM THE UNDERGROUNG POND TO DRAIN MANHOLE 93, THE ROOF LEADER COLLECTION SYSTEM AND FROM ROOF LEADER CONNECTION TO DMH 95.

REFERENCES:
ASSESSORS MAP 286 PARCELS 32, 33 AND 34
DEED BOOK 36860 PAGE 516
DEED BOOK 35983 PAGE 116
DEED BOOK 24648 PAGE 492
PLAN 108 OF 1908
PLAN 576 OF 1900
OWNERS PLAN OF LAND BY GUERRIERE AND HALNON, INC DATED OCTOBER 22, 2018
PLAN 3334 OF 1913
PLAN 853 OF 1928

70 AND 72 EAST CENTRAL STREET PROPERTY ARE LOCATED WITHIN A DOWNTOWN COMMERCIAL ZONE. 88 AND 94 EAST CENTRAL STREET PROPERTY ARE LOCATED WITHIN A COMMERCIAL I ZONE. ZONING TABLE VALUES FOR #94 AND # 88 EAST CENTRAL STREET ARE BASED ON PARCELS "A" AND "B" BEING PART OF #94 EAST CENTRAL STEET AND ARE NOT REFLECTED AS PART OF # 88 EAST CENTRAL STREET.

#88 AND 94 E	AST CENTRAL STREET - REQUIREMENTS:	COMMERCIAL I Z	ONING DISTRICT PROPOSED	
AREA:	5,000 S.F.	54,614± S.F.	54,614± S.F.	
FRONTAGE:	50'	159.43'	159.43'	
DEPTH:	50°	271'	271'	
HEIGHT:	3 STORIES - 40' *15	2 STORIES	# 94 3 STORIES < 40' SEE ARCHITECTURAL	PLAN
WIDTH: SETBACKS	45'	163.5'	163.5'	
FRONT:	20' *1	160.3'	172.5'	
SIDE:	10' *14	24.6'	11.0'	
REAR: COVERAGE	15'	35.5'	17.2'	
STRUCTURES: STRUC, & PAV	80% ING: 90%	6.9% 15.4%	19.3% 46.2%	

#70-72 EAST CENTRAL STREET - DOWNTOWN COMMERCIAL ZONING DISTRICT

	REQUIREMENTS:	EXISTING	PROPOSED
DOWNTOWN CO	M.		
AREA:	5,000 S.F.	32,810 S.F.	32,810± S.F.
FRONTAGE:	50°	186.07	186.07
DEPTH:	50"	266'	266'
HEIGHT:	3 STORIES - 40' *9	2 STORIES	4 STORIES - 49.5'
WDTH:	45'	>45'	>45'
COVERAGE -			
STRUCTURES:	80%	7.6%	26%
STRUC. & PAY	/ING: 90%	19.2%	72.7%
SETBACKS-			
FRONT:	15' *10	20.7'	15.7'
SIDE:	0' *2	25.2'	15.0' & 5'
REAR:	15'	105'	23.3' & 17.5'

THE ABOVE INFORMATION WAS TAKEN FROM THE APPROVED SITE PLAN FOR 70 - 72 EAST CENTRAL STREET.

*1 - BUT NO NEW STRUCTURE SHALL BE REQUIRED TO PROVIDE A DEEPER YARD THAN EXISTED ON THAT PARCEL UPON ADOPTION OF THIS AMENDMENT.
*14 - THE 10-FOOT SIDE SETBACK IS ONLY REQUIRED ON ONE SIDE OF THE LOT; IF LOT ABUTS A RESIDENTIAL DISTRICT, A 20-FOOT SETBACK IS REQUIRED ON THE ABUTTING SIDE.
*15 - BUILDINGS UP TO 50 FEET IN HEIGHT, REGARDLESS OF THE NUMBER OF STORIES, MAY BE PERMITTED BY A SPECIAL PERMIT FROM THE PLANNING BOARD.

REQUIREMENTS FOR 94 EAST CENTRAL STREET ZONE COMMERCIAL 1
EXISTING AND PROPOSED LOT AREA, FRONTAGE, DEPTH, WIDTH AND COVERAGE BASED ON THE LOTS BEING COMBINED.
BUILDING HEIGHT, AND SETBACKS BASED ON EXISTING AND PROPOSED BUILDINGS LOCATED ON 88 AND 94 EAST CENTRAL STREET.

PROPERTY IS NOT LOCATED WITHIN A FRANKLIN WATER RESOURCE DISTRICT.
THE PROPERTY IS LOCATED IN A ZONE C BASED ON FEMA FIRM MAP 25021C0309E DATED JULY 17, 2012.

94 EAST CENTRAL STREET: EXISTING BUILDING USE RESIDENTIAL. PROPOSED BUILDING USE MIXED WITH RESIDENTIAL.

88 EAST CENTRAL STREET EXISTING BUILDING USE RESIDENTIAL.

70-72 EAST CENTRAL STREET CURRENT BUILDING USE MIXED WITH RESIDENTIAL.

DRAWING INDEX:

- 1. COVER SHEET
- 2. EXISTING CONDITIONS PLAN
- 3. SITE LAYOUT PLAN
- 4. SITE GRADING AND UTILITY PLAN
- 5. SITE PLANTING PLAN
- 6. EROSION CONTROL PLAN
- 7. CONSTRUCTION DETAILS
- 8. CONSTRUCTION DETAILS
- 9. CONSTRUCTION DETAILS SITE LIGHTING-LIGHTING PLAN, PHOTOMETRICS AND SCHEDULES

BY SK & ASSOCIATES

OWNER: MAP 286 PARCELS 32 AND 34 70 EAST CENTRAL STREET, LLC 37 EAST CENTRAL STREET

FRANKLIN, MASSACHUSETTS

OWNER MAP 286 PARCEL 33 JOHN AND CARMEL SHERRY 88 EAST CENTRAL STREET

APPLICANT: 70 EAST CENTRAL STREET, LLC 37 EAST CENTRAL STREET FRANKLIN, MASSACHUSETTS

SITE PLAN MODIFICATION COVER SHEET


70, 72, 88 AND 94 EAST CENTRAL STREET FRANKLIN, MASSACHUSETTS

PREPARED FOR 70 EAST CENTRAL STREET, LLC 37 EAST CENTRAL STREET

FRANKLIN, MASSACHUSETTS
DECEMBER 24, 2021
SCALE: 1" = 100'

SITE PLAN APPROVAL REQUIRED FRANKLIN PLANNING BOARD

DATE _____

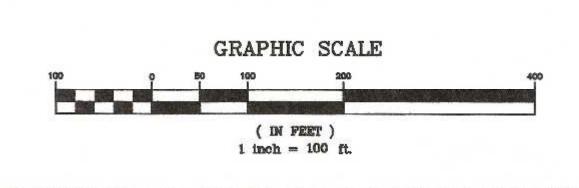

2	3/29/22	REVIEW COMMENTS	RRG
1	3/29/22 2/28/22	REVIEW COMMENTS	RRG
NO.	DATE	DESCRIPTION	BY

DATE		INT.
6/19	FIELD BY:	BL
BK#	FIELD BOOK	PG#
12/21	CALCS BY:	RRG
12/21	DESIGNED BY:	RRG
12/21	DRAWN BY:	COMP
12/21	CHECKED BY:	CAQ

NITED
ONSULTANTS
INC.

850 FRANKLIN STREET SUITE 11D


850 FRANKLIN STREET SUITE 11D WRENTHAM, MASSACHUSETTS 02093 508-384-6560 FAX 508-384-6566


UC1334 SHEET 1 of 9


DEC. 24, 2021


1'' = 100'


PROJECT

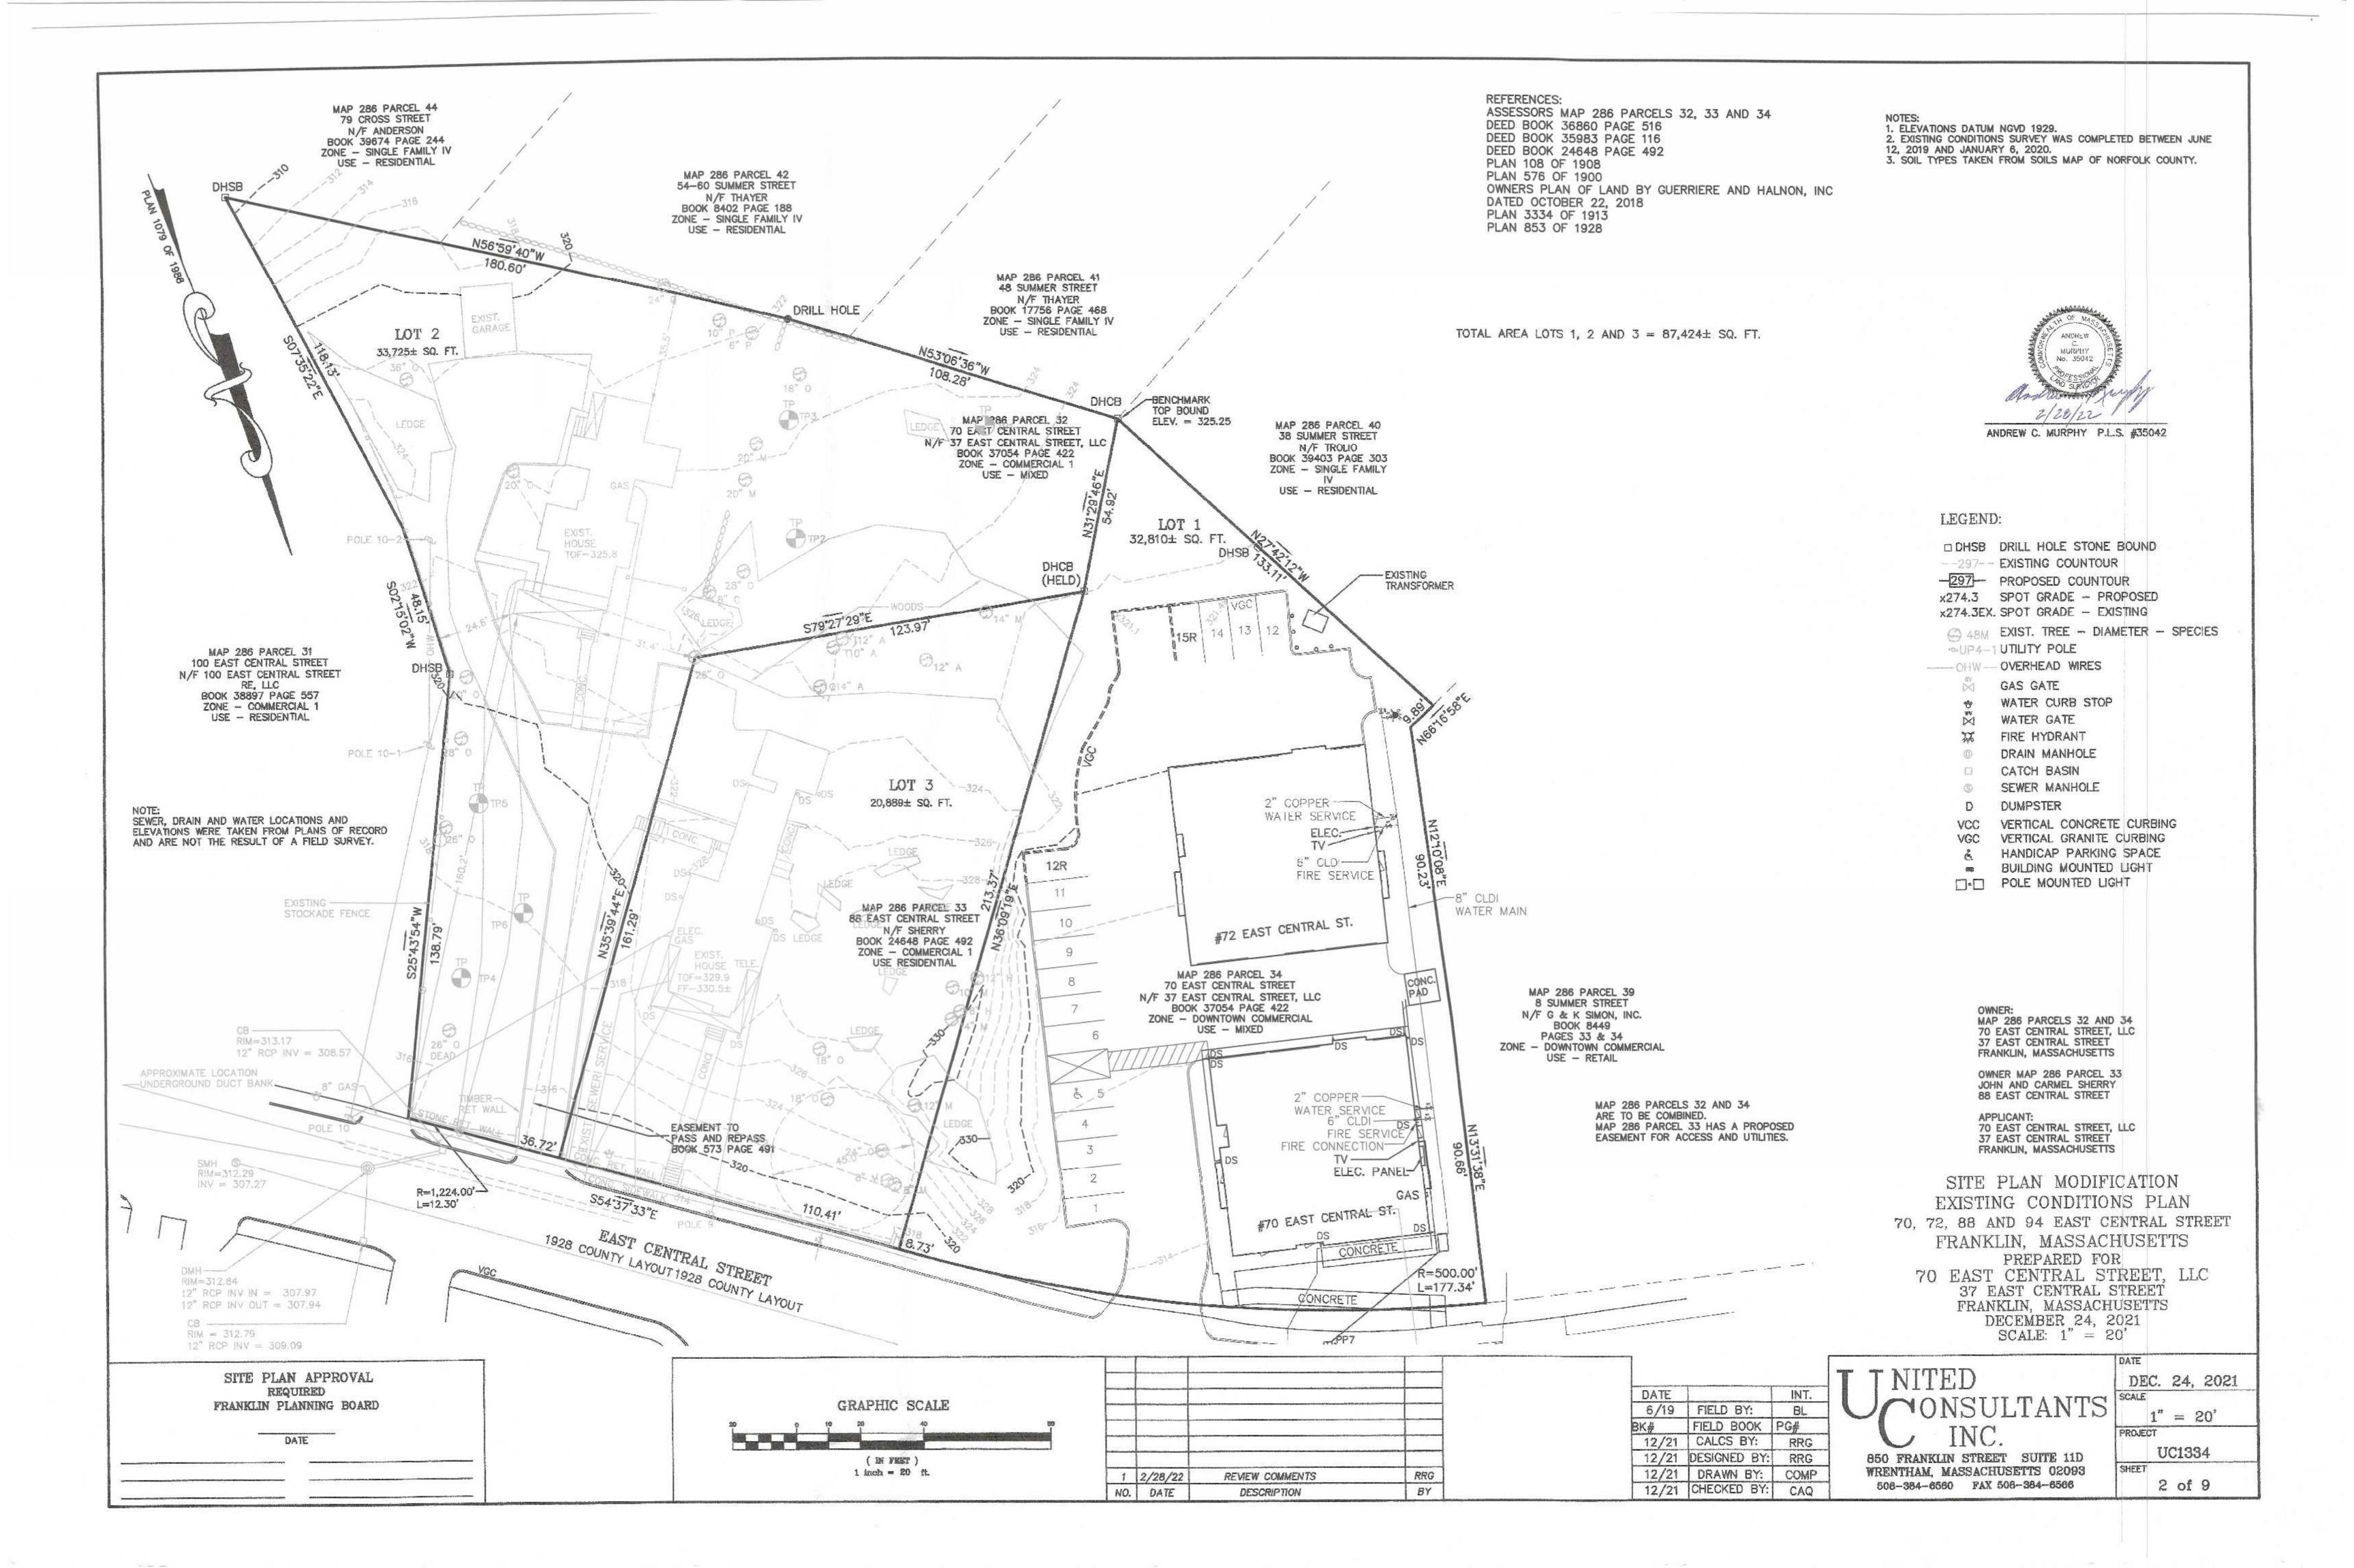

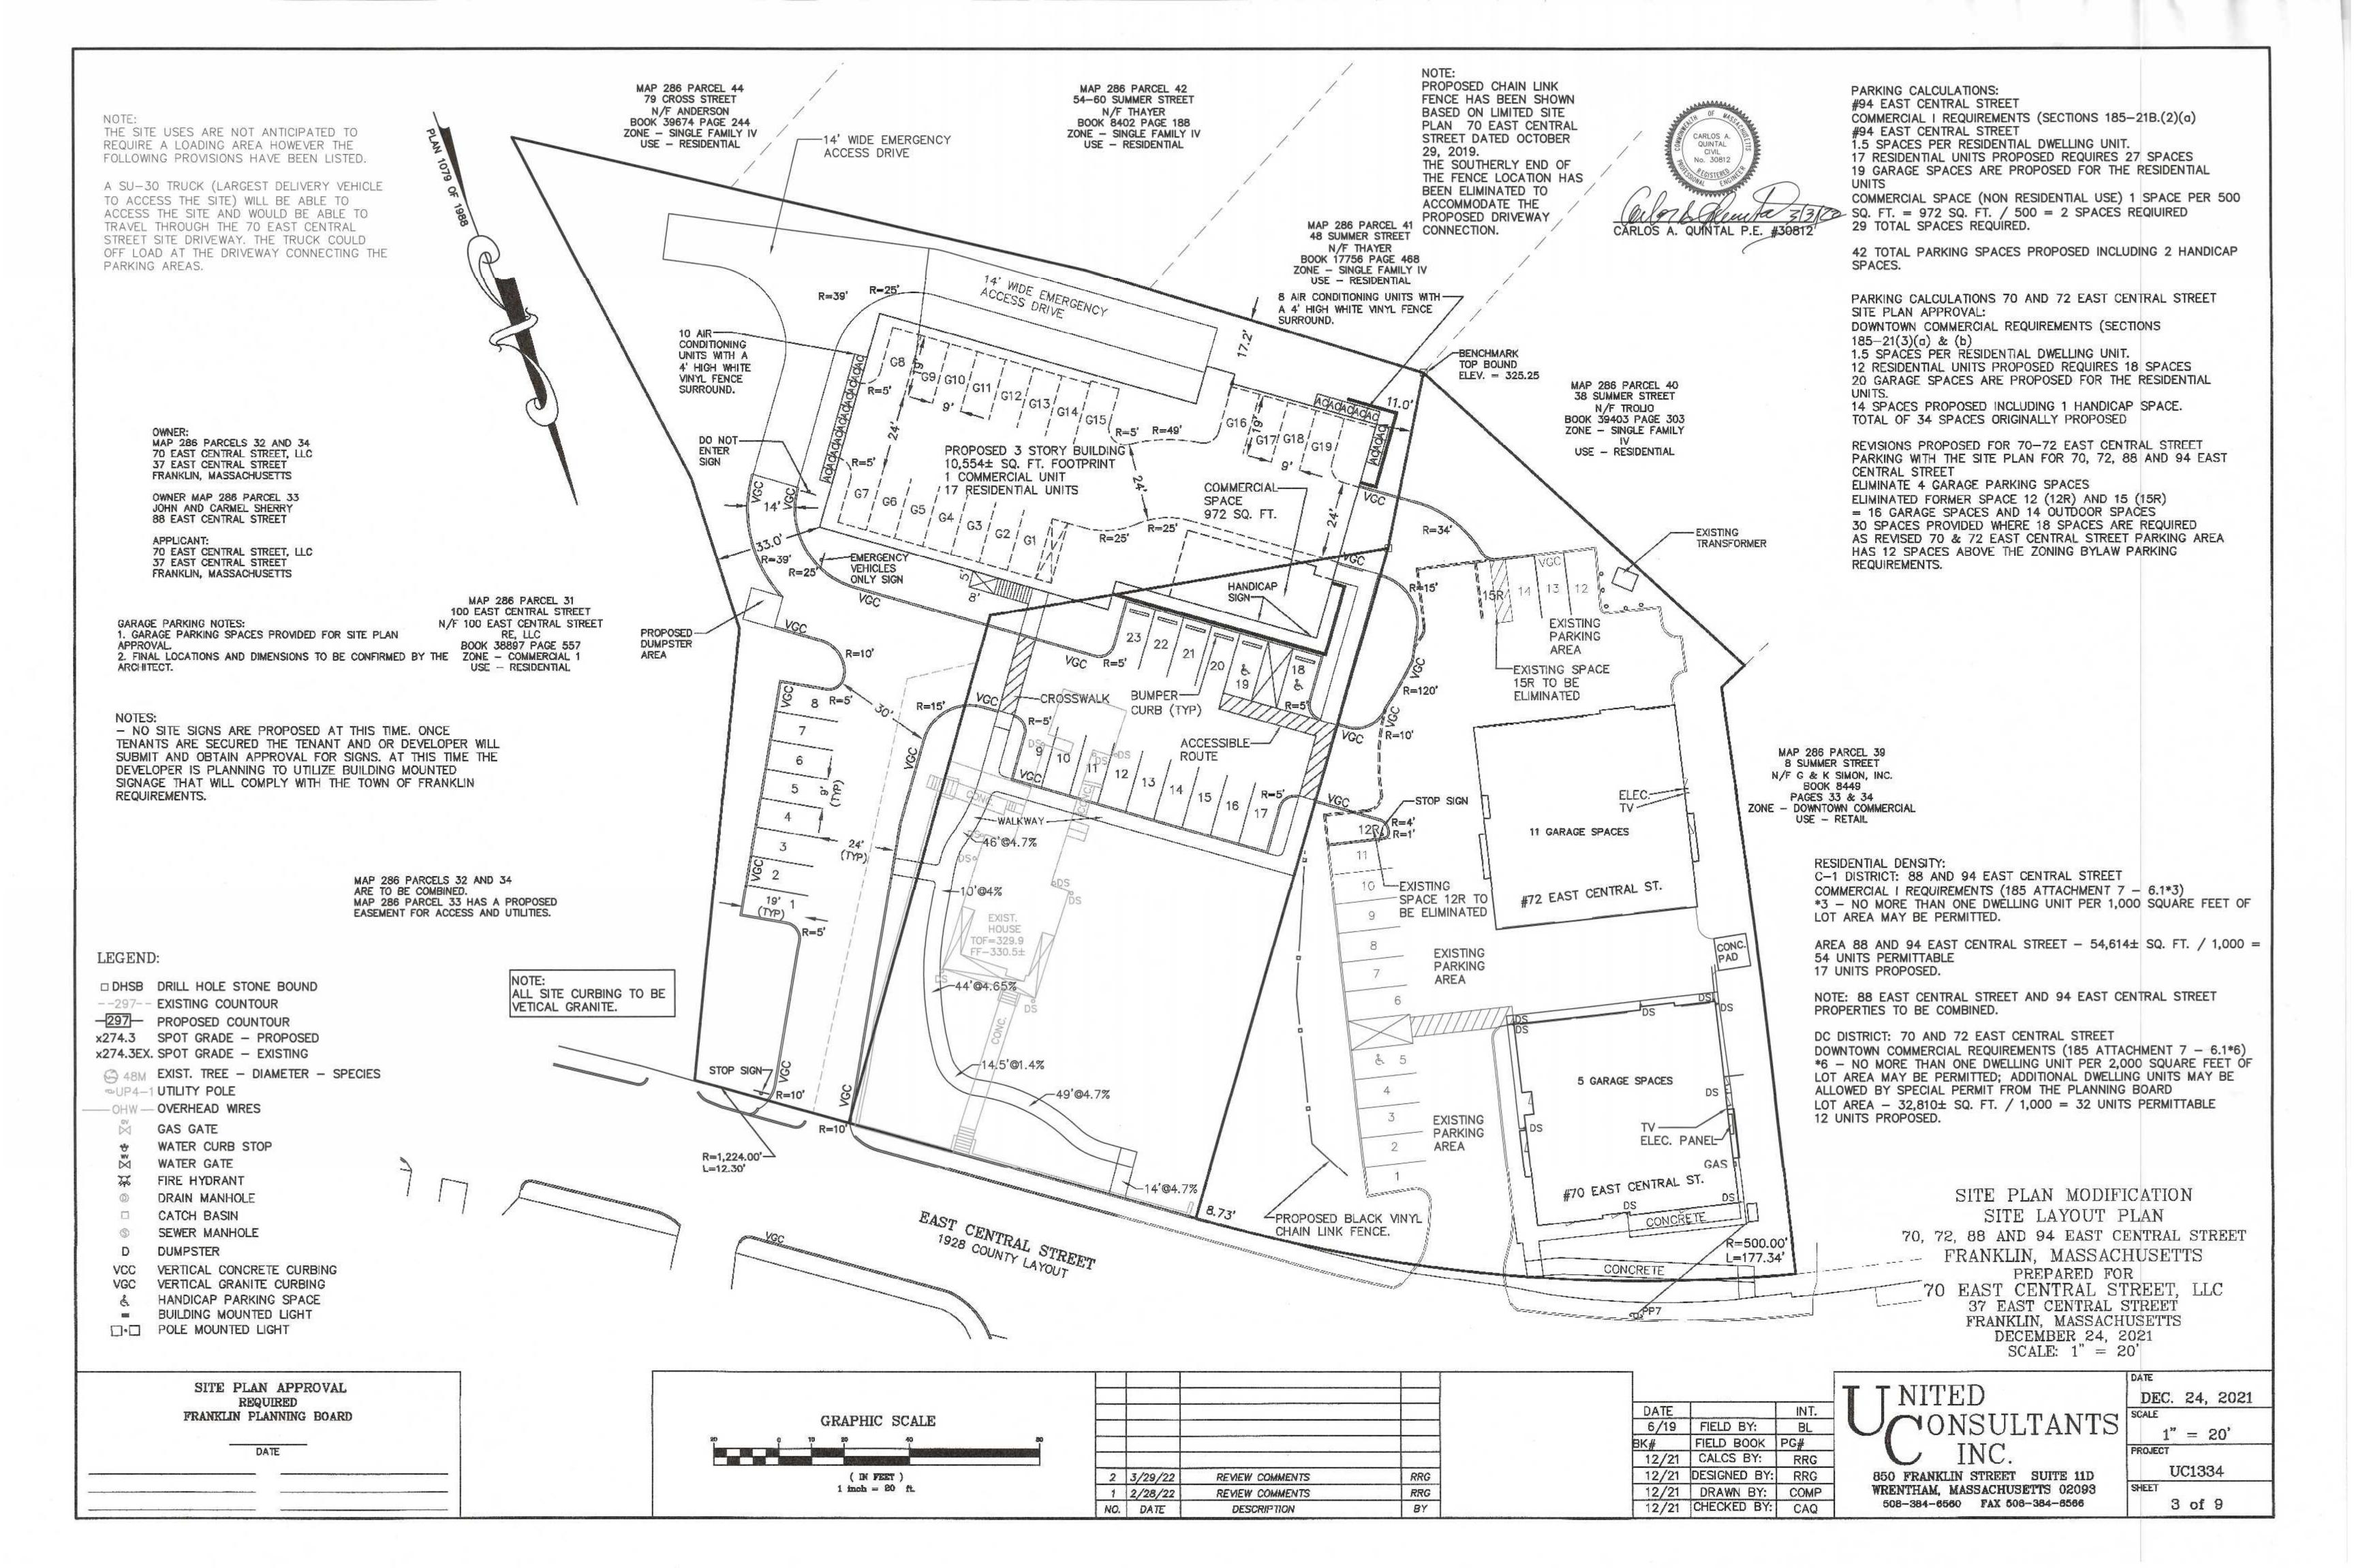

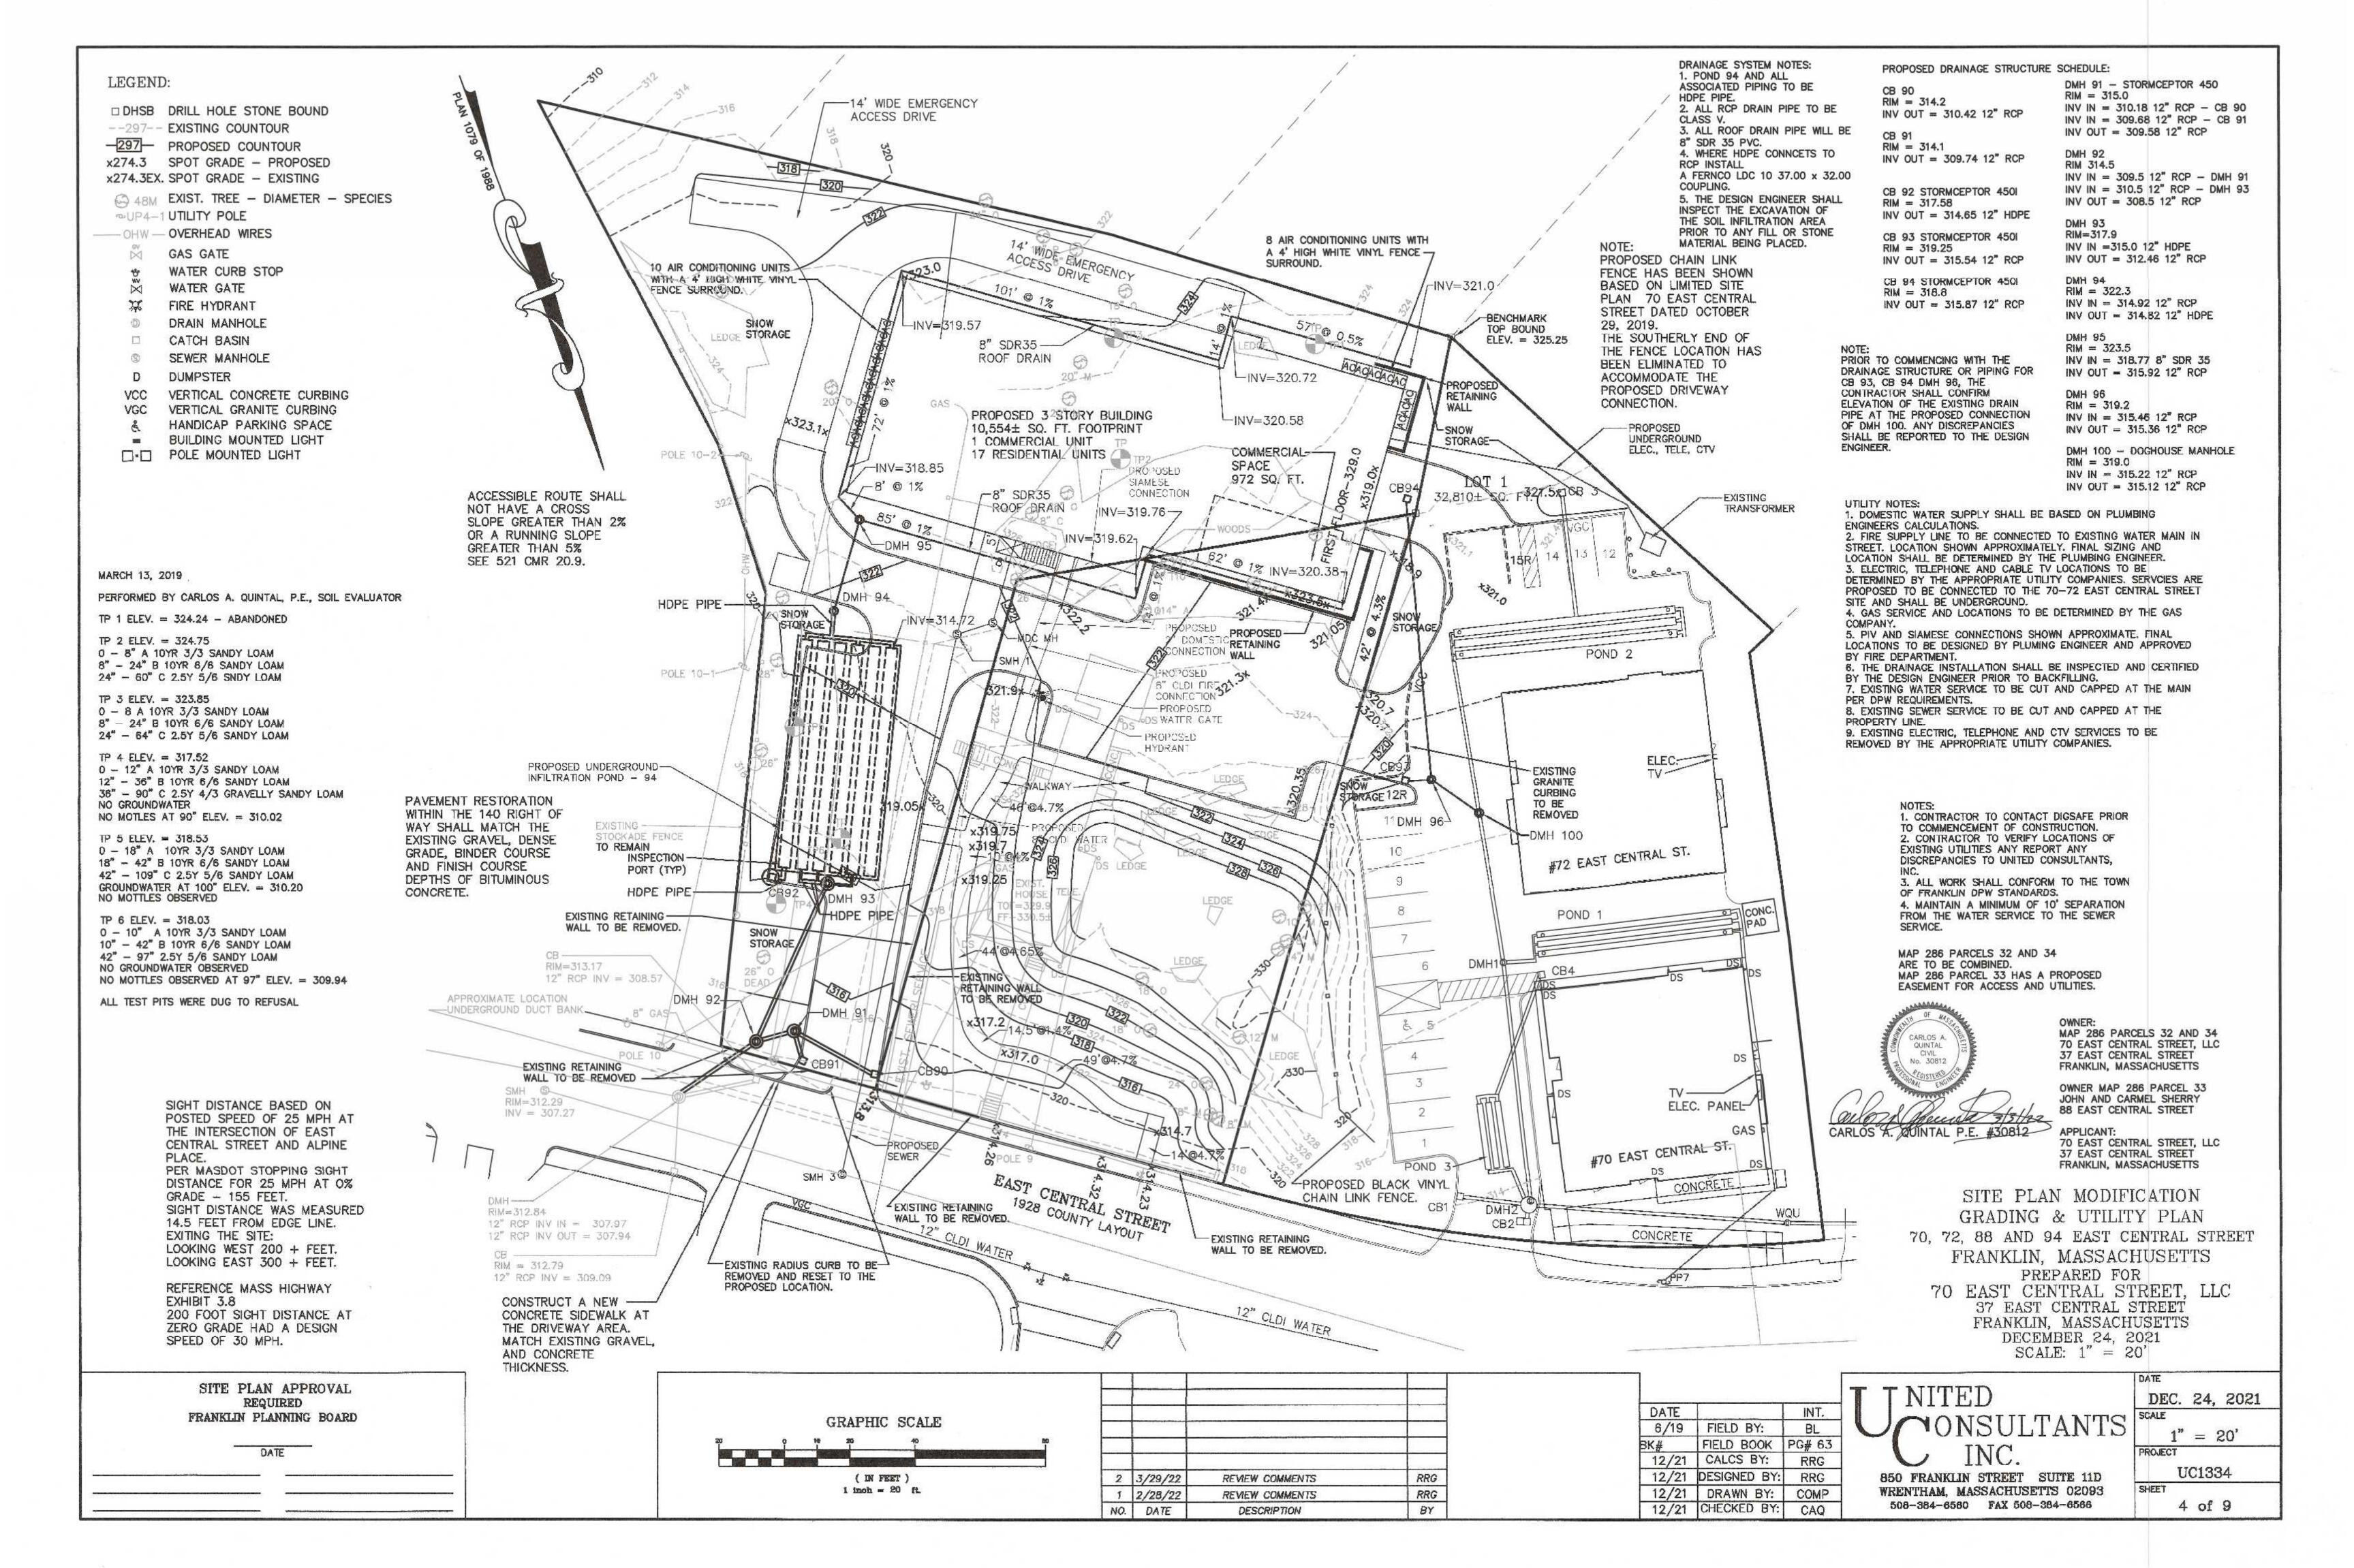

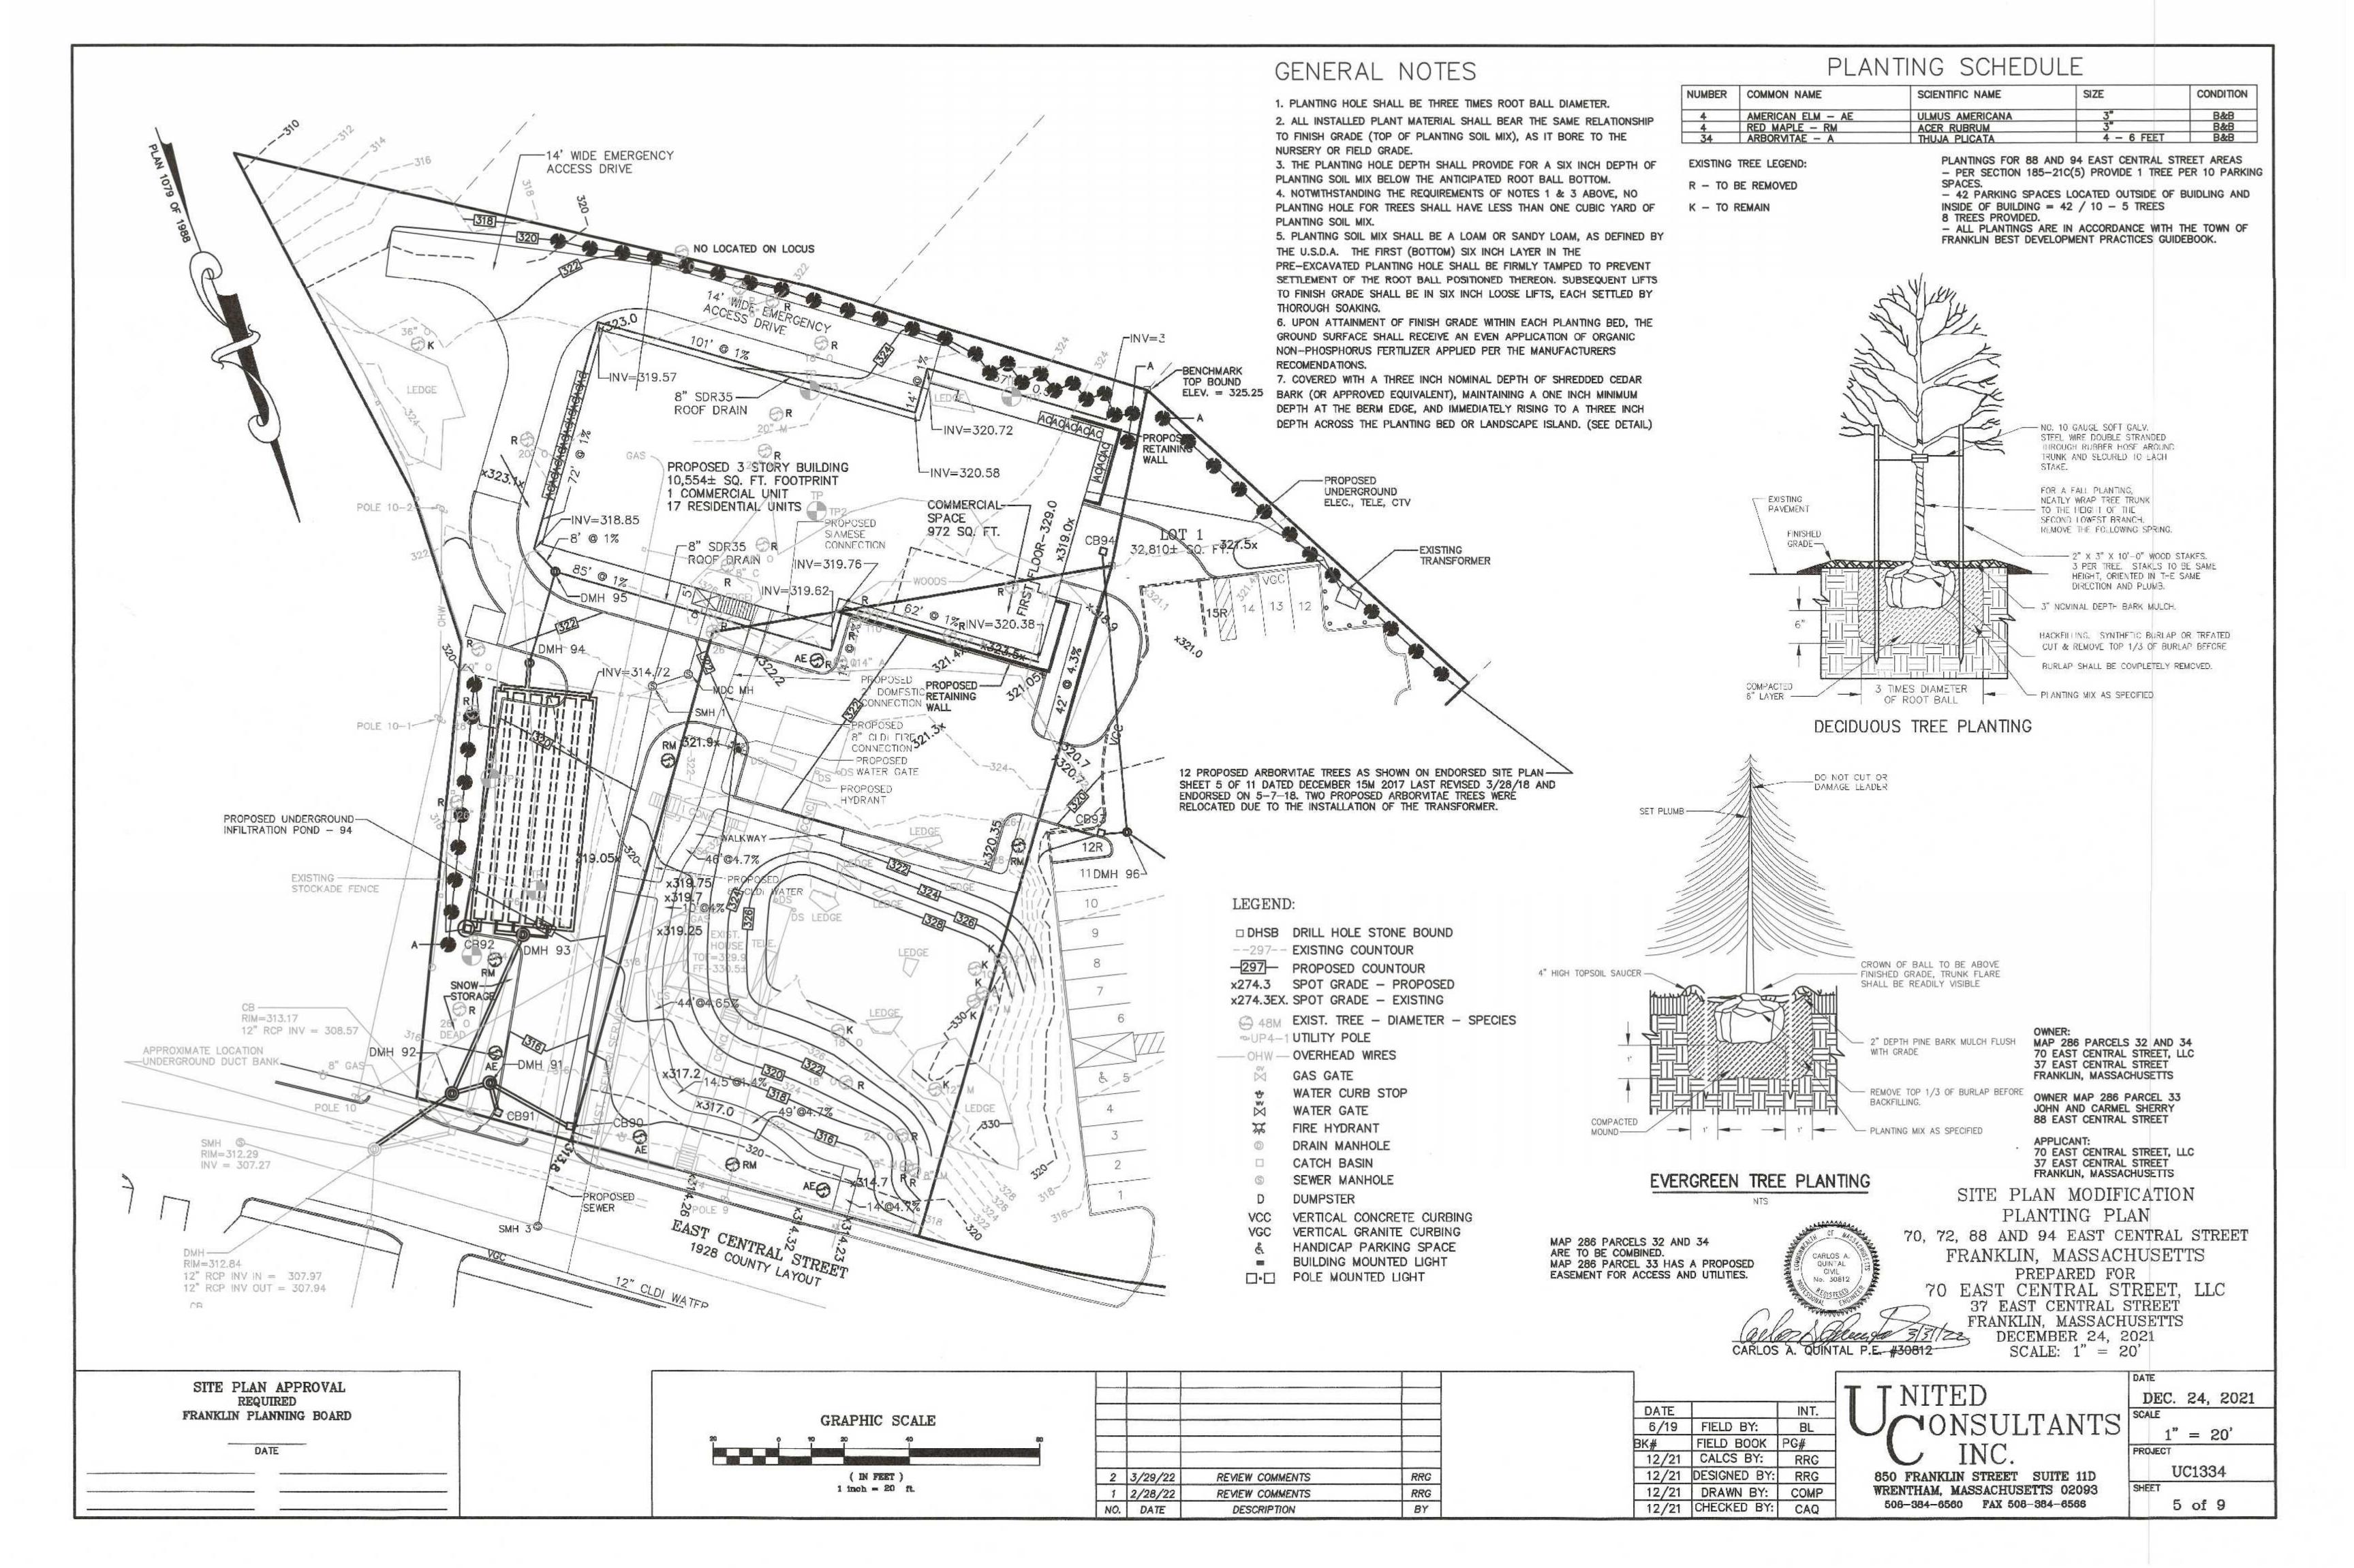

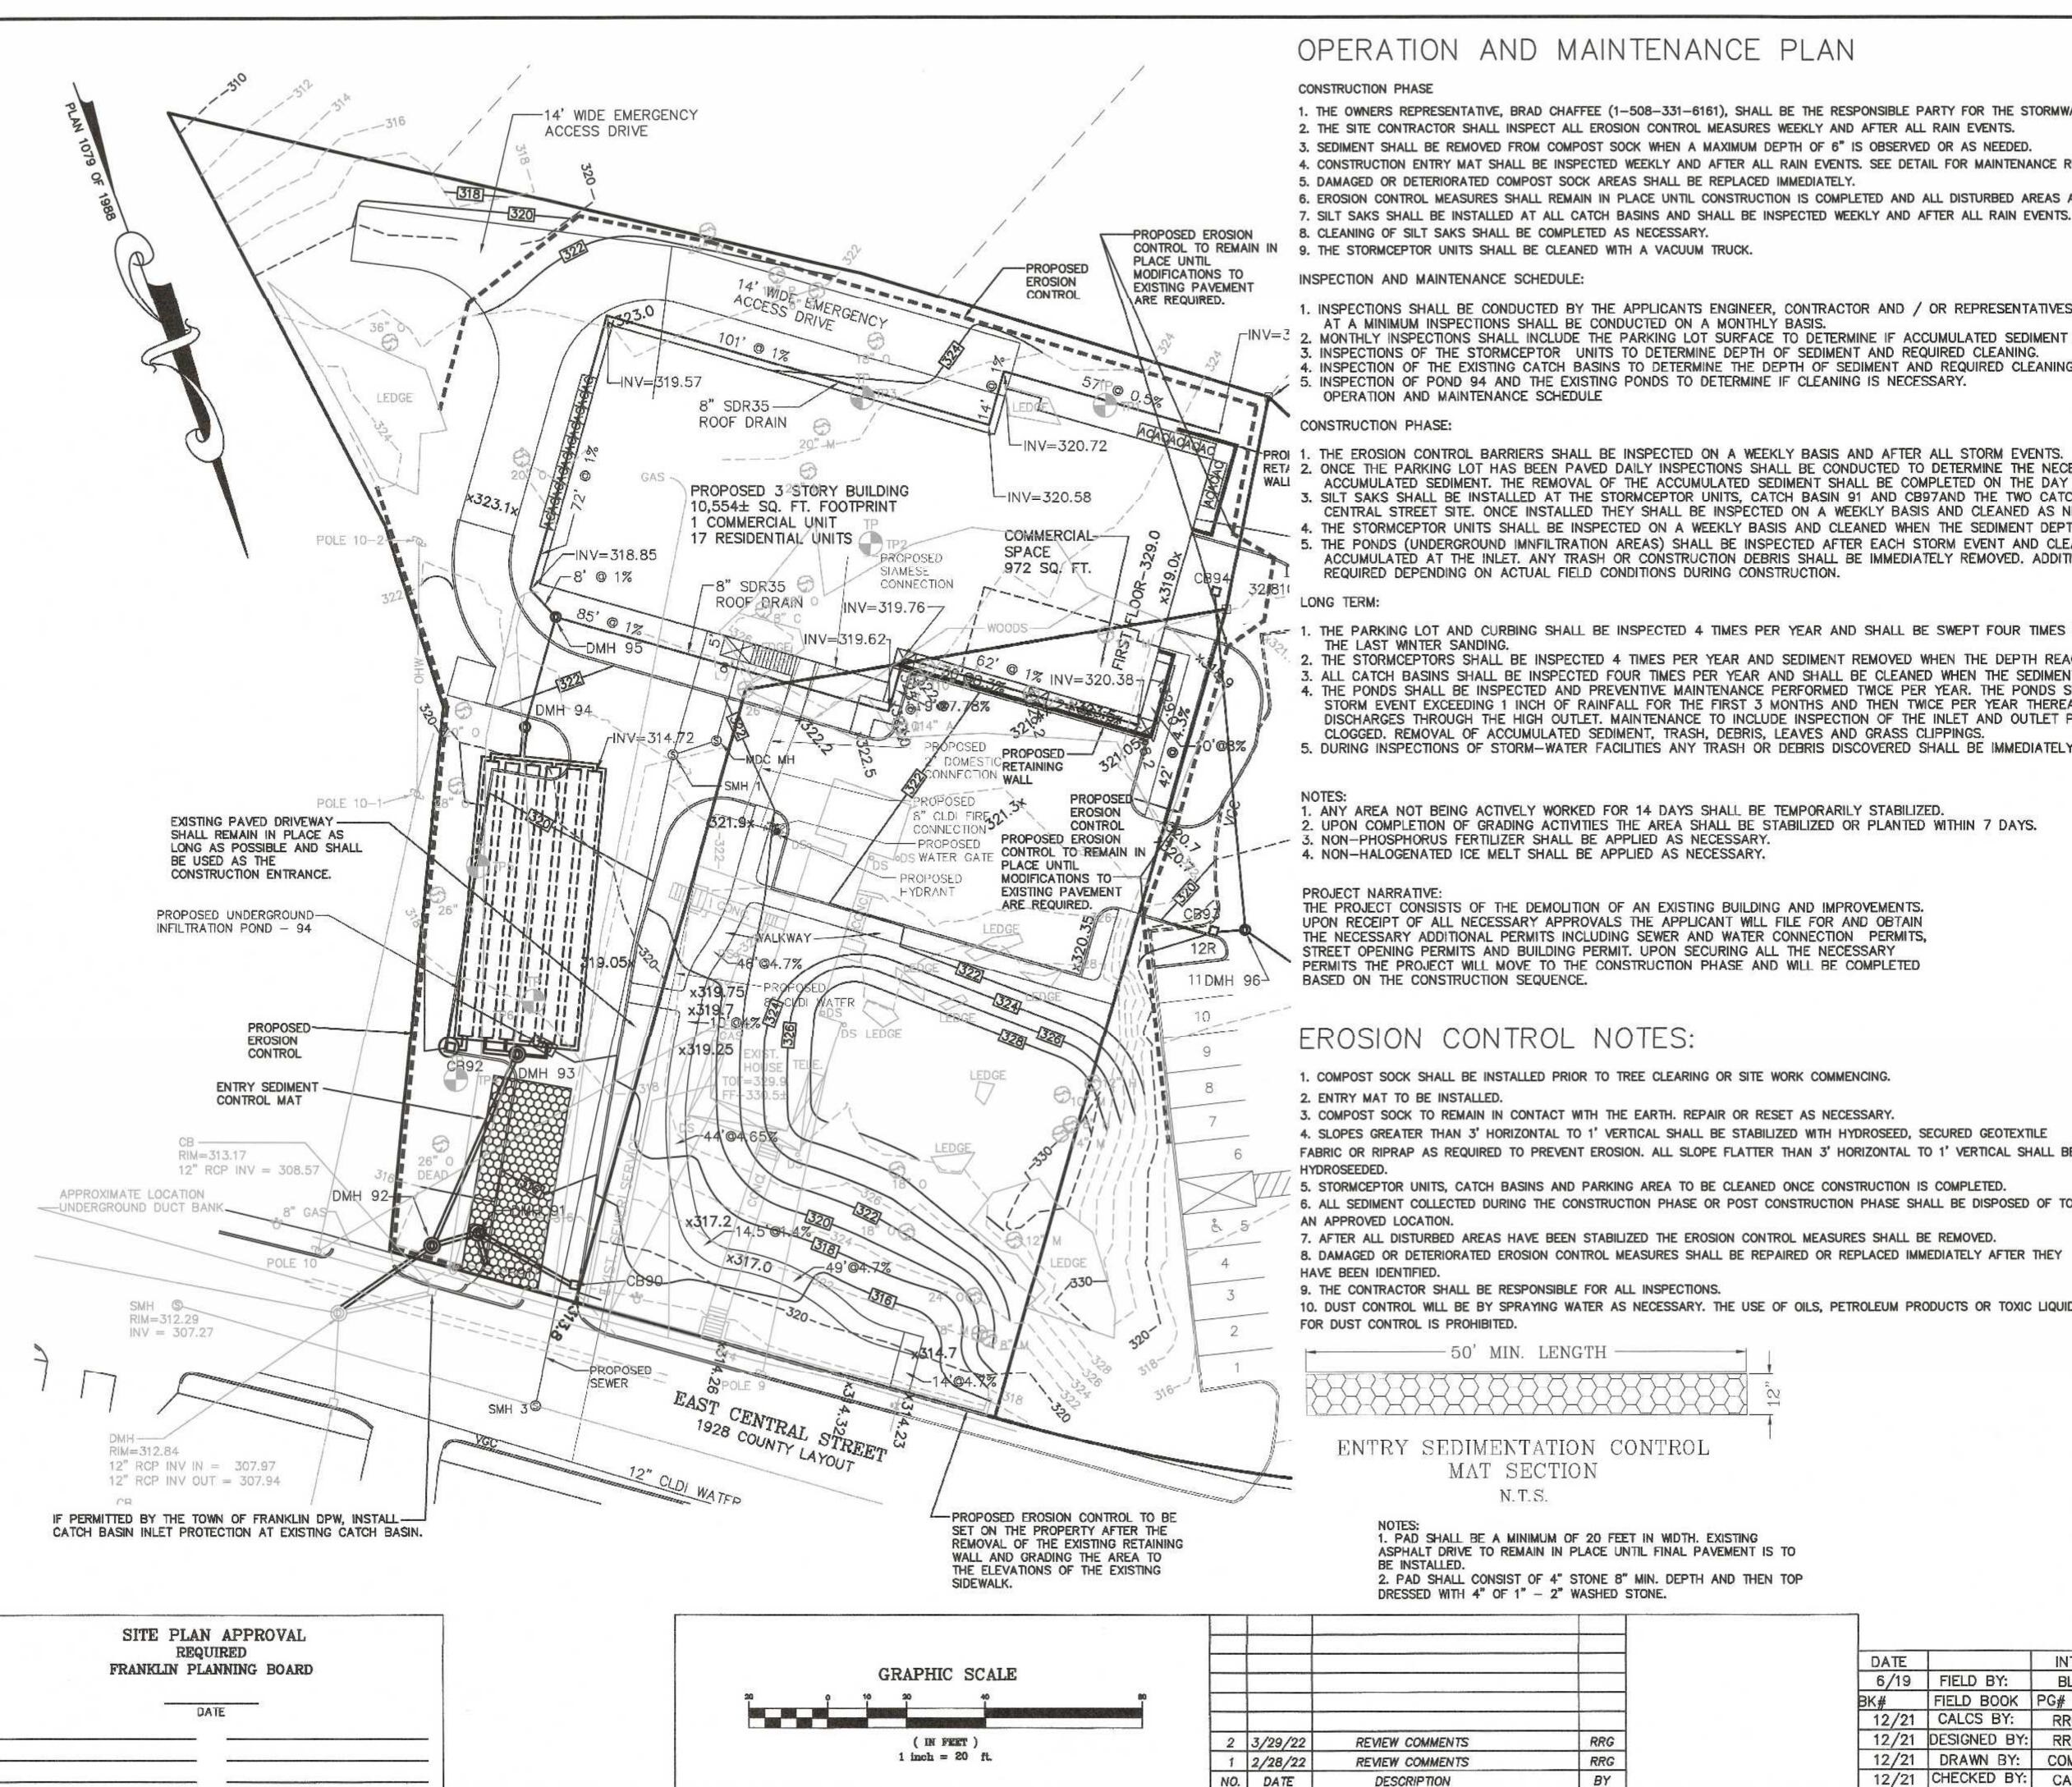

OPERATION AND MAINTENANCE PLAN

- 1. THE OWNERS REPRESENTATIVE, BRAD CHAFFEE (1-508-331-6161), SHALL BE THE RESPONSIBLE PARTY FOR THE STORMWATER MAINTENANCE PLAN.
- 2. THE SITE CONTRACTOR SHALL INSPECT ALL EROSION CONTROL MEASURES WEEKLY AND AFTER ALL RAIN EVENTS.
- SEDIMENT SHALL BE REMOVED FROM COMPOST SOCK WHEN A MAXIMUM DEPTH OF 6" IS OBSERVED OR AS NEEDED.
- 4. CONSTRUCTION ENTRY MAT SHALL BE INSPECTED WEEKLY AND AFTER ALL RAIN EVENTS. SEE DETAIL FOR MAINTENANCE REQUIREMENTS.
- 5. DAMAGED OR DETERIORATED COMPOST SOCK AREAS SHALL BE REPLACED IMMEDIATELY.
- 6. EROSION CONTROL MEASURES SHALL REMAIN IN PLACE UNTIL CONSTRUCTION IS COMPLETED AND ALL DISTURBED AREAS ARE STABILIZED.
- CLEANING OF SILT SAKS SHALL BE COMPLETED AS NECESSARY.
- CONTROL TO REMAIN IN 9. THE STORMCEPTOR UNITS SHALL BE CLEANED WITH A VACUUM TRUCK.

INSPECTION AND MAINTENANCE SCHEDULE:


- 1. INSPECTIONS SHALL BE CONDUCTED BY THE APPLICANTS ENGINEER, CONTRACTOR AND / OR REPRESENTATIVES OF THE TOWN AS NECESSARY. AT A MINIMUM INSPECTIONS SHALL BE CONDUCTED ON A MONTHLY BASIS.
- 2. MONTHLY INSPECTIONS SHALL INCLUDE THE PARKING LOT SURFACE TO DETERMINE IF ACCUMULATED SEDIMENT ARE TO BE REMOVED.
- 3. INSPECTIONS OF THE STORMCEPTOR UNITS TO DETERMINE DEPTH OF SEDIMENT AND REQUIRED CLEANING.
- 4. INSPECTION OF THE EXISTING CATCH BASINS TO DETERMINE THE DEPTH OF SEDIMENT AND REQUIRED CLEANING.
- 5. INSPECTION OF POND 94 AND THE EXISTING PONDS TO DETERMINE IF CLEANING IS NECESSARY. OPERATION AND MAINTENANCE SCHEDULE

- PPROI 1. THE EROSION CONTROL BARRIERS SHALL BE INSPECTED ON A WEEKLY BASIS AND AFTER ALL STORM EVENTS.
- RET/ 2. ONCE THE PARKING LOT HAS BEEN PAVED DAILY INSPECTIONS SHALL BE CONDUCTED TO DETERMINE THE NECESSITY TO REMOVE ANY
 - ACCUMULATED SEDIMENT. THE REMOVAL OF THE ACCUMULATED SEDIMENT SHALL BE COMPLETED ON THE DAY THE DETERMINATION IS MADE. 3. SILT SAKS SHALL BE INSTALLED AT THE STORMCEPTOR UNITS, CATCH BASIN 91 AND CB97AND THE TWO CATCH BASINS ON 70 - 72 EAST
 - CENTRAL STREET SITE. ONCE INSTALLED THEY SHALL BE INSPECTED ON A WEEKLY BASIS AND CLEANED AS NECESSARY. 4. THE STORMCEPTOR UNITS SHALL BE INSPECTED ON A WEEKLY BASIS AND CLEANED WHEN THE SEDIMENT DEPTH REACHES 8"
 - 5. THE PONDS (UNDERGROUND IMNFILTRATION AREAS) SHALL BE INSPECTED AFTER EACH STORM EVENT AND CLEANED WHEN 2" OF SEDIMENT HAS
 - ACCUMULATED AT THE INLET, ANY TRASH OR CONSTRUCTION DEBRIS SHALL BE IMMEDIATELY REMOVED, ADDITIONAL EROSION CONTROLS MAY BE REQUIRED DEPENDING ON ACTUAL FIELD CONDITIONS DURING CONSTRUCTION.
- 1. THE PARKING LOT AND CURBING SHALL BE INSPECTED 4 TIMES PER YEAR AND SHALL BE SWEPT FOUR TIMES PER YEAR WITH ONE BEING AFTER
 - 2. THE STORMCEPTORS SHALL BE INSPECTED 4 TIMES PER YEAR AND SEDIMENT REMOVED WHEN THE DEPTH REACHES 8 INCHES
- 3. ALL CATCH BASINS SHALL BE INSPECTED FOUR TIMES PER YEAR AND SHALL BE CLEANED WHEN THE SEDIMENT DEPTH IS 18"
- 4. THE PONDS SHALL BE INSPECTED AND PREVENTIVE MAINTENANCE PERFORMED TWICE PER YEAR. THE PONDS SHALL BE INSPECTED AFTER EVERY STORM EVENT EXCEEDING 1 INCH OF RAINFALL FOR THE FIRST 3 MONTHS AND THEN TWICE PER YEAR THEREAFTER AND WHEN THERE ARE DISCHARGES THROUGH THE HIGH OUTLET. MAINTENANCE TO INCLUDE INSPECTION OF THE INLET AND OUTLET PIPES TO DETERMINE IF THEY ARE CLOGGED, REMOVAL OF ACCUMULATED SEDIMENT, TRASH, DEBRIS, LEAVES AND GRASS CLIPPINGS.
- 5. DURING INSPECTIONS OF STORM-WATER FACILITIES ANY TRASH OR DEBRIS DISCOVERED SHALL BE IMMEDIATELY REMOVED.
- 1. ANY AREA NOT BEING ACTIVELY WORKED FOR 14 DAYS SHALL BE TEMPORARILY STABILIZED.
- 2. UPON COMPLETION OF GRADING ACTIVITIES THE AREA SHALL BE STABILIZED OR PLANTED WITHIN 7 DAYS.
- 3. NON-PHOSPHORUS FERTILIZER SHALL BE APPLIED AS NECESSARY.
- 4. NON-HALOGENATED ICE MELT SHALL BE APPLIED AS NECESSARY.

THE PROJECT CONSISTS OF THE DEMOLITION OF AN EXISTING BUILDING AND IMPROVEMENTS. UPON RECEIPT OF ALL NECESSARY APPROVALS THE APPLICANT WILL FILE FOR AND OBTAIN THE NECESSARY ADDITIONAL PERMITS INCLUDING SEWER AND WATER CONNECTION PERMITS, STREET OPENING PERMITS AND BUILDING PERMIT. UPON SECURING ALL THE NECESSARY PERMITS THE PROJECT WILL MOVE TO THE CONSTRUCTION PHASE AND WILL BE COMPLETED BASED ON THE CONSTRUCTION SEQUENCE.

EROSION CONTROL NOTES:

- 1. COMPOST SOCK SHALL BE INSTALLED PRIOR TO TREE CLEARING OR SITE WORK COMMENCING.
- 2. ENTRY MAT TO BE INSTALLED.
- 3. COMPOST SOCK TO REMAIN IN CONTACT WITH THE EARTH. REPAIR OR RESET AS NECESSARY.
- 4. SLOPES GREATER THAN 3' HORIZONTAL TO 1' VERTICAL SHALL BE STABILIZED WITH HYDROSEED, SECURED GEOTEXTILE FABRIC OR RIPRAP AS REQUIRED TO PREVENT EROSION. ALL SLOPE FLATTER THAN 3' HORIZONTAL TO 1' VERTICAL SHALL BE
- 5. STORMCEPTOR UNITS, CATCH BASINS AND PARKING AREA TO BE CLEANED ONCE CONSTRUCTION IS COMPLETED.
- 6. ALL SEDIMENT COLLECTED DURING THE CONSTRUCTION PHASE OR POST CONSTRUCTION PHASE SHALL BE DISPOSED OF TO AN APPROVED LOCATION.
- 7. AFTER ALL DISTURBED AREAS HAVE BEEN STABILIZED THE EROSION CONTROL MEASURES SHALL BE REMOVED.
- 8. DAMAGED OR DETERIORATED EROSION CONTROL MEASURES SHALL BE REPAIRED OR REPLACED IMMEDIATELY AFTER THEY HAVE BEEN IDENTIFIED.
- 9. THE CONTRACTOR SHALL BE RESPONSIBLE FOR ALL INSPECTIONS.
- 10. DUST CONTROL WILL BE BY SPRAYING WATER AS NECESSARY. THE USE OF OILS, PETROLEUM PRODUCTS OR TOXIC LIQUIDS FOR DUST CONTROL IS PROHIBITED.

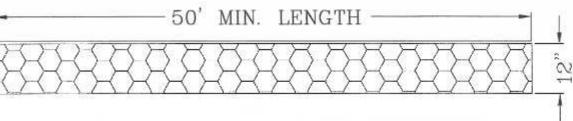

ENTRY SEDIMENTATION CONTROL MAT SECTION

N.T.S.

1. PAD SHALL BE A MINIMUM OF 20 FEET IN WIDTH, EXISTING ASPHALT DRIVE TO REMAIN IN PLACE UNTIL FINAL PAVEMENT IS TO 2. PAD SHALL CONSIST OF 4" STONE 8" MIN. DEPTH AND THEN TOP

DRESSED WITH 4" OF 1" - 2" WASHED STONE.

RRG

RRG

INT. 6/19 | FIELD BY: BL FIELD BOOK PG# 12/21 | CALCS BY: RRG 12/21 DESIGNED BY: WRENTHAM, MASSACHUSETTS 02093 12/21 | DRAWN BY: COMP 508-384-6560 FAX 508-384-6566 12/21 CHECKED BY: CAQ

DATE

MAP 286 PARCELS 32 AND 34 70 EAST CENTRAL STREET, LLC 37 EAST CENTRAL STREET FRANKLIN, MASSACHUSETTS

A. QUINTAL P.E. #3081

OWNER MAP 286 PARCEL 33 JOHN AND CARMEL SHERRY 88 EAST CENTRAL STREET

APPLICANT: 70 EAST CENTRAL STREET, LLC 37 EAST CENTRAL STREET FRANKLIN, MASSACHUSETTS

SITE PLAN MODIFICATION EROSION CONTROL PLAN

BIODEGRADABLE

COMPOST SOCK DETAIL

SOCK - 12" DIAMETER

COMPOST

100% ORGANIC

TRAPPED SEDIMENT

70, 72, 88 AND 94 EAST CENTRAL STREET FRANKLIN, MASSACHUSETTS

PREPARED FOR 70 EAST CENTRAL STREET, LLC 37 EAST CENTRAL STREET FRANKLIN, MASSACHUSETTS DECEMBER 24, 2021


SCALE: 1'' = 20'


ONSULTANTS SCALE


DEC. 24, 2021 1'' = 20'PROJECT UC1334 SHEET


6 of 9


850 FRANKLIN STREET SUITE 11D

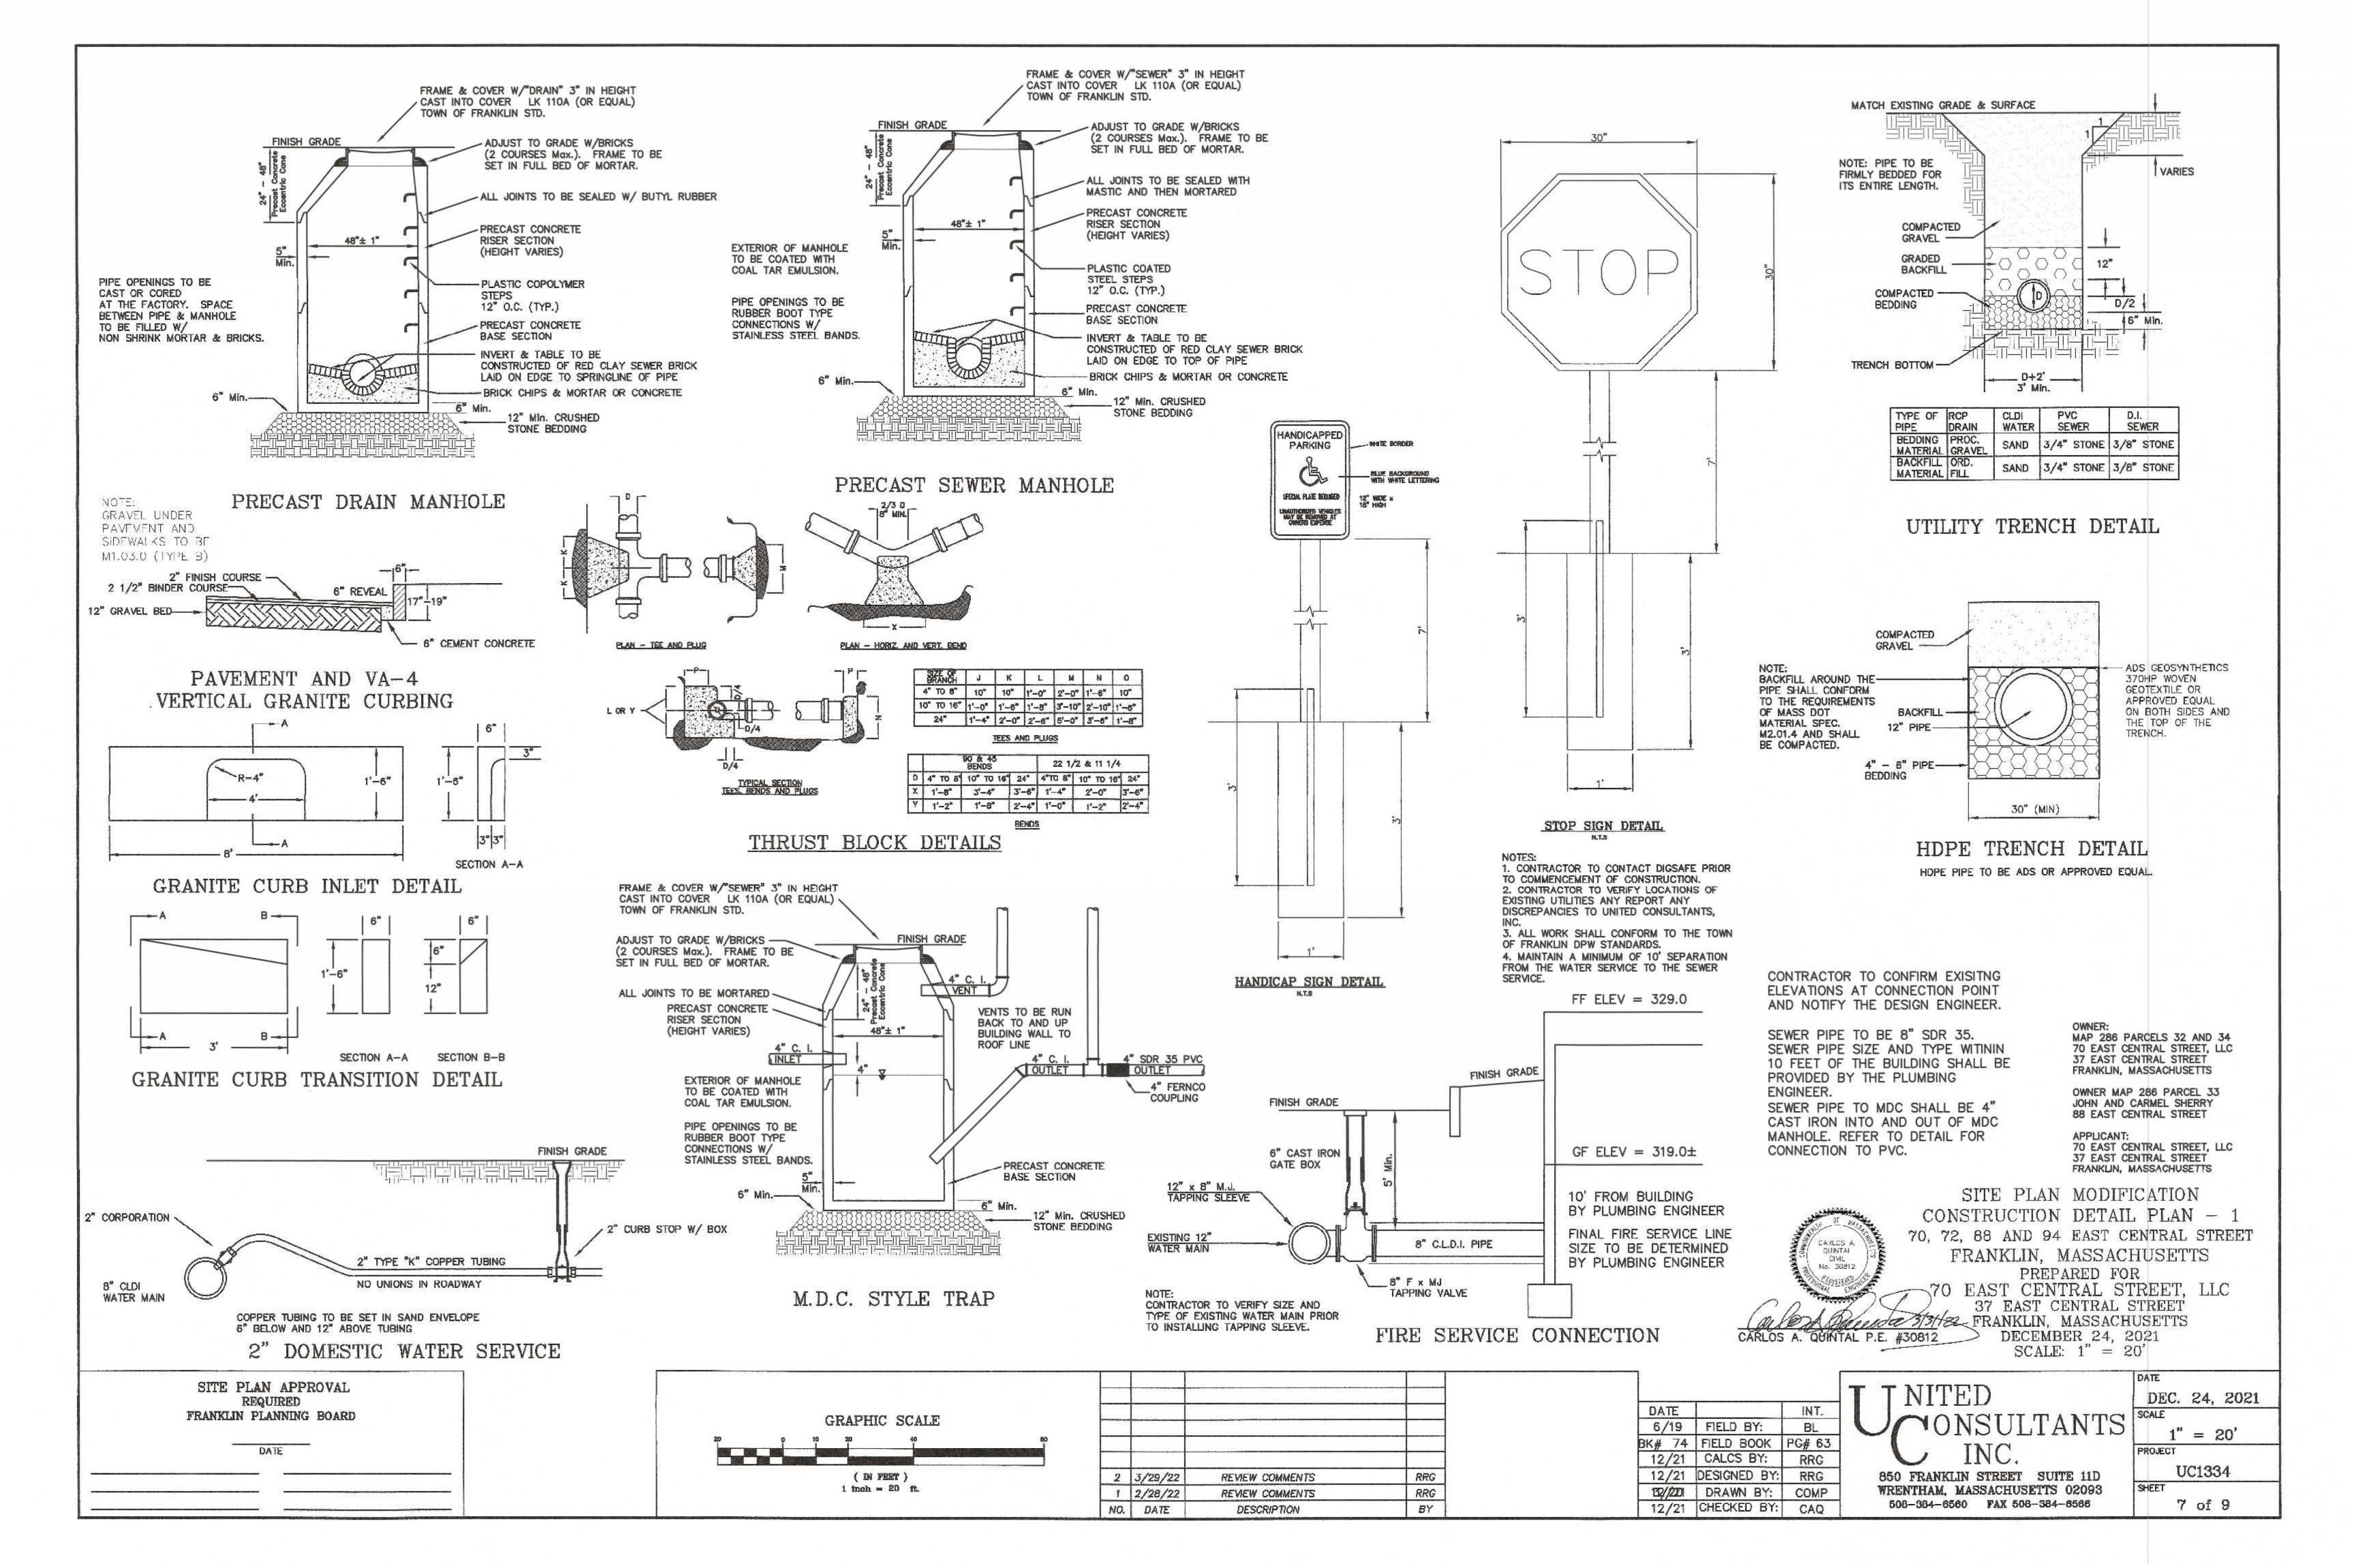

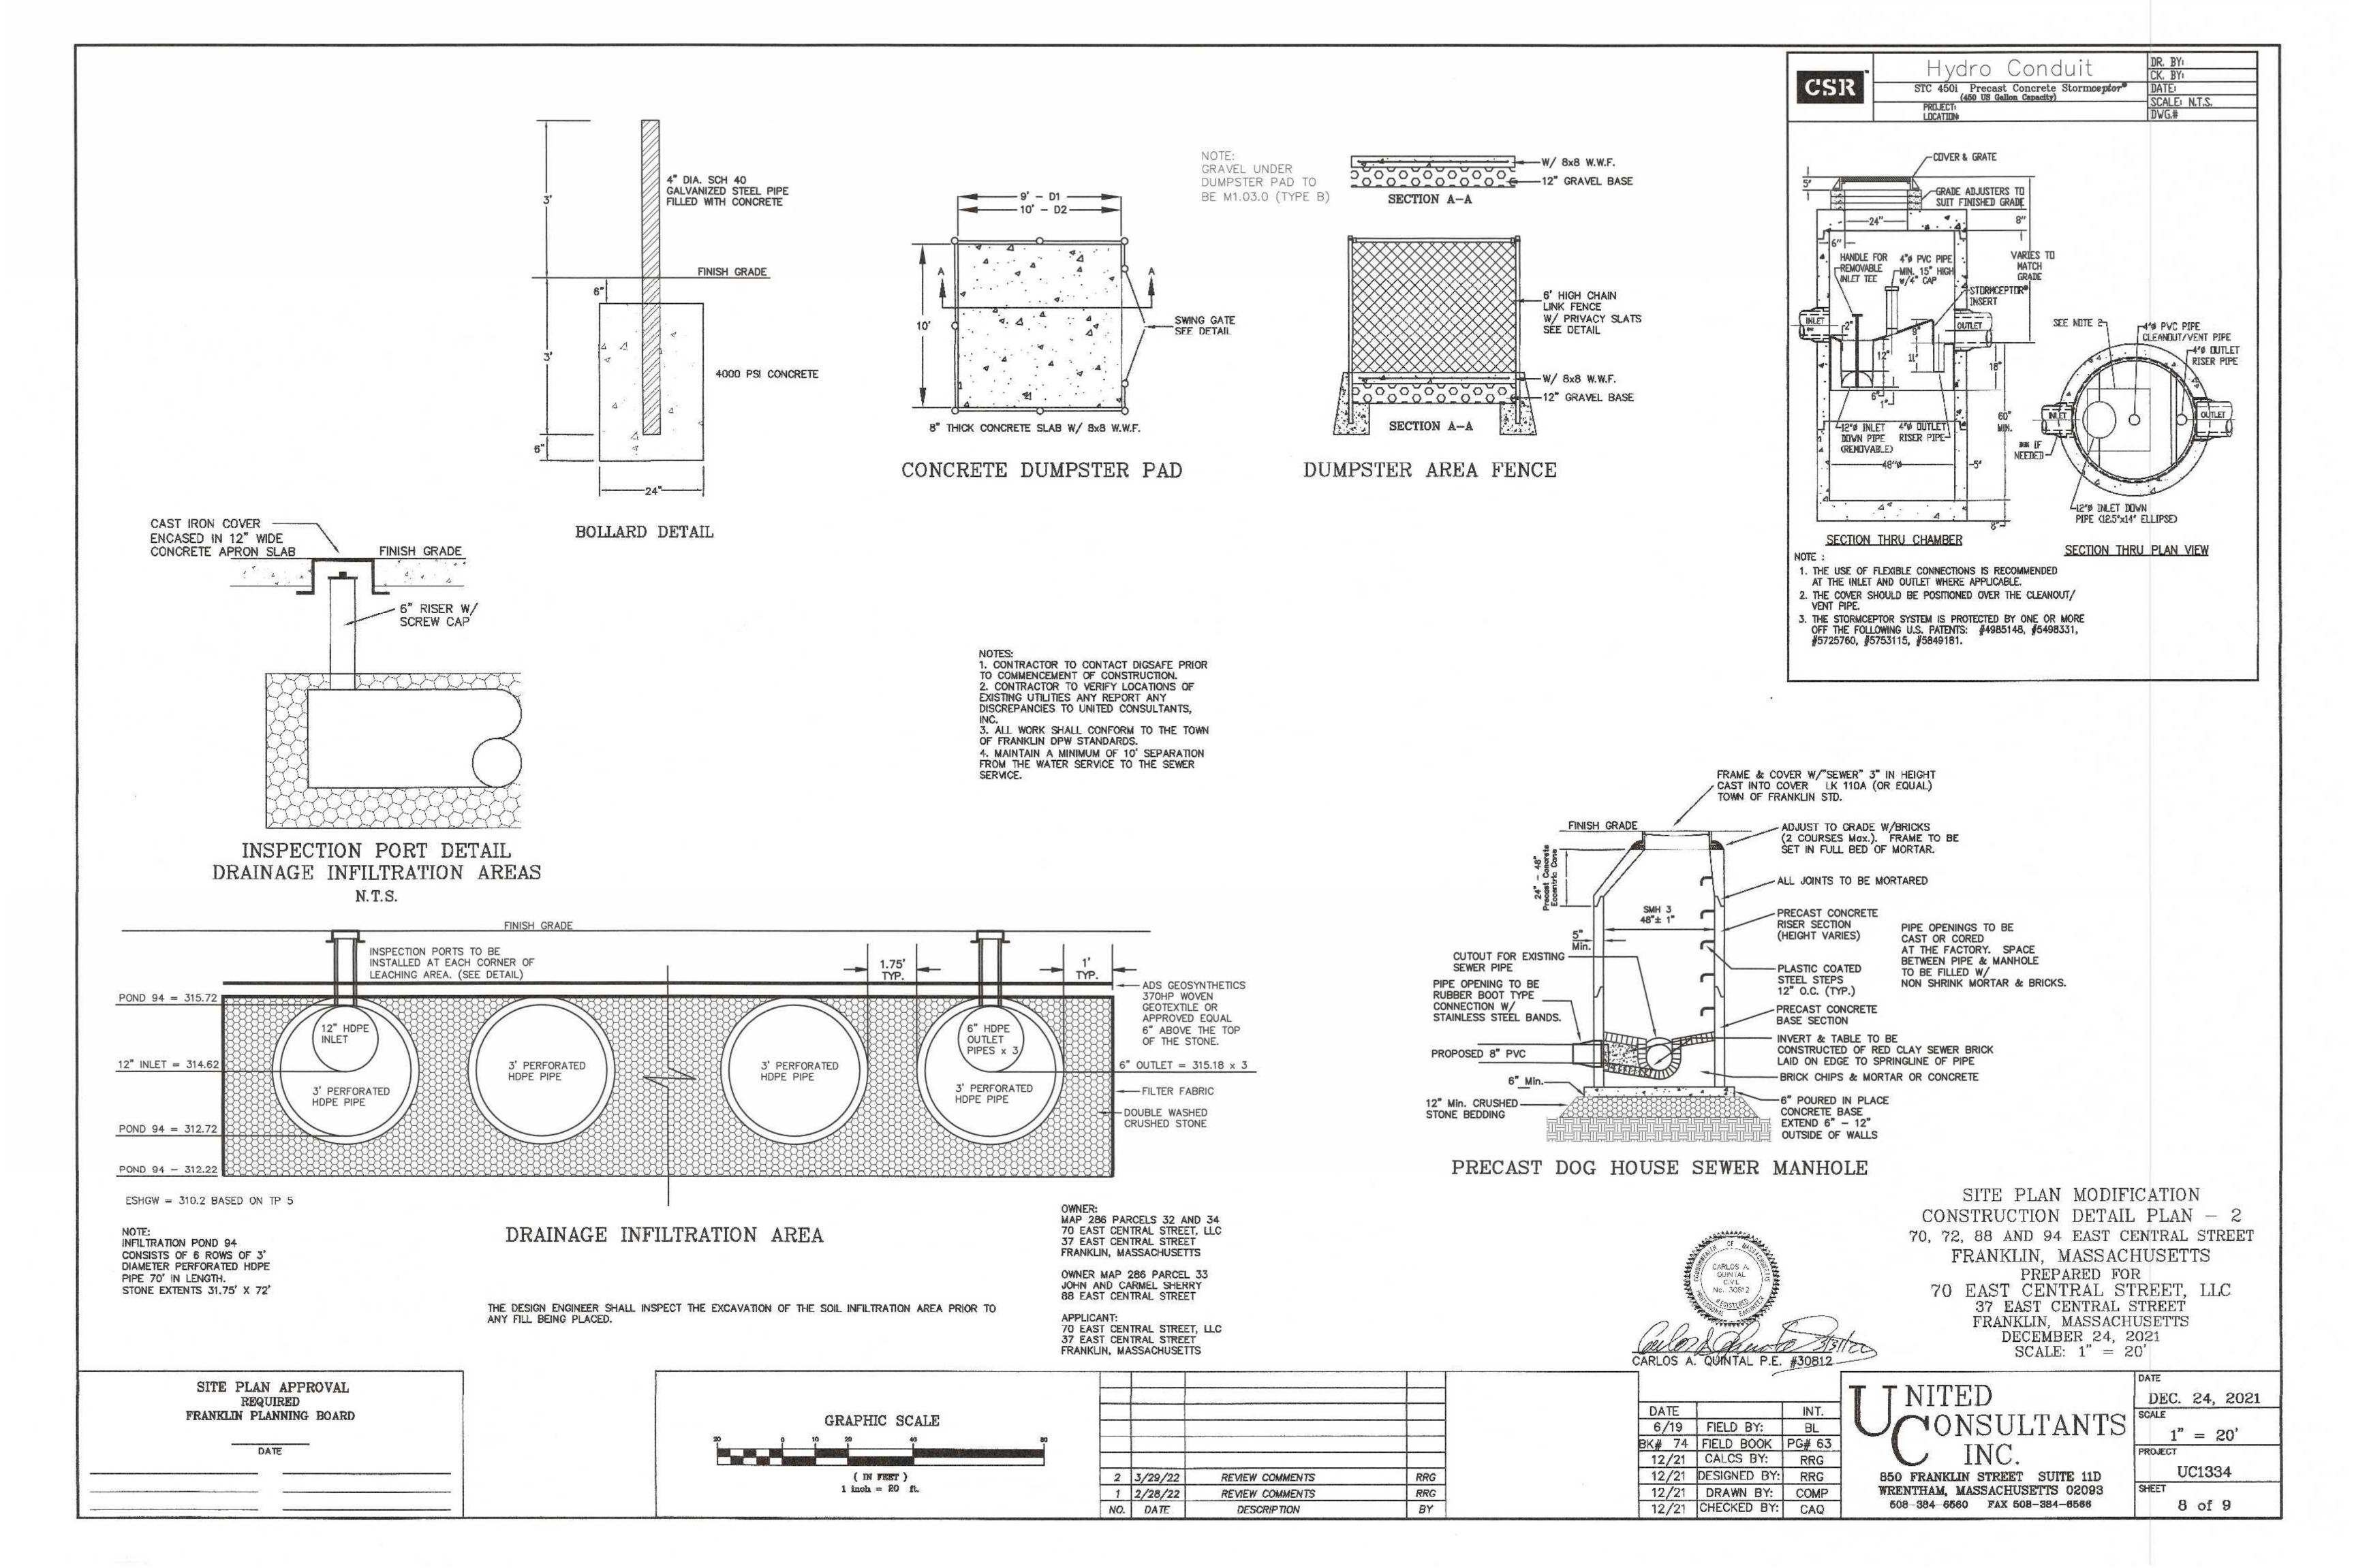


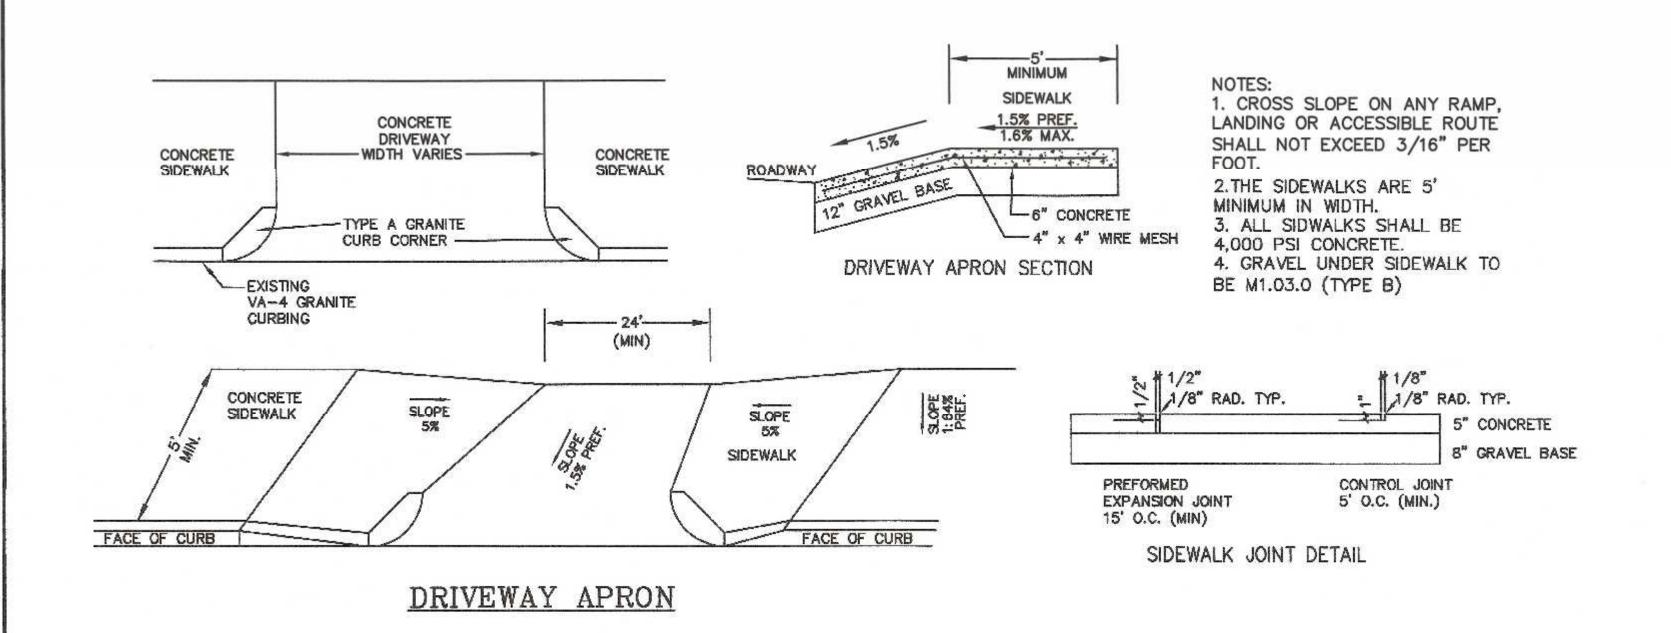

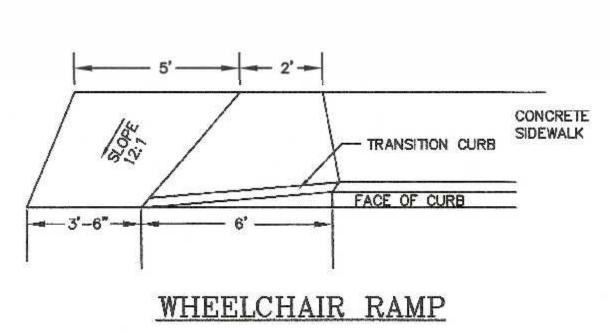


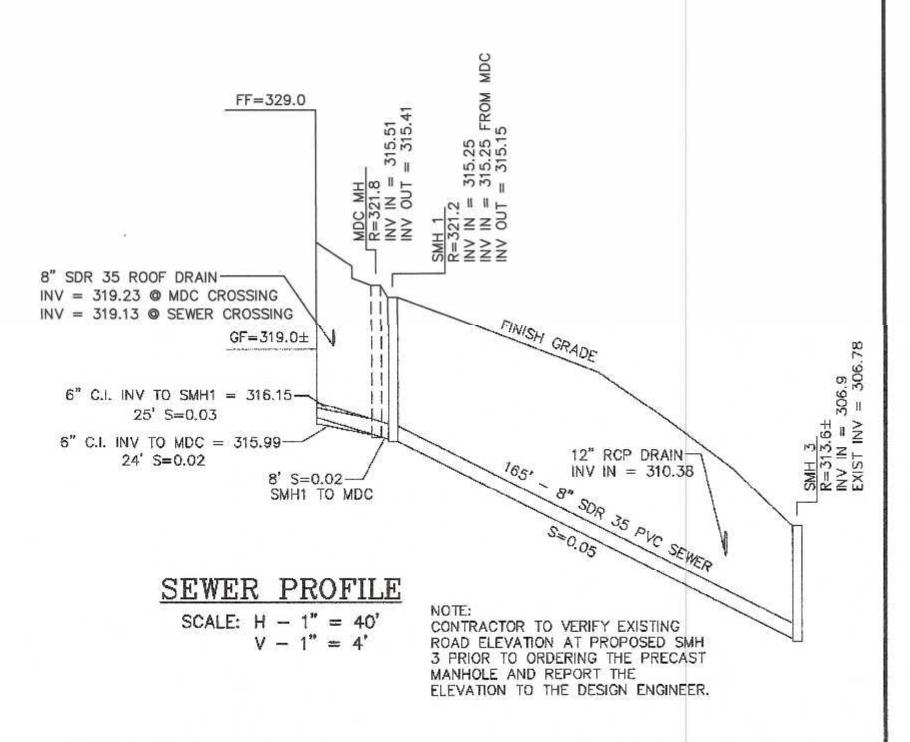

SEWER NOTE:
THE PROJECT PLUMBING ENGINEER SHALL CONFIRM THE
ELEVATIONS OF THE SEWER CONNECTIONS UPON COMPLETION
OF THE FLOOR DRAIN DESIGN. ANY REVISIONS SHALL BE
REPORTED TO THE DESIGN ENGINEER PRIOR TO COMMENCING
WITH CONSTRUCTION.

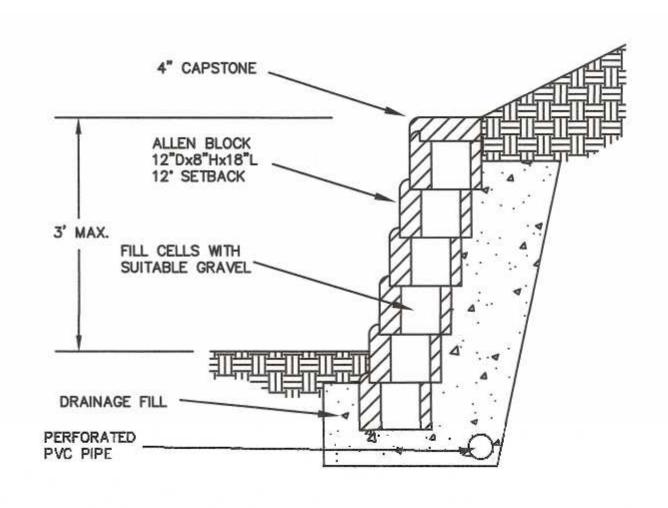



RETAINING WALL DETAIL N.T.S.

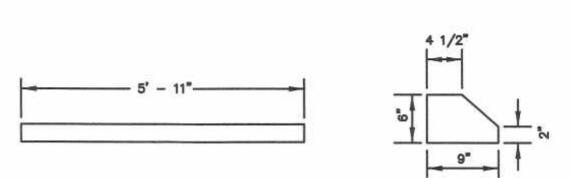

BUMPER CURB DETAIL

BUMPER CURB SHALL BE E.F. SHEA ITEM NO. B-BBSF OR APPROVED EQUAL.

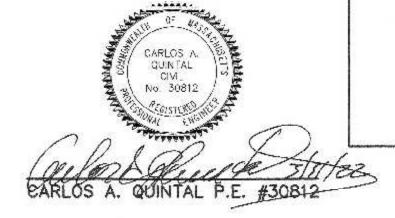

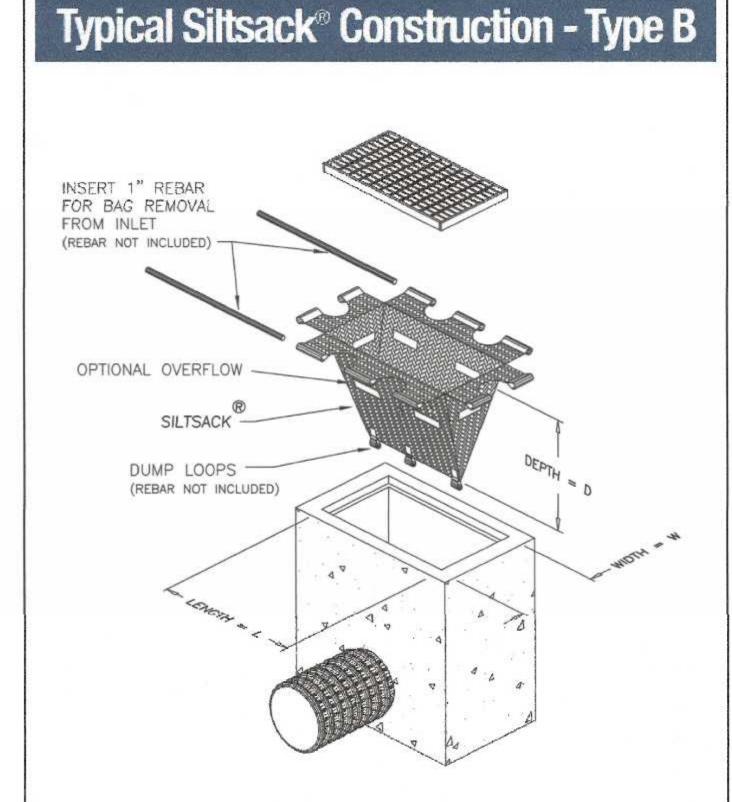

OWNER: MAP 286 PARCELS 32 AND 34 70 EAST CENTRAL STREET, LLC 37 EAST CENTRAL STREET FRANKLIN, MASSACHUSETTS

OWNER MAP 286 PARCEL 33 JOHN AND CARMEL SHERRY 88 EAST CENTRAL STREET

APPLICANT: 70 EAST CENTRAL STREET, LLC 37 EAST CENTRAL STREET FRANKLIN, MASSACHUSETTS DATE INT.
6/19 FIELD BY: BL

BK# 74 FIELD BOOK PG# 63

12/21 CALCS BY: RRG

12/21 DESIGNED BY: RRG

12/21 DRAWN BY: COMP

12/21 CHECKED BY: CAQ

2" OF LOAM AND SEED

8" GRAVEL BED

COMPACTED SUBGRADE

EMERGENCY ACCESS DRIVE

SITE PLAN MODIFICATION

CONSTRUCTION DETAIL PLAN - 3

70, 72, 88 AND 94 EAST CENTRAL STREET

FRANKLIN, MASSACHUSETTS

PREPARED FOR

70 EAST CENTRAL STREET, LLC

37 EAST CENTRAL STREET

FRANKLIN, MASSACHUSETTS

DECEMBER 24, 2021

SCALE: 1" = 20'

UNITED CONSULTANTS

B50 FRANKLIN STREET SUTTE 11D WRENTHAM, MASSACHUSETTS 02093 508-384-6560 FAX 508-384-6566

DEC. 24, 2021
SCALE


1" = 20'
PROJECT

UC1334
SHEET


9 of 9

SITE PLAN APPROVAL
REQUIRED
FRANKLIN PLANNING BOARD

DATE

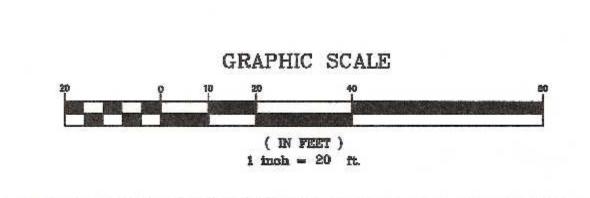

ane-es			
2	3/29/22	REVIEW COMMENTS	RRG
1	3/29/22 2/28/22	REVIEW COMMENTS	RRG
NO.	DATE	DESCRIPTION	BY

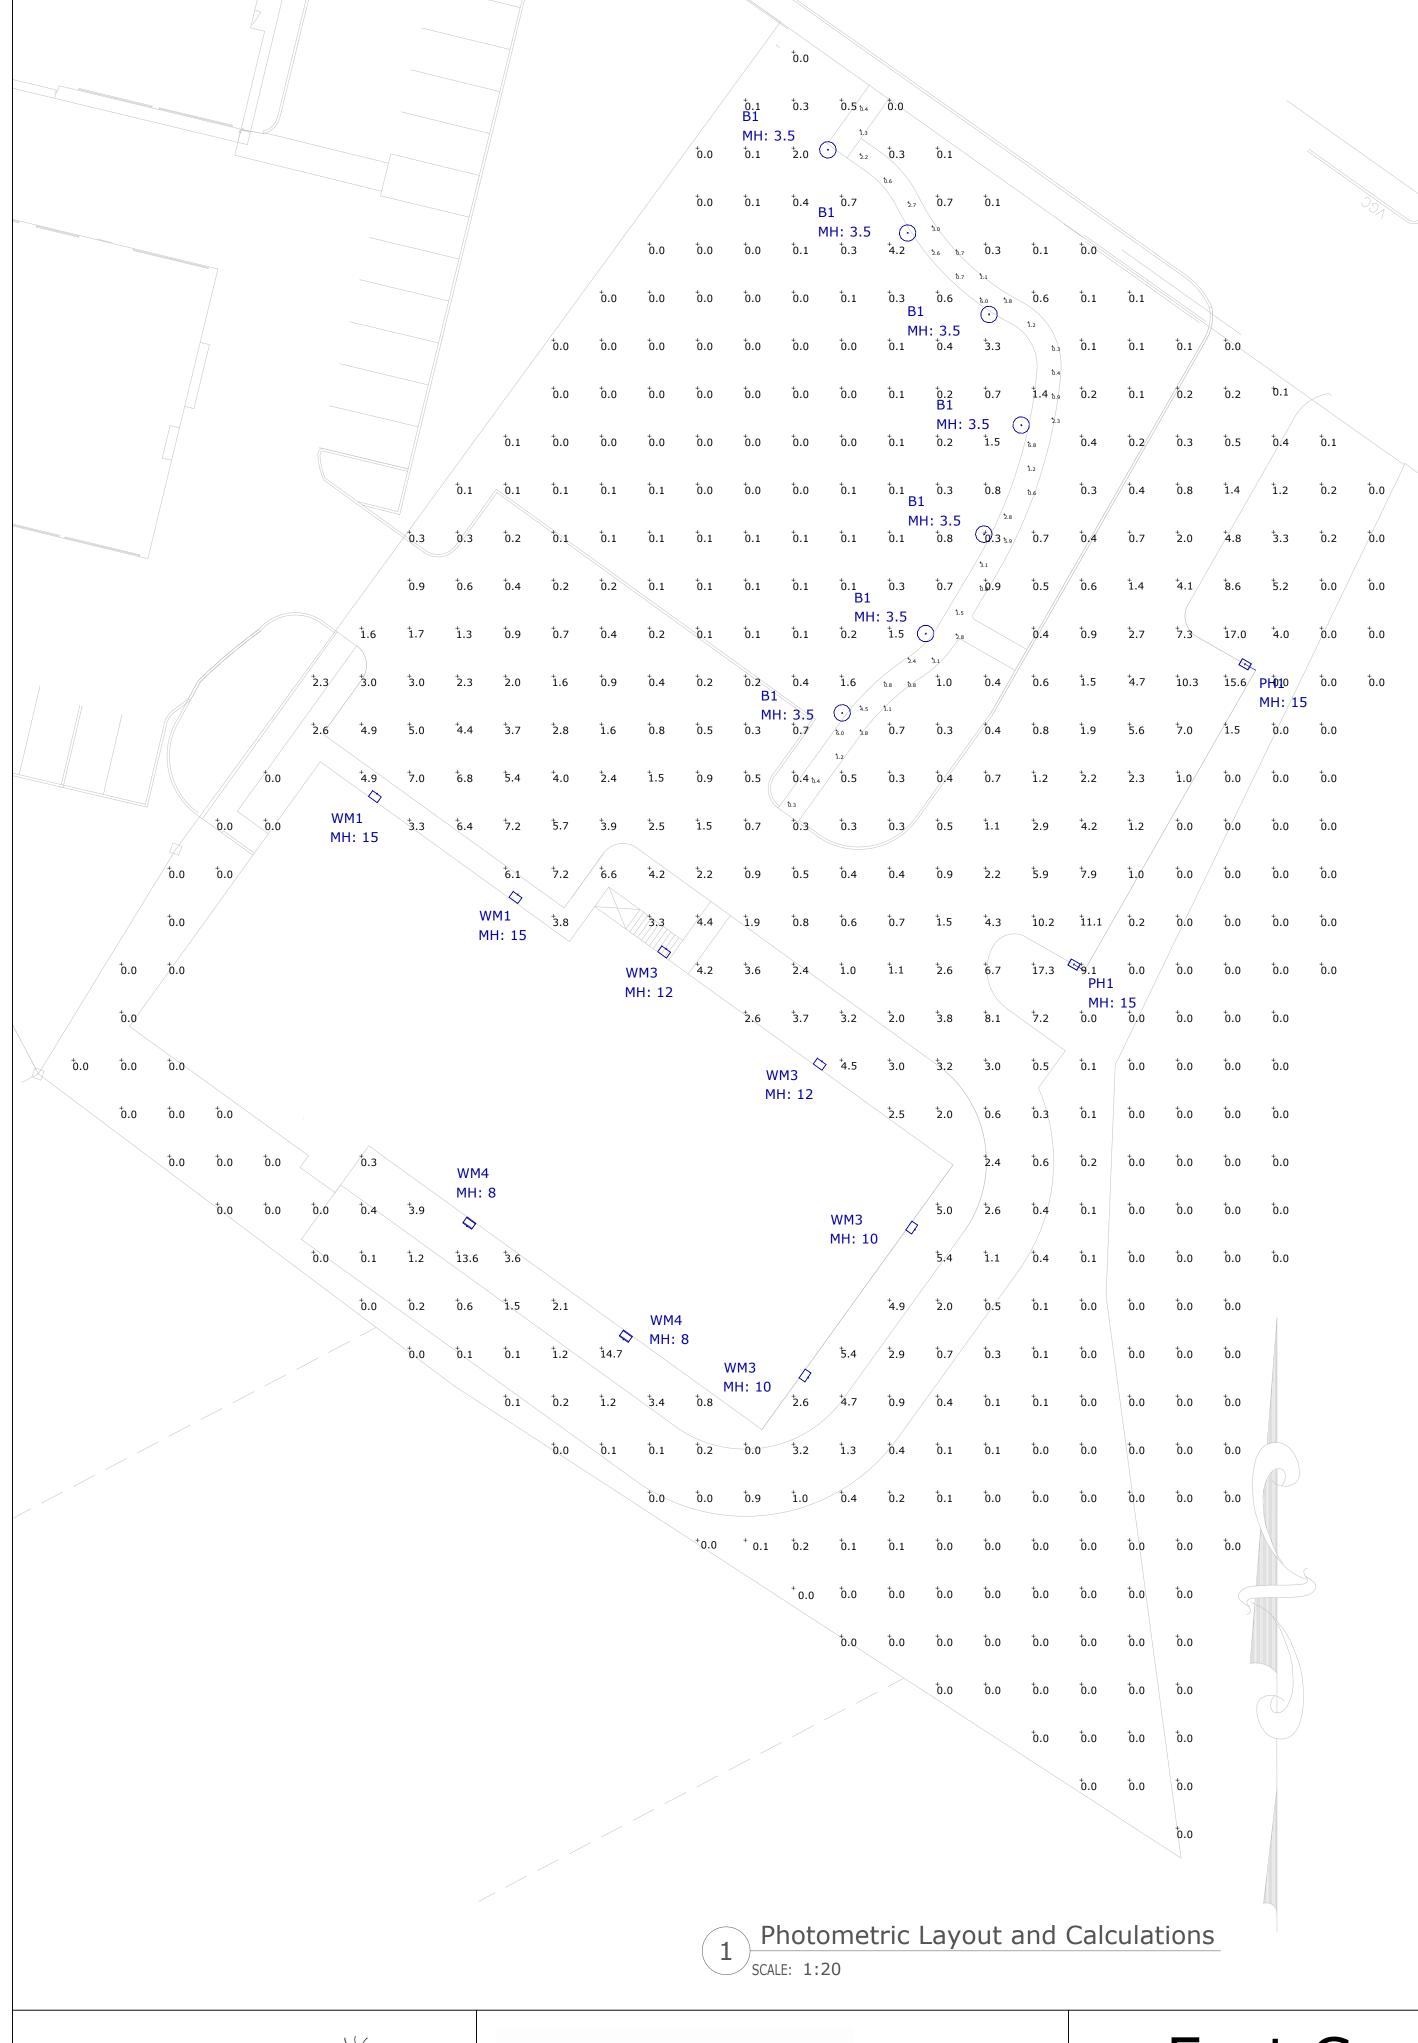


Luminaire Schedule							
Symbol Label Qty Description			Description	LLF	Lum. Watts	Lum. Lumens	
\odot	B1	7	Utopia # BLD2-A-25LED	0.900	24.8	1335	
PH1 2 Xtralight # VN		2	Xtralight # VNTLEDS-01-100-3M-N-DIM-4-20-TBD-	0.826	339	15588	
			BZ-HO-VNT-HSS-N-SM				
	WM1	2	Xtralight # VNTW-11000L-40K-DIM-4S-BZ	0.900	109.1	10678	
	WM3	4	Xtralight # VNTW-3500L-40K-DIM-2M-BZ	0.900	27.9	3455	
	WM4	2	Xtralight # VNTW-3500L-40K-DIM-2S-BZ	0.900	27.9	3505	

Calculation Summary							
Label	CalcType	Units	Avg	Max	Min	Avg/Min	Max/Min
Site Points	Illuminance	Fc	1.18	17.3	0.0	N.A.	N.A.
WALKWAY	Illuminance	Fc	2.16	6.8	0.3	7.20	22.67



3 XtraLight Type Vieno Area Specifications

4 Utopia Type BLD2 Specifications

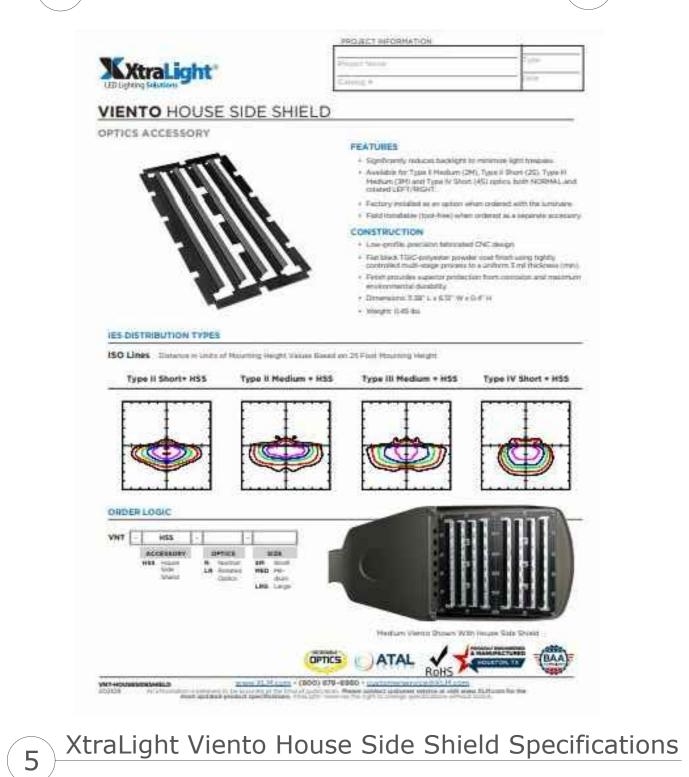

NOTES:

- A. A LIGHT LOSS FACTOR OF 0.900 HAS BEEN APPLIED TO FIXTURES UNLESS OTHERWISE NOTED. REFER TO LUMINAIRE SCHEDULE FOR LIGHT LOSS FACTOR AND LUMEN INFORMATION.
- B. SEE "MH" ON LIGHTING FIXTURE TAG LOCATED ON PLAN FOR MOUNTING HEIGHT INFORMATION.
- C. CALCULATION POINTS ARE TAKEN AT GRADE.
- D. CALCULATION RESULTS ARE BASED ON IES STANDARDS UNLESS OTHERWISE REQUESTED.

JACK SKWATT APPROVED SK&Associates Experience the light $^{\text{TM}}$

T - 781-821-1700

www.skandassociates.com

20/22 Carver Circle

Canton, MA 02021



37 East Central St.

Franklin, MA

East Central Street Development

Exterior Lighting Plan, Photometrics & Schedules

DATE: 2/1/2022	REVISIONS	DESCRIPTION	DATE	
PROJECT NUMBER:	1			
DRAWN BY: AD	2			
CHECKED BY:HD	3			
APPROVED BY: HD	4			
SCALE: 1"=20'-0"	5			
	6			
	7			l .

94 EAST CENTRAL APARTMENTS

CAMFORD PROPERTY GROUP

94 EAST CENTRAL STREET

FRANKLIN, MA 02038

PROJECT NUMBER: 19092

DENNIS COLWELL

A R C H I T E C T S

132 CENTRAL STREET, SUITE 203, FOXBOROUGH, MA 022035

STAMP:

DRAWING SCALE:

DATE:

03.15.2022

DRAWING SCALE:

DRAWN BY: DES CHECKED BY: DMC
DRAWING TITLE:

ELEVATIONS

A2.0