

SITE PLAN MODIFICATION

70, 72, 88 AND 94 EAST CENTRAL STREET

PLAN 108 OF 1908



LOCUS MAP
SCALE: 1" = 100'

70 AND 72 EAST CENTRAL STREET PROPERTY ARE LOCATED WITHIN A DOWNTOWN COMMERCIAL ZONE. 88 AND 94 EAST CENTRAL STREET PROPERTY ARE LOCATED WITHIN A COMMERCIAL I ZONE. ZONING TABLE VALUES FOR #94 AND # 88 EAST CENTRAL STREET ARE BASED ON PARCELS "A" AND "B" BEING PART OF #94 EAST CENTRAL STREET AND ARE NOT REFLECTED AS PART OF # 88 EAST CENTRAL STREET.

#88 AND 94 EAST CENTRAL STREET - COMMERCIAL I ZONING DISTRICT		EXISTING	PROPOSED
REQUIREMENTS:	5,000 S.F.	54,814± S.F.	54,814± S.F.
AREA:	50'	159.43'	159.43'
FRONTAGE:	50'	271'	271'
DEPTH:	3 STORIES - 40' *15	2 STORIES	# 94 3 STORIES < 40' SEE ARCHITECTURAL PLANS
HEIGHT:	45'	163.5'	163.5'
WIDTH:	SETBACKS		
FRONT:	20' *1	160.3'	172.5'
SIDE:	10' *14	24.6'	11.0'
REAR:	15'	35.5'	17.2'
COVERAGE	80%	6.9%	19.3%
STRUCTURES:	90%	15.4%	46.1%
STRUC. & PAVING:			

#70-72 EAST CENTRAL STREET - DOWNTOWN COMMERCIAL ZONING DISTRICT		EXISTING	PROPOSED
REQUIREMENTS:	5,000 S.F.	32,810 S.F.	32,810± S.F.
AREA:	50'	186.07'	186.07'
FRONTAGE:	50'	266'	266'
DEPTH:	3 STORIES - 40' *9	2 STORIES	4 STORIES - 49.5'
HEIGHT:	45'	>45'	>45'
WIDTH:	COVERAGE -		
FRONT:	15' *10	20.7'	15.7'
SIDE:	0' *2	25.2'	15.0' & 5'
REAR:	15'	105'	23.3' & 17.5'
STRUC. & PAVING:	80%	7.6%	28%
	90%	19.2%	67.7%

THE ABOVE INFORMATION WAS TAKEN FROM THE APPROVED SITE PLAN FOR 70 - 72 EAST CENTRAL STREET.

- *1 - BUT NO NEW STRUCTURE SHALL BE REQUIRED TO PROVIDE A DEEPER YARD THAN EXISTED ON THAT PARCEL UPON ADOPTION OF THIS AMENDMENT.
- *14 - THE 10-FOOT SIDE SETBACK IS ONLY REQUIRED ON ONE SIDE OF THE LOT; IF LOT ABUTS A RESIDENTIAL DISTRICT, A 20-FOOT SETBACK IS REQUIRED ON THE ABUTTING SIDE.
- *15 - BUILDINGS UP TO 50 FEET IN HEIGHT, REGARDLESS OF THE NUMBER OF STORIES, MAY BE PERMITTED BY A SPECIAL PERMIT FROM THE PLANNING BOARD.

REQUIREMENTS FOR 94 EAST CENTRAL STREET ZONE COMMERCIAL I EXISTING AND PROPOSED LOT AREA, FRONTAGE, DEPTH, WIDTH AND COVERAGE BASED ON THE LOTS BEING COMBINED. BUILDING HEIGHT, AND SETBACKS BASED ON EXISTING AND PROPOSED BUILDINGS LOCATED ON 88 AND 94 EAST CENTRAL STREET. PROPERTY IS NOT LOCATED WITHIN A FRANKLIN WATER RESOURCE DISTRICT. THE PROPERTY IS LOCATED IN A ZONE C BASED ON FEMA FIRM MAP 25021C0309E DATED JULY 17, 2012.

94 EAST CENTRAL STREET:
EXISTING BUILDING USE RESIDENTIAL.
PROPOSED BUILDING USE MIXED WITH RESIDENTIAL.

88 EAST CENTRAL STREET
EXISTING BUILDING USE RESIDENTIAL.

70-72 EAST CENTRAL STREET
CURRENT BUILDING USE MIXED WITH RESIDENTIAL.

DRAWING INDEX:


1. COVER SHEET
 2. EXISTING CONDITIONS PLAN
 3. SITE LAYOUT PLAN
 4. SITE GRADING AND UTILITY PLAN
 5. SITE PLANTING PLAN
 6. EROSION CONTROL PLAN
 7. CONSTRUCTION DETAILS
 8. CONSTRUCTION DETAILS
 9. CONSTRUCTION DETAILS
 - SITE LIGHTING-LIGHTING PLAN, PHOTOMETRICS AND SCHEDULES
- BY SK & ASSOCIATES

OWNER:
MAP 286 PARCELS 32 AND 34
70 EAST CENTRAL STREET, LLC
37 EAST CENTRAL STREET
FRANKLIN, MASSACHUSETTS

OWNER MAP 286 PARCEL 33
JOHN AND CARMEL SHERRY
88 EAST CENTRAL STREET

APPLICANT:
70 EAST CENTRAL STREET, LLC
37 EAST CENTRAL STREET
FRANKLIN, MASSACHUSETTS


SITE PLAN MODIFICATION
COVER SHEET
70, 72, 88 AND 94 EAST CENTRAL STREET
FRANKLIN, MASSACHUSETTS
PREPARED FOR
70 EAST CENTRAL STREET, LLC
37 EAST CENTRAL STREET
FRANKLIN, MASSACHUSETTS
DECEMBER 24, 2021
SCALE: 1" = 100'

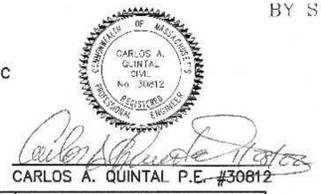

- ALL EROSION CONTROL MITIGATION MEASURES SHALL BE IN PLACE PRIOR TO MAJOR CONSTRUCTION OR SOIL DISTURBANCE COMMENCING ON THE SITE.

- WAIVER REQUESTS:**
1. TO ALLOW LESS THAN 42" OF COVER OVER THE RCP DRAIN PIPE. PROPOSED CLASS V RCP.
 2. TO ALLOW THE USE OF HPDE PIPE FROM CATCH BASIN 92 TO THE UNDERGROUND POND, FROM THE UNDERGROUND POND TO DRAIN MANHOLE 93, THE ROOF LEADER COLLECTION SYSTEM AND FROM ROOF LEADER CONNECTION TO DMH 95.
 3. TO ALLOW THE SITE LIGHTING TO EXTEND PAST THE PROPERTY LINE.

- REFERENCES:**
- ASSESSORS MAP 286 PARCELS 32, 33 AND 34
 - DEED BOOK 36860 PAGE 516
 - DEED BOOK 35983 PAGE 116
 - DEED BOOK 24648 PAGE 492
 - PLAN 108 OF 1908
 - PLAN 576 OF 1900
 - OWNERS PLAN OF LAND BY GUERRIERE AND HALNON, INC DATED OCTOBER 22, 2018
 - PLAN 3334 OF 1913
 - PLAN 853 OF 1928

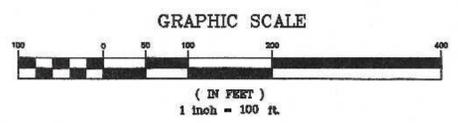

SITE PLAN APPROVAL
REQUIRED
FRANKLIN PLANNING BOARD

DATE _____

NO.	DATE	DESCRIPTION	BY

DATE	FIELD BY:	INT.
6/19	BL	BL
BK#	FIELD BOOK	PG#
12/21	CALCS BY:	RRG
12/21	DESIGNED BY:	RRG
12/21	DRAWN BY:	COMP
12/21	CHECKED BY:	CAQ

UNITED CONSULTANTS INC.

850 FRANKLIN STREET SUITE 11D
WRENTHAM, MASSACHUSETTS 02093
508-384-8560 FAX 508-384-8566

DATE DEC. 24, 2021

SCALE 1" = 100'

PROJECT UC1334

SHEET 1 of 9

NOTE:
THE SITE USES ARE NOT ANTICIPATED TO REQUIRE A LOADING AREA HOWEVER THE FOLLOWING PROVISIONS HAVE BEEN LISTED.

A SU-30 TRUCK (LARGEST DELIVERY VEHICLE TO ACCESS THE SITE) WILL BE ABLE TO ACCESS THE SITE AND WOULD BE ABLE TO TRAVEL THROUGH THE 70 EAST CENTRAL STREET SITE DRIVEWAY. THE TRUCK COULD OFF LOAD AT THE DRIVEWAY CONNECTING THE PARKING AREAS.

OWNER:
MAP 286 PARCELS 32 AND 34
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37 EAST CENTRAL STREET
FRANKLIN, MASSACHUSETTS

OWNER MAP 286 PARCEL 33
JOHN AND CARMEL SHERRY
88 EAST CENTRAL STREET

APPLICANT:
70 EAST CENTRAL STREET, LLC
37 EAST CENTRAL STREET
FRANKLIN, MASSACHUSETTS

PLAN 1079 OF 1088

MAP 286 PARCEL 44
79 CROSS STREET
N/F ANDERSON
BOOK 39674 PAGE 244
ZONE - SINGLE FAMILY IV
USE - RESIDENTIAL

MAP 286 PARCEL 42
54-60 SUMMER STREET
N/F THAYER
BOOK 8402 PAGE 188
ZONE - SINGLE FAMILY IV
USE - RESIDENTIAL

MAP 286 PARCEL 41
48 SUMMER STREET
N/F THAYER
BOOK 17756 PAGE 468
ZONE - SINGLE FAMILY IV
USE - RESIDENTIAL

MAP 286 PARCEL 40
38 SUMMER STREET
N/F TROLIO
BOOK 39403 PAGE 303
ZONE - SINGLE FAMILY IV
USE - RESIDENTIAL



CARLOS A. QUINTAL P.E. #30812

PARKING CALCULATIONS:
#94 EAST CENTRAL STREET
COMMERCIAL I REQUIREMENTS (SECTIONS 185-21B.(2)(a)
#94 EAST CENTRAL STREET
1.5 SPACES PER RESIDENTIAL DWELLING UNIT.
17 RESIDENTIAL UNITS PROPOSED REQUIRES 27 SPACES
19 GARAGE SPACES ARE PROPOSED FOR THE RESIDENTIAL UNITS
COMMERCIAL SPACE (NON RESIDENTIAL USE) 1 SPACE PER 500
SQ. FT. = 972 SQ. FT. / 500 = 2 SPACES REQUIRED
29 TOTAL SPACES REQUIRED.

42 TOTAL PARKING SPACES PROPOSED INCLUDING 2 HANDICAP SPACES.

PARKING CALCULATIONS 70 AND 72 EAST CENTRAL STREET
SITE PLAN APPROVAL:
DOWNTOWN COMMERCIAL REQUIREMENTS (SECTIONS
185-21(3)(a) & (b)
1.5 SPACES PER RESIDENTIAL DWELLING UNIT.
12 RESIDENTIAL UNITS PROPOSED REQUIRES 18 SPACES
20 GARAGE SPACES ARE PROPOSED FOR THE RESIDENTIAL UNITS.
14 SPACES PROPOSED INCLUDING 1 HANDICAP SPACE.
TOTAL OF 34 SPACES ORIGINALLY PROPOSED

REVISIONS PROPOSED FOR 70-72 EAST CENTRAL STREET
PARKING WITH THE SITE PLAN FOR 70, 72, 88 AND 94 EAST
CENTRAL STREET
ELIMINATE 4 GARAGE PARKING SPACES
ELIMINATED FORMER SPACE 12 (12R) AND 15 (15R)
= 16 GARAGE SPACES AND 14 OUTDOOR SPACES
30 SPACES PROVIDED WHERE 18 SPACES ARE REQUIRED
AS REVISED 70 & 72 EAST CENTRAL STREET PARKING AREA
HAS 12 SPACES ABOVE THE ZONING BYLAW PARKING
REQUIREMENTS.

MAP 286 PARCEL 39
8 SUMMER STREET
N/F G & K SIMON, INC.
BOOK 8449
PAGES 33 & 34
ZONE - DOWNTOWN COMMERCIAL
USE - RETAIL

RESIDENTIAL DENSITY:
C-1 DISTRICT: 88 AND 94 EAST CENTRAL STREET
COMMERCIAL I REQUIREMENTS (185 ATTACHMENT 7 - 6.1*3)
*3 - NO MORE THAN ONE DWELLING UNIT PER 1,000 SQUARE FEET OF
LOT AREA MAY BE PERMITTED.

AREA 88 AND 94 EAST CENTRAL STREET - 54,614± SQ. FT. / 1,000 =
54 UNITS PERMISSIBLE
17 UNITS PROPOSED.

NOTE: 88 EAST CENTRAL STREET AND 94 EAST CENTRAL STREET
PROPERTIES TO BE COMBINED.


DC DISTRICT: 70 AND 72 EAST CENTRAL STREET
DOWNTOWN COMMERCIAL REQUIREMENTS (185 ATTACHMENT 7 - 6.1*6)
*6 - NO MORE THAN ONE DWELLING UNIT PER 2,000 SQUARE FEET OF
LOT AREA MAY BE PERMITTED; ADDITIONAL DWELLING UNITS MAY BE
ALLOWED BY SPECIAL PERMIT FROM THE PLANNING BOARD
LOT AREA - 32,810± SQ. FT. / 1,000 = 32 UNITS PERMISSIBLE
12 UNITS PROPOSED.

NOTES:
- NO SITE SIGNS ARE PROPOSED AT THIS TIME. ONCE
TENANTS ARE SECURED THE TENANT AND OR DEVELOPER WILL
SUBMIT AND OBTAIN APPROVAL FOR SIGNS. AT THIS TIME THE
DEVELOPER IS PLANNING TO UTILIZE BUILDING MOUNTED
SIGNAGE THAT WILL COMPLY WITH THE TOWN OF FRANKLIN
REQUIREMENTS.

MAP 286 PARCELS 32 AND 34
ARE TO BE COMBINED.
MAP 286 PARCEL 33 HAS A PROPOSED
EASEMENT FOR ACCESS AND UTILITIES.

- LEGEND:
- DHSB DRILL HOLE STONE BOUND
 - - - 297 - - EXISTING COUNTOUR
 - 297 - - PROPOSED COUNTOUR
 - x274.3 SPOT GRADE - PROPOSED
 - x274.3EX. SPOT GRADE - EXISTING
 - ⊕ 48M EXIST. TREE - DIAMETER - SPECIES
 - ⊕ UP4-1 UTILITY POLE
 - OHW — OVERHEAD WIRES
 - ⊗ GAS GATE
 - ⊕ WATER CURB STOP
 - ⊕ WATER GATE
 - ⊕ FIRE HYDRANT
 - ⊕ DRAIN MANHOLE
 - ⊕ CATCH BASIN
 - ⊕ SEWER MANHOLE
 - D DUMPSTER
 - VCC VERTICAL CONCRETE CURBING
 - VGC VERTICAL GRANITE CURBING
 - ⊕ HANDICAP PARKING SPACE
 - ⊕ BUILDING MOUNTED LIGHT
 - POLE MOUNTED LIGHT


NOTE:
ALL SITE CURBING TO BE
VERTICAL GRANITE.

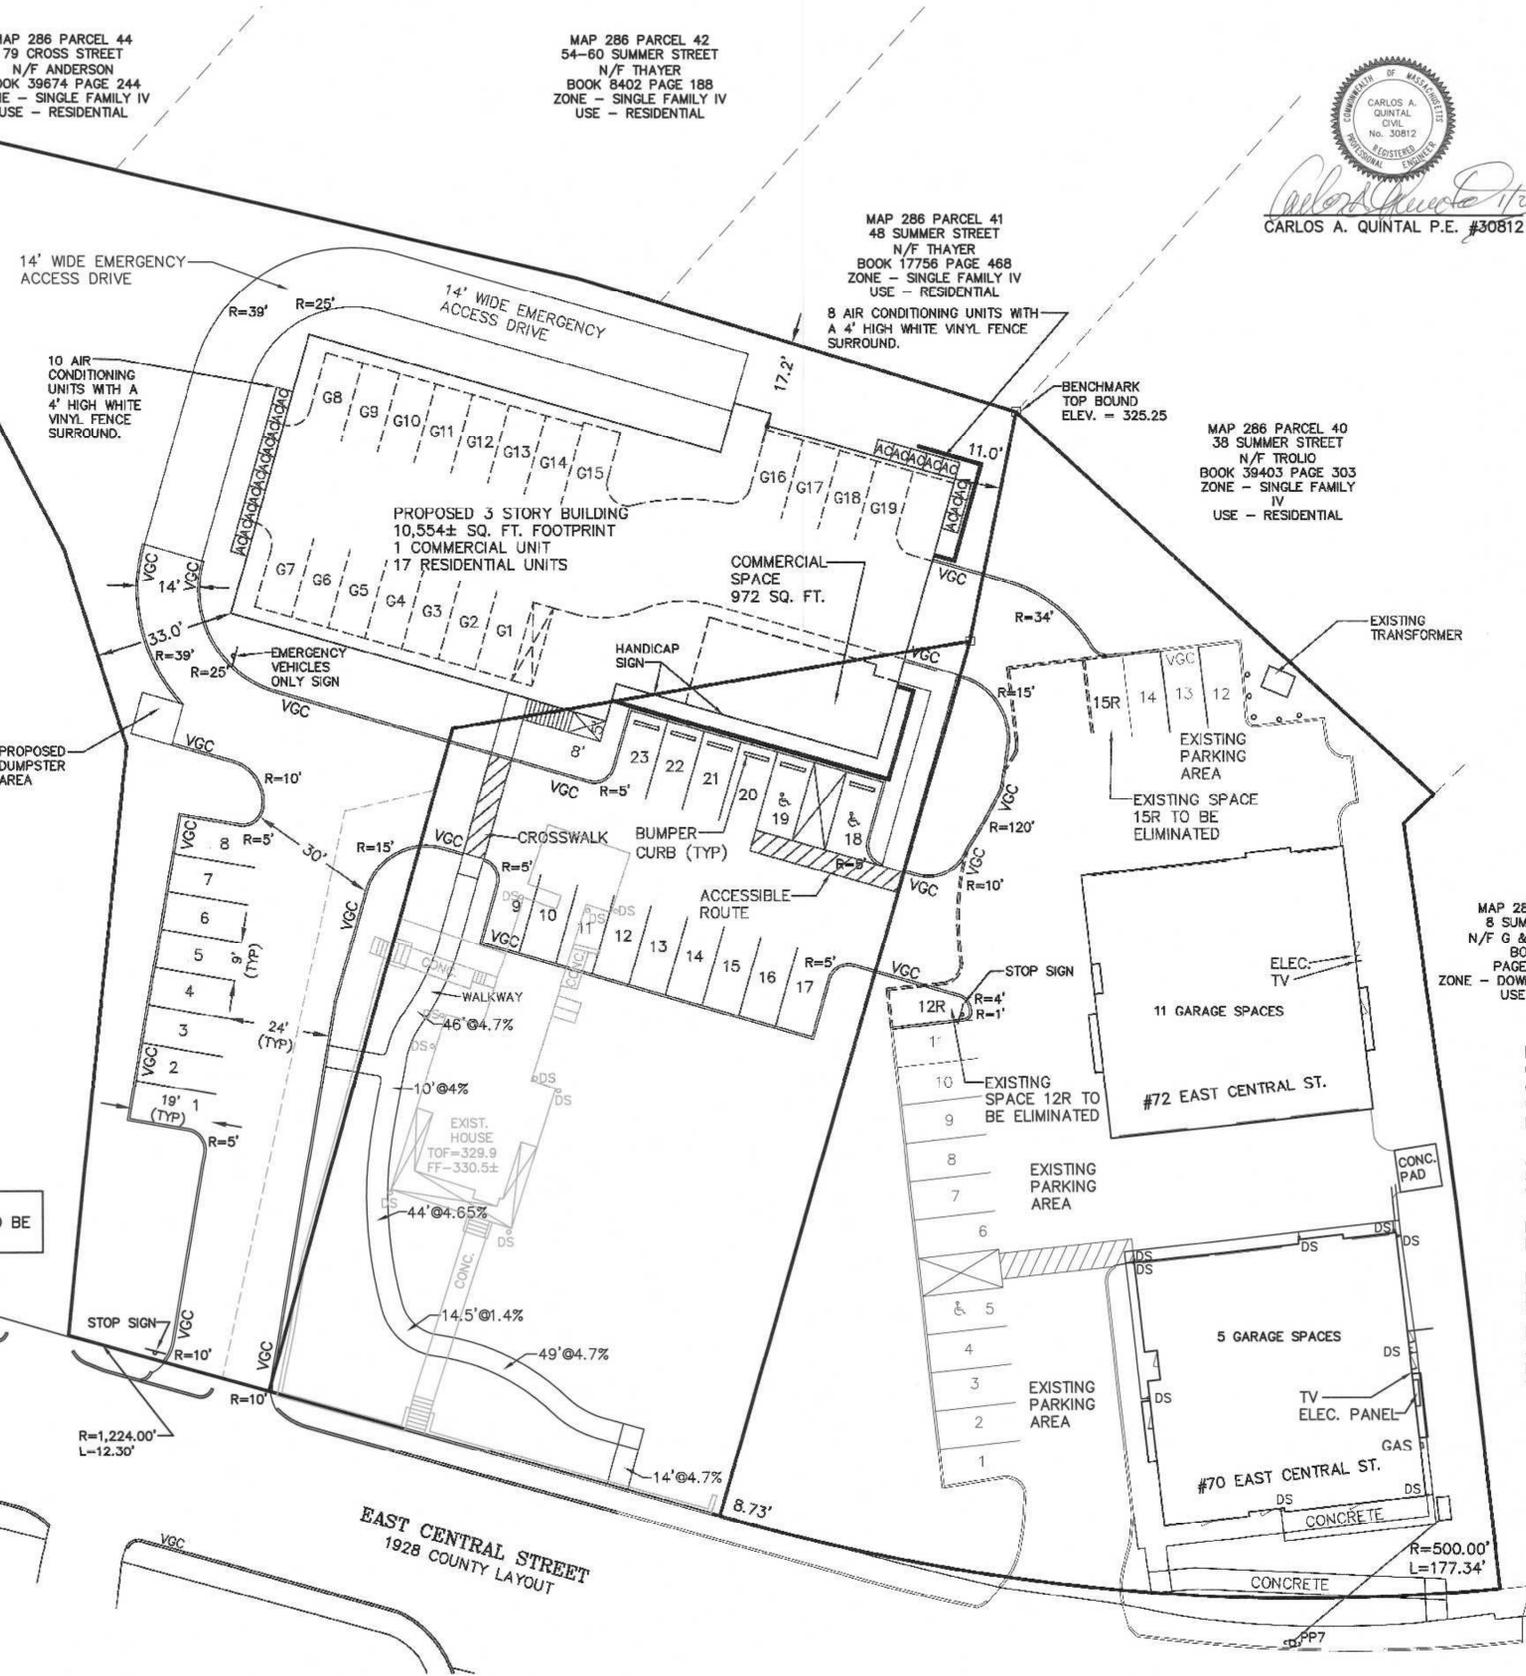

SITE PLAN MODIFICATION
SITE LAYOUT PLAN
70, 72, 88 AND 94 EAST CENTRAL STREET
FRANKLIN, MASSACHUSETTS
PREPARED FOR
70 EAST CENTRAL STREET, LLC
37 EAST CENTRAL STREET
FRANKLIN, MASSACHUSETTS
DECEMBER 24, 2021
SCALE: 1" = 20'

SITE PLAN APPROVAL
REQUIRED
FRANKLIN PLANNING BOARD

DATE _____

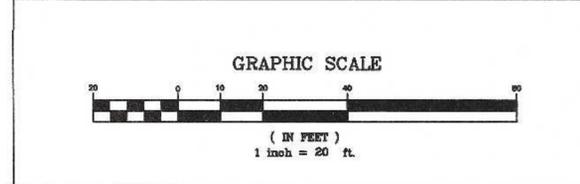


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12/21	RRG	
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PROJECT	UC1334
SHEET	3 of 9

- LEGEND:**
- DHSB DRILL HOLE STONE BOUND
 - 297- EXISTING COUNTOUR
 - 297- PROPOSED COUNTOUR
 - x274.3 SPOT GRADE - PROPOSED
 - x274.3EX. SPOT GRADE - EXISTING
 - ⊕ 48M EXIST. TREE - DIAMETER - SPECIES
 - ⊕ UP4-1 UTILITY POLE
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 - ⊕ WATER CURB STOP
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 - ⊕ DRAIN MANHOLE
 - ⊕ CATCH BASIN
 - ⊕ SEWER MANHOLE
 - D DUMPSTER
 - VCC VERTICAL CONCRETE CURBING
 - VGC VERTICAL GRANITE CURBING
 - ⊕ HANDICAP PARKING SPACE
 - ⊕ BUILDING MOUNTED LIGHT
 - POLE MOUNTED LIGHT



1. POND 94 AND ALL ASSOCIATED PIPING TO BE HDPE PIPE.
2. ALL RCP DRAIN PIPE TO BE CLASS V.
3. ALL ROOF DRAIN PIPE WILL BE 8" SDR 35 PVC.
4. WHERE HDPE CONNETCTS TO RCP INSTALL A FERRO LDC 10 37.00 x 32.00 COUPLING.
5. THE DESIGN ENGINEER SHALL INSPECT THE EXCAVATION OF THE SOIL INFILTRATION AREA PRIOR TO ANY FILL OR STONE MATERIAL BEING PLACED.

PROPOSED DRAINAGE STRUCTURE SCHEDULE:

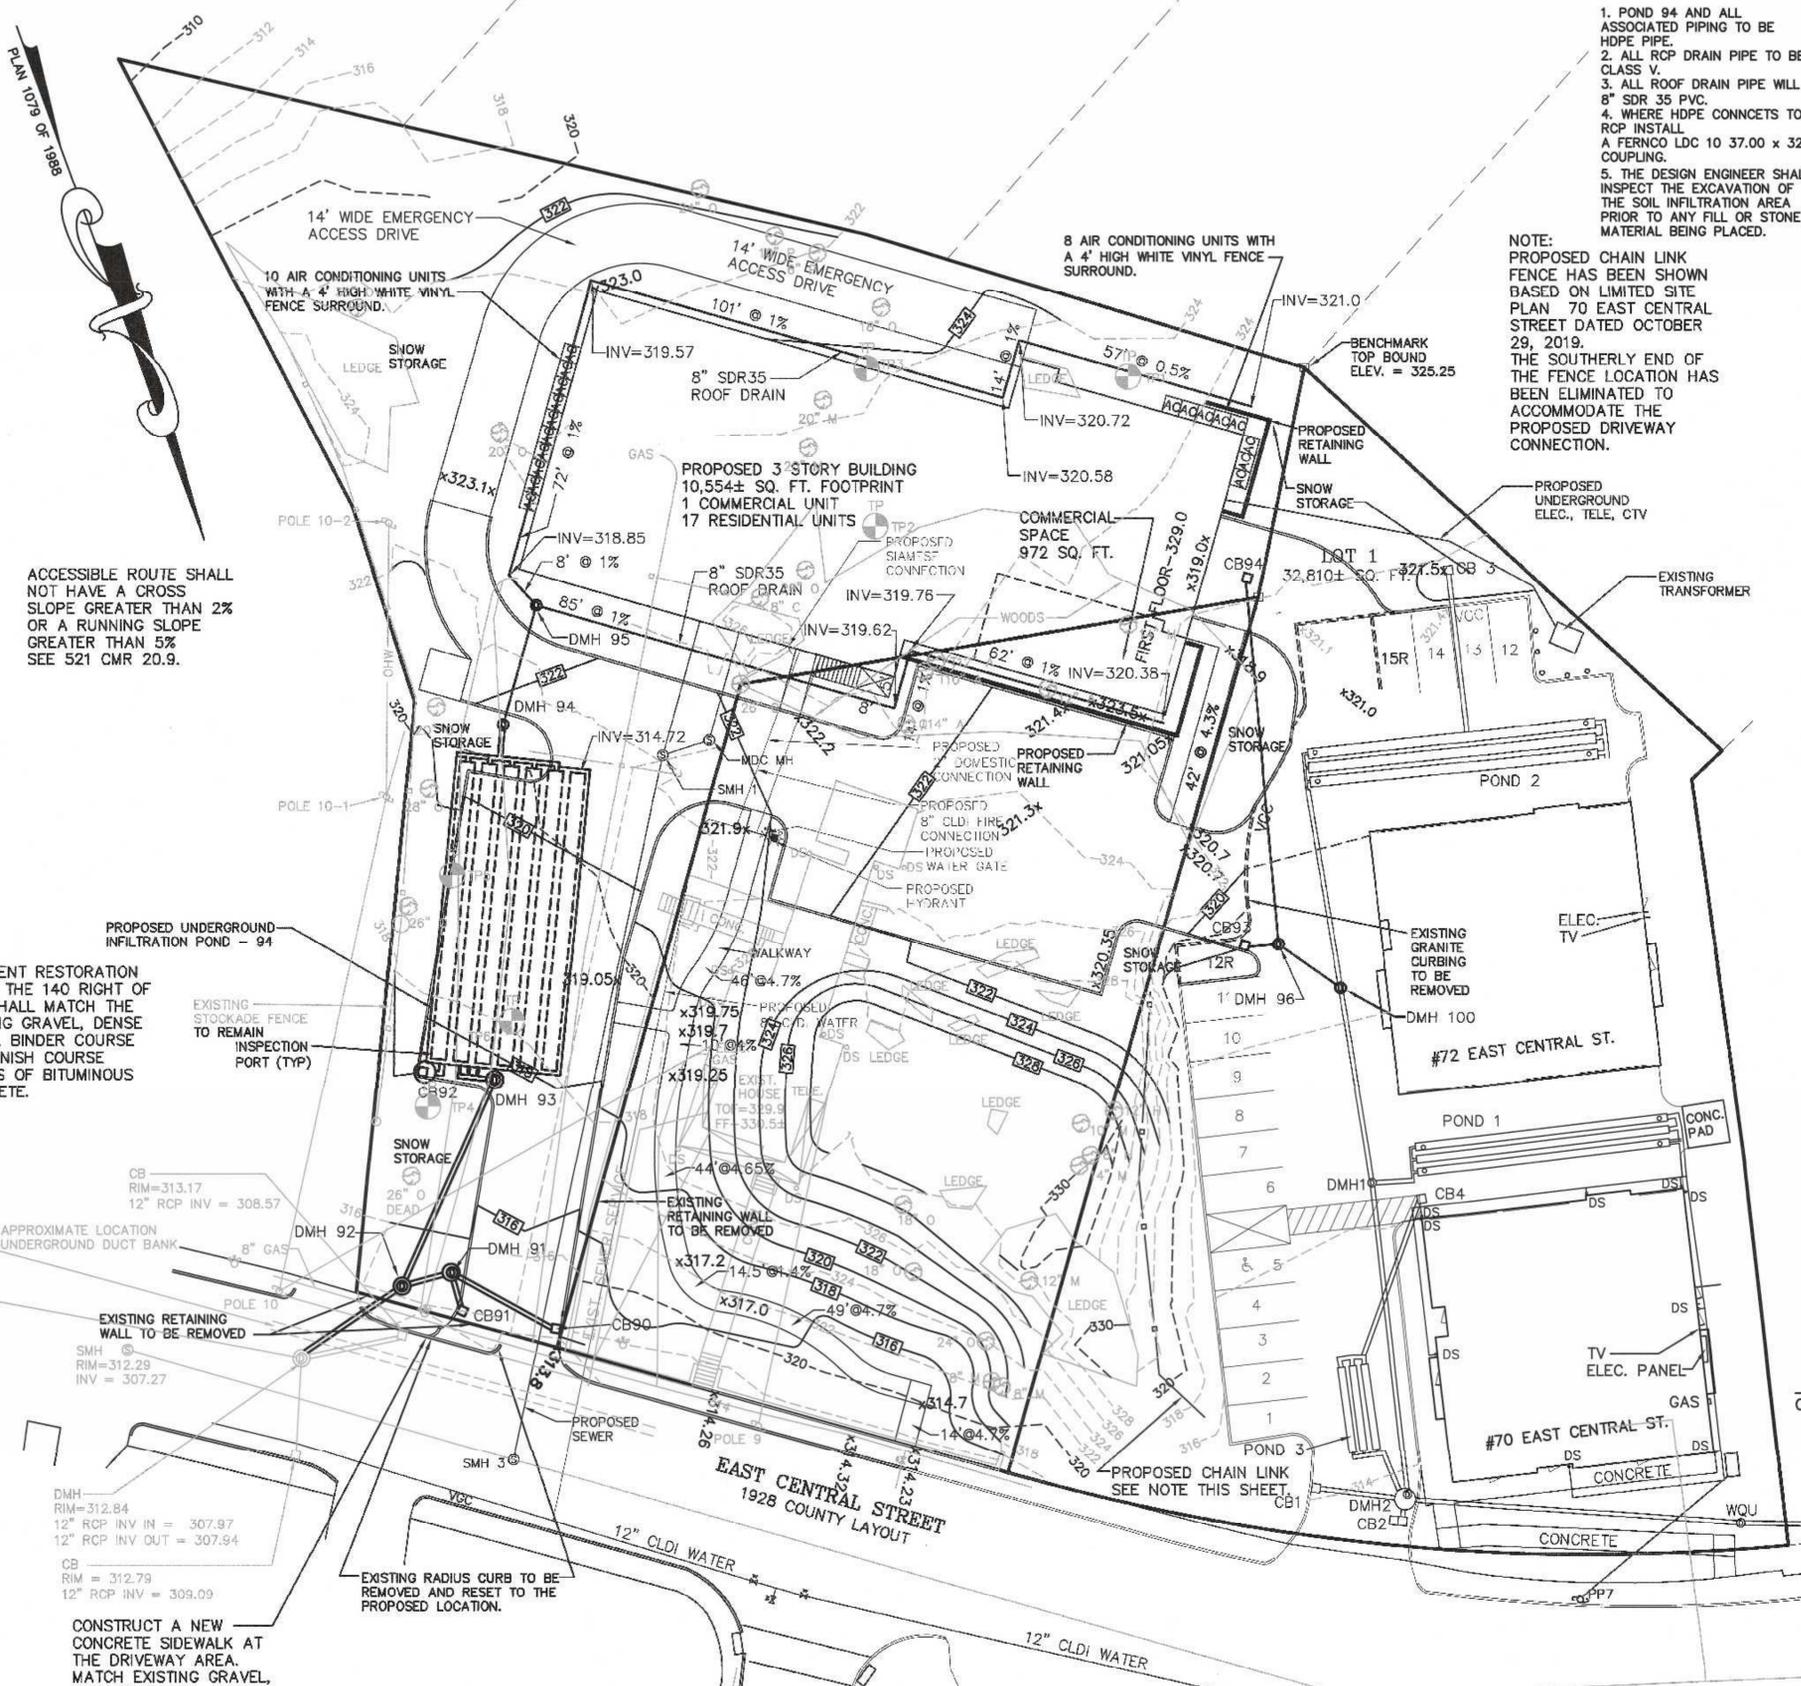CB 90 RIM = 314.2 INV OUT = 310.42 12" RCP	DMH 91 - STORMCEPTOR 450 RIM = 315.0 INV IN = 310.18 12" RCP - CB 90 INV IN = 309.68 12" RCP - CB 91 INV OUT = 309.58 12" RCP
CB 91 RIM = 314.1 INV OUT = 309.74 12" RCP	DMH 92 RIM 314.5 INV IN = 309.5 12" RCP - DMH 91 INV IN = 310.5 12" RCP - DMH 93 INV OUT = 308.5 12" RCP
CB 92 STORMCEPTOR 450 RIM = 317.58 INV OUT = 314.65 12" HDPE	DMH 93 RIM=317.9 INV IN =315.0 12" HDPE INV OUT = 312.46 12" RCP
CB 93 STORMCEPTOR 450 RIM = 319.25 INV OUT = 315.54 12" RCP	DMH 94 RIM = 322.3 INV IN = 314.92 12" RCP INV OUT = 314.82 12" HDPE
CB 94 STORMCEPTOR 450 RIM = 318.8 INV OUT = 315.87 12" RCP	DMH 95 RIM = 323.5 INV IN = 318.77 8" SDR 35 INV OUT = 315.92 12" RCP
	DMH 96 RIM = 319.2 INV IN = 315.46 12" RCP INV OUT = 315.36 12" RCP
	DMH 100 - DOGHOUSE MANHOLE RIM = 319.0 INV IN = 315.22 12" RCP INV OUT = 315.12 12" RCP

NOTE:
PROPOSED CHAIN LINK FENCE HAS BEEN SHOWN BASED ON LIMITED SITE PLAN 70 EAST CENTRAL STREET DATED OCTOBER 29, 2019. THE SOUTHERLY END OF THE FENCE LOCATION HAS BEEN ELIMINATED TO ACCOMMODATE THE PROPOSED DRIVEWAY CONNECTION.

NOTE:
PRIOR TO COMMENCING WITH THE DRAINAGE STRUCTURE OR PIPING FOR CB 93, CB 94 DMH 96, THE CONTRACTOR SHALL CONFIRM ELEVATION OF THE EXISTING DRAIN PIPE AT THE PROPOSED CONNECTION OF DMH 100. ANY DISCREPANCIES SHALL BE REPORTED TO THE DESIGN ENGINEER.

- UTILITY NOTES:**
1. DOMESTIC WATER SUPPLY SHALL BE BASED ON PLUMBING ENGINEERS CALCULATIONS.
 2. FIRE SUPPLY LINE TO BE CONNECTED TO EXISTING WATER MAIN IN STREET. LOCATION SHOWN APPROXIMATELY. FINAL SIZING AND LOCATION SHALL BE DETERMINED BY THE PLUMBING ENGINEER.
 3. ELECTRIC, TELEPHONE AND CABLE TV LOCATIONS TO BE DETERMINED BY THE APPROPRIATE UTILITY COMPANIES. SERVICES ARE PROPOSED TO BE CONNECTED TO THE 70-72 EAST CENTRAL STREET SITE AND SHALL BE UNDERGROUND.
 4. GAS SERVICE AND LOCATIONS TO BE DETERMINED BY THE GAS COMPANY.
 5. PIV AND SIAMSE CONNECTIONS SHOWN APPROXIMATE. FINAL LOCATIONS TO BE DESIGNED BY PLUMBING ENGINEER AND APPROVED BY FIRE DEPARTMENT.
 6. THE DRAINAGE INSTALLATION SHALL BE INSPECTED AND CERTIFIED BY THE DESIGN ENGINEER PRIOR TO BACKFILLING.
 7. EXISTING WATER SERVICE TO BE CUT AND CAPPED AT THE MAIN PER DPW REQUIREMENTS.
 8. EXISTING SEWER SERVICE TO BE CUT AND CAPPED AT THE PROPERTY LINE.
 9. EXISTING ELECTRIC, TELEPHONE AND CTV SERVICES TO BE REMOVED BY THE APPROPRIATE UTILITY COMPANIES.

- NOTES:**
1. CONTRACTOR TO CONTACT DIGSAFE PRIOR TO COMMENCEMENT OF CONSTRUCTION.
 2. CONTRACTOR TO VERIFY LOCATIONS OF EXISTING UTILITIES ANY REPORT ANY DISCREPANCIES TO UNITED CONSULTANTS, INC.
 3. ALL WORK SHALL CONFORM TO THE TOWN OF FRANKLIN DPW STANDARDS.
 4. MAINTAIN A MINIMUM OF 10' SEPARATION FROM THE WATER SERVICE TO THE SEWER SERVICE.

MAP 286 PARCELS 32 AND 34 ARE TO BE COMBINED. MAP 286 PARCEL 33 HAS A PROPOSED EASEMENT FOR ACCESS AND UTILITIES.



CARLOS A. QUINTAL P.E. #30812

OWNER:
MAP 286 PARCELS 32 AND 34
70 EAST CENTRAL STREET, LLC
37 EAST CENTRAL STREET
FRANKLIN, MASSACHUSETTS

OWNER MAP 286 PARCEL 33
JOHN AND CARMEL SHERRY
88 EAST CENTRAL STREET

APPLICANT:
70 EAST CENTRAL STREET, LLC
37 EAST CENTRAL STREET
FRANKLIN, MASSACHUSETTS

**SITE PLAN MODIFICATION
GRADING & UTILITY PLAN**
70, 72, 88 AND 94 EAST CENTRAL STREET
FRANKLIN, MASSACHUSETTS
PREPARED FOR
70 EAST CENTRAL STREET, LLC
37 EAST CENTRAL STREET
FRANKLIN, MASSACHUSETTS
DECEMBER 24, 2021
SCALE: 1" = 20'

MARCH 13, 2019
PERFORMED BY CARLOS A. QUINTAL, P.E., SOIL EVALUATOR

TP 1 ELEV. = 324.24 - ABANDONED

TP 2 ELEV. = 324.75
0 - 8" A 10YR 3/3 SANDY LOAM
8" - 24" B 10YR 6/6 SANDY LOAM
24" - 60" C 2.5Y 5/6 SANDY LOAM

TP 3 ELEV. = 323.85
0 - 8" A 10YR 3/3 SANDY LOAM
8" - 24" B 10YR 6/6 SANDY LOAM
24" - 64" C 2.5Y 5/6 SANDY LOAM

TP 4 ELEV. = 317.52
0 - 12" A 10YR 3/3 SANDY LOAM
12" - 36" B 10YR 6/6 SANDY LOAM
36" - 90" C 2.5Y 4/3 GRAVELLY SANDY LOAM
NO GROUNDWATER
NO MOTILES AT 90" ELEV. = 310.02

TP 5 ELEV. = 318.53
0 - 18" A 10YR 3/3 SANDY LOAM
18" - 42" B 10YR 6/6 SANDY LOAM
42" - 109" C 2.5Y 5/6 SANDY LOAM
GROUNDWATER AT 100" ELEV. = 310.20
NO MOTILES OBSERVED

TP 6 ELEV. = 318.03
0 - 10" A 10YR 3/3 SANDY LOAM
10" - 42" B 10YR 6/6 SANDY LOAM
42" - 97" C 2.5Y 5/6 SANDY LOAM
NO GROUNDWATER OBSERVED
NO MOTILES OBSERVED AT 97" ELEV. = 309.94

ALL TEST PITS WERE DUG TO REFUSAL


PAVEMENT RESTORATION WITHIN THE 140 RIGHT OF WAY SHALL MATCH THE EXISTING GRAVEL, DENSE GRADE, BINDER COURSE AND FINISH COURSE DEPTHS OF BITUMINOUS CONCRETE.

SIGHT DISTANCE BASED ON POSTED SPEED OF 25 MPH AT THE INTERSECTION OF EAST CENTRAL STREET AND ALPINE PLACE.
PER MASDOT STOPPING SIGHT DISTANCE FOR 25 MPH AT 0% GRADE - 155 FEET.
SIGHT DISTANCE WAS MEASURED 14.5 FEET FROM EDGE LINE, EXITING THE SITE:
LOOKING WEST 200 + FEET.
LOOKING EAST 300 + FEET.

REFERENCE MASS HIGHWAY EXHIBIT 3.8
200 FOOT SIGHT DISTANCE AT ZERO GRADE HAD A DESIGN SPEED OF 30 MPH.

CONSTRUCT A NEW CONCRETE SIDEWALK AT THE DRIVEWAY AREA. MATCH EXISTING GRAVEL, AND CONCRETE THICKNESS.

**SITE PLAN APPROVAL
REQUIRED
FRANKLIN PLANNING BOARD**

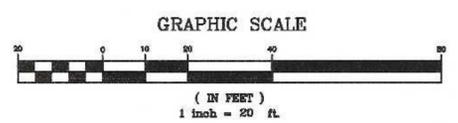

NO.	DATE	DESCRIPTION	BY

DATE	FIELD BY:	INT.
6/19	BL	BL
12/21	FIELD BOOK	PG# 63
12/21	CALCS BY:	RRG
12/21	DESIGNED BY:	RRG
12/21	DRAWN BY:	COMP
12/21	CHECKED BY:	CAQ

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850 FRANKLIN STREET SUITE 11D
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508-384-6580 FAX 508-384-6566

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PROJECT	UC1334
SHEET	4 of 9

GENERAL NOTES


1. PLANTING HOLE SHALL BE THREE TIMES ROOT BALL DIAMETER.
2. ALL INSTALLED PLANT MATERIAL SHALL BEAR THE SAME RELATIONSHIP TO FINISH GRADE (TOP OF PLANTING SOIL MIX), AS IT BORE TO THE NURSERY OR FIELD GRADE.
3. THE PLANTING HOLE DEPTH SHALL PROVIDE FOR A SIX INCH DEPTH OF PLANTING SOIL MIX BELOW THE ANTICIPATED ROOT BALL BOTTOM.
4. NOTWITHSTANDING THE REQUIREMENTS OF NOTES 1 & 3 ABOVE, NO PLANTING HOLE FOR TREES SHALL HAVE LESS THAN ONE CUBIC YARD OF PLANTING SOIL MIX.
5. PLANTING SOIL MIX SHALL BE A LOAM OR SANDY LOAM, AS DEFINED BY THE U.S.D.A. THE FIRST (BOTTOM) SIX INCH LAYER IN THE PRE-EXCAVATED PLANTING HOLE SHALL BE FIRMLY TAMPED TO PREVENT SETTLEMENT OF THE ROOT BALL POSITIONED THEREON. SUBSEQUENT LIFTS TO FINISH GRADE SHALL BE IN SIX INCH LOOSE LIFTS, EACH SETTLED BY THOROUGH SOAKING.
6. UPON ATTAINMENT OF FINISH GRADE WITHIN EACH PLANTING BED, THE GROUND SURFACE SHALL RECEIVE AN EVEN APPLICATION OF ORGANIC NON-PHOSPHORUS FERTILIZER APPLIED PER THE MANUFACTURERS RECOMMENDATIONS.
7. COVERED WITH A THREE INCH NOMINAL DEPTH OF SHREDDED CEDAR BARK (OR APPROVED EQUIVALENT), MAINTAINING A ONE INCH MINIMUM DEPTH AT THE BERM EDGE, AND IMMEDIATELY RISING TO A THREE INCH DEPTH ACROSS THE PLANTING BED OR LANDSCAPE ISLAND. (SEE DETAIL)

PLANTING SCHEDULE


NUMBER	COMMON NAME	SCIENTIFIC NAME	SIZE	CONDITION
4	AMERICAN ELM - AE	ULMUS AMERICANA	3"	B&B
4	RED MAPLE - RM	ACER RUBRUM	3"	B&B
28	ARBORVITAE - A	THUJA PLICATA	4 - 6 FEET	B&B

EXISTING TREE LEGEND:
 R - TO BE REMOVED
 K - TO REMAIN

PLANTINGS FOR 88 AND 94 EAST CENTRAL STREET AREAS - PER SECTION 185-21C(5) PROVIDE 1 TREE PER 10 PARKING SPACES
 - 42 PARKING SPACES LOCATED OUTSIDE OF BUILDING AND INSIDE OF BUILDING = 42 / 10 = 5 TREES
 8 TREES PROVIDED.
 - ALL PLANTINGS ARE IN ACCORDANCE WITH THE TOWN OF FRANKLIN BEST DEVELOPMENT PRACTICES GUIDEBOOK.

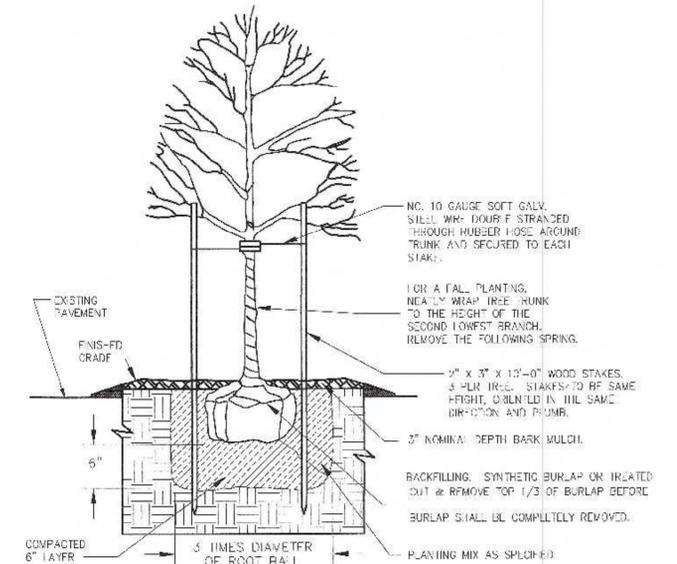

DECIDUOUS TREE PLANTING

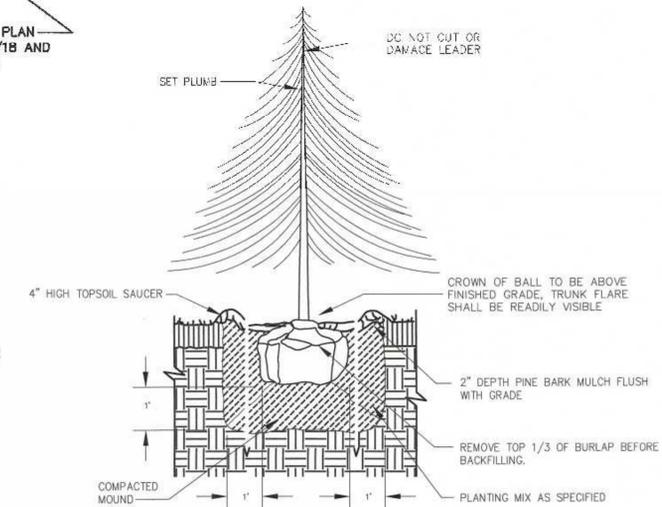

EVERGREEN TREE PLANTING

OWNER:
 MAP 286 PARCELS 32 AND 34
 70 EAST CENTRAL STREET, LLC
 37 EAST CENTRAL STREET
 FRANKLIN, MASSACHUSETTS

OWNER MAP 286 PARCEL 33
 JOHN AND CARMEL SHERRY
 88 EAST CENTRAL STREET

APPLICANT:
 70 EAST CENTRAL STREET, LLC
 37 EAST CENTRAL STREET
 FRANKLIN, MASSACHUSETTS

SITE PLAN MODIFICATION PLANTING PLAN

70, 72, 88 AND 94 EAST CENTRAL STREET
 FRANKLIN, MASSACHUSETTS


PREPARED FOR
 70 EAST CENTRAL STREET, LLC
 37 EAST CENTRAL STREET
 FRANKLIN, MASSACHUSETTS

DECEMBER 24, 2021
 SCALE: 1" = 20'




CARLOS A. QUINTAL P.E. #30812

MAP 286 PARCELS 32 AND 34 ARE TO BE COMBINED. MAP 286 PARCEL 33 HAS A PROPOSED EASEMENT FOR ACCESS AND UTILITIES.

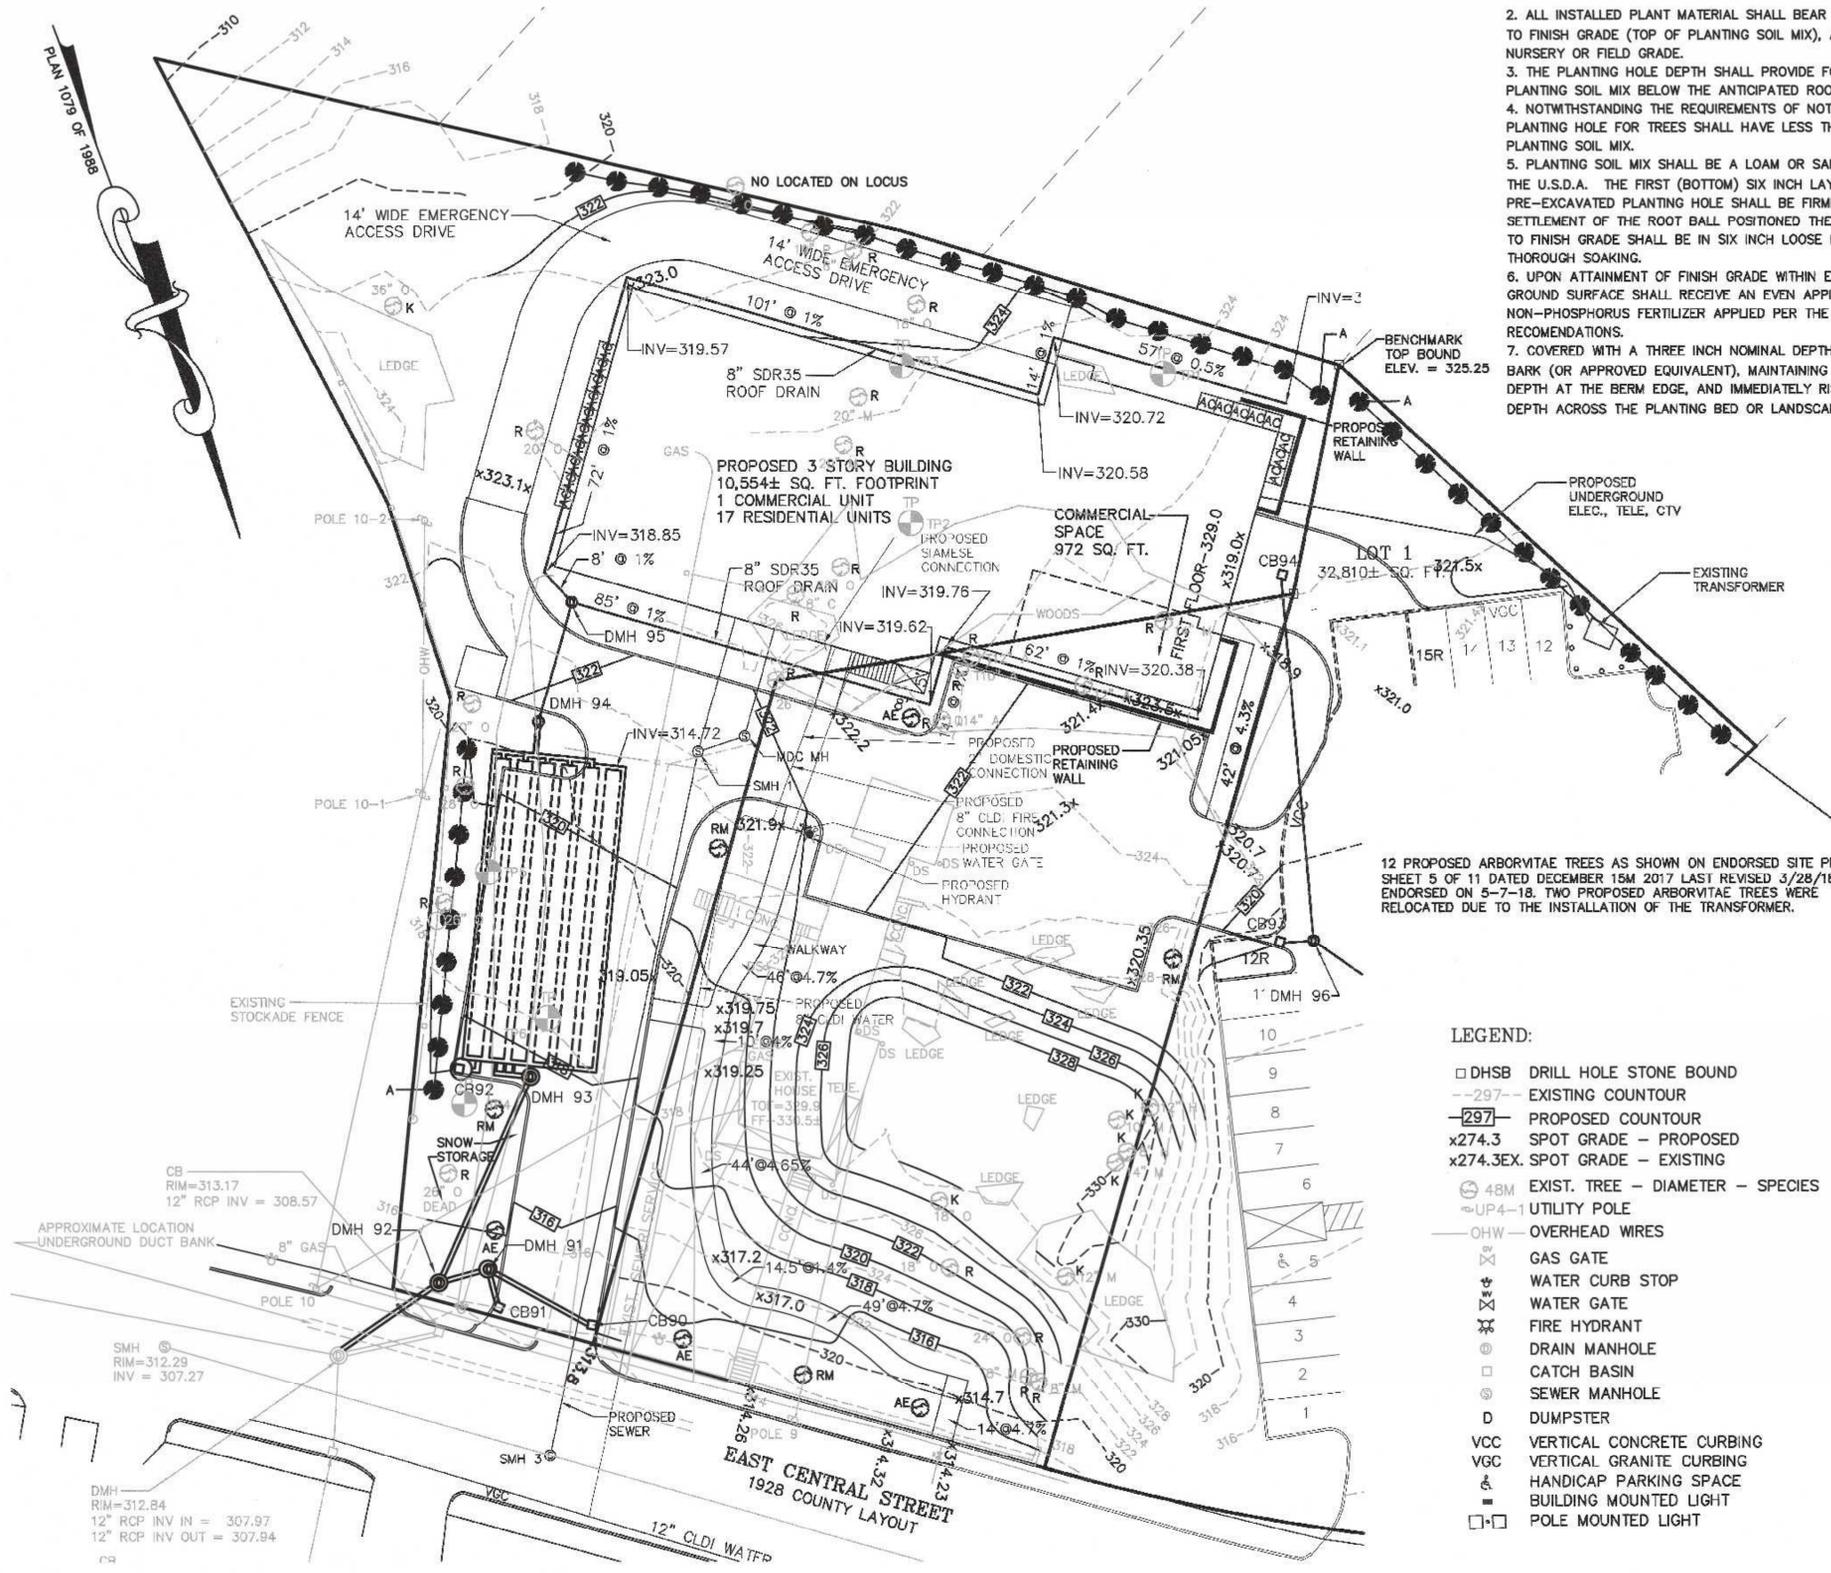

12 PROPOSED ARBORVITAE TREES AS SHOWN ON ENDORSED SITE PLAN SHEET 5 OF 11 DATED DECEMBER 15M 2017 LAST REVISED 3/28/18 AND ENDORSED ON 5-7-18. TWO PROPOSED ARBORVITAE TREES WERE RELOCATED DUE TO THE INSTALLATION OF THE TRANSFORMER.

- LEGEND:
- DHSB DRILL HOLE STONE BOUND
 - - - - - EXISTING COUNTOUR
 - - - - - PROPOSED COUNTOUR
 - x274.3 SPOT GRADE - PROPOSED
 - x274.3EX. SPOT GRADE - EXISTING
 - ⊙ 48M EXIST. TREE - DIAMETER - SPECIES
 - ⊙ UP 4" UTILITY POLE
 - - - - - OHW OVERHEAD WIRES
 - ⊙ GAS GATE
 - ⊙ WATER CURB STOP
 - ⊙ WATER GATE
 - ⊙ FIRE HYDRANT
 - ⊙ DRAIN MANHOLE
 - ⊙ CATCH BASIN
 - ⊙ SEWER MANHOLE
 - ⊙ D DUMPSTER
 - VCC VERTICAL CONCRETE CURBING
 - VGC VERTICAL GRANITE CURBING
 - ⊙ HANDICAP PARKING SPACE
 - ⊙ BUILDING MOUNTED LIGHT
 - ⊙ POLE MOUNTED LIGHT

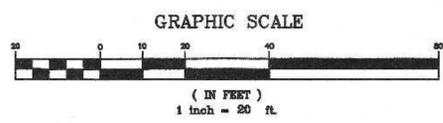


SITE PLAN APPROVAL
 REQUIRED
 FRANKLIN PLANNING BOARD
 DATE

NO.	DATE	DESCRIPTION	BY


DATE	FIELD BY:	INT.
6/19	BL	BL
12/21	FIELD BOOK PG#	
12/21	CALCS BY: RRG	
12/21	DESIGNED BY: RRG	
12/21	DRAWN BY: COMP	
12/21	CHECKED BY: CAQ	

UNITED CONSULTANTS INC.
 850 FRANKLIN STREET SUITE 11D
 WRENTHAM, MASSACHUSETTS 02093
 508-384-8560 FAX 508-384-8568


DATE
 DEC. 24, 2021
 SCALE
 1" = 20'
 PROJECT
 UC1334
 SHEET
 5 of 9

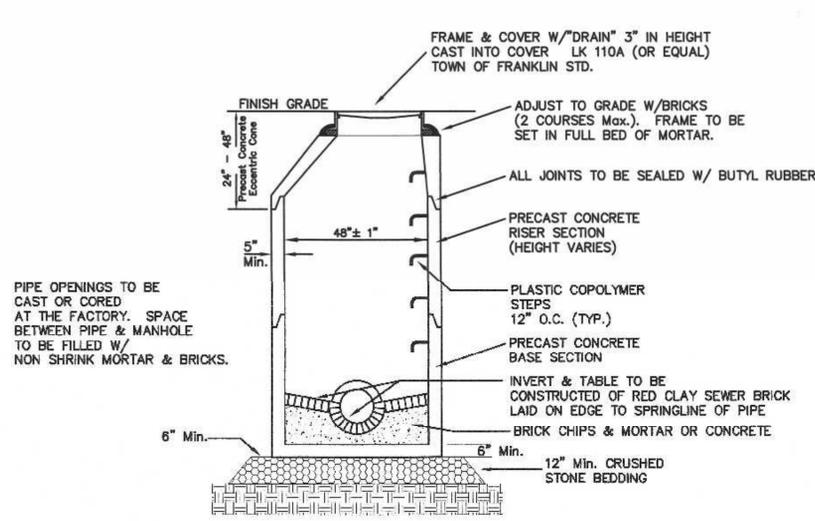


PRECAST DRAIN MANHOLE

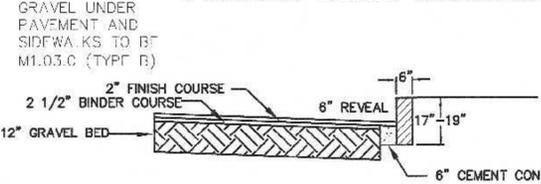


PAVEMENT AND VA-4 VERTICAL GRANITE CURBING

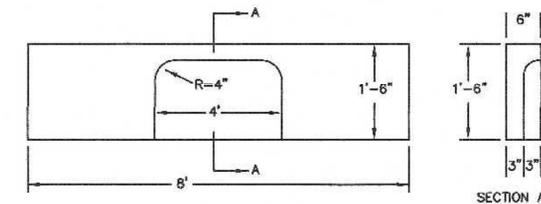


GRANITE CURB INLET DETAIL

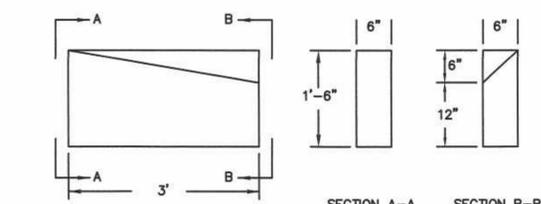


GRANITE CURB TRANSITION DETAIL

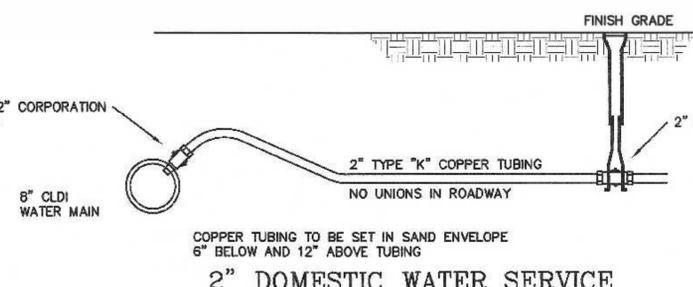

2" DOMESTIC WATER SERVICE

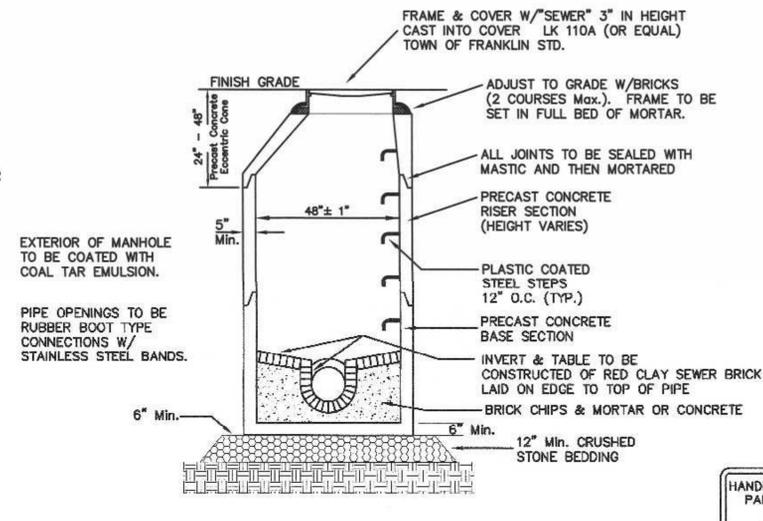

PRECAST SEWER MANHOLE

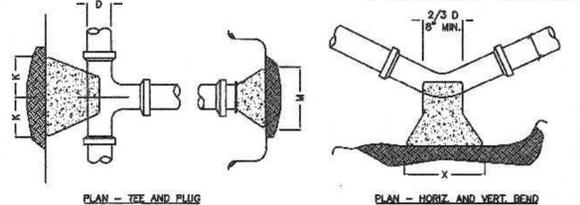


SIZE OF BRANCH	J	K	L	M	N	D
4" TO 8"	10"	10"	1'-0"	2'-0"	1'-8"	10"
10" TO 16"	1'-0"	1'-8"	1'-8"	3'-10"	2'-10"	1'-8"
24"	1'-4"	2'-0"	2'-8"	5'-0"	3'-8"	1'-8"

TEES AND PLUGS


90 & 45 BENDS	22 1/2 & 11 1/4
D 4" TO 8" 10" TO 16" 24"	4" TO 6" 10" TO 16" 24"
X 1'-8" 3'-4" 3'-8" 1'-4" 2'-0" 3'-8"	
Y 1'-2" 1'-8" 2'-4" 1'-0" 1'-2" 2'-4"	

BENDS


THRUST BLOCK DETAILS

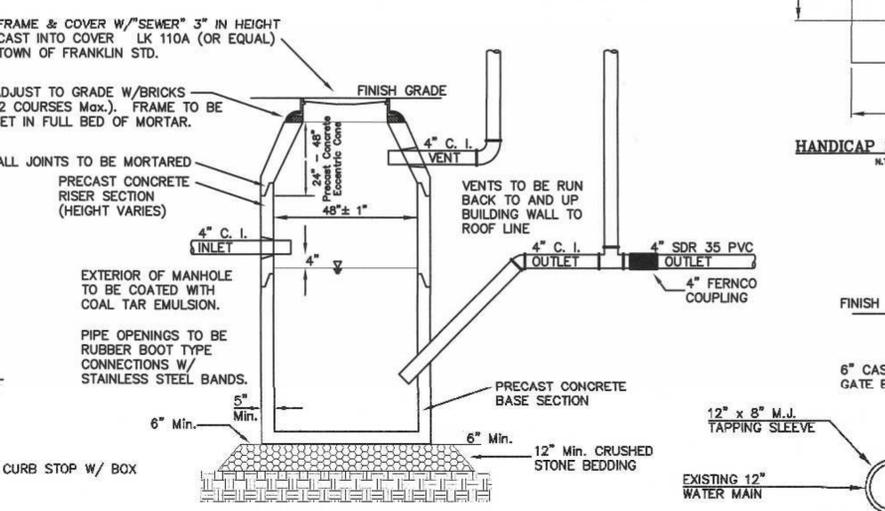


M.D.C. STYLE TRAP

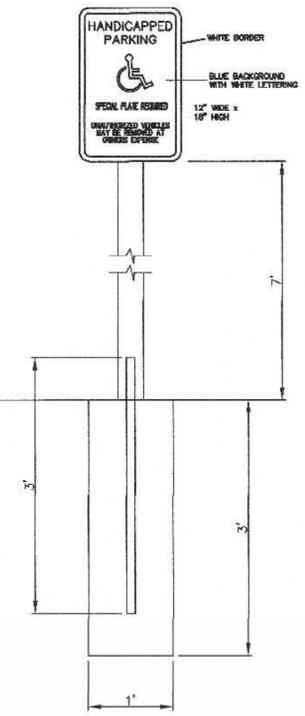

HANDICAP SIGN DETAIL

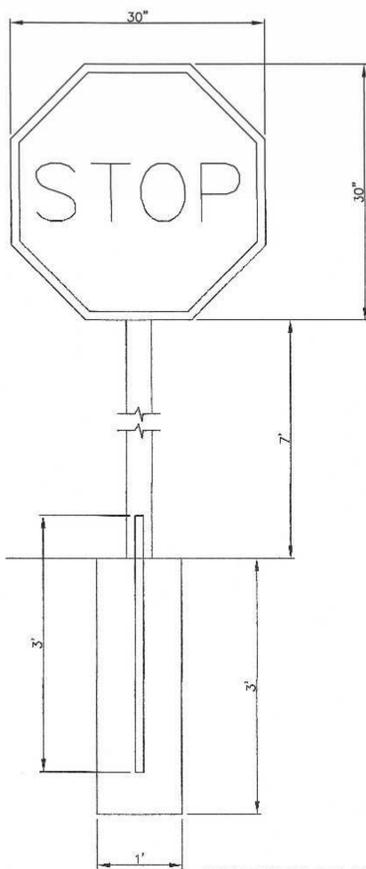


STOP SIGN DETAIL

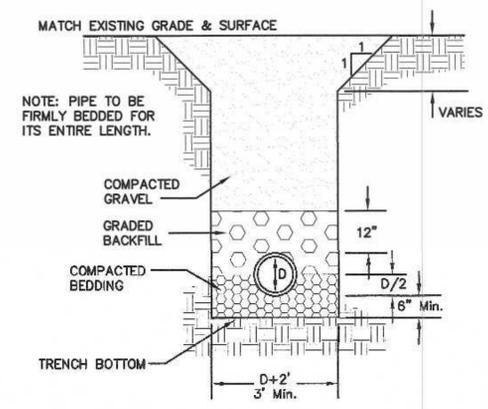


UTILITY TRENCH DETAIL

TYPE OF PIPE	RCP DRAIN	CLDI WATER	PVC SEWER	D.I. SEWER
BEDDING	PROC. GRAVEL	SAND	3/4" STONE	3/8" STONE
BACKFILL	ORD. FILL	SAND	3/4" STONE	3/8" STONE

UTILITY TRENCH DETAIL

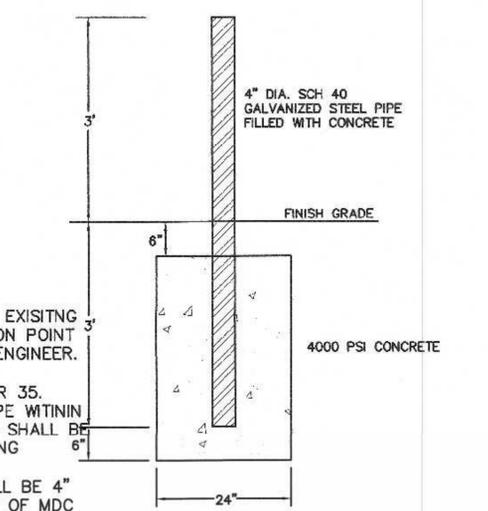

BOLLARD DETAIL

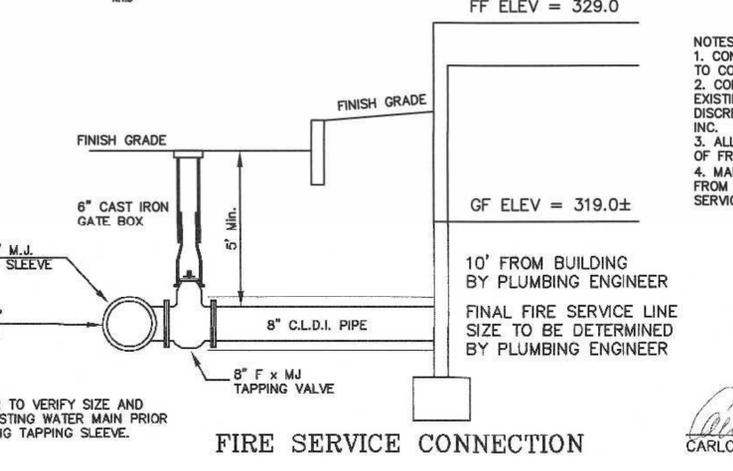

FIRE SERVICE CONNECTION

CONTRACTOR TO CONFIRM EXISTING ELEVATIONS AT CONNECTION POINT. NOTIFY THE DESIGN ENGINEER.

SEWER PIPE TO BE 8" SDR 35. SEWER PIPE SIZE AND TYPE WITHIN 10 FEET OF THE BUILDING SHALL BE PROVIDED BY THE PLUMBING ENGINEER. SEWER PIPE TO MDC SHALL BE 4" CAST IRON INTO AND OUT OF MDC MANHOLE. REFER TO DETAIL FOR CONNECTION TO PVC.

- NOTES:**
- CONTRACTOR TO CONTACT DIGSAFE PRIOR TO COMMENCEMENT OF CONSTRUCTION.
 - CONTRACTOR TO VERIFY LOCATIONS OF EXISTING UTILITIES ANY REPORT ANY DISCREPANCIES TO UNITED CONSULTANTS, INC.
 - ALL WORK SHALL CONFORM TO THE TOWN OF FRANKLIN DPW STANDARDS.
 - MAINTAIN A MINIMUM OF 10' SEPARATION FROM THE WATER SERVICE TO THE SEWER SERVICE.

OWNER:
MAP 286 PARCELS 32 AND 34
70 EAST CENTRAL STREET, LLC
37 EAST CENTRAL STREET
FRANKLIN, MASSACHUSETTS

OWNER MAP 286 PARCEL 33
JOHN AND CARMEL SHERRY
88 EAST CENTRAL STREET

APPLICANT:
70 EAST CENTRAL STREET, LLC
37 EAST CENTRAL STREET
FRANKLIN, MASSACHUSETTS


SITE PLAN MODIFICATION
CONSTRUCTION DETAIL PLAN - 1
70, 72, 88 AND 94 EAST CENTRAL STREET
FRANKLIN, MASSACHUSETTS
PREPARED FOR
70 EAST CENTRAL STREET, LLC
37 EAST CENTRAL STREET
FRANKLIN, MASSACHUSETTS
DECEMBER 24, 2021
SCALE: 1" = 20'



CARLOS A. QUINTAL P.E. #30812

SITE PLAN APPROVAL
REQUIRED
FRANKLIN PLANNING BOARD

DATE _____

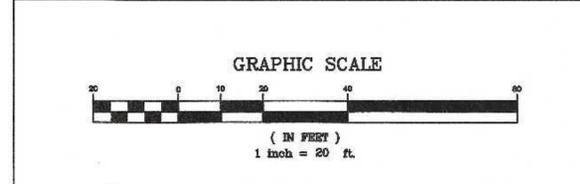

NO.	DATE	DESCRIPTION	BY

DATE	FIELD BY:	INT.
6/19	BL	
BK# 74	FIELD BOOK	PG# 63
12/21	CALCS BY:	RRG
12/21	DESIGNED BY:	RRG
12/21	DRAWN BY:	COMP
12/21	CHECKED BY:	CAQ

UNITED CONSULTANTS INC.
850 FRANKLIN STREET SUITE 11D
WRENTHAM, MASSACHUSETTS 02093
508-384-6560 FAX 508-384-6566

DATE
DEC. 24, 2021

SCALE
1" = 20'

PROJECT
UC1334

SHEET
7 of 9


CSR	Hydro Conduit	DR. BY:
	STC 4501 Precast Concrete Stormceptor® (450 US Gallon Capacity)	CK. BY:
	PROJECT LOCATION:	DATE:
		SCALE: N.T.S.
		DWG.#

SECTION THRU CHAMBER


SECTION THRU PLAN VIEW

NOTE:


- THE USE OF FLEXIBLE CONNECTIONS IS RECOMMENDED AT THE INLET AND OUTLET WHERE APPLICABLE.
- THE COVER SHOULD BE POSITIONED OVER THE CLEANOUT/VENT PIPE.
- THE STORMCEPTOR SYSTEM IS PROTECTED BY ONE OR MORE OF THE FOLLOWING U.S. PATENTS: #4985148, #5498331, #5725760, #5753115, #5849181.

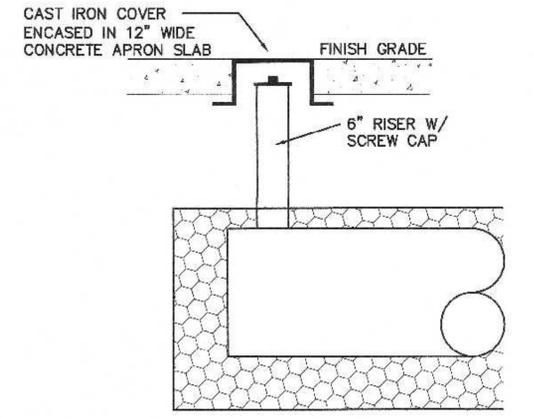

**INSPECTION PORT DETAIL
DRAINAGE INFILTRATION AREAS**
N.T.S.

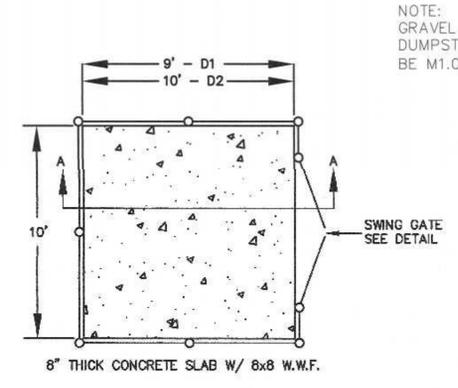


CONCRETE DUMPSTER PAD

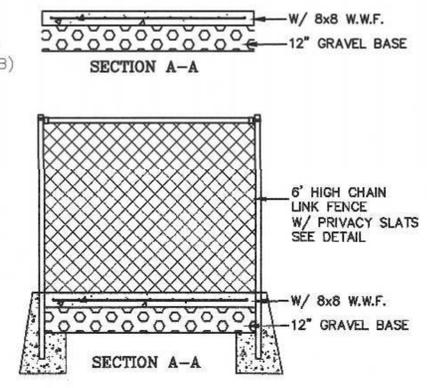

DUMPSTER AREA FENCE

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DRAINAGE INFILTRATION AREA

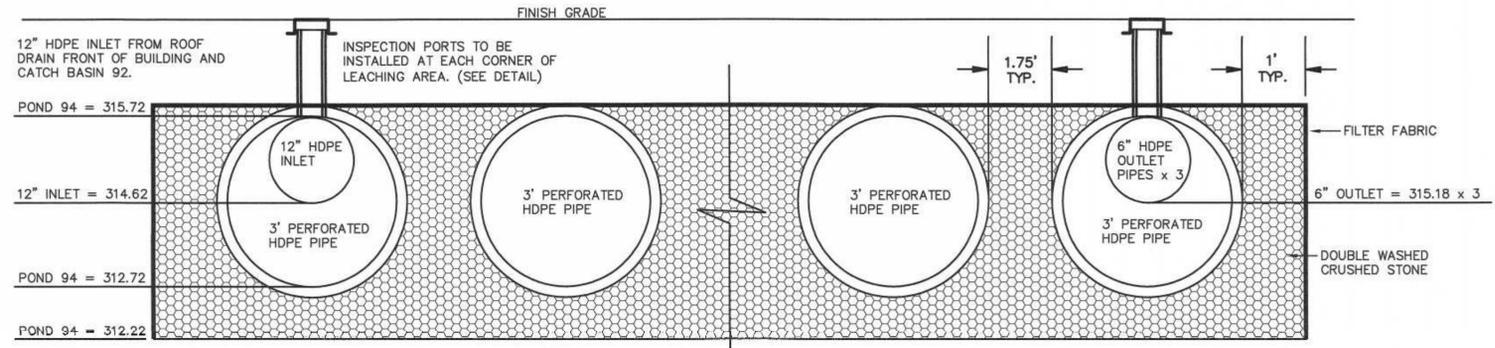
NOTE:
INFILTRATION POND 94
CONSISTS OF 6 ROWS OF 3'
DIAMETER PERFORATED HDPE
PIPE 70' IN LENGTH.
STONE EXTENTS 31.75' X 72'

THE DESIGN ENGINEER SHALL INSPECT THE EXCAVATION OF THE SOIL INFILTRATION AREA PRIOR TO ANY FILL BEING PLACED.

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OWNER MAP 286 PARCEL 33
JOHN AND CARMEL SHERRY
88 EAST CENTRAL STREET

APPLICANT:
70 EAST CENTRAL STREET, LLC
37 EAST CENTRAL STREET
FRANKLIN, MASSACHUSETTS

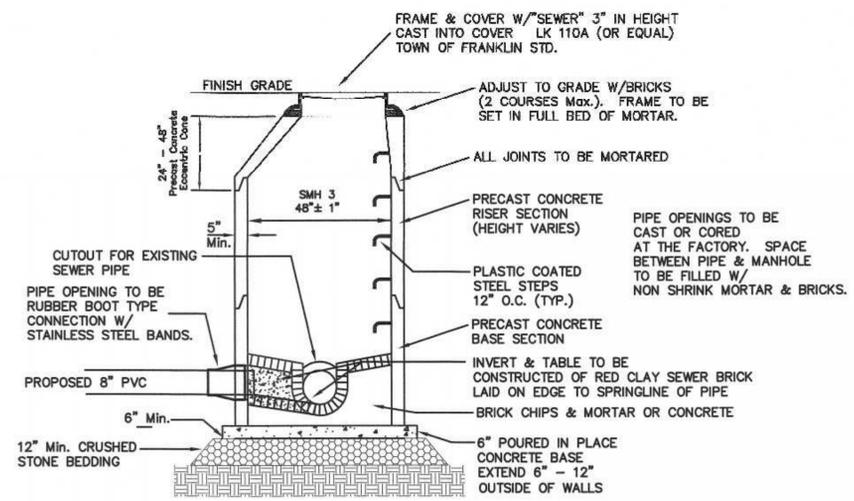

PRECAST DOG HOUSE SEWER MANHOLE


SITE PLAN MODIFICATION
CONSTRUCTION DETAIL PLAN - 2
70, 72, 88 AND 94 EAST CENTRAL STREET
FRANKLIN, MASSACHUSETTS
PREPARED FOR
70 EAST CENTRAL STREET, LLC
37 EAST CENTRAL STREET
FRANKLIN, MASSACHUSETTS
DECEMBER 24, 2021
SCALE: 1" = 20'



Carlos A. Quintal
CARLOS A. QUINTAL P.E. #30812

SITE PLAN APPROVAL
REQUIRED
FRANKLIN PLANNING BOARD

DATE

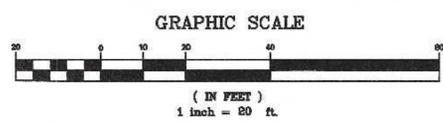


NO.	DATE	DESCRIPTION	BY


DATE	FIELD BY:	INT.
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**UNITED
CONSULTANTS
INC.**
850 FRANKLIN STREET SUITE 11D
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508-384-8560 FAX 508-384-8566


DATE	DEC. 24, 2021
SCALE	1" = 20'
PROJECT	UC1334
SHEET	8 of 9

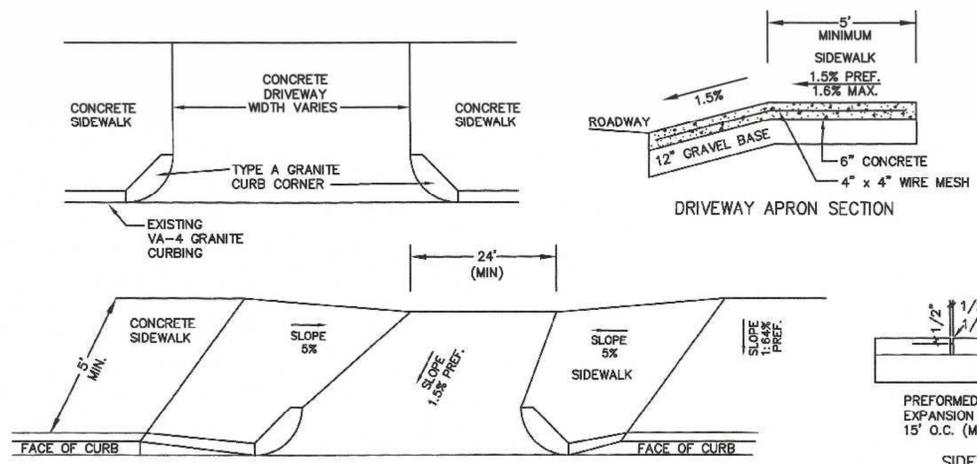


NOTES:
 1. CROSS SLOPE ON ANY RAMP, LANDING OR ACCESSIBLE ROUTE SHALL NOT EXCEED 3/16" PER FOOT.
 2. THE SIDEWALKS ARE 5' MINIMUM IN WIDTH.
 3. ALL SIDEWALKS SHALL BE 4,000 PSI CONCRETE.
 4. GRAVEL UNDER SIDEWALK TO BE M1.03.0 (TYPE B)

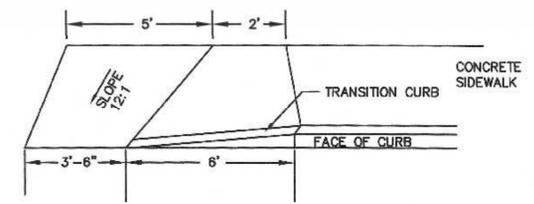

WHEELCHAIR RAMP

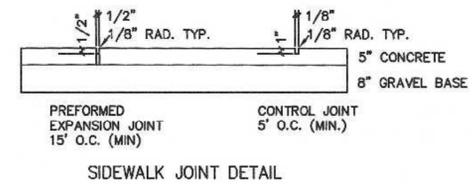

SIDEWALK JOINT DETAIL

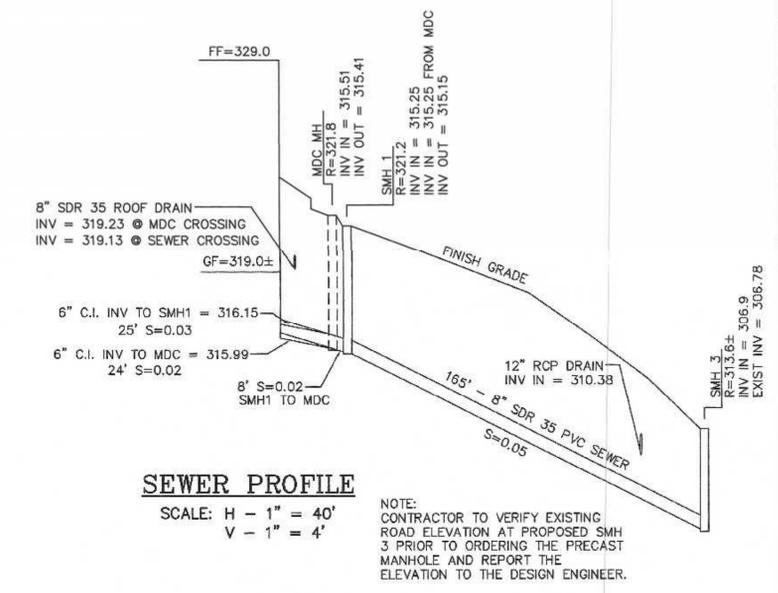


SEWER PROFILE

SCALE: H - 1" = 40'
 V - 1" = 4'

NOTE:
 CONTRACTOR TO VERIFY EXISTING ROAD ELEVATION AT PROPOSED SMH 3 PRIOR TO ORDERING THE PRECAST MANHOLE AND REPORT THE ELEVATION TO THE DESIGN ENGINEER.


SEWER NOTE:
 THE PROJECT PLUMBING ENGINEER SHALL CONFIRM THE ELEVATIONS OF THE SEWER CONNECTIONS UPON COMPLETION OF THE FLOOR DRAIN DESIGN. ANY REVISIONS SHALL BE REPORTED TO THE DESIGN ENGINEER PRIOR TO COMMENCING WITH CONSTRUCTION.

DRIVEWAY APRON

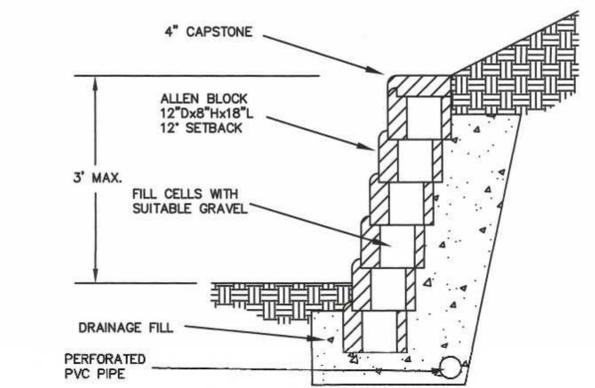



RETAINING WALL DETAIL

N.T.S.

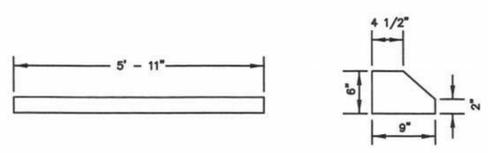

BUMPER CURB DETAIL

BUMPER CURB SHALL BE E.F. SHEA ITEM NO. B-BBSF OR APPROVED EQUAL.

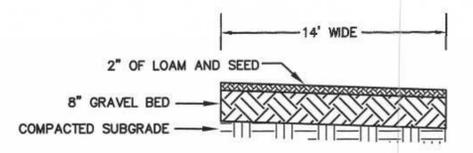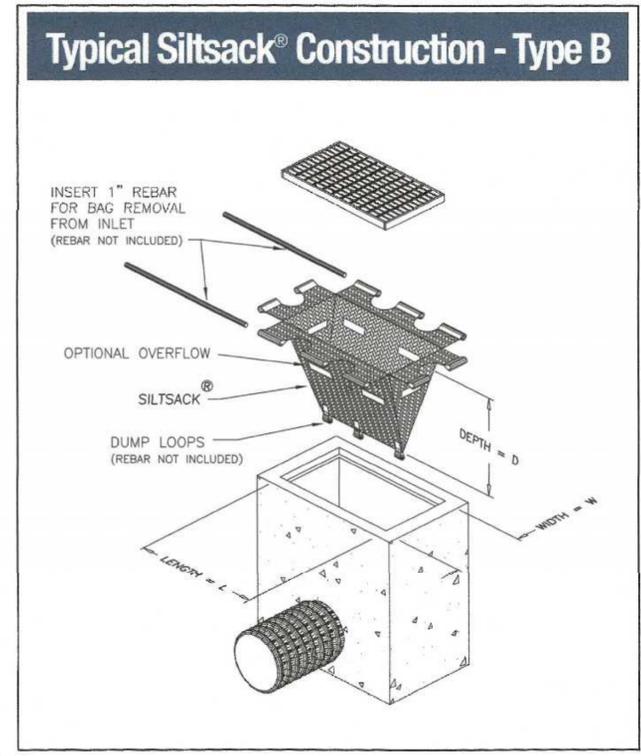

EMERGENCY ACCESS DRIVE




Carlos A. Quintal
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SITE PLAN MODIFICATION
 CONSTRUCTION DETAIL PLAN - 3
 70, 72, 88 AND 94 EAST CENTRAL STREET
 FRANKLIN, MASSACHUSETTS
 PREPARED FOR
 70 EAST CENTRAL STREET, LLC
 37 EAST CENTRAL STREET
 FRANKLIN, MASSACHUSETTS
 DECEMBER 24, 2021
 SCALE: 1" = 20'

SITE PLAN APPROVAL REQUIRED
FRANKLIN PLANNING BOARD

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OWNER MAP 286 PARCEL 33
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12/21	COMP	
12/21	CAQ	

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UC1334
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9 of 9

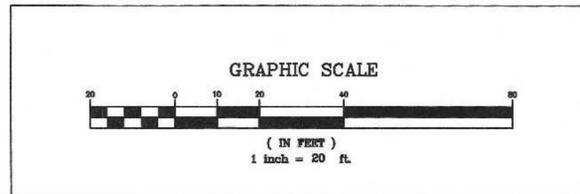

