DESIGN REVIEW COMMISSION AGENDA

August 8, 2023

7:00 PM

Virtual Meeting

Due to the growing concerns regarding the COVID-19 virus, we will be conducting a remote/virtual Design Review Commission Meeting. In an effort to ensure citizen engagement and comply with open meeting law regulations, citizens will be able to dial into the meeting using the provided phone number (Cell phone or Landline Required) OR citizens can participate by copying the link (Phone, Computer, or Tablet required). Please click on https://zoom.us/j/93879275725 or call on your phone at 1-929-205-6099, meeting ID is 93879275725

7:00 PM Gardner – 125 Constitution Blvd.

Replace existing monument and wall signs faces to reflect rebranding

7:05 PM Big Y – 348 East Central Street

Rebrand Big Y with new logo signage – reface existing pylon sign – Replace existing building signs

7:10 PM Alpine Place – 40 Alpine Row

Renovate existing office building with new offices and warehouse space. Construction of new mixed-use 28 unit apartment building w/ground level parking and commercial space.

General Matters: Approval of Minutes:

Old Business: New Business: Adjourn

COMMENTS: These listing of matters are those reasonably anticipated by the Chair which may be discussed at the meeting. Not all items listed may in fact be discussed and other items not listed may also be brought up for discussion to the extent permitted by law. This agenda is subject to change. Next meeting is 8/22/2023

FORM Q

TOWN OF FRANKLIN DESIGN REVIEW APPLICATION FOR §185-31(2) OF THE ZONING BY-LAW

A) General Information
Name of Business or Project:GARDIOR
Property Address 125 Consitivition BivD.
Assessors' Map #_ 319-014-000 Parcel #
Zoning District (select applicable zone):
Zoning History: Use Variance
B) Applicant Information:
Applicant Name: Approve CLARK EXPOSE SICNS + CRAPHICS
Address: 3 LANDING LANT HOPE PALE MA 01747
Telephone Number: 508 - 381 - 694/
Contact Person: KEVIN ROSINBIRG
C) Owner Information (Business Owner & Property Owner if different)
Business Owner: GARDIER Property Owner: SAME Address: 125 COSTINTUN BLVD FRANKLIN
All of the information is submitted according to the best of my knowledge Executed as a sealed instrument this day of 20
Signature of Applicant Signature of Owner
Print name of Applicant STEVE GOLOMAN COD Print name of Owner


*FOR SIGNS COMPLETE PAGES 1 & 2 ONLY. FOR SITE PLANS, BUILDING PLANS, PROJECTS, COMPLETE PAGES 1 – 4

SEE ADDENDA ATTACHED FOR ASSISTANCE IN COMPLETION OF FORM Q

a. Sign Company
Business Name: CYPOSE SICOS & CRAPHICS INC. Contact Person: Andrew CLARK Address 3 LANDING LANE, HOPEPALE MA 01747
Contact Person: Anna CLASK
Address 3 1 ADDIN 1 ANE HARIOALE MA 01747
Telephone Number: 508 381-0941
300 331 041
b. Architect/Engineer (when applicable)
Rusiness Name: 1/1
Contact Persons
Business Name: Contact Person: Address
Tolonborn New Low
Address Telephone Number:
E) Work Summary
Summary of work to be done: FABRICATE + REPLACE EXISTENCE MENUMENT
+ WALL SIGNS FALCES DO ROTLOT REBRANDING NO CHANCE TO CURRENT
SIZE ON LOCATION FOR ETTYER. PLMS ATTACYOR
F) Information & Materials to be Submitted with Application
-,
a) <u>FOR SIGN SUBMISSIONS ONLY</u> :
THE FOLLOWING MUST BE SUBMITTED ELECTRONICALLY TO
Mkinhart@franklinma.gov
1. Drawing of Proposed Sign which must also include
type of sign (wall, pylon etc.) / colors /
size/dimensions materials style of lettering lighting-illuminated, non-illuminated and style
style of lettering / lighting-illuminated, non-illuminated and style
2 Duraning and/on mintages in direction 1 and in Committee Committ
2. Drawing and/or pictures indicating location of new sign.
2. Distance of existing location and signs (if any in the state of the location)
3. Picture of existing location and signs (if previously existing location)
b) FOR BUILDINGS/DEVELOPMENTS OR PROJECT SUBMISSIONS:
b) FOR BUILDINGS/DEVELOTMENTS OR I ROJECT SUBMISSIONS:
THE FOLLOWING MUST BE SUBMITTED W/APPLICATION to Mkinhart@franklinma.gov
1 Chapter in the Land and the District Chapter in the Chapter in t
1. Site Plan including Landscape Plan showing plantings. Plantings must be from Best Development
Practices Guide
2. Lighting Plan indicating lighting levels & specifications of proposed lights
3. Building drawings, indicating size and height of building(s); front, rear and side elevations
(when there are no adjoining buildings) and floor plans
4. Drawings or pictures of existing conditions
5. If any signage on the building or site, provide information from above Signage Checklist

D) Architect/Engineer/Sign Company Information (if not the applicant)

SIGNS & GRAPHICS, INC. 13 Aliphort Read - Hope-table MA phone 598,281,0941 fax 598,381,2794 VANWASDOGESGRAMS French Rivd. Fr	BUILD BY: Chevity	Proposed: 1445 in White Polycorbonate Panel 1445 in White Polycorbonate Panel 145 in White Polycorbonate Panel	Existing: Response ponent with new cart with new cart	EXPOSE ONLY LASER SHOP EXPOSE / F.H. ROUTER METAL FAB. ENGRAVE MINITURINATION PAINT SUBVENDOR Shop Vinyl Install Prod. Original POSE / F.H. ROUTER METAL FAB. ENGRAVE MINITURINATION AND MATERIAL (Theck Stock) Needed / Ordered / Supplied Approval Date: 04/28/2023	JOB# 20288 EST#
		REPLACE DOSTING PANELWITH NEW PANEL & VIRTH CRAPHICS	INIA OTHER: VILVY - COLORGE PAS 0720 / PAS 4660 TYPE EXTENOR SUPFACE PAST WELL: STANDARD NA FIRA ONLY:	DANIES MATERIAL: POLYTANBONATE SZE 30"N x 144"W THOONESS: \$718"0 COLOR: WHITE MOUNTHE: DUSTING PLDG BOX	FILE PATH: \\Mainserver\g\Production

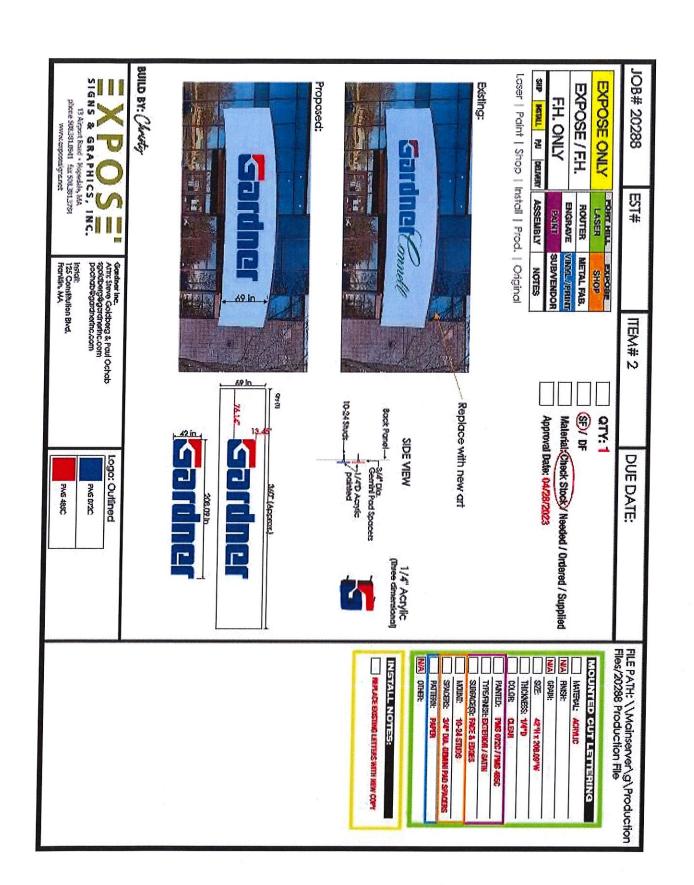

FORM Q

TOWN OF FRANKLIN DESIGN REVIEW APPLICATION FOR §185-31(2) OF THE ZONING BY-LAW

A) General Information
Name of Business or Project: BIGY
Property Address 348 MAIN STREET
Assessors' Map # 285 Parcel # 008 PARCELID: 285-008-000
Zoning District (select applicable zone):CBCD - COMMERCIAL II
Zoning History: Use Variance Non-Conforming Use
B) Applicant Information:
Applicant Name: GRAPHIC IMPACT SIGNS, INC
Address: 575 DALTON AVENUE PITTSFIELD, MA OIZOI
Telephone Number: 800-458-2376
Contact Person: JOHN ZENZI
C) Owner Information (Business Owner & Property Owner if different)
Business Owner: BIGY FOODS, INC Address: 2145 ROOSEVELT NENUE SPRINGFIELD, MA 01102 Property Owner: BIGY FOODS, INC 2145 ROOSEVELT AVENUE SPRINGFIELD, MA 01104-1650
All of the information is submitted according to the best of my knowledge Executed as a sealed instrument this 11 day of JVLY 2023
Signature of Applicant Signature of Owner
TOHN RENZI Print name of Applicant CURTIS THORINGTON Print name of Owner

*FOR SIGNS COMPLETE PAGES 1 & 2 ONLY. FOR SITE PLANS, BUILDING PLANS, PROJECTS, COMPLETE PAGES 1 – 4

SEE ADDENDA ATTACHED FOR ASSISTANCE IN COMPLETION OF FORM Q

D) Architect/Engineer/Sign Company Information (if not the applicant)
a. Sign Company
Business Name: GRAPHIC IMPACT SIGNS, INC
Contact Person: JOHN RENZI
Address 575 DALTON AVE, PITSFIELD, MA 01201
Telephone Number: 800-458-2376
b. Architect/Engineer (when applicable)
Business Name:
Contact Person:
Address
AddressTelephone Number:
E) Work Summary
C. Landa Janes School Plant (1971) 1000 SKANGE
Summary of work to be done: REBRAND BIG Y WITH NEW LOGO SIGNAGE
- REPLACE EXISTING PYLON SIGN "BIGY - YOUR FAMILY MARKET" & "TABLE LYINE" - REPLACE EXISTING BUILDING SIGNS "BIGY - YOUR FAMILY MARKET" & "WINE & BEER'-TABLE LYINE"
KELEVICE EXISTING BRICHING 2002 DIG 1-TOOK LYMINES INVINCES & MINES AND THE AND AND THE AND
F) Information & Materials to be Submitted with Application
a) FOR SIGN SUBMISSIONS ONLY:
THE FOLLOWING MUST BE SUBMITTED ELECTRONICALLY TO Mkinhart@franklinma.gov
1. Drawing of Proposed Sign which must also include
✓ type of sign (wall, pylon etc.) ✓ colors
/ type of sign (wan, pyton etc.) / colors
 ✓ size/dimensions ✓ style of lettering ✓ lighting-illuminated, non-illuminated and style
Style of fettering Inglitting-multimated, non-multimated and style
2. Drawing and/or pictures indicating location of new sign.
3. Picture of existing location and signs (if previously existing location) 🗸
b) FOR BUILDINGS/DEVELOPMENTS OR PROJECT SUBMISSIONS:
THE FOLLOWING MUST BE SUBMITTED W/APPLICATION to Mkinhart@franklinma.gov
1. Site Plan including Landscape Plan showing plantings. Plantings must be from Best Development
Practices Guide
2. Lighting Plan indicating lighting levels & specifications of proposed lights
3. Building drawings, indicating size and height of building(s); front, rear and side elevations
(when there are no adjoining buildings) and floor plans
4. Drawings or pictures of existing conditions
5. If any signage on the building or site, provide information from above Signage Checklist



ph. 800.458.2376 fax. 413.443.0034 gisigns.com

Big Y 348 East Central Street Franklin, MA 7-11-2023

Building Frontage = 312 Feet

Existing Building Signage Audit:

Sign	Size	Square Footage	Quantity	Total Square Footage
Big Y	8' 6" H x 16' 6" W	140.25	1	140.25
World Class Market	1' 3" H x 21' 0" W	26.25	1	26.25
American Owned	1' 3" H x 19' 4" W	24.17	1	24.17
Sushi Chef	1' 3" H x 11' 3" W	14.06	1	14.06
Sandwich Shop	1' 3" H x 15' 4" W	19.17	1	19.17
Hearth Baked Pizza	1' 3" H x 19' 2" W	23.96	1	23.96
Bouquets	1' 3" H x 9' 9" W	12.19	1	12.19
Butcher Shop	1' 3" H x 14' 0" W	17.50	1	17.50
Bakery	1' 3" H x 7' 3" W	9.06	1	9.06
Fish & Chips	1' 3" H x 12' 0" W	15.00	1	15.00
Delicatessen	1' 3" H x 13' 0" W	16.25	1	16.25
Beer & Wine	1' 3" H x 11' 9" W	14.69	1	14.69
	Total Sign Square	Footage: 332.	52	

Proposed Building Sign Plan:

Sign	Size	Square Footage	Quantity	Total Square Footage
Big Y	132" H x 132" W	121.00	1	121.00
Your Family Market	13" H x 226.5" W	20.50	1	20.50
Wine & Beer	16.38" H x 167" W	19.00	1	19.00
Table & Vine	16" H x 121" W	13.45	1	13.45
	Total Sign Square	Footage: 173.	.95	

Proposed



Existing





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Sales Rep: J. Renzi Job Name: Big Y

Job Location: Franklin, MA

Sheet: 1 of 7

Date: 5/24/22

Job #:

Scale: as noted

Drawn by: LH

Big Y 348 Main Street Franklin, MA Rev 7/5/23

APPROVED

APPROVED AS NOTED

CLIENT SIGNATURE


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A...(1)...Storefront Internally Illuminated Logo Signage...NTS logo circle= 121 sq. ft.

- * 8" deep aluminum fabricated circular flex-face extruded sign with bleed face retainer...edges and retainer painted Big Y Red
- * internally illuminated with 6500 K white SloanLED²⁴ Prism low voltage LED modules ...60W 120VAC power supplies contained within cabinet..UL listings
- * 3M white panaflex flex face with translucent 3M 3630-73 Dark Red vinyl applied graphics
- * sign cabinet mounts to window mullion system (self drill/tap into existing mullion extrusions)
- * non-illum. "YOUR FAMILY MARKET " letters are .50" thick Type 1 PVC letters painted Black...stud mount flush to fascia



A...(1)...Single Sided Storefront Internally Illuminated Logo Signage Details...NTS

* UL listed with disconnect switch

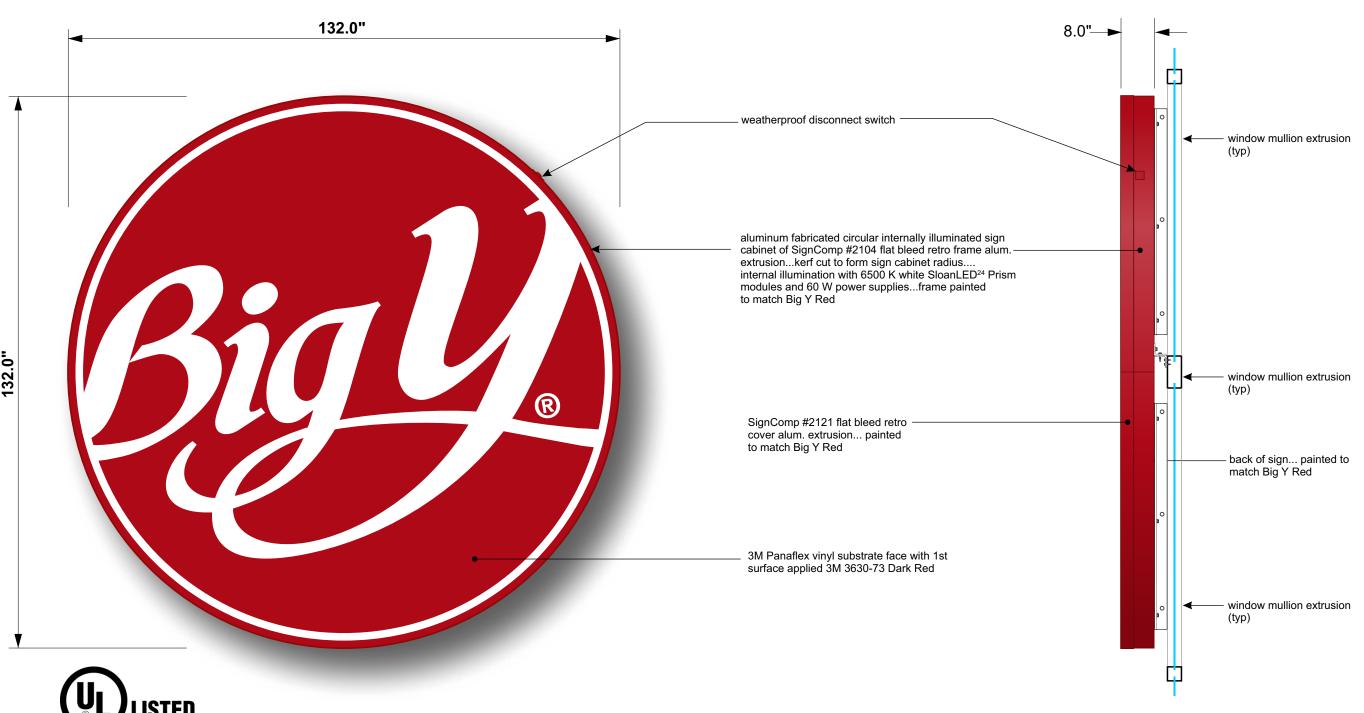

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Sales Rep: J. Renzi Job Name: Big Y

Job Location: Franklin, MA
Sheet: 2 of 7

Date: 6/20/22

Job #:

Scale: as noted

Drawn by: LH

Big Y 348 Main Street Franklin, MA Rev 7/5/23

APPROVED


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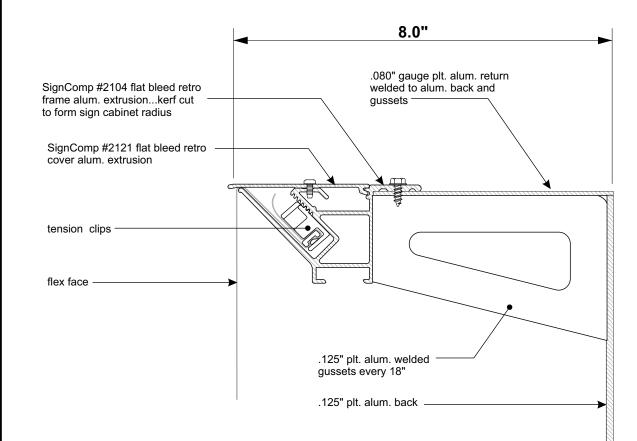
CLIENT SIGNATURE

DATE


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Section A



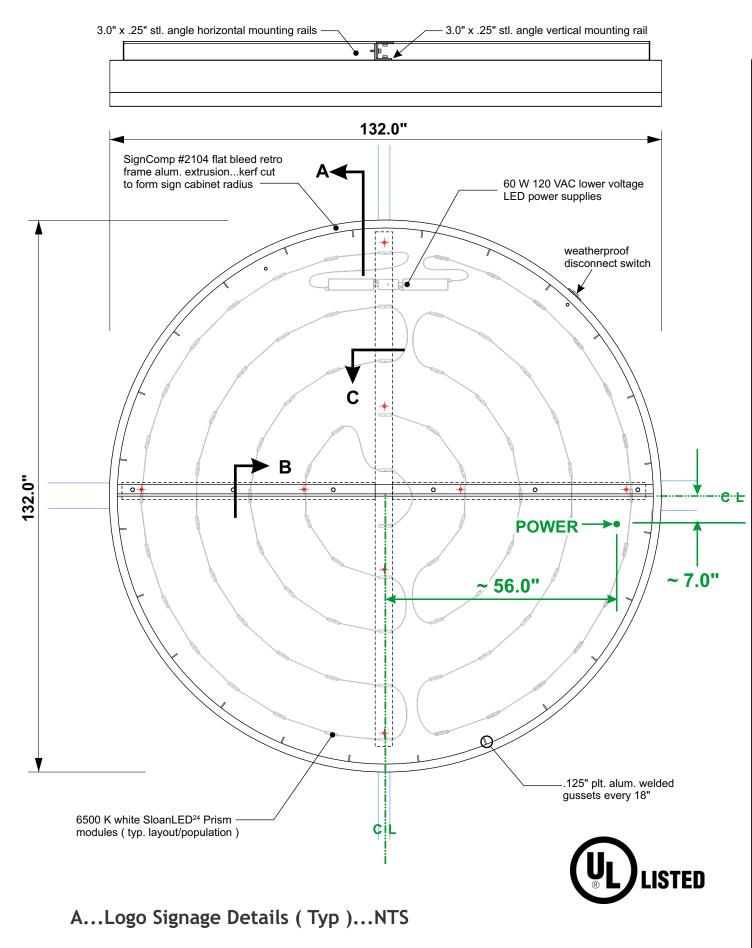

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Sales Rep: J. Renzi

Job Name: Big Y

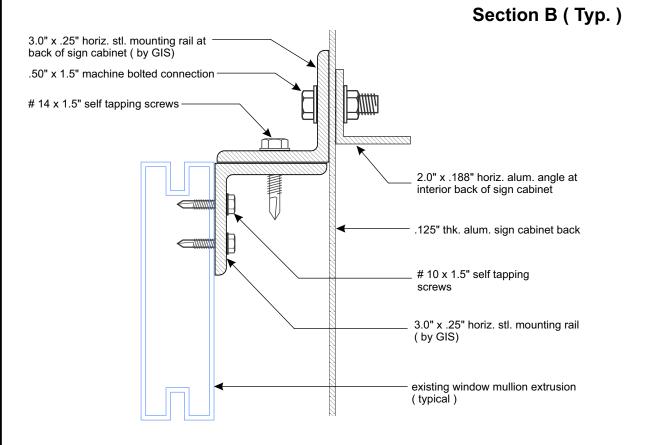Job Location: Franklin, MA

Sheet: 3 of 7

Date: 6/20/22

Job #:

Scale: as noted

Drawn by: LH

Big Y 348 Main Street Franklin, MA Rev 7/5/23


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Sales Rep: J. Renzi Job Name: Big Y

Job Location: Franklin, MA

Sheet: 4 of 7

Date: 6/20/22

Job #:

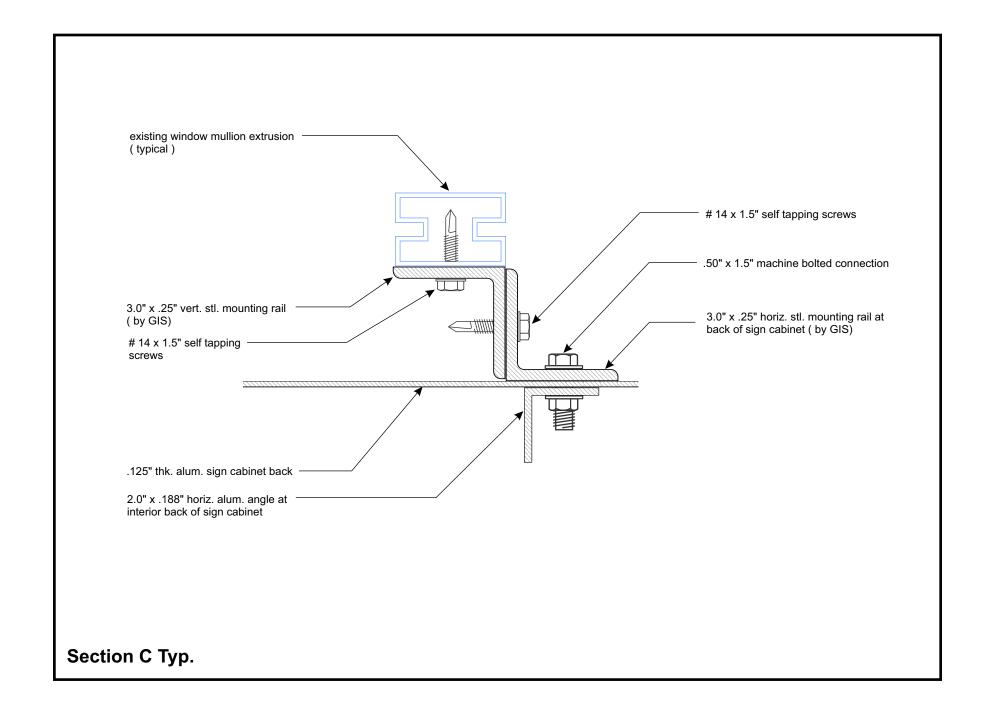Scale: as noted

Drawn by: LH

Big Y 348 Main Street Franklin, MA Rev 7/5/23

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DATE

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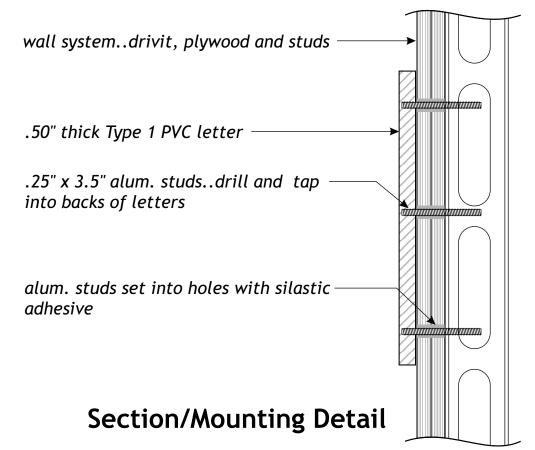
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Signs.



B...(1)...Set "YOUR FAMILY MARKET" Dimensional Letter Signage...NTS

20.5 sq. ft.

^{* .50&}quot; thick CAM routered Type 1 PVC letters painted Satin Black...mount flush to fascia with aluminum studs and silastic adhesive





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Sales Rep: J. Renzi

Job Name: Big Y

Job Location: Franklin, MA

Sheet: 5 of 7

6/20/22

Date:
Job #:

Scale: as noted


Drawn by: LH

Big Y 348 Main Street Franklin, MA Rev 7/5/23

	APPROVED
	APPROVED AS NOTED
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Existing (to be removed)



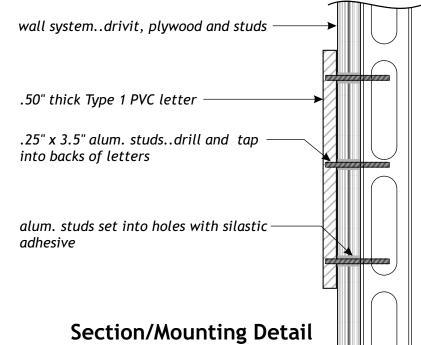

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Sales Rep: J. Renzi
Job Name: Big Y
Job Location: Franklin, MA

Sheet: 6 of 7

Date: 6/20/22

Job #:

Scale: as noted

Drawn by: LH

Big Y 348 Main Street Franklin, MA Rev 7/5/23

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19.0 sq. ft.

* .50" thick CAM routered Type 1 PVC letters painted Satin Black...mount flush to fascia with aluminum studs and silastic adhesive

D...(1)...Set "TABLE & VINE "Dimensional Letter Signage...NTS

13.5 sq. ft.

* .50" thick CAM routered Type 1 PVC letters painted Satin Black...mount flush to fascia with aluminum studs and silastic adhesive



remove SUSHI CHEF BOUQUETS BOUQUETS

remove remove & replace



remove & replace remove











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Sales Rep: J. Renzi

Job Name: Big Y

Job Location: Franklin, MA

Sheet: 7 of 7

6/20/22

Date: Job #:

Scale: as noted

Drawn by: LH

Big Y 348 Main Street Franklin, MA Rev 7/5/23

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CLIENT SIGNATURE

DATE

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Existing



Proposed





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Sales Rep: J. Renzi

Job Name: Big Y

Job Location: Franklin, MA

Sheet: 1 of 1

Date: Job #:

Scale: as noted

6/20/22

Drawn by: LH

Big Y 348 Main Street Franklin, MA

APPROVED

APPROVED AS NOTED

CLIENT SIGNATURE

DATE

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FORM Q

TOWN OF FRANKLIN DESIGN REVIEW APPLICATION FOR §185-31(2) OF THE ZONING BY-LAW

A) <u>General Information</u>
Name of Business or Project: ALPINE PLACE
Property Address 40 Alpine Row
Assessors' Map #_279 Parcel # _181
Zoning District (select applicable zone):Downtown Commercial District
Zoning History: Use VarianceNon-Conforming Use
B) Applicant Information:
Applicant Name: NEW GENERATION CUSTOM HOMES CORP
Address: 5 Exchange Street, Suite 4 Milford, MA 01757
Telephone Number: _(508)377-2395
Contact Person:Marcelo Alves
C) Owner Information (Business Owner & Property Owner if different)
Business Owner: _Marcelo Alves Property Owner: Alpine Place LLC Address: _8 Puffer Drive
All of the information is submitted according to the best of my knowledge Executed as a sealed instrument this day of June 2023
Signature of Applicant Marcelo Alves Print name of Applicant Signature of Owner Marcelo Alves Print name of Owner

*FOR SIGNS COMPLETE PAGES 1 & 2 ONLY. FOR SITE PLANS, BUILDING PLANS, PROJECTS, COMPLETE PAGES 1 – 4

SEE ADDENDA ATTACHED FOR ASSISTANCE IN COMPLETION OF FORM Q

D) Architect/Engineer/Sign Company Information (if not the applicant) a. Sign Company Business Name: Dennis Colwell Architects Contact Person: __Bob Boynton_____bob@dc-architect.com____ Address _132 Central Street, Suite 203, Foxborough, MA 02035_____ Telephone Number: _(508)241-2122 x104______ b. Architect/Engineer (when applicable) Business Name: Contact Person: ____ Address Telephone Number: E) Work Summary Summary of work to be done: Renovating existing office building with new offices and warehouse space Construction of new mixed-use 28-unit apartment building w/ ground level parking and commercial space____

F) Information & Materials to be Submitted with Application

a) FOR SIGN SUBMISSIONS ONLY:

THE FOLLOWING MUST BE SUBMITTED ELECTRONICALLY TO Mkinhart@franklinma.gov

1. Drawing of Proposed Sign which must also include

type of sign (wall, pylon etc.) colors size/dimensions materials

size/dimensions materials style of lettering lighting-illuminated, non-illuminated and style

- 2. Drawing and/or pictures indicating location of new sign.
- 3. Picture of existing location and signs (if previously existing location)

b) FOR BUILDINGS/DEVELOPMENTS OR PROJECT SUBMISSIONS:

THE FOLLOWING MUST BE SUBMITTED W/APPLICATION to Mkinhart@franklinma.gov

- 1. Site Plan including Landscape Plan showing plantings. Plantings must be from Best Development Practices Guide
- 2. Lighting Plan indicating lighting levels & specifications of proposed lights
- **3**. Building drawings, indicating size and height of building(s); front, rear and side elevations (when there are no adjoining buildings) and floor plans
- **4**. Drawings or pictures of existing conditions
- 5. If any signage on the building or site, provide information from above Signage Checklist

DESIGN STANDARDS

Explain how each of the design standards outlined below has been incorporated into the design of the proposed development. Fill in the information in the spaces provided or use a separate sheet.

1. Height —The height of any proposed alteration shall be compatible with the style and character of the surrounding buildings, within zoning requirements. The proposed apartment building is a residential apartment building with architectural features/elements that complement the existing neighborhood. The existing commercial building has been vacant for some time and new owner is looking to set up their personal business in that on
2. Proportions of Windows and Doors – The proportions and relationships between doors and windows shall be compatible with the architectural style and character of the surrounding area. The apartment building will have double-hung windows and glass sliders that are similar to other properties around. The existing commercial building has existing storefront that will be repaired/replaced
3. Relations of Building Masses and Spaces – The relationship of a structure to the open space between it and adjoining structures shall be compatible. The existing streetscape has buildings close to the street. The proposed apartment building mimics this with the proposed commercial space being accessed directly from the street with an adjacent patio for people to use
4. Roof Shape – The design and pitch of the roof shall be compatible with the architectural style and character of the surrounding buildingsThe proposed apartment building will have a mansard roof compatible with existing properties in the area. The existing commercial building has an existing flat roof but we will be altering the geometry of exiting front canopy to provide more cub appeal (proposed sloped metal roof)
5. Scale – The scale of the structure shall be compatible with its architectural style and the character of the surrounding buildings. While larger than adjacent properties, the proposed apartment building meets all the criteria of the current bylaw and is similar in scale to other newer properties in the area
6. Façade, Line, Shape & Profile – Facades shall blend with other structures in the surrounding area with regard to the dominant vertical or horizontal context: The proposed apartment is broken up architecturally (materials/banding/trim/balconies) so as to fit within the context of the surrounding area. Existing commercial space will have the existing masonry façade altered to soften its look and fi better with the surrounding buildings

7. **Architectural Details** – Architectural details, including signs, materials, colors and textures shall be treated so as to be compatible with the existing and adjacent architectural character, thereby preserving and enhancing the surround area. _All proposed site/building elements, colors, and textures, signs, materials will fit in with fabric of the current neighborhood and will embrace and enhance it ______

permanent signs and outdoor advertising structures shall not detract from the use and enjoyment of the proposed buildings and structures and the surrounding propertiesAny proposed signage/advertising will not detract from the neighborhood.
9. Heritage – Removal or disruption of historic, traditional or significant uses, structures or architectural elements shall be minimized insofar as practicable. No know heritage elements to be impacted by proposed work
10. Energy Efficiency – To the maximum extent reasonably practicable, proposals shall utilize energy efficient technology and renewable energy resources and shall adhere to the principles of energy-conscious design with regard to orientation, building materials, shading, landscaping and other elements. Proposed apartment building will fall under the latest IECC energy codes and will be equipped with high efficiency doors, windows, HCAV equipment, The existing building will have new updated equipment installed that will operate at a higher efficiency than what is currently in place
11. Landscape - The landscape should improve the character and appearance of the surrounding area and parking areas should be located to the side or rear of buildings when reasonably possible. Currently there is minimal landscaping as the existing site has a lot of pavement. The proposed landscaping will be an improvement on what is currently there and will fit within the surrounding neighborhood

SEE ADDENDA ATTACHED FOR INSTRUCTIONS TO ASSIST IN COMPLETING APPLICATION.

ADDENDA

INSTRUCTIONS FOR COMPLETION OF FORM Q-DESIGN REVIEW APPLICATION

A. General Information

- Please list name of Business as it will appear on sign or name of project or development, as the case may be, as well as the property address
- Assessors' Map & Parcel numbers may be obtained from tax bill, Town website @ www.franklin.ma.us/Town/Assessors/PropertyTax or from the computer located outside the Assessor's Office, first floor, Municipal Building, 355 East Central Street.
- Zoning District and Zoning History information may be obtained at the Building Department, 1st floor, Municipal Building
- B. Applicant Information complete and include name of contact person w/ phone number
- C. Owner Information if business owner and property owner are not the same, please include information for both. If signage is within a shopping plaza—obtain letter of approval of sign changes from plaza owner.

Page 2 –

- D. Architect/Engineer or Sign Company Information:
 - Signs only Name of Sign Company and Contact Person
 - Developments & Projects Engineer and Architect Information as well
- E. Work Summary: Include brief summation of work to be done

Pages 3 & 4

- F. Information & Materials to be Submitted via email (Mkinhart@franklinma.gov) w/Application a) SIGNS ONLY
 - sign drawings and photos, which include information listed on Page 2 of the application
 - b) SITE PLAN APPLICATIONS FOR BUILDINGS/DEVELOPMENTS/PROJECTS.
 - all plans including information listed on Page 2 of application.
 - Please bring samples of siding and roofing materials and paint color samples to the meeting when scheduled.

<u>**DESIGN STANDARDS**</u> – For Buildings/Projects and Developments, please complete Pages 3 and 4 as they apply to your project.


ALL APPLICATIONS WITH SUPPLEMENTARY INFORMATION MUST BE FILED BY 4:00 PM ON THE WEDNESDAY PRIOR TO THE FOLLOWING TUESDAY MEETING. MEETINGS ARE GENERALLY TWICE A MONTH THE $2^{\rm ND}$ & $4^{\rm TH}$ TUESDAY OF THE MONTH.


FOR SIGN APPLICATIONS ONLY, YOU NEED ONLY COMPLETE PAGES 1 & 2 OF APPLICATION.

THE ENGINE YARD

SITE REDEVELOPMENT 40 ALPINE ROW

FRANKLIN, MASSACHUSETTS

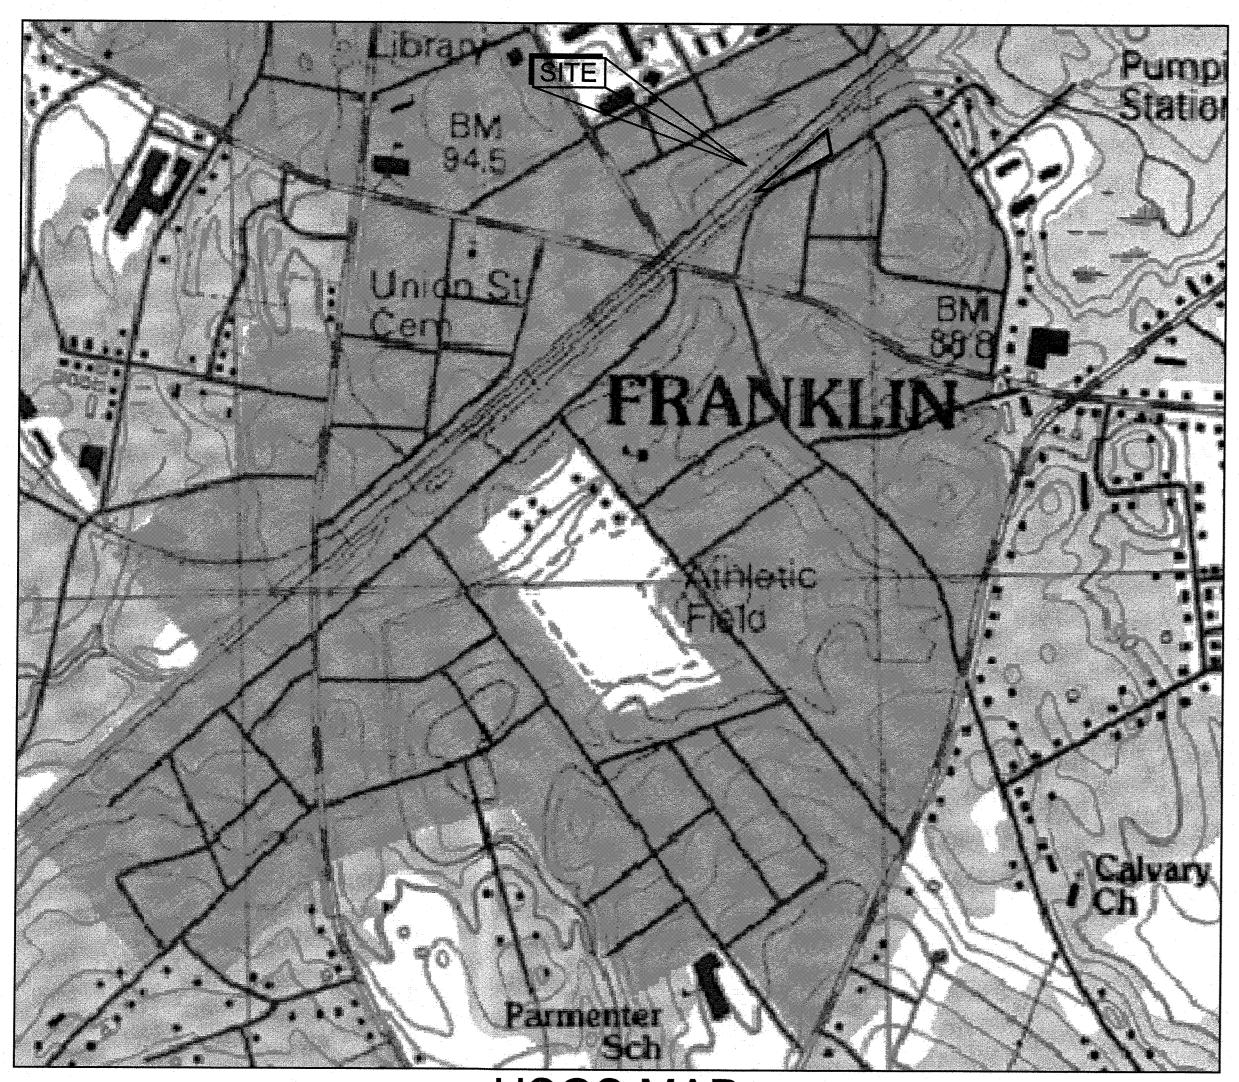

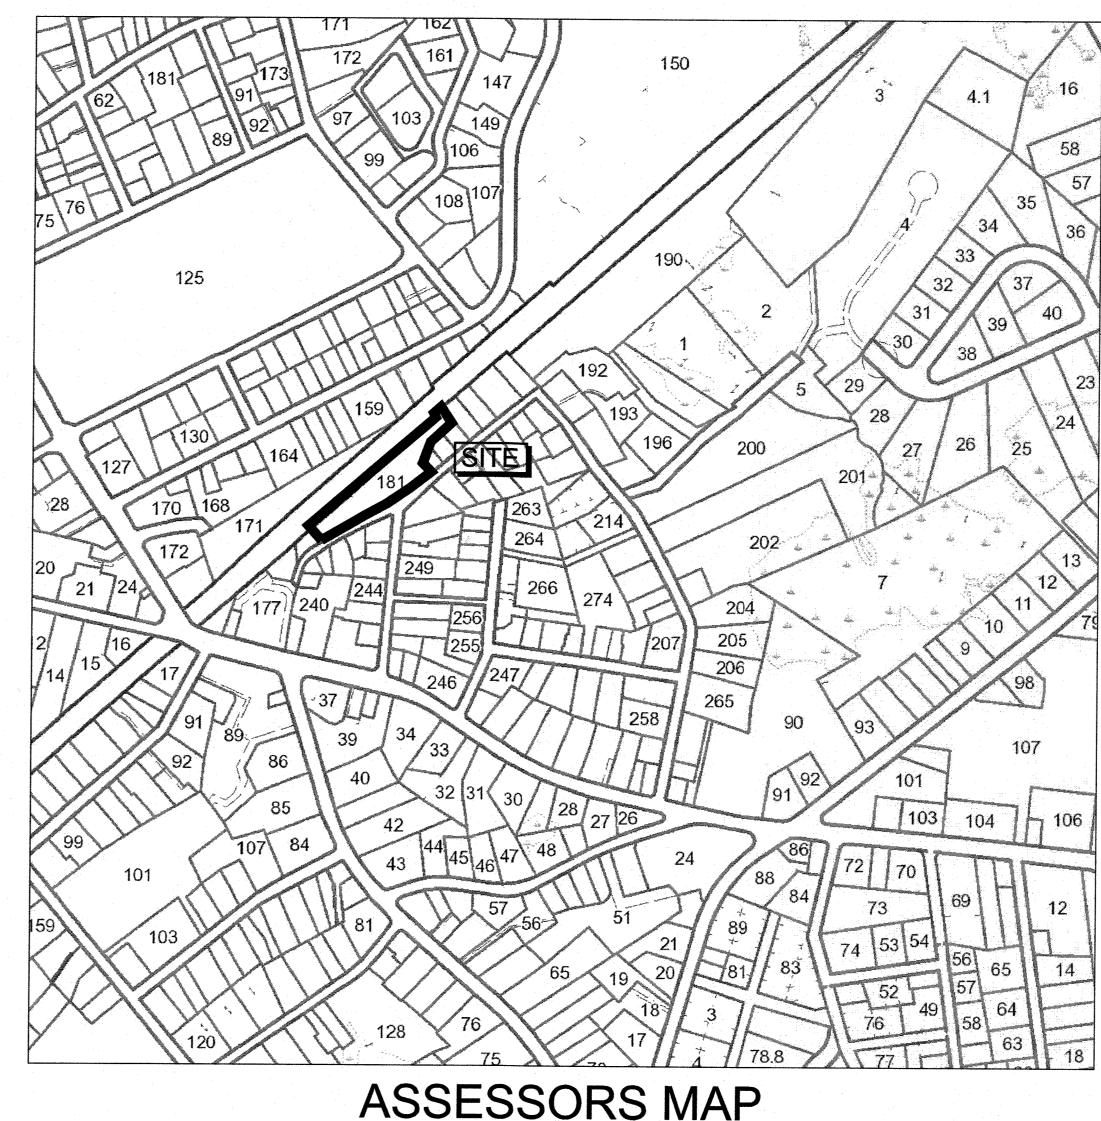

USGS MAP

SCALE: $1" = 1,000' \pm$

Town of Franklin

Planning Board

CERTIFICATE OF VOTE

Site Plan Modification 40 Alpine Row

"The Engineer Yard, Site Redevelopment, 40 Alpine Row"

Please be advised that at its meeting on Monday, November 1, 2021 the Planning Board voted (4-0-1), upon motion duly made and seconded to APPROVE, with conditions, the above referenced Site Plan. The Conditions of Approval are listed on page 2-3, attached hereto. Both the Certificate of Vote as well as the

Franklin, MA 02038

Walker Development & Construction, Inc.

5 Mount Royal Ave, Suite 40

Level Design Group, Plainville, MA

Marlborough, MA 01752

40 Alpine Roy

conditions of approval shall be referenced on the site plan.

November 3, 2021

Town of Franklin

Property Location:

Dear Mrs. Danello:

Franklin Planning Board

cc: Owner/Applicant/ Applicant's Engineer

355 East Central Street

Franklin, MA 02038

Nancy Danello, Town Clerk

M N 15 A 6 22

CERTIFICATE OF VOTE

40 Alpine Row The Planning Board will use outside consultant services to complete construction inspections upon the commencement of construction. The Franklin Department of Public Works Director, directly and brough employees of the Department of Public Works and outside consultant services shall act as the Planning Board's inspector to assist the Board with inspections necessary to ensure compliance with all relevant laws, regulations and Planning Board approved plan specifications. Such consultants shall be selected and relained upon a majority vote of the Board.

Actual and reasonable costs of inspection consulting services shall be paid by the owner/applicant before or at the time of the pre-construction meeting. Should additional inspections be required beyond the original scope of work, the owner/applicant shall be required to submit fees prior to the issuance of a Final Certificate of Completion by the Planning Board (Form H). Said inspection is further outlined in condition #1. No alteration of these plans shall be made or affected other that by an affirmative vote of the members

of the Board at a duly posted meeting and upon the issuance of a written amended decision. All applicable laws, by-laws, rules, regulations, and codes shall be complied with, and all necessary icenses, permits and approvals shall be obtained by the owner/applicant.

5. Prior to the endorsement of the site plan, the following shall be done: The owner/applicant shall provide the entire list of conditions and this Certificate of Vote on the A notation shall be made on the plans that all crosion mitigation measures shall be in place prior to major construction or soil disturbance commencing on the site.

All outstanding invoices for services rendered by the Town's Engineers and other reviewing

Departments of the Town relative to their review of the owner/applicant's application and plans

- shall have been paid in full. All required improvements specified in this Certificate of Vote shall be constructed within a one-year period unless the Board grants an extension. No final Certificate of Occupancy shall be assued until all requirements of the approved plan have been completed to the satisfaction of the Board unless the applicant has submitted a Partial Certificate of Completion for the remainder of the required
- Improvements. The applicant's engineer or surveyor, upon completion of all required improvements, shall submit a Certificate of Completion. The Board or its agent(s) shall complete a final inspection of the site upon filing of the Certificate of Completion by the applicant. Said inspection is further outlined Prior to any work commencing on the subject property, the owner/applicant shall provide plans to limit construction debris and materials on the site. In the event that debris is carried onto any public way, the owner/applicant and his assigns shall be responsible for all cleanup of the roadway. All cleanups shall occur within twenty-four (24) hours after first written notification to the owner/applicant by the Board or
- The owner/applicant shall install erosion control devices as necessary and as directed by the Town's

such public way is clear of debris.

Maintenance and repair of the parking area, water supply system, sewer pipes, electric distribution system, and stormwater system shall be the responsibility of the owner/applicant and shall never be the responsibility of the Town and the Town shall never be required to perform any service, repair or aintenance with respect to said areas, or any of the aforementioned systems within the subject property. The Town will never be required to provide snow plowing or trash pickup, with respect to the

its designee. Pailure to complete such cleanup may result in suspension of construction of the site until

Page 2 of 3

10. Prior to construction activities, there shall be a pre-construction meeting with the owner/applicant, and his contractor(s), the Department of Public Works and the Planning Board's Observation Contractor.

CERTIFICATE OF VOTE 40 Alpine Row

- 1. BETA recommends a condition that requires guardrail to be installed at all parking stalls adjacent to the railroad right-of-way or retaining walls. 2. Provide fencing for fall protection where walls exceed 30° in height and/or along the entirety of the
- railroad right-of-way where none exists today. 3. Final wall design to be provided at the start of construction to confirm parking stall lengths will not be impacted by the wall, fence or guardrail.
- 4. Final plans to provide a ramp at westerly accessible aisle prior to endorsement. 5. All easements to be in place to the satisfaction of the DPW prior to the issuance of a certificate of
- 6. All roof top units should be screened in accordance with the Proposed Roof Plan, dated October 8,
- 7. Provide a detailed grading at bases of retaining wall at the time of construction adjacent to residential properties to ensure positive drainage.
- 8. Applicant will provide pavement per §300-10.F(4). DPW and Annicent are to resolve the encroachment issue prior to the start of construction.

9.	DPW and A	applicant a	re to resoi	ve the end	roachment	issue prior to	the start of	construction

Page 3 of 3

SCALE: 1"= 250'±

1 06/21/2021 PERMITTING SUBMISSION 2 09/13/2021 RESPONSE TO COMMENTS 3 10/04/2021 RESPONSE TO COMMENTS 4 10/19/2021 RESPONSE TO COMMENTS 5 11/30/2021 APPROVAL CONDITIONS

APPLICANT:

WALKER DEVELOPMENT & CONSTRUCTION 5 MT. ROYAL AVE MARLBOROUGH, MA 01752

CIVIL ENGINEER:



PROPERTY ADDRESS:

40 ALPINE ROW

FRANKLIN, MASSACHUSETTS

ASSESSORS MAP/PARCEL: 279-181-000-000

ZONING DISTRICT: DOWNTOWN COMMERCIAL


DRAWING LIST:

	<u> </u>
C-0.0	COVER
C-1.0	EXISTING CONDITIONS
C-2.0	LAYOUT AND MATERIALS
C-3.0	GRADING AND UTILITIES
C-3.1	EROSION CONTROL
C-4.0	TYPICAL DETAILS
C-4.1	TYPICAL DETAILS
LA-01-LA-04	LANDSCAPE PLANS
AL-001	PHOTOMETRIC

EXISTING BUILDING ELEVATIONS EXTERNAL ELEVATIONS

EXTERNAL ELEVATIONS EXTERNAL ELEVATIONS EXTERNAL SIGNAGE

PROPOSED BUILDING RENDERINGS

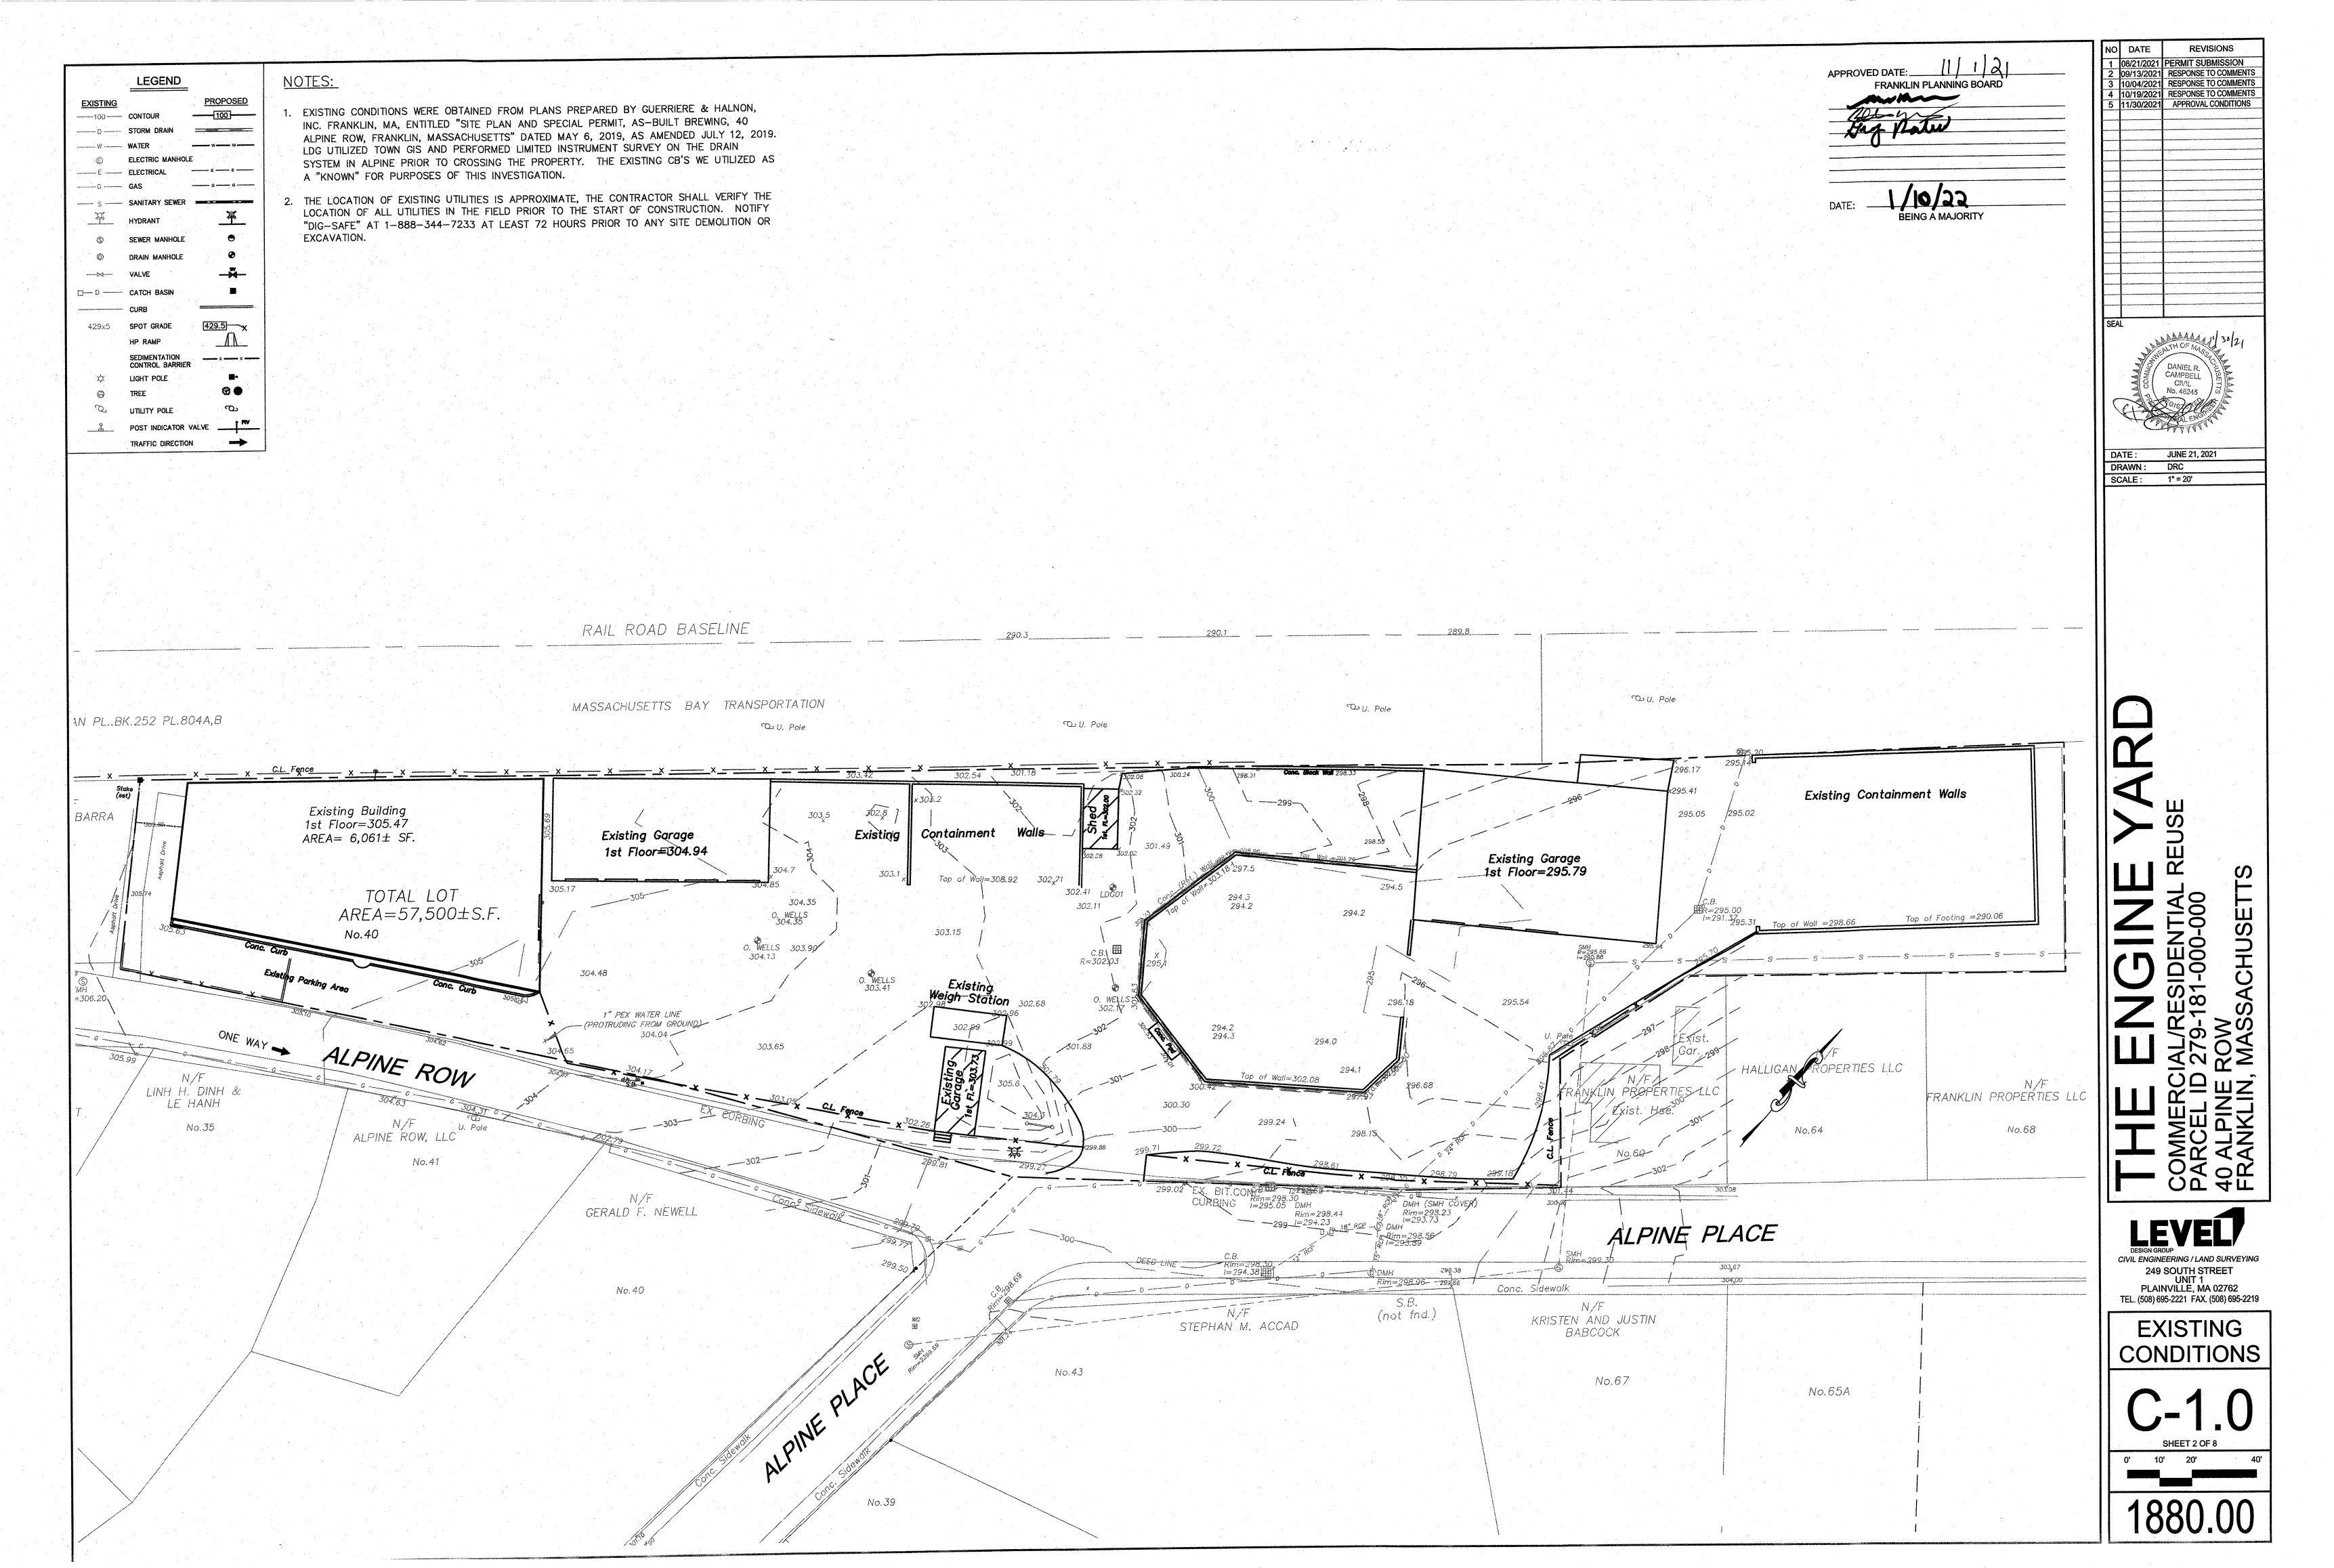

ſ		LEGEND		ZONING BY-LAW RE	QUIREME	ENTS	NOTES:
1				ZONING DISTRICT: DOWNT	OWN COMMI	ERCIAL	
ŀ	EXISTING	!	PROPOSED	USE: COMMERCIAL/OFFICE / M	IULTI-FAMILY	/ HOUSING	1. EXISTING CONDITIONS WERE OBTAINED FROM PLANS PREPARED BY GUERRIERE &
1	100	CONTOUR	100		REQUIRED	EXISTING/PROPOSED	HALNON, INC. FRANKLIN, MA, ENTITLED "SITE PLAN AND SPECIAL PERMIT, AS-BUILT
		STORM DRAIN ==		MIN. LOT AREA	5,000	57,500	BREWING, 40 ALPINE ROW, FRANKLIN, MASSACHUSETTS" DATED MAY 6, 2019, AS
		WATER -	w	MIN. LOT FRONTAGE	50'	332.88'	AMENDED JULY 12, 2019. LDG UTILIZED TOWN GIS AND PERFORMED LIMITED
	©	ELECTRIC MANHOLE		FRONT YARD SETBACK	5'*	19.0'/5.5'	INSTRUMENT SURVEY ON THE DRAIN SYSTEM IN ALPINE PRIOR TO CROSSING THE
ı		ELECTRICAL	- E E	SIDE YARD SETBACK	0'**	14.4'/34.9'	PROPERTY. THE EXISTING CB'S WE UTILIZED AS A "KNOWN" FOR PURPOSES OF
		GAS		REAR YARD SETBACK***	15'	1'/43.0'	THIS INVESTIGATION.
ı	S	SANITARY SEWER		BUILDING HEIGHT	40'	16' / 38'	
	**		ቾ	% OF LOT UPLAND COVERAGE	. :		2. THIS SITE IS NOT WITHIN THE WATER RESOURCE DISTRICT.
		HYDRANT	<u> </u>	STRUCTURES	80%	21.1%/31.8%	7 A DDE CONCEDITION MEETING WITH THE DRW IC DECINEED
ı	S	SEWER MANHOLE	•	STRUCTURES & PAVEMENT	90%	92.8%/78.5%	3. A PRE-CONSTRUCTION MEETING WITH THE DPW IS REQUIRED.
ı	0	DRAIN MANHOLE	•	PARKING REQUIREMENTS	REQUIRED	PROVIDED	4. ALL STRIPING AND SIGNAGE SHALL CONFORM TO THE MUTCD.
ı				USE: MULTI-FAMILY (28 UNITS)	42		T. ALE STAN ING AND GIGNAGE GIALE GOVERNMENTO THE MOTOR
ı	X	VALVE	-¾-	1.5 SPACES / UNIT	•		5. THE ARCHITECT OR THEIR ASSIGNS WILL PROVIDE PLANS AND CALCULATIONS FOR
1	D-0-	CATCH BASIN		USE: COMMERCIAL (6,061± S.F.)	12.12		THE PROPOSED FIRE PROTECTION.
ı		CURB ==		1 SPACE / 500 S.F.	12.12		
1	400. C	ODOT 00405	100 E1	USE: COMMERCIAL (1,500± S.F.)	3		
	429x5		429.5	1 SPACE / 500 S.F.	9		
		HP RAMP	_//\	REGULAR SPACES		65	
1		SEDIMENTATION CONTROL BARRIER	x x	HANDICAP SPACES	3	4	
	ά	LIGHT POLE	•	TOTAL SPACES	57	69	
1	•	TREE	8 ●	MINIMUM FIVE-FT SETBACK ON FIRST FLOOR/STRE	ET LEVEL: UPPER FL	OORS CAN	
1	0			 OVERHANG REQUIRED FIRST FLOOR SETBACK. INCREASE TO 20' WHEN ABUTTING A RESIDENTIAL 	DISTRICT.		
	O.	UTILITY POLE	ம	*** REAR LINE IS WAIVED IN ACCORDANCE WITH 185-2	95 DUE TO THE ADJAC	CENT RAILROAD.	
	<u></u>	POST INDICATOR VALVE	PIV				
		TRAFFIC DIRECTION	→			: 1	

FENCE AND GUARDRAIL NOTES:

1. GUARDRAIL SHALL BE INSTALLED AT ALL PARKING STALLS ADJACENT TO THE RAILROAD RIGHT-OF-WAY.

2. GUARDRAIL SHALL BE INSTALLED AT ALL PARKING STALLS ADJACENT TO THE RETAINING WALLS

3. FENCING SHALL BE INSTALLED FOR FALL PROTECTION ALONG ANY WALL IN EXCESS OF 30" IN HEIGHT. THE FENCE SHALL BE A MINIMUM OF 48" IN HEIGHT.

4. FENCING SHALL BE INSTALLED ALONG THE RAILROAD RIGHT-OF-WAY IN ALL LOCATIONS WHERE THERE WOULD OTHERWISE BE A GAP IN FENCE ALONG THE RIGHT-OF-WAY.

ED DATE: 11/1/21
FRANKLIN PLANNING BOARD

1/10/22 **BEING A MAJORITY**

2 09/13/2021 RESPONSE TO COMMENTS 10/04/2021 RESPONSE TO COMMENTS 4 10/19/2021 RESPONSE TO COMMENTS 5 11/30/2021 APPROVAL CONDITIONS DATE: JUNE 21, 2021 DRAWN: DRC SCALE: 1" = 20'

REVISIONS


1 06/21/2021 PERMIT SUBMISSION


NO DATE

RAIL ROAD BASELINE CONCRETE WALL, OR APPROVED EQUAL AS NEEDED TO MEET GRADES ALONG THE RAILROAD, TOP MOUNTED GUARDRAIL AND ADDED 4' HIGH CHAINLINK FENCE 6' HIGH CHAINLINK FENCE ALONG THE RAILROAD WHEN NOT ATOP— THE WALL (TYP) PROPOSED CONCRETE OR ARTICULATED BLOCK WALL, GRADES PER
PLAN. WALL IN EXCESS OF 4' IN HEIGHT WILL REQUIRE BUILDING DEPARTMENT REVIEW. MASSACHUSETTS BAY TRANSPORTATION WHEN OVER 30" IN HEIGHT (TYP) DUMPSTER PAD — AND ENCLOSURE RAIL ROAD PLAN PL. BK.252 PL.804A,B HDCP RAMP TRANSITION AT EDGE OF DRIVEWAY (TYP.) Existing Building 1st Floor=305.47 HDCP RAMP TRANSITION AT EDGE OF HECTOR IBARRA AREA = 6,061 ± SF. DRIVEWAY (TYP.) SIGN-"ONE WAY-DO NOT ENTER"(TYP.) GRASS PLAY SURFACE WINTER SNOW STORAGE CONVERTED COMMERCIAL USE .------ \Rightarrow LOADING AREA (TYP.) 3 TOTAL LOT AREA=57,500±S.F. HDCP RAMP TRANSITION AT EDGE OF DRIVEWAY (TYP.) ACCESSIBLE PATH CONCRETE WALL, OR APPROVED EQUAL AS NEEDED TO MEET GRADES AT ABUTTING PROPERTIES, TOP MOUNTED GUARDRAIL ADJACENT TO PARKING AREA AND ADDED 4'HIGH CHAINLINK FENCE WHEN OVER 30" IN HEIGHT (TYP) ALPINE ROW No.31 No.27 LINH H. DINH & FRANKLIN PROPERTIES LLC N/F LE HANH KR KRISHNA TRUST MURCUS AND JENNIFER COLLIGAN FRANKLIN PROPERTIES LLC HILLARY MURTY N/F ALPINE ROW, LLC No.35 No.68 No.72 HDCP RAMP TRANSITION AT EDGE OF DRIVEWAY (TYP.) No.41 No.23 N/F GERALD F. NEWELL ALPINE PLACE N/F STEPHAN M. ACCAD (not fnd.) KRISTEN AND JUSTIN BABCOCK No.67 No.65A No.64 No.35 No.31

CIVIL ENGINEERING / LAND SURVEYING 249 SOUTH STREET UNIT 1 PLAINVILLE, MA 02762 TEL. (508) 695-2221 FAX. (508) 695-2219

LAYOUT & **MATERIALS**

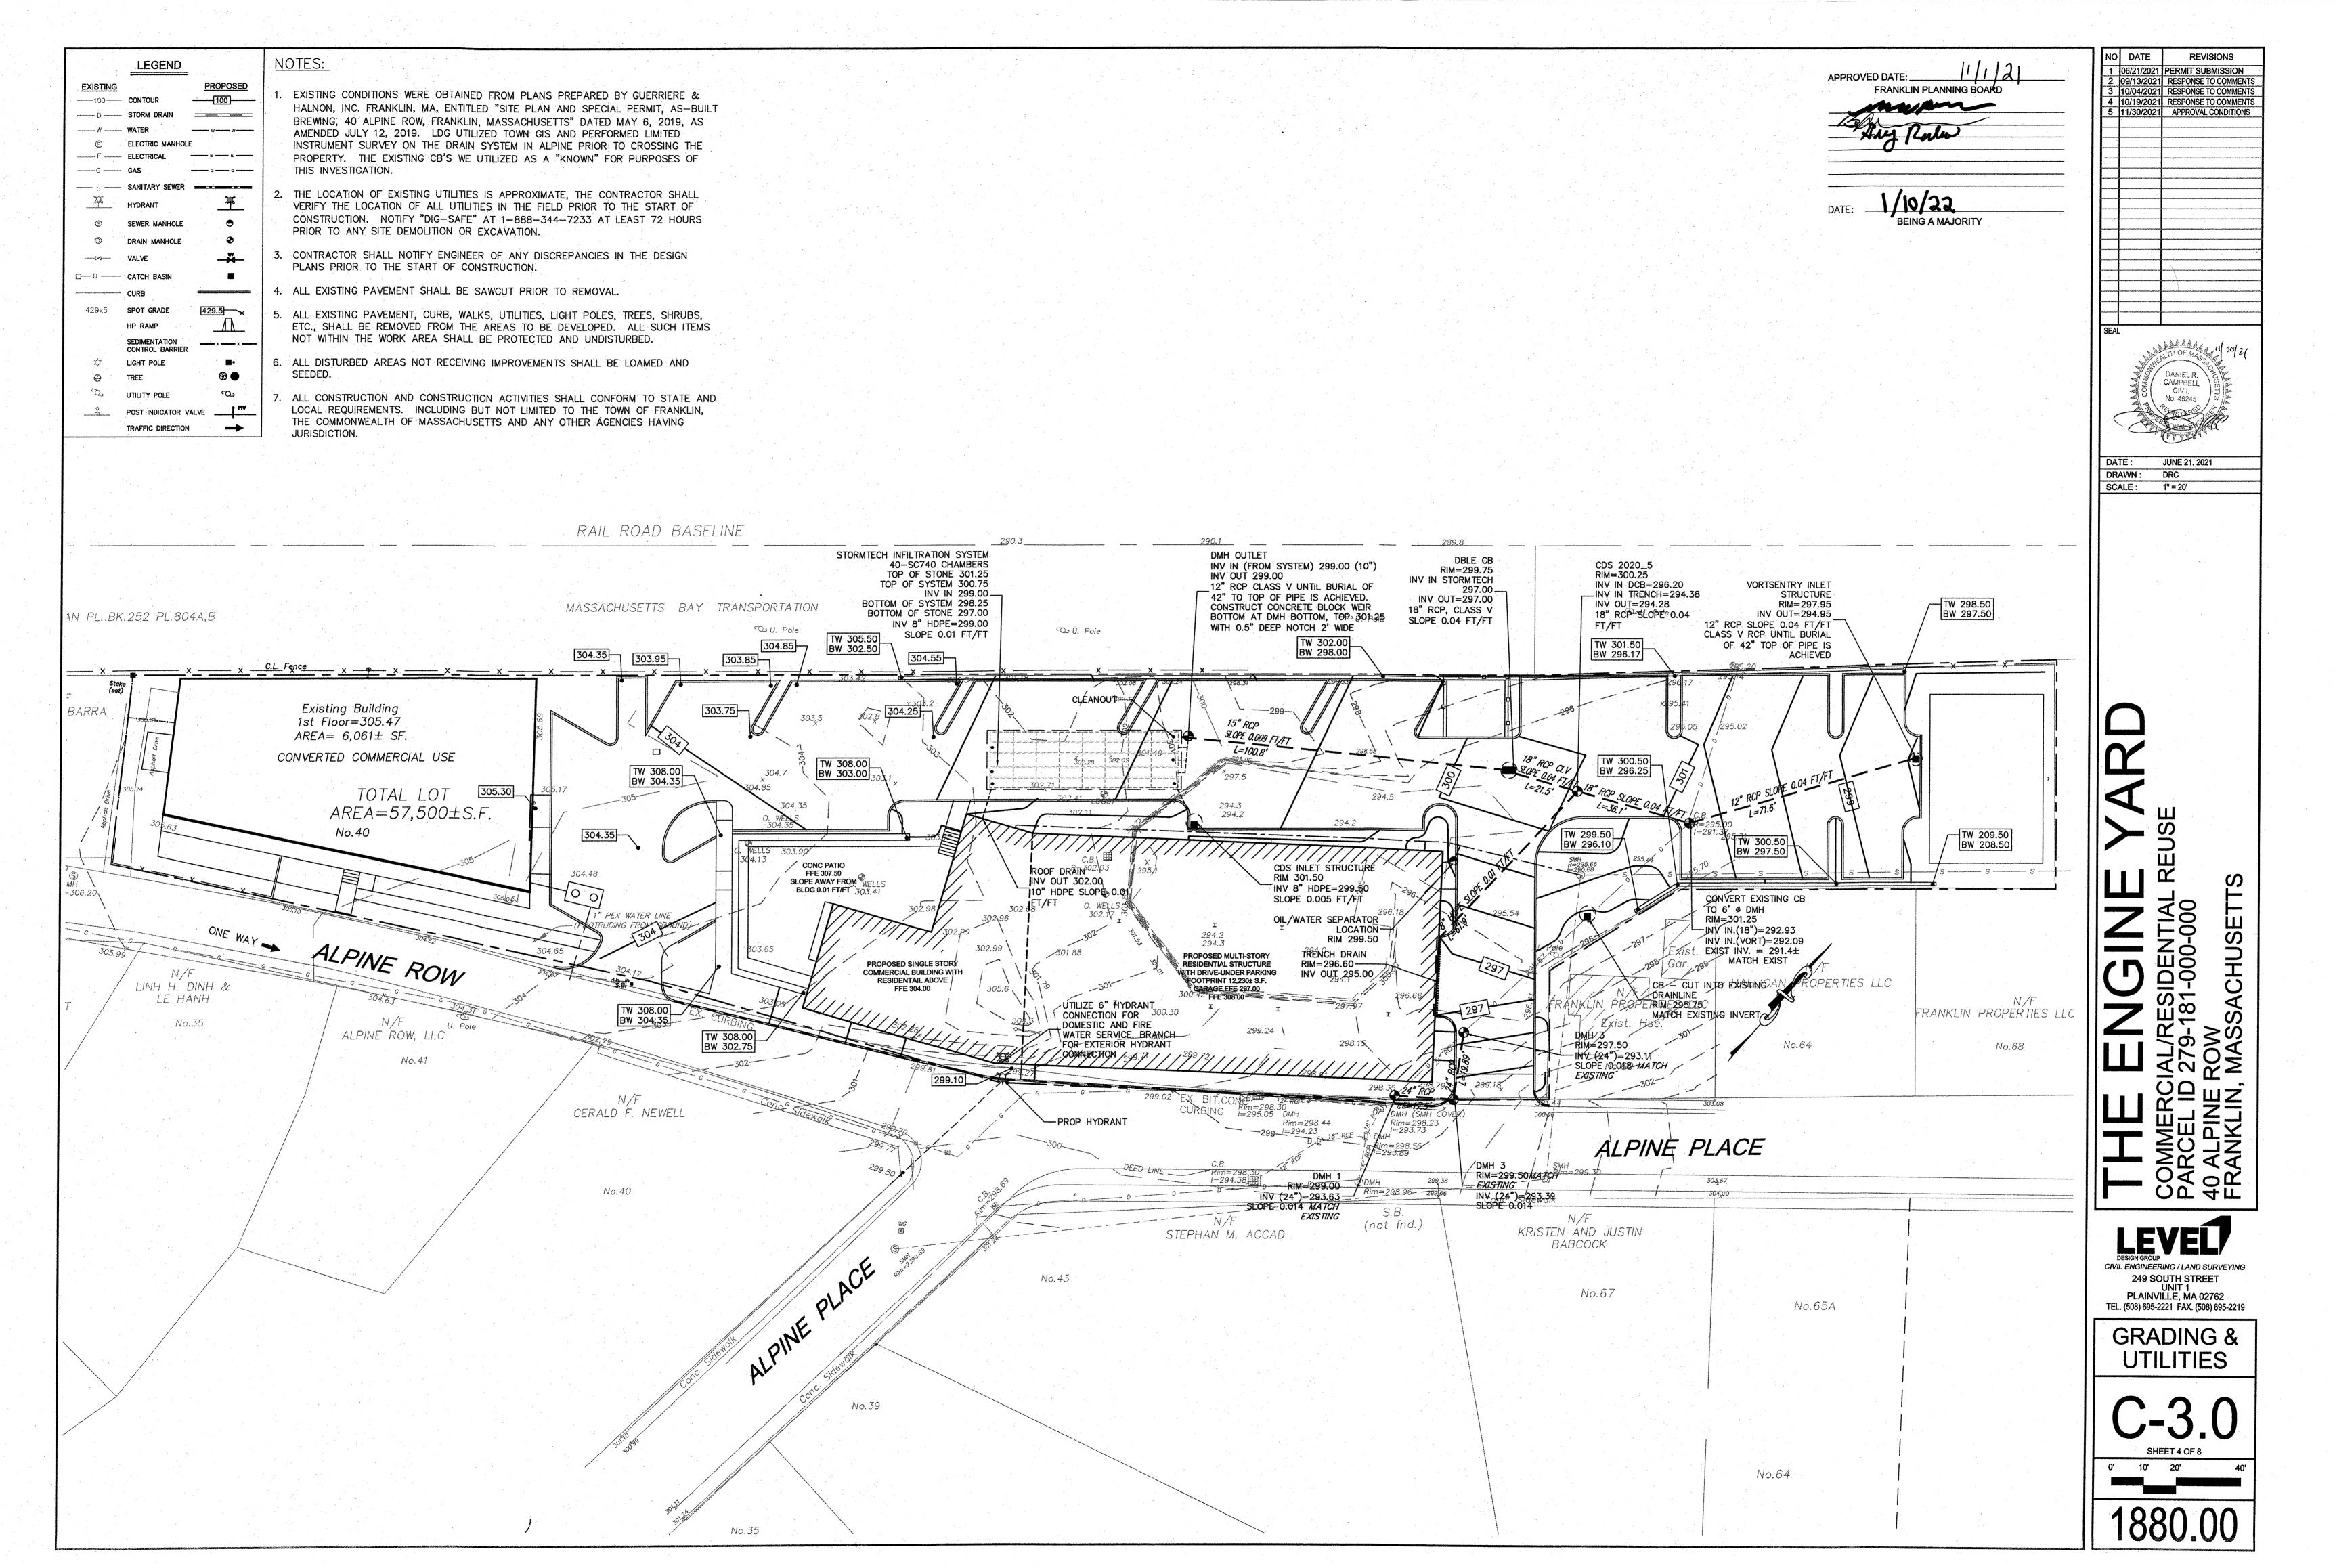

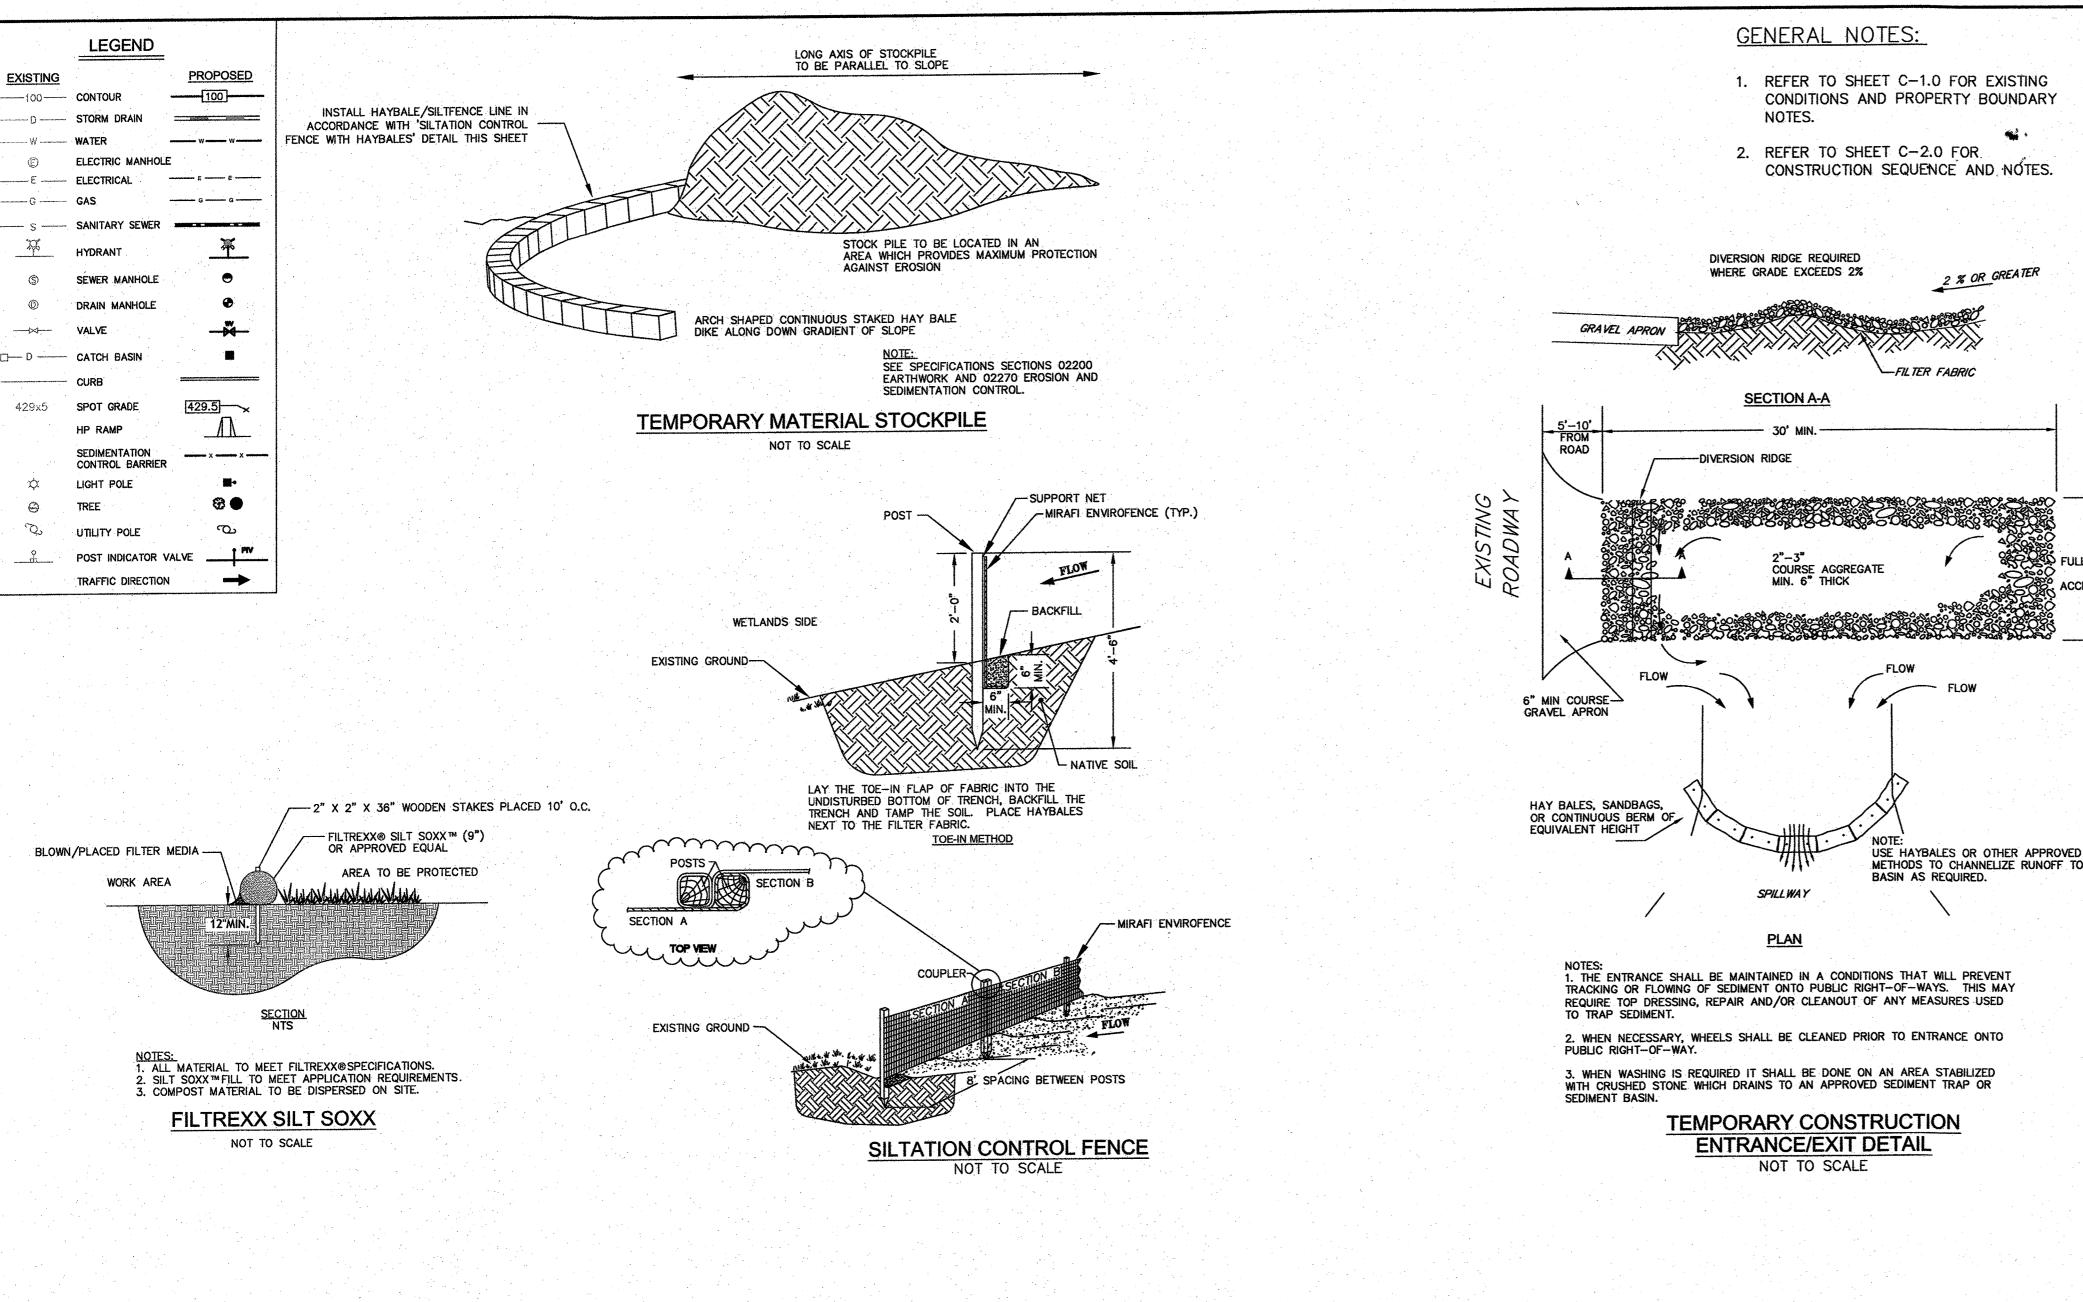

RAIL ROAD BASELINE


TW 298.50 BW 297.50 9" COMPOST SOCK Quil. Pole MASSACHUSETTS BAY TRANSPORTATION N PL.BK.252 PL.804A,B TW 301.50 BW 296.17 TW 302.00 BW 298.00 Existing Building 1st Floor=305.47 3ARRA AREA= 6,061± SF. CONVERTED COMMERCIAL USE BW 304.35 TOTAL LOT AREA=57,500±S.F. ONE WAY - ALPINE ROW ROPERTIES LLC LINH H. DINH & RANKLIN PROPERTIES LLC LE HANH No.68 ALPINE ROW, LLC GERALD F. NEWELL ALPINE PLACE KRISTEN AND JUSTIN STEPHAN M. ACCAD BABCOCK No.67 No.65A

GENERAL NOTES:

REFER TO SHEET C-1.0 FOR EXISTING CONDITIONS AND PROPERTY BOUNDARY

2. REFER TO SHEET C-2.0 FOR CONSTRUCTION SEQUENCE AND NOTES.

2 % OR GREATER

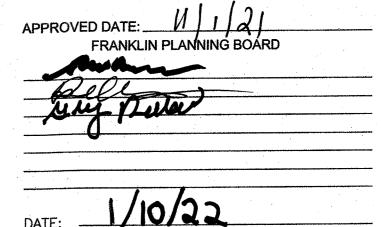

BEING A MAJORITY

EROSION CONTROL NOTES

SILTATION CONTROL USING EROSION CONTROL FENCE WITH STRAW WATTLE, OR APPROVED EQUAL EROSION CONTROL LINE IS TO BE VISUALLY INSPECTED AFTER EVERY RAIN FALL AND REPAIRS MADE AS REQUIRED TO THE SILTATION CONTROL FENCE AND STRAW WATTLE AFTER EACH RAIN FALL. CLEANOUT C ACCUMULATED SEDIMENT BEHIND THE WATTLE IS NECESSARY IF 1/2 OF THE ORIGINAL HEIGHT OF THE WATT APPEARS TO HAVE BEEN INUNDATED WITH SEDIMENT.

PRESERVE TOPSOIL

SITE OWNERS AND OPERATORS MUST PRESERVE EXISTING TOPSOIL ON THE CONSTRUCTION SITE TO THE MAXIMUM EXTENT FEASIBLE AND AS NECESSARY TO SUPPORT HEALTHY VEGETATION, PROMOTE SOIL STABILIZATION, AND INCREASE STORMWATER INFILTRATION RATES IN THE POST-CONSTRUCTION PHASE OF

UPON COMPLETION AND ACCEPTANCE OF SITE PREPARATION AND INITIAL INSTALLATION OF EROSION, RUNG AND SEDIMENT CONTROLS AND TEMPORARY POLLUTION PREVENTION MEASURES, THE OPERATOR SHALL INITIATE APPROPRIATE TEMPORARY OR PERMANENT STABILIZATION PRACTICES DURING ALL PHASES OF CONSTRUCTION ON ALL DISTURBED AREAS AS SOON AS POSSIBLE, BUT NOT MORE THAN FOURTEEN (14) DAYS AFTER THE CONSTRUCTION ACTIVITY IN THAT AREA HAS TEMPORARILY OR PERMANENTLY CEASED. SLOPES IN EXCESS OF 3:1 SHALL HAVE 22 MONTH EROSION CONTROL FABRIC INSTALLED OVER A SLOPE SEED MIX WITH TACKIFIER UNLESS OTHERWISE SPECIFIED.

ANY DISTURBED AREAS THAT WILL NOT HAVE ACTIVE CONSTRUCTION ACTIVITY OCCURRING WITHIN 14 DAYS MUST BE STABILIZED USING THE CONTROL MEASURES DEPICTED IN SITE PLANS, IN ACCORDANCE WITH THE STORMWATER POLLUTION PREVENTION PLAN, AND PER MANUFACTURER PRODUCT SPECIFICATIONS.

ONLY AREAS THAT CAN BE REASONABLY EXPECTED TO HAVE ACTIVE CONSTRUCTION WORK BEING PERFORMED WITHIN 14 DAYS OF DISTURBANCE WILL BE CLEARED/GRUBBED AT ANY ONE TIME. IT IS NOT ACCEPTABLE TO CLEAR AND GRUB THE ENTIRE CONSTRUCTION SITE IF PORTIONS WILL NOT BE ACTIVE WITHIN THE 14-DAY TIME FRAME. PROPER PHASING OF CLEARING AND GRUBBING ACTIVITIES SHALL INCLUDE TEMPORARY STABILIZATION TECHNIQUES FOR AREAS CLEARED AND GRUBBED THAT WILL NOT BE ACTIVE WITHIN THE 14-DAY TIME FRAME.

STORMWATER INLET PROTECTION

INLET PROTECTION - WILL BE UTILIZED TO PREVENT SOIL AND DEBRIS FROM ENTERING STORM DRAIN INLETS AND SHALL BE INSTALLED WITHIN BASINS DOWNSTREAM OF DISTURBANCE WITHIN 200' OF THE PROPOSED DISTURBANCE. THESE MEASURES ARE USUALLY TEMPORARY AND ARE IMPLEMENTED BEFORE A SITE IS

MAINTENANCE - THE OPERATOR MUST CLEAN, OR REMOVE AND REPLACE THE INLET PROTECTION MEASURES AS SEDIMENT ACCUMULATES, THE FILTER BECOMES CLOGGED, AND/OR AS PERFORMANCE IS COMPROMISED. ACCUMULATED SEDIMENT ADJACENT TO THE INLET PROTECTION MEASURES SHOULD BE REMOVED BY THE END OF THE SAME WORK DAY IN WHICH IT IS FOUND OR BY THE END OF THE FOLLOWING WORK DAY IF REMOVAL BY THE SAME WORK DAY IS NOT FEASIBLE.

STORMWATER BASINS - ALL AREAS CONTAINING STORMWATER BASINS (ABOVE OR BELOW GROUND) SHALL PROTECTED THROUGHOUT CONSTRUCTION. THESE ARES ARE NOT BE USED FOR MATERIAL STOCKPILES OR FOR PARKING EQUIPMENT. SURFACE BASINS ARE TO BE ROUGH GRADED AND PROTECTED UNTIL STABILIZED AND BROUGHT ON-LINE FOR STORMWATER MANAGEMENT OF THE STABILIZED SITE.

CONSTRUCTION ENTRANCES

CONSTRUCTION ENTRANCES SHALL BE USED IN CONJUNCTION WITH THE STABILIZATION OF CONSTRUCTION ROADS TO REDUCE THE AMOUNT OF SEDIMENT TRACKING OFF THE PROJECT. ANY CONSTRUCTION SITE ACCESS POINT MUST EMPLOY THE CONTROL MEASURES ON THE APPROVED SITE PLANS AND IN ACCORDANCE WITH THE STORMWATER POLLUTION PREVENTION PLAN. CONSTRUCTION ENTRANCES SHALL BE USED IN CONJUNCTION WITH THE STABILIZATION OF CONSTRUCTION ROADS TO REDUCE THE AMOUNT OF MUD PICKED UP BY CONSTRUCTION VEHICLES. ALL CONSTRUCTION ACCESS ROADS SHALL BE CONSTRUCTED PRIOR TO ANY ROADWAY ACCEPTING CONSTRUCTION TRAFFIC.

THE SITE OWNER AND OPERATOR MUST WILL RESTRICT VEHICLE USE TO PROPERLY DESIGNATED EXIT POINTS, USE PROPERLY DESIGNED AND CONSTRUCTED CONSTRUCTION ENTRANCES AT ALL POINTS THAT EXIT ONTO PAVED ROADS SO THAT SEDIMENT REMOVAL OCCURS PRIOR TO VEHICLE EXIT. WHEN AND WHERE NECESSARY USE ADDITIONAL CONTROLS TO REMOVE SEDIMENT FROM VEHICLE TIRES PRIOR TO EXIT (I.E. WHEEL WASHING RACKS, RUMBLE STRIPS, AND RATTLE PLATES). WHERE SEDIMENT HAS BEEN TRACKED OUT FROM THE CONSTRUCTION SITE ONTO THE SURFACE OF OFF-SITE STREETS, OTHER PAVED AREAS, AND SIDEWALKS, THE DEPOSITED SEDIMENT MUST BE REMOVED BY THE END OF THE SAME WORK DAY IN WHICH THE TRACK OUT OCCURS. TRACK-OUT MUST BE REMOVED BY SWEEPING, SHOVELING, OR VACUUMING THESE SURFACES, OR BY USING OTHER SIMILARLY EFFECTIVE MEANS OF SEDIMENT REMOVAL.

STOCKPILE CONTAINMENT

SHALL BE USED ONSITE TO MINIMIZE OR ELIMINATE THE DISCHARGE OF SOIL, TOPSOIL, BASE MATERIAL OR RUBBLE, FROM ENTERING DRAINAGE SYSTEMS OR SURFACE WATERS. ALL STOCKPILES MUST BE LOCATED WITHIN THE LIMIT OF DISTURBANCE, PROTECTED FROM RUN-ON WITH THE USE OF TEMPORARY SEDIMENT BARRIERS AND PROVIDED WITH COVER OR STABILIZATION TO AVOID CONTACT WITH PRECIPITATION AND WIND WHERE AND WHEN PRACTICAL. STOCK PILE MANAGEMENT CONSISTS OF PROCEDURES AND PRACTICES DESIGNED TO MINIMIZE OR ELIMINATE THE DISCHARGE OF STOCKPILED MATERIAL (SOIL, TOPSOIL, BASE MATERIAL, RUBBLE) FROM ENTERING DRAINAGE SYSTEMS OR SURFACE WATERS.

FOR ANY STOCKPILES OR LAND CLEARING DEBRIS COMPOSED, IN WHOLE OR IN PART, OF SEDIMENT OR SOIL YOU MUST COMPLY WITH THE FOLLOWING REQUIREMENTS - LOCATE PILES WITHIN THE DESIGNATED LIMITS OF DISTURBANCE OUTSIDE OF THE 100-FOOT BUFFER ZONE, PROTECT FROM CONTACT WITH STORMWATER (INCLUDING RUN-ON) USING A TEMPORARY PERIMETER SEDIMENT BARRIER; WHERE PRACTICABLE, PROVIDE COVER OR APPROPRIATE TEMPORARY VEGETATIVE OR STRUCTURAL STABILIZATION TO AVOID DIRECT CONTAC WITH PRECIPITATION OR TO MINIMIZE SEDIMENT DISCHARGE; NEVER HOSE DOWN OR SWEEP SOIL OR SEDIMEN ACCUMULATED ON PAVEMENT OR OTHER IMPERVIOUS SURFACES INTO ANY STORMWATER CONVEYANCE, STORM DRAIN INLET, OR SURFACE WATER; TO THE MAXIMUM EXTENT PRACTICABLE, CONTAIN AND SECURELY PROTECT FROM WIND.

TEMPORARY SEDIMENT BASINS

IF REQUIRED, ADDITIONAL TEMPORARY SEDIMENT BASINS SHALL BE CONSTRUCTED TO MITIGATE THE POTENTIAL SEDIMENT LOADING TO THE ADJACENT RESOURCE AREAS. TEMPORARY SEDIMENT BASINS ARE TO BE LOCATED OUTSIDE OF THE 50-FOOT BUFFER ZONE TO THE BORDERING VEGETATED WETLANDS AND SHALL NOT BE LOCATED IN AN AREA WHERE AN INFILTRATION BASIN IS PROPOSED. TEMPORARY SEDIMENT BASIN GRADING LOCATION SHALL BE DICTATED BY THE DESIGN ENGINEER. AT A MINIMUM THE THE VOLUME OF THE TEMPORARY SEDIMENT BASIN, AS MEASURED FROM THE BOTTOM OF THE BASE TO THE ELEVATION OF THE CREST OF THE PRINCIPAL SPILLWAY SHALL BE AT LEAST 3,600 CUBIC FEET PER ACRE OF DRAINAGE AREA. THIS 3,600 CUBIC FEET IS EQUIVALENT TO 1.0 INCH OF SEDIMENT PER ACRE OF DRAINAGE AREA. ADDITIONA STORAGE IN THE FORM OF A PERMANENT WET POOL SHALL BE PROVIDED WHENEVER PRACTICABLE, BUT MAY NOT BE USED TO FULFILL THE TEMPORARY STORAGE VOLUME REQUIREMENT.

SEDIMENT BASINS SHALL BE CLEANED OUT WHEN THE VOLUME REMAINING AS DESCRIBED ABOVE IS REDUCED BY SEDIMENTATION TO 1,800 CUBIC FEET PER ACRE OF DRAINAGE AREA (50 PERCENT FULL). IN NO CASE SHALL THE SEDIMENT LEVEL BE PERMITTED TO BUILD UP HIGHER THAN ONE FOOT BELOW THE PRINCIPAL SPILLWAY CREST. AT THIS ELEVATION, CLEANOUT SHALL BE PERFORMED TO RESTORE THE ORIGINAL DESIGN VOLUME TO THE SEDIMENT BASIN. THE ELEVATION OF THE MAXIMUM ALLOWABLE SEDIMENT LEVEL SHALL BE DETERMINED AND SHALL BE STATED IN THE DESIGN DATA AS A DISTANCE BELOW THE TOP OF THE RISER AND BE CLEARLY MARKED ON THE RISER. NO AREA OF DETENTION SHALL BE UTILIZED FOR TEMPORARY EROSION CONTROL OR DEWATERING ACTIVITIES.

	1	06/21/2021	PERMIT SUBMISSION
	2	09/13/2021	RESPONSE TO COMMENTS
Г	3	10/04/2021	RESPONSE TO COMMENTS
2000	4	10/19/2021	RESPONSE TO COMMENTS
	5		APPROVAL CONDITIONS
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		2 3 4 5 5 SEAN DA	2 09/13/2021 3 10/04/2021 4 10/19/2021 5 11/30/2021 SEAL

NO DATE

REVISIONS

AAS MAS O D

O L CIVIL ENGINEERING / LAND SURVEYING 249 SOUTH STREET


<u>~</u>

EROSION CONTROL

PLAINVILLE, MA 02762 TEL. (508) 695-2221 FAX. (508) 695-2219

SHEET 5 OF 8

15' 30'

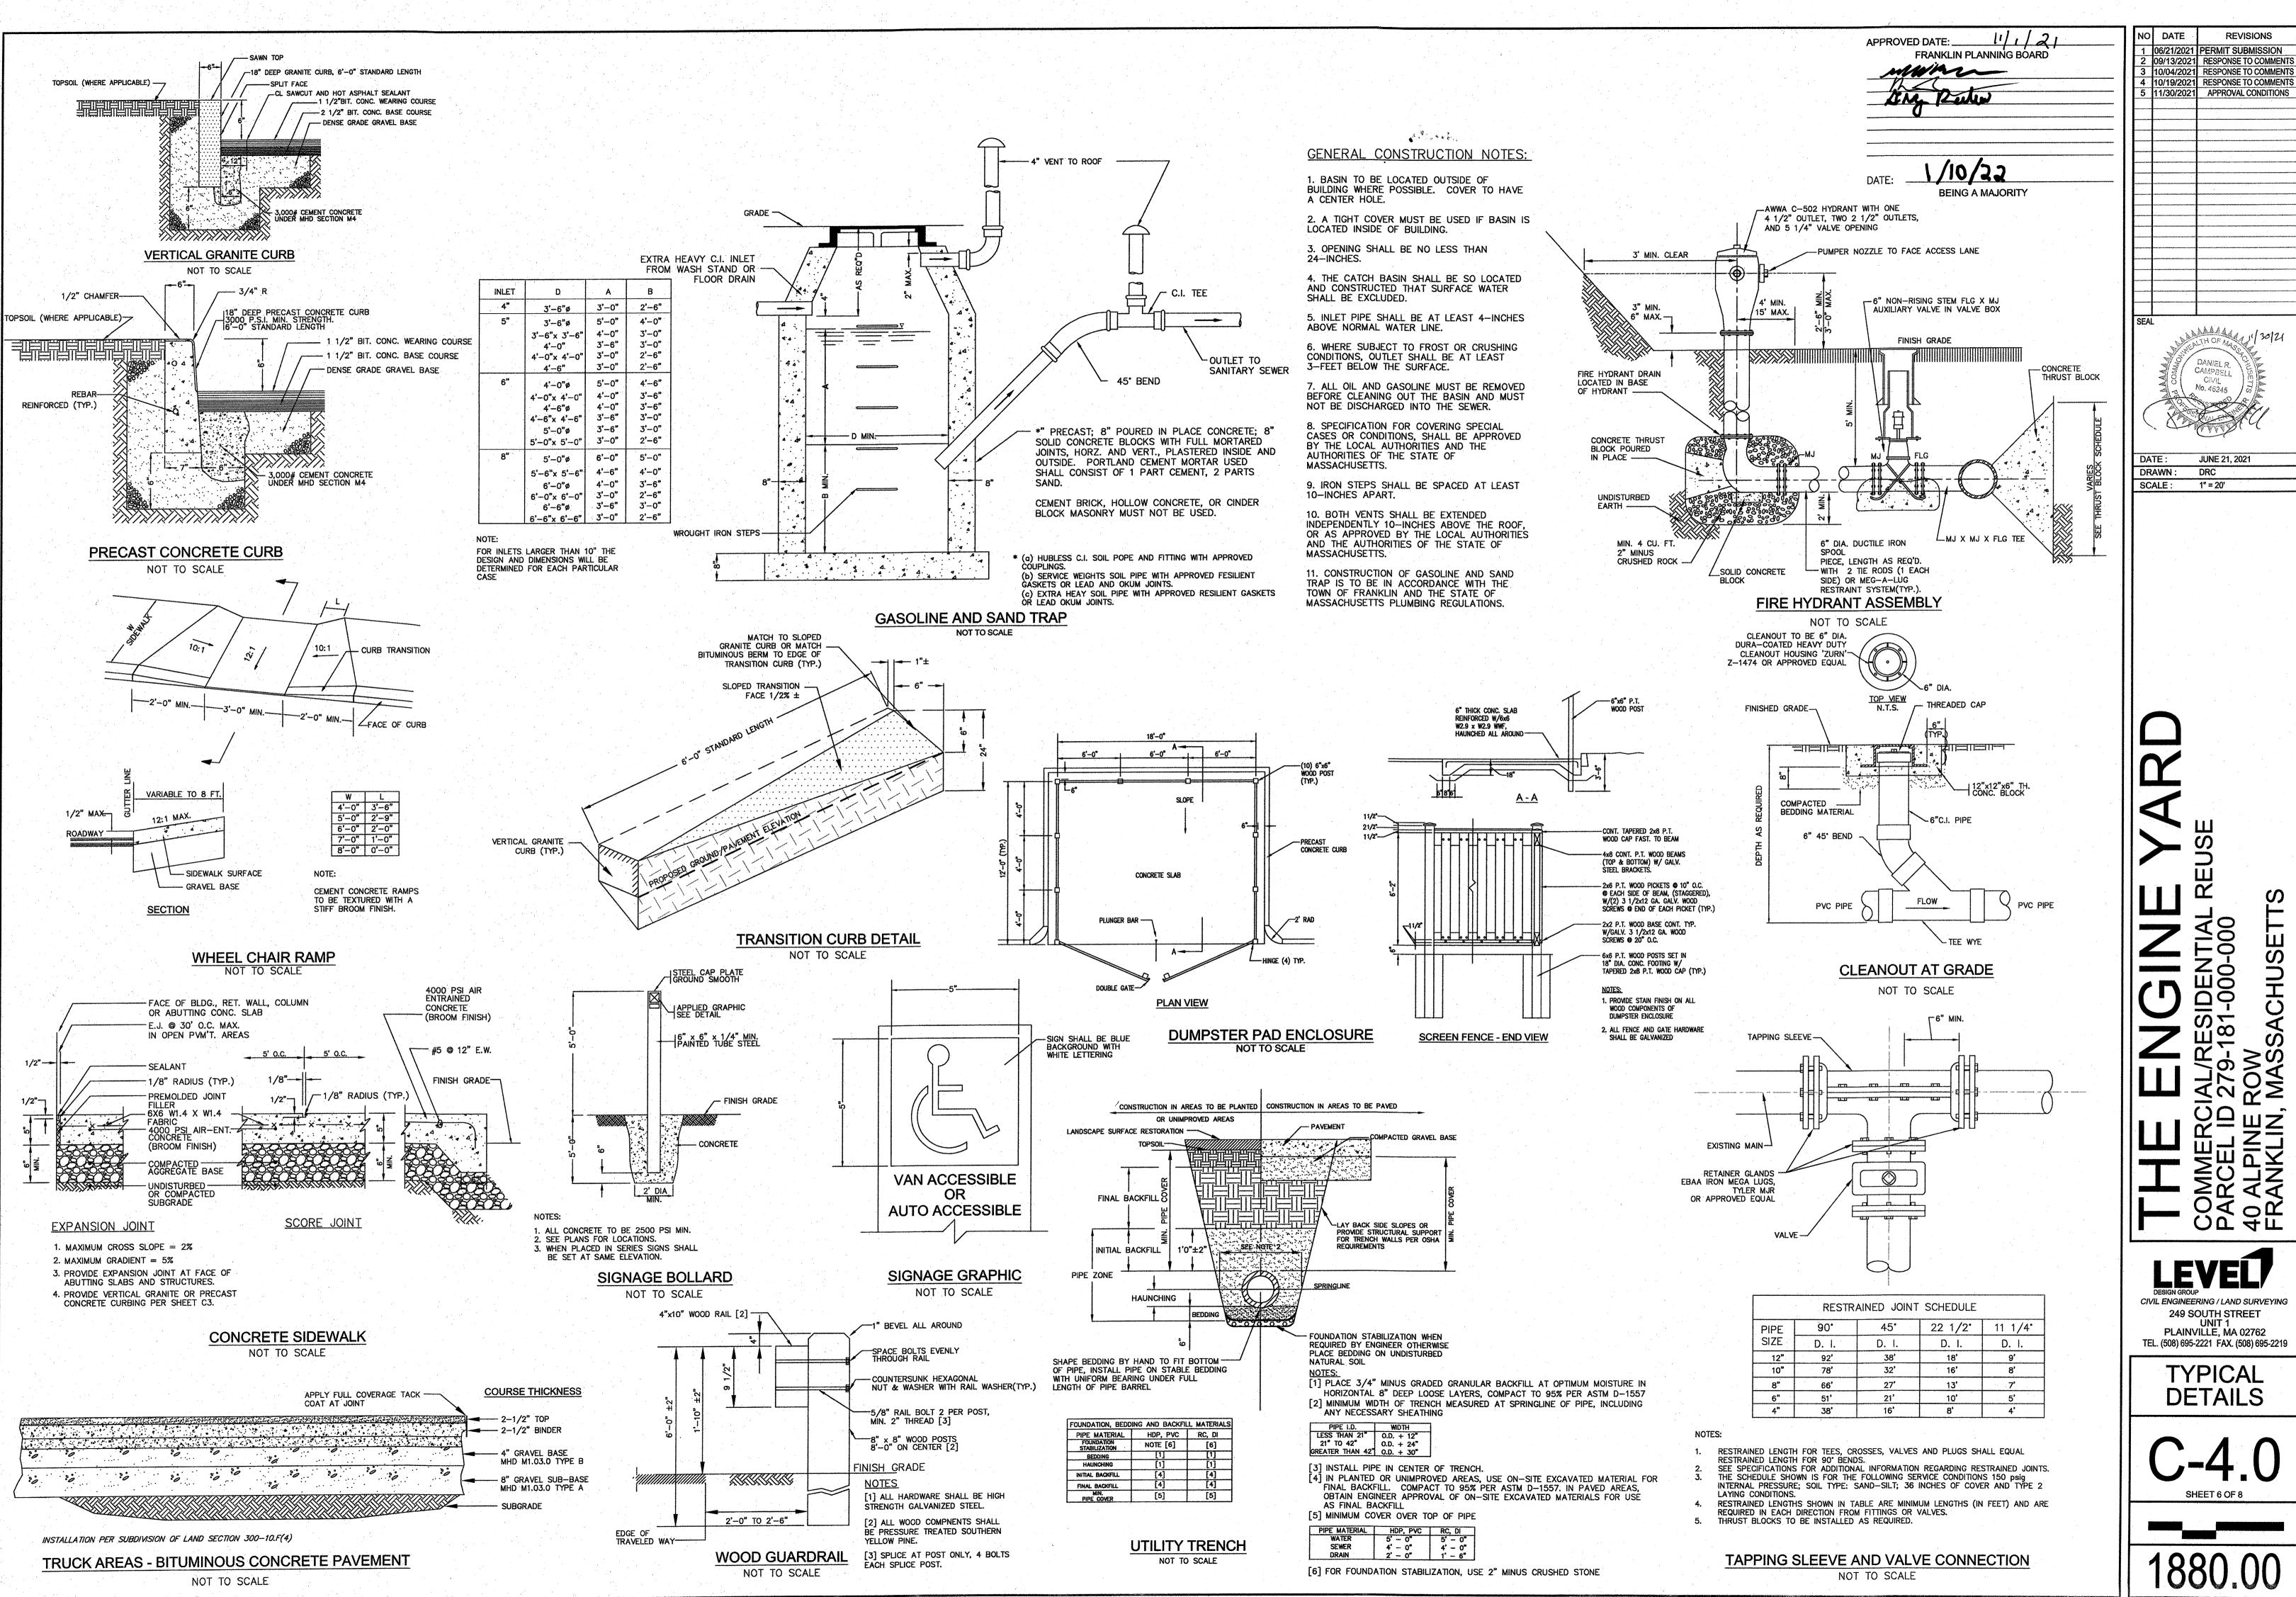

JUNE 21, 2021 DRAWN: SCALE: 1" = 20'

REVISIONS


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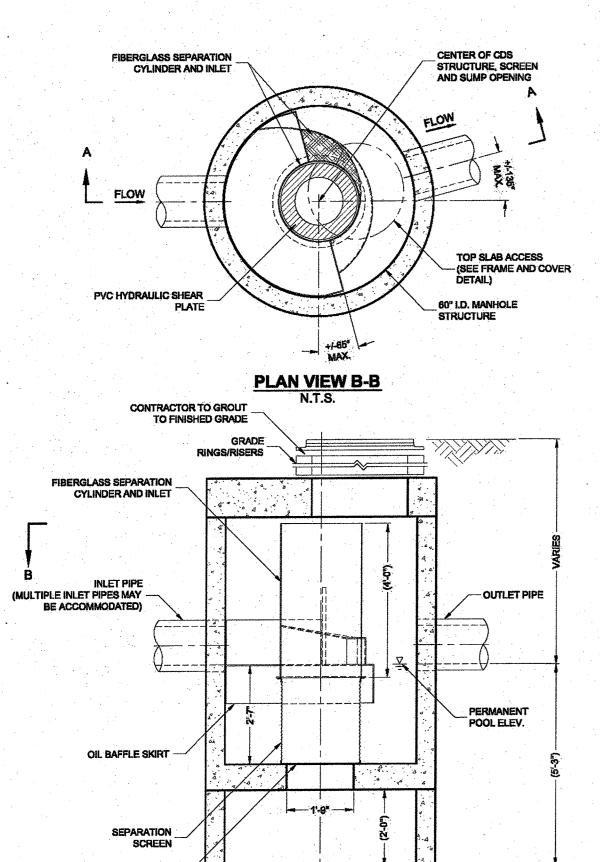
CIVIL ENGINEERING / LAND SURVEYING 249 SOUTH STREET

TEL. (508) 695-2221 FAX. (508) 695-2219 TYPICAL

DETAILS

SHEET 6 OF 8



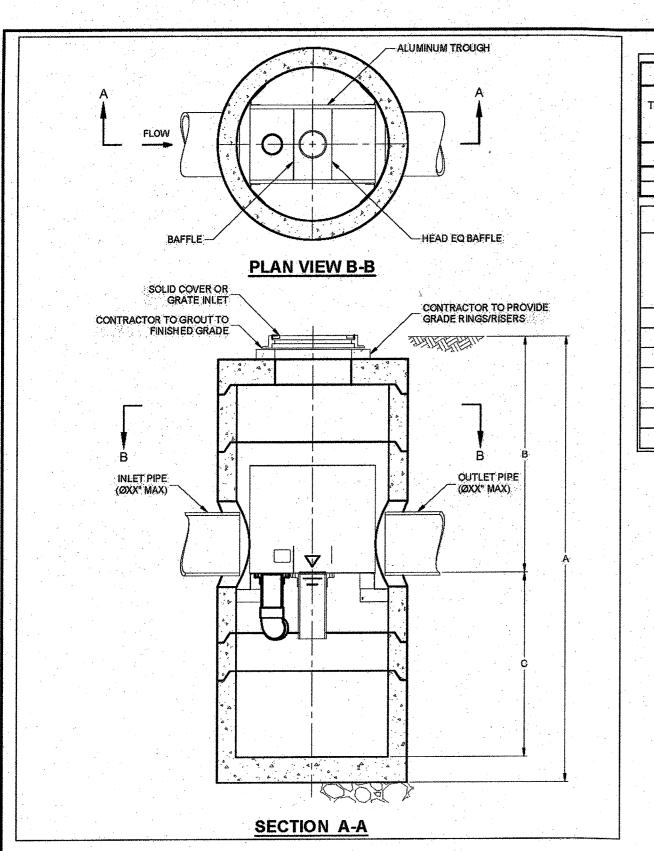

VORTSENTRY HS DESIGN NOTES THE STANDARD SOLID COVER CONFIGURATION IS SHOWN. ALTERNATE CONFIGURATIONS ARE AVAILABLE AND ARE LISTED BELOW. **CONFIGURATION OPTION DESCRIPTION** GRATE INLET (NO INLET PIPE GRATE INLET WITH INLET PIPE

VORTSENTRY HS GENERAL INFORMATION												
Model	1	nhole iter (ID)	Distan to Or Bot	al Total ce Rim utside tom	Distan	oical ce Rim overt B	Below (ins	Depth Invertide)	Mini Distan	ximate mum ce Rim overt	f	um Pipe eter (ID)
	FT	mm	FT	m	FT	m	FT	mm	FT	m	IN	mm
HS36	3	900	10.16	3.10	4.08	1.24	5.58	1702	3.00	0.91	18	450
HS48	4	1200	13.25	4.04	6.00	1.83	6.75	2057	4.00	1.22	24	600
HS60	5	1500	15.13	4.61	6.50	1.98	7.96	2426	4.82	1.47	30	750
HS72	6	1800	16.56	5.05	6.75	2.06	9.15	2788	5.59	1.70	36	900
HS84	7	2100	18.85	5.75	7.75	2.36	10.35	3156	5.00	1.52	42	1050
HS96	8	2400	20.87	6.36	8.50	2.59	11.54	3518	6.91	2.11	48	1200

GENERAL NOTES L


1. CONTECH TO PROVIDE ALL MATERIALS UNLESS NOTED OTHERWISI


ACTION OF THE PROVIDE ACTION OF T DIMENSIONS MARKED WITH () ARE REFERENCE DIMENSIONS. ACTUAL DIMENSIONS MAY VARY. FOR FABRICATION DRAWINGS WITH DETAILED STRUCTURE DIMENSIONS AND WEIGHT, PLEASE CONTACT YOUR CONTECH ENGINEERED SOLUTIONS LLC REPRESENTATIVE. www.ContechES.com . VORTSENTRY HS WATER QUALITY STRUCTURE SHALL BE IN ACCORDANCE WITH ALL DESIGN DATA AND INFORMATION

5. STRUCTURE SHALL MEET AASHTO HS20 AND CASTINGS SHALL MEET AASHTO M306 LOAD RATING, ASSUMING GROUNDWATER ELEVATION AT, OR BELOW, THE OUTLET PIPE INVERT ELEVATION. ENGINEER OF RECORD TO CONFIRM ACTUAL GROUNDWATER ELEVATION. INSTALLATION NOTES
1. ANY SUB-BASE, BACKFILL DEPTH, AND/OR ANTI-FLOTATION PROVISIONS ARE SITE-SPECIFIC DESIGN CONSIDERATIONS AND SHALL BE SPECIFIED BY ENGINEER OF RECORD.

CONTRACTOR TO PROVIDE EQUIPMENT WITH SUFFICIENT LIFTING AND REACH CAPACITY TO LIFT AND SET THE VORTSENTRY HS MANHOLE STRUCTURE (LIFTING CLUTCHES PROVIDED). CONTRACTOR TO INSTALL JOINT SEALANT BETWEEN ALL STRUCTURE SECTIONS AND ASSEMBLE STRUCTURE. 4. CONTRACTOR TO PROVIDE, INSTALL, AND GROUT PIPES. MATCH PIPE INVERTS WITH ELEVATIONS SHOWN. 5. CONTRACTOR TO TAKE APPROPRIATE MEASURES TO ASSURE UNIT IS WATER TIGHT, HOLDING WATER TO FLOWLINE INVERT MINIMUM. IT IS SUGGESTED THAT ALL JOINTS BELOW PIPE INVERTS ARE GROUTED.

VORTSENTRY DETAILS AND SPECIFICATIONS

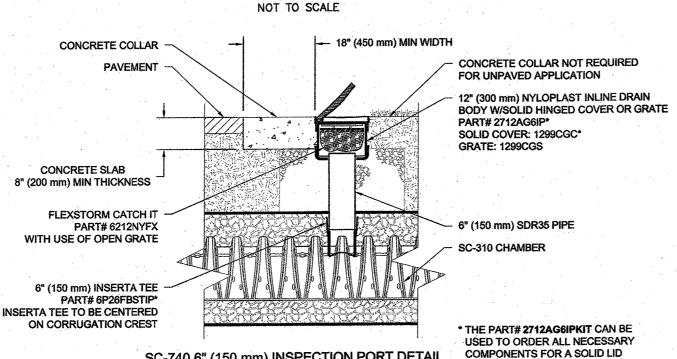

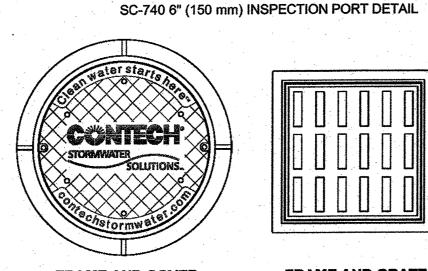

<u>ENERAL NOTES</u> CONTECH TO PROVIDE ALL MATERIALS UNLESS NOTED OTHERWIS

FRAME AND GRATE (24" SQUARE) FRAME AND COVER N.T.S.

DIMENSIONS MARKED WITH () ARE REFERENCE DIMENSIONS. ACTUAL DIMENSIONS MAY VARY.
FOR FABRICATION DRAWINGS WITH DETAILED STRUCTURE DIMENSIONS AND WEIGHTS, PLEASE CONTACT YOUR CONTECH CONSTRUCTIO I. CDS WATER QUALITY STRUCTURE SHALL BE IN ACCORDANCE WITH ALL DESIGN DATA AND INFORMATION CONTAINED IN THIS DRAWING 5. STRUCTURE SHALL MEET AASHTO HS20 AND CASTINGS SHALL MEET AASHTO M308 LOAD RATING, ASSUMING GROUNDWATER ELEVATION AT, OR BELOW, THE OUTLET PIPE INVERT ELEVATION. ENGINEER OF RECORD TO CONFIRM ACTUAL GROUNDWATER ELEVATION. 8. PVC HYDRAULIC SHEAR PLATE IS PLACED ON SHELF AT BOTTOM OF SCREEN CYLINDER. REMOVE AND REPLACE AS NECESSARY DURING


INSTALLATION NOTES


1. ANY SUB-BASE, BACKFILL DEPTH, AND/OR ANTI-FLOTATION PROVISIONS ARE SITE-SPECIFIC DESIGN CONSIDERATIONS AND SHALL BE SPECIFIED CONTRACTOR TO PROVIDE EQUIPMENT WITH SUFFICIENT LIFTING AND REACH CAPACITY TO LIFT AND SET THE CDS MANHOLE STRUCTURE

CONTRACTOR TO ADD JOINT SEALANT BETWEEN ALL STRUCTURE SECTIONS, AND ASSEMBLE STRUCTUR CONTRACTOR TO PROVIDE, INSTALL, AND GROUT PIPES. MATCH PIPE INVERTS WITH ELEVATIONS SHOWN 5. CONTRACTOR TO TAKE APPROPRIATE MEASURES TO ASSURE UNIT IS WATER TIGHT, HOLDING WATER TO FLOWLINE INVERT MINIMUM. IT IS SUGGESTED THAT ALL JOINTS BELOW PIPE INVERTS ARE GROUTED.

CDS 2020-5-G UNIT (STANDARD)

STORAGE SUMP

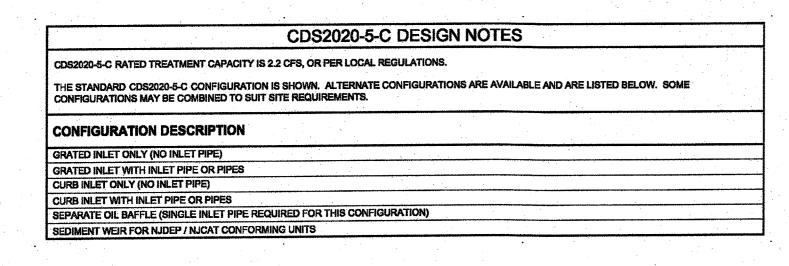

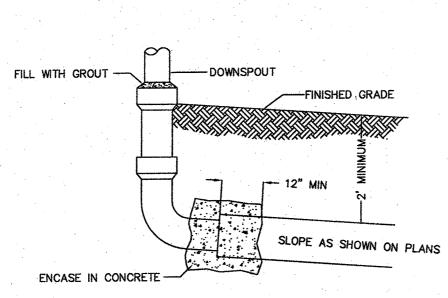

DOWNSPOUT CONNECTION TO DRAINAGE OUTLET NOT TO SCALE

STORMTECH CHAMBER SPECIFICATIONS

CHAMBERS SHALL BE STORMTECH SC-740 OR SC-310. CHAMBERS SHALL BE MANUFACTURED FROM VIRGIN POLYPROPYLENE OR

POLYETHYLENE RESINS.

- CHAMBER ROWS SHALL PROVIDE CONTINUOUS, UNOBSTRUCTED INTERNAL SPACE WITH NO INTERNAL SUPPORT PANELS THAT WOULD IMPEDE FLOW OR LIMIT ACCESS FOR
- THE STRUCTURAL DESIGN OF THE CHAMBERS, THE STRUCTURAL BACKFILL, AND THE INSTALLATION REQUIREMENTS SHALL ENSURE THAT THE LOAD FACTORS SPECIFIED IN THE AASHTO LIRED BRIDGE DESIGN SPECIFICATIONS, SECTION 12.12, ARE MET FOR: 1) LONG-DURATION DEAD LOADS AND 2) SHORT-DURATION LIVE LOADS, BASED ON THE AASHTO DESIGN TRUCK WITH CONSIDERATION FOR IMPACT AND MULTIPLE VEHICLE PRESENCES.
- CHAMBERS SHALL MEET ASTM F2922 (POLYETHYLENE) OR ASTM F2418-16 (POLYPROPYLENE), "STANDARD SPECIFICATION FOR THERMOPLASTIC CORRUGATED WALL STORMWATER COLLECTION CHAMBERS".
- CHAMBERS SHALL BE DESIGNED AND ALLOWABLE LOADS DETERMINED IN ACCORDANCE WITH ASTM F2787, "STANDARD PRACTICE FOR STRUCTURAL DESIGN OF THERMOPLASTIC

CORRUGATED WALL STORMWATER COLLECTION CHAMBERS".

- ONLY CHAMBERS THAT ARE APPROVED BY THE SITE DESIGN ENGINEER WILL BE ALLOWED. THE CHAMBER MANUFACTURER SHALL SUBMIT THE FOLLOWING UPON REQUEST TO THE SITE DESIGN ENGINEER FOR APPROVAL BEFORE DELIVERING CHAMBERS TO THE PROJECT SITE:
- A STRUCTURAL EVALUATION SEALED BY A REGISTERED PROFESSIONAL ENGINEER THAT DEMONSTRATES THAT THE SAFETY FACTORS ARE GREATER THAN OR EQUAL 2 TO 1.95 FOR DEAD LOAD AND 1.75 FOR LIVE LOAD, THE MINIMUM REQUIRED BY ASTM F2787 AND BY AASHTO FOR THERMOPLASTIC PIPE.
- A STRUCTURAL EVALUATION SEALED BY A REGISTERED PROFESSIONAL ENGINEER THAT DEMONSTRATES THAT THE LOAD FACTORS SPECIFIED IN THE AASHTO LRFD BRIDGE DESIGN SPECIFICATIONS, SECTION 12.12, ARE MET. THE 50 YEAR CREEP MODULUS DATA SPECIFIED IN ASTM F2418 OR ASTM F2922 MUST BE USED AS PART OF THE AASHTO STRUCTURAL EVALUATION TO VERIFY LONG-TERM PERFORMANCE
- c. STRUCTURAL CROSS SECTION DETAIL ON WHICH THE STRUCTURAL EVALUATION IS

CHAMBERS AND END CAPS SHALL BE PRODUCED AT AN ISO 9001 CERTIFIED MANUFACTURING FACILITY. IMPORTANT - NOTES FOR THE BIDDING AND INSTALLATION OF

THE SC-310/SC-740 SYSTEM

OVER THE CHAMBERS.

- STORMTECH SC-310 & SC-740 CHAMBERS SHALL NOT BE INSTALLED UNTIL THE MANUFACTURER'S REPRÈSENTATIVE HAS COMPLETED A PRE-CONSTRUCTION MEETING WITH THE INSTALLERS.
- STORMTECH SC-310 & SC-740 CHAMBERS SHALL BE INSTALLED IN ACCORDANCE WITH
- THE "STORMTECH SC-310/SC-740/DC-780 CONSTRUCTION GUIDE". CHAMBERS ARE NOT TO BE BACKFILLED WITH A DOZER OR AN EXCAVATOR SITUATED
- STORMTECH RECOMMENDS 3 BACKFILL METHODS: STONESHOOTER LOCATED OFF THE CHAMBER BED. BACKFILL AS ROWS ARE BUILT USING AN EXCAVATOR ON THE FOUNDATION STONE
- BACKFILL FROM OUTSIDE THE EXCAVATION USING A LONG BOOM HOE OR
- THE FOUNDATION STONE SHALL BE LEVELED AND COMPACTED PRIOR TO PLACING
- JOINTS BETWEEN CHAMBERS SHALL BE PROPERLY SEATED PRIOR TO PLACING STONE.
- MAINTAIN MINIMUM 6" (150 mm) SPACING BETWEEN THE CHAMBER ROWS.
- EMBEDMENT STONE SURROUNDING CHAMBERS MUST BE A CLEAN, CRUSHED, ANGULAR STONE 3/4-2" (20-50 mm).
- THE CONTRACTOR MUST REPORT ANY DISCREPANCIES WITH CHAMBER FOUNDATION MATERIALS BEARING CAPACITIES TO THE SITE DESIGN ENGINEER.
- ADS RECOMMENDS THE USE OF "FLEXSTORM CATCH IT" INSERTS DURING CONSTRUCTION FOR ALL INLETS TO PROTECT THE SUBSURFACE STORMWATER

MANAGEMENT SYSTEM FROM CONSTRUCTION SITE RUNOFF.

NOTES FOR CONSTRUCTION EQUIPMENT

- STORMTECH SC-310 & SC-740 CHAMBERS SHALL BE INSTALLED IN ACCORDANCE WITH HE "STORMTECH SC-310/SC-740/DC-780 CONSTRUCTION GUIDE".
- THE USE OF CONSTRUCTION EQUIPMENT OVER SC-310 & SC-740 CHAMBERS IS LIMITED: NO EQUIPMENT IS ALLOWED ON BARE CHAMBERS.
- NO RUBBER TIRED LOADERS, DUMP TRUCKS, OR EXCAVATORS ARE ALLOWED UNTIL PROPER FILL DEPTHS ARE REACHED IN ACCORDANCE WITH THE "STORMTECH SC-310/SC-740/DC-780 CONSTRUCTION GUIDE". WEIGHT LIMITS FOR CONSTRUCTION EQUIPMENT CAN BE FOUND IN THE
- "STORMTECH SC-310/SC-740/DC-780 CONSTRUCTION GUIDE". FULL 36" (900 mm) OF STABILIZED COVER MATERIALS OVER THE CHAMBERS IS REQUIRED FOR DUMP TRUCK TRAVEL OR DUMPING.

USE OF A DOZER TO PUSH EMBEDMENT STONE BETWEEN THE ROWS OF CHAMBERS MAY CAUSE DAMAGE TO THE CHAMBERS AND IS NOT AN ACCEPTABLE BACKFILL METHOD. ANY CHAMBERS DAMAGED BY THE "DUMP AND PUSH" METHOD ARE NOT COVERED UNDER THE

CONTACT STORMTECH AT 1-888-892-2694 WITH ANY QUESTIONS ON INSTALLATION REQUIREMENTS OR WEIGHT LIMITS FOR CONSTRUCTION EQUIPMENT.

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MORTAR ALL

HEIGHT OF

VARY FROM


RISER SECTIONS

JOINTS

ACCEPTABLE FILL MATERIALS: STORMTECH SC-740 CHAMBER SYSTEMS

	. *	MATERIAL LOCATION	DESCRIPTION	AASHTO MATERIAL CLASSIFICATIONS	COMPACTION / DENSITY REQUIREMENT
тн	D	FINAL FILL: FILL MATERIAL FOR LAYER 'D' STARTS FROM THE TOP OF THE 'C' LAYER TO THE BOTTOM OF FLEXIBLE PAVEMENT OR UNPAVED FINISHED GRADE ABOVE. NOTE THAT PAVEMENT SUBBASE MAY BE PART OF THE 'D' LAYER	ANY SOIL/ROCK MATERIALS, NATIVE SOILS, OR PER ENGINEER'S PLANS. CHECK PLANS FOR PAVEMENT SUBGRADE REQUIREMENTS.	N/A	PREPARE PER SITE DESIGN ENGINEER'S PLAN PAVED INSTALLATIONS MAY HAVE STRINGENT MATERIAL AND PREPARATION REQUIREMENTS
•	С	INITIAL FILL: FILL MATERIAL FOR LAYER 'C' STARTS FROM THE TOP OF THE EMBEDMENT STONE ('B' LAYER) TO 18" (450 mm) ABOVE THE TOP OF THE CHAMBER. NOTE THAT PAVEMENT SUBBASE MAY BE A PART OF THE 'C' LAYER.	GRANULAR WELL-GRADED SOIL/AGGREGATE MIXTURES, <35% FINES OR PROCESSED AGGREGATE. MOST PAVEMENT SUBBASE MATERIALS CAN BE USED IN LIEU OF THIS LAYER.	OR	BEGIN COMPACTIONS AFTER 12" (300 mm) OF MATERIAL OVER THE CHAMBERS IS REACHED COMPACT ADDITIONAL LAYERS IN 6" (150 mm) M LIFTS TO A MIN. 95% PROCTOR DENSITY FOR WELL GRADED MATERIAL AND 95% RELATIVE DENSITY FOR PROCESSED AGGREGATE MATERIALS. ROLLER GROSS VEHICLE WEIGHT NOT TO EXCEED 12,000 lbs (53 kN). DYNAMIC FORCE NOT TO EXCEED 20,000 lbs (89 kN).
CE TIC	В	EMBEDMENT STONE: FILL SURROUNDING THE CHAMBERS FROM THE FOUNDATION STONE ('A' LAYER) TO THE 'C' LAYER ABOVE.	CLEAN, CRUSHED, ANGULAR STONE	AASHTO M43 ¹ 3, 357, 4, 467, 5, 56, 57	NO COMPACTION REQUIRED.
	A	FOUNDATION STONE: FILL BELOW CHAMBERS FROM THE SUBGRADE UP TO THE FOOT (BOTTOM) OF THE CHAMBER.	CLEAN, CRUSHED, ANGULAR STONE	AASHTO M43 ¹ 3, 357, 4, 467, 5, 56, 57	PLATE COMPACT OR ROLL TO ACHIEVE A FLAT SURFACE. ^{2,3}


PLEASE NOTE THE LISTED AASHTO DESIGNATIONS ARE FOR GRADATIONS ONLY. THE STONE MUST ALSO BE CLEAN, CRUSHED, ANGULAR. FOR EXAMPLE, A SPECIFICATION FOR #4 STONE WOULD STATE: "CLEAN, CRUSHED, ANGULAR NO. 4 (AASHTO M43) STONE". STORMTECH COMPACTION REQUIREMENTS ARE MET FOR 'A' LOCATION MATERIALS WHEN PLACED AND COMPACTED IN 6" (150 mm) (MAX) LIFTS USING TWO FULL COVERAGES WITH A VIBRATORY COMPACTOR. WHERE INFILTRATION SURFACES MAY BE COMPROMISED BY COMPACTION, FOR STANDARD DESIGN LOAD CONDITIONS, A FLAT SURFACE MAY BE ACHIEVED BY RAKING OR DRAGGING WITHOUT COMPACTION EQUIPMENT. FOR SPECIAL LOAD DESIGNS, CONTACT STORMTECH FOR COMPACTION REQUIREMENTS.

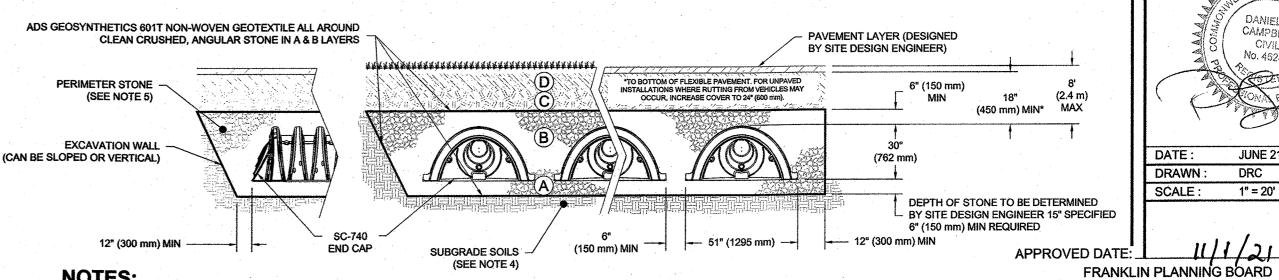


- 1. SC-7410 CHAMBERS SHALL CONFORM TO THE REQUIREMENTS OF ASTM F2418 "STANDARD SPECIFICATION FOR POLYPROPYLENE (PP) CORRUGATED WALL STORMWATER COLLECTION CHAMBERS", OR ASTM F2922 "STANDARD SPECIFICATION FOR POLYETHYLENE (PE) CORRUGATED WALL STORMWATER COLLECTION CHAMBERS".
- 2. SC-740 CHAMBERS SHALL BE DESIGNED IN ACCORDANCE WITH ASTM F2787 "STANDARD PRACTICE FOR STRUCTURAL DESIGN OF THERMOPLASTIC CORRUGATED WALL
- 3. "ACCEPTABLE FILL MATERIALS" TABLE ABOVE PROVIDES MATERIAL LOCATIONS, DESCRIPTIONS, GRADATIONS, AND COMPACTION REQUIREMENTS FOR FOUNDATION, EMBEDMENT AND FILL MATERIALS.
- 4. THE SITE DESIGN ENGINEER IS RESPONSIBLE FOR ASSESSING THE BEARING RESISTANCE (ALLOWABLE BEARING CAPACITY) OF THE SUBGRADE SOILS AND THE DEPTH OF FOUNDATION STONE WITH CONSIDERATION FOR THE RANGE OF EXPECTED SOIL MOISTURE CONDITIONS.
- 5. PERIMETER STONE MUST BE EXTENDED HORIZONTALLY TO THE EXCAVATION WALL FOR BOTH VERTICAL AND SLOPED EXCAVATION WALLS.
- 6. ONCE LAYER 'C' IS PLACED, ANY SOIL/MATERIAL CAN BE PLACED IN LAYER 'D' UP TO THE FINISHED GRADE. MOST PAVEMENT SUBBASE SOILS CAN BE USED TO REPLACE THE

SC-740 CROSS SECTION DETAIL STORMTECH SC-310 DETAILS AND SPECIFICATIONS

NOT TO SCALE

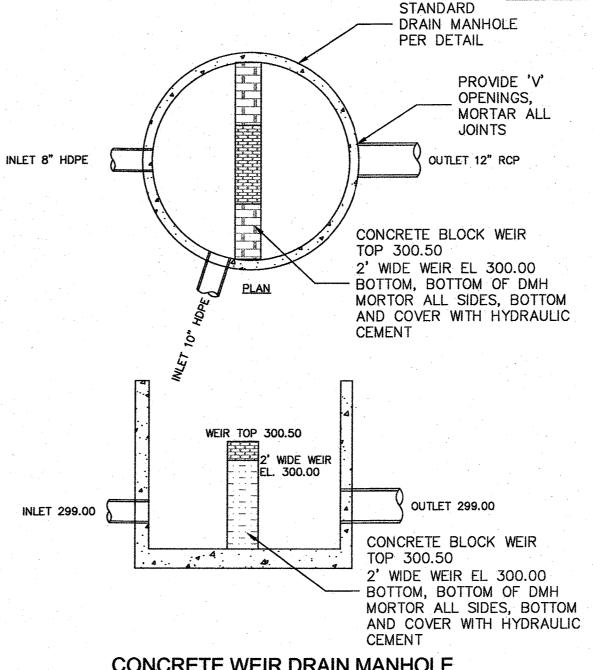

MATERIAL REQUIREMENTS OF LAYER 'C' OR 'D' AT THE SITE DESIGN ENGINEER'S DISCRETION

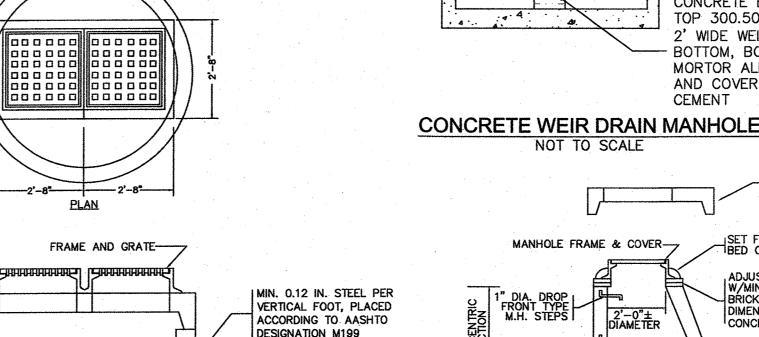

OUTSIDE OF PIPE

+2" CLEARANCE

- PROVIDE "V" OPENINGS

VARIES DEPENDING


SEPARATOR TO BE

"NEENAH R-3705"


OR APPROVED EQUAL

ON DIAM. OF PIPE

(MINIMUM 12")

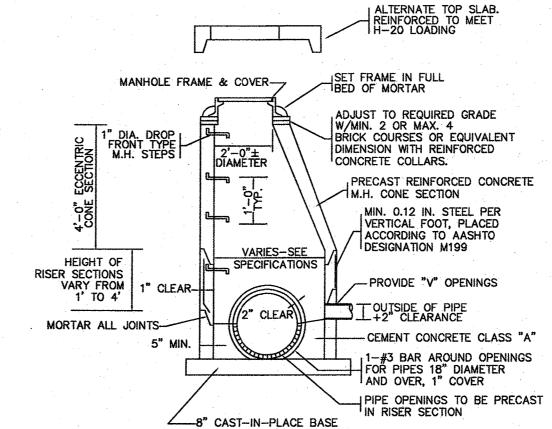



PRECAST CONCRETE DRAIN MANHOLE

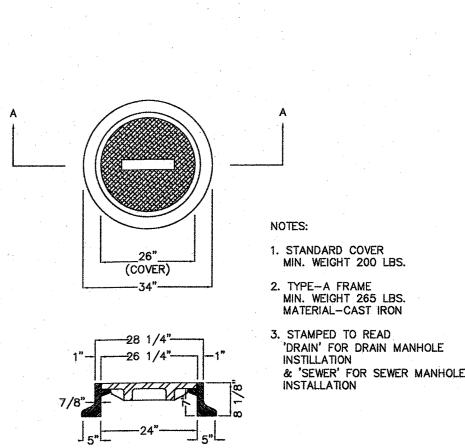

STANDARD MANHOLE FRAME & COVER NOT TO SCALE

SECTION A-A

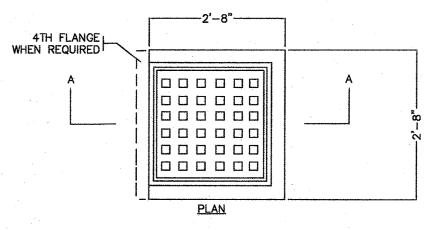

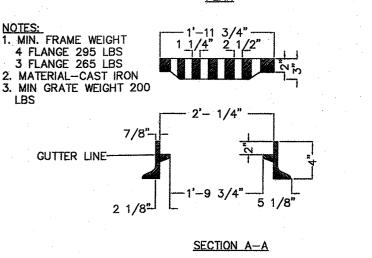

STANDARD CATCH BASIN FRAME & GRATE

DО $i \infty$ OU

NO DATE

REVISIONS

1 06/21/2021 PERMIT SUBMISSION

09/13/2021 RESPONSE TO COMMENTS

10/04/2021 RESPONSE TO COMMENTS

4 10/19/2021 RESPONSE TO COMMENTS

5 11/30/2021 APPROVAL CONDITIONS

JUNE 21, 2021

DRC

SCALE: 1" = 20'

DATE:

DRAWN:

BEING A MAJORITY

CIVIL ENGINEERING / LAND SURVEYING 249 SOUTH STREET PLAINVILLE, MA 02762 TEL. (508) 695-2221 FAX. (508) 695-2219

DETAILS

SHEET 7 OF 8

WITH GAS AND OIL SEPARATOR

INSPECTION PORT INSTALLATION

NOT TO SCALE


8" CAST-IN-PLACE BASE

PRECAST CONCRETE DOUBLE CATCH BASIN


CDS UNIT DETAILS AND SPECIFICATIONS

NOT TO SCALE

NOT TO SCALE

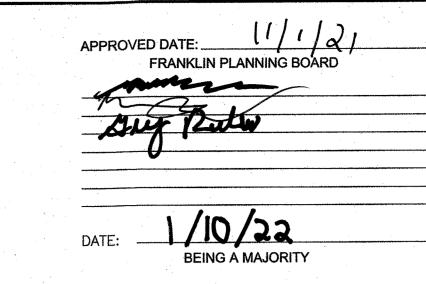

NO DATE REVISIONS 1 06/21/2021 PERMIT SUBMISSION 2 09/13/2021 RESPONSE TO COMMENTS 10/04/2021 RESPONSE TO COMMENTS 4 10/19/2021 RESPONSE TO COMMENTS 5 11/30/2021 APPROVAL CONDITIONS SEAL

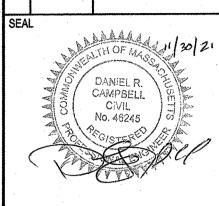

DATE: JUNE 21, 2021 DRAWN: DRC SCALE: 1" = 20'

OU 4 II

CIVIL ENGINEERING / LAND SURVEYING 249 SOUTH STREET

UNIT 1 PLAINVILLE, MA 02762 TEL. (508) 695-2221 FAX. (508) 695-2219

TYPICAL DETAILS


SHEET 8 OF 8

REINFORCED CONCRETE NOTES


- R1. ALL CONCRETE SHALL BE PROPORTIONED, MIXED AND PLACED IN ACCORDANCE WITH ACI 318. "BUILDING CODE REQUIREMENTS FOR REINFORCED CONCRETE", AND ACI 301, "SPECIFICATIONS FOR STRUCTURAL CONCRETE FOR BUILDINGS". MAXIMUM SLUMP SHALL BE 4 INCHES.
- R2. ALL CONCRETE SHALL BE CONTROLLED, MIXED, AND PLACED UNDER THE SUPERVISION OF AN APPROVED CONCRETE TESTING AGENCY.
- R3. UNLESS NOTED OTHERWISE, ALL CONCRETE SHALL BE NORMAL WEIGHT WITH A MINIMUM COMPRESSIVE STRENGTH AT THE END OF 28 DAYS AS FOLLOWS:


STRENGTH (PSI) AGGREGATE SIZE (in.) ENTRAINED AIR (%) <u>APPLICATION</u> EXTERIOR CONCRETE 3000

- R4. THE USE OF "FLY ASH" IN CONCRETE MIX DESIGN IS NOT ALLOWED.
- R5. NO ADMIXTURES OTHER THAN LOW RANGE WATER REDUCER WILL BE ALLOWED.
- R6. THE CONTRACTOR SHALL BE RESPONSIBLE FOR PROPER REMOVAL OF FORMWORK. FORMS SHALL BE REMOVED ONLY AFTER CONCRETE HAS ATTAINED SUFFICIENT STRENGTH TO SUPPORT ITS OWN WEIGHT. CONSTRUCTION LOADS AND LATERAL LOADS SHOULD BE PLACED WITHOUT DAMAGE TO THE STRUCTURE OR CAUSE ANY EXCESSIVE DEFLECTION.
- R7. CONSTRUCTION JOINT LOCATIONS, OTHER THAN THOSE SHOWN ON THE DRAWINGS, ARE PERMITTED SUBJECT TO PRIOR APPROVAL OF THE ENGINEER. CONTROL JOINTS AND EXPANSION JOINTS ARE
- R8. PROVIDE 3/4 INCH CHAMFER AT ALL CONTINUOUSLY EXPOSED CONCRETE EDGES, SUCH AS CURBS, EQUIPMENT PADS, AND EDGE OF WALLS.
- R9. PROVIDE FLANGED STEEL SLEEVES WHERE PIPES PASS THROUGH CONCRETE.
- R10. ALL DETAILING, FABRICATION AND PLACING OF REINFORCING STEEL SHALL BE IN ACCORDANCE WITH THE LATEST ACI 315 "DETAILS AND DETAILING OF CONCRETE REINFORCING".
- R11. REINFORCING BARS SHALL CONFORM TO ASTM A615, GRADE 60. UNLESS NOTED OTHERWISE
 - ON THE DRAWINGS, THE CLEAR CONCRETE COVER OVER BARS SHALL BE AS FOLLOWS: A. SURFACES PLACED IN CONTACT WITH THE GROUND 3
 - B. FORMED SURFACE EXPOSED TO GROUND..
 - C. INSIDE FACE OF FORMED WALL.
 - D. WALL PIER TIES... E. SLAB REINFORCING..
- R12. PROVIDE CLASS B SPLICES FOR ALL CONTINUOUS REINFORCEMENT UNLESS NOTED OTHERWISE.
- R13. SET AND TIE ALL REINFORCEMENT BEFORE PLACING CONCRETE. SETTING OF ANCHOR BOLTS, DOWELS AND REINFORCEMENT INTO WET CONCRETE IS PROHIBITED.
- R14. ALL KEYS SHALL BE 2"x4" (NOMINAL) UNLESS NOTED OTHERWISE.
- R15. USE NON-SHRINK, NON-METALLIC GROUT WHERE INDICATED.
- R16. PROVIDE SEALANT FOR ALL EXPOSED TO VIEW CONSTRUCTION AND/OR CONTROL JOINTS.

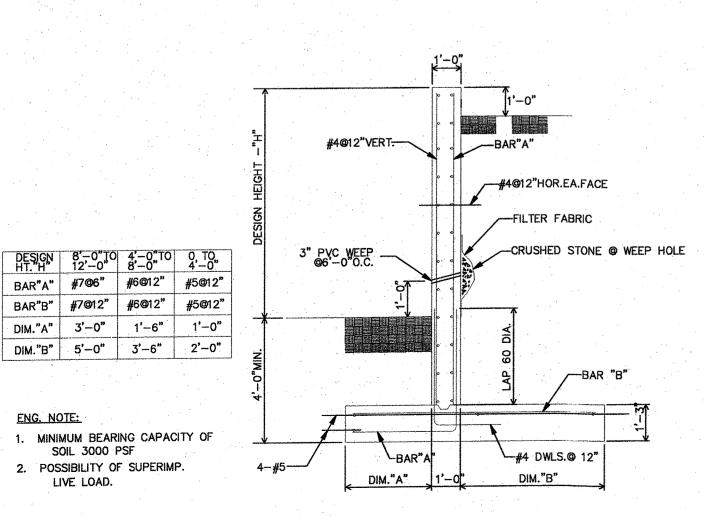

REINFORCED CONCRETE **RETAINING WALL** NOT TO SCALE

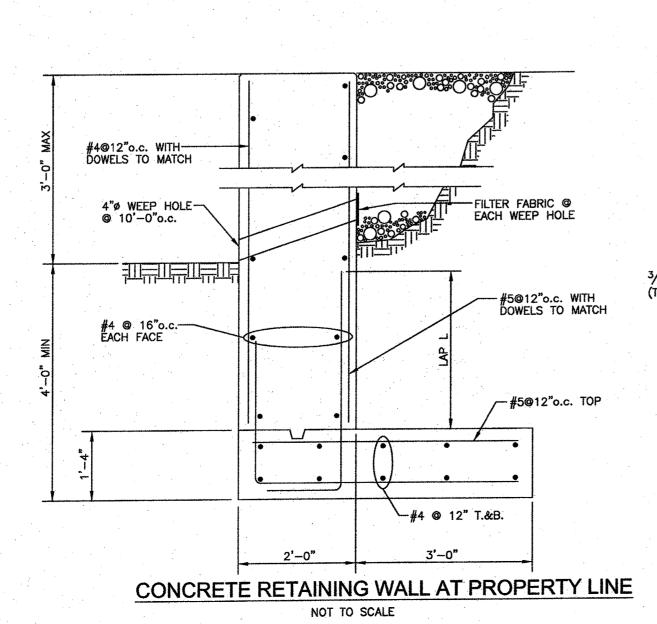

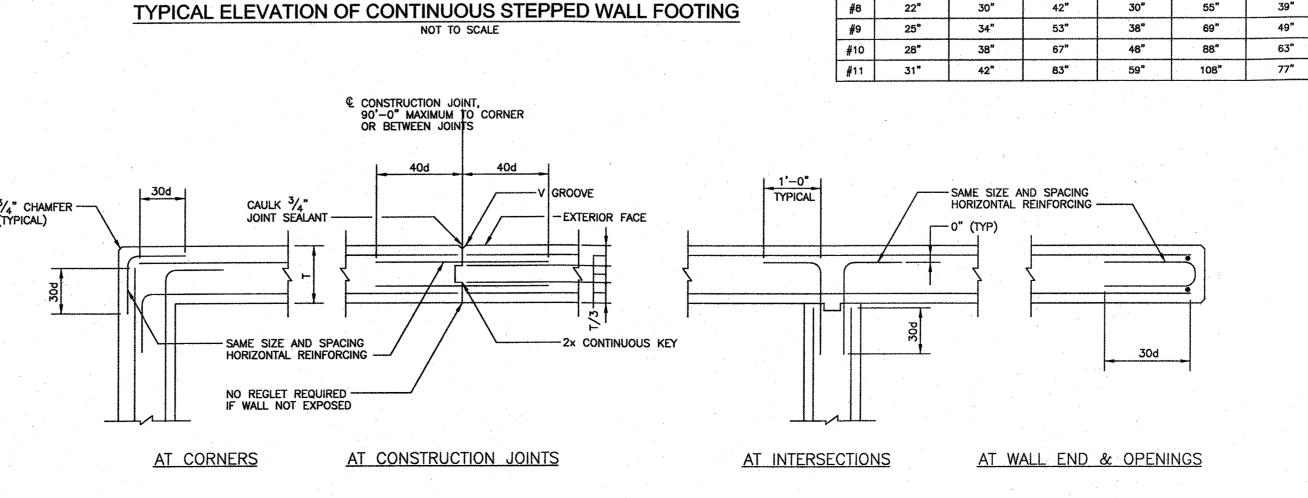

REINFORCING TO MATCH HORIZONTAL WALL REINFORCING

SCHEDULE OF EMBEDMENT AND SPLICE LENGTHS (UNLESS SHOWN OTHERWISE ON DRAWINGS)

21"

25"

19"

23"

30"

17"

EMBEDMENT LAP SPLICE EMBEDMENT LENGTH LAP SPLICE LENGTH

TOP BARS OTHER BARS TOP BARS OTHER BARS

12"

15"

18"

23"

30"

16"

27"

33"

55"

16"

16"

20"

24"

30"


39"


TYPICAL FOUNDATION WALL DETAILS

-FOUNDATION WALL

(MINIMUM)

(TYPICAL)

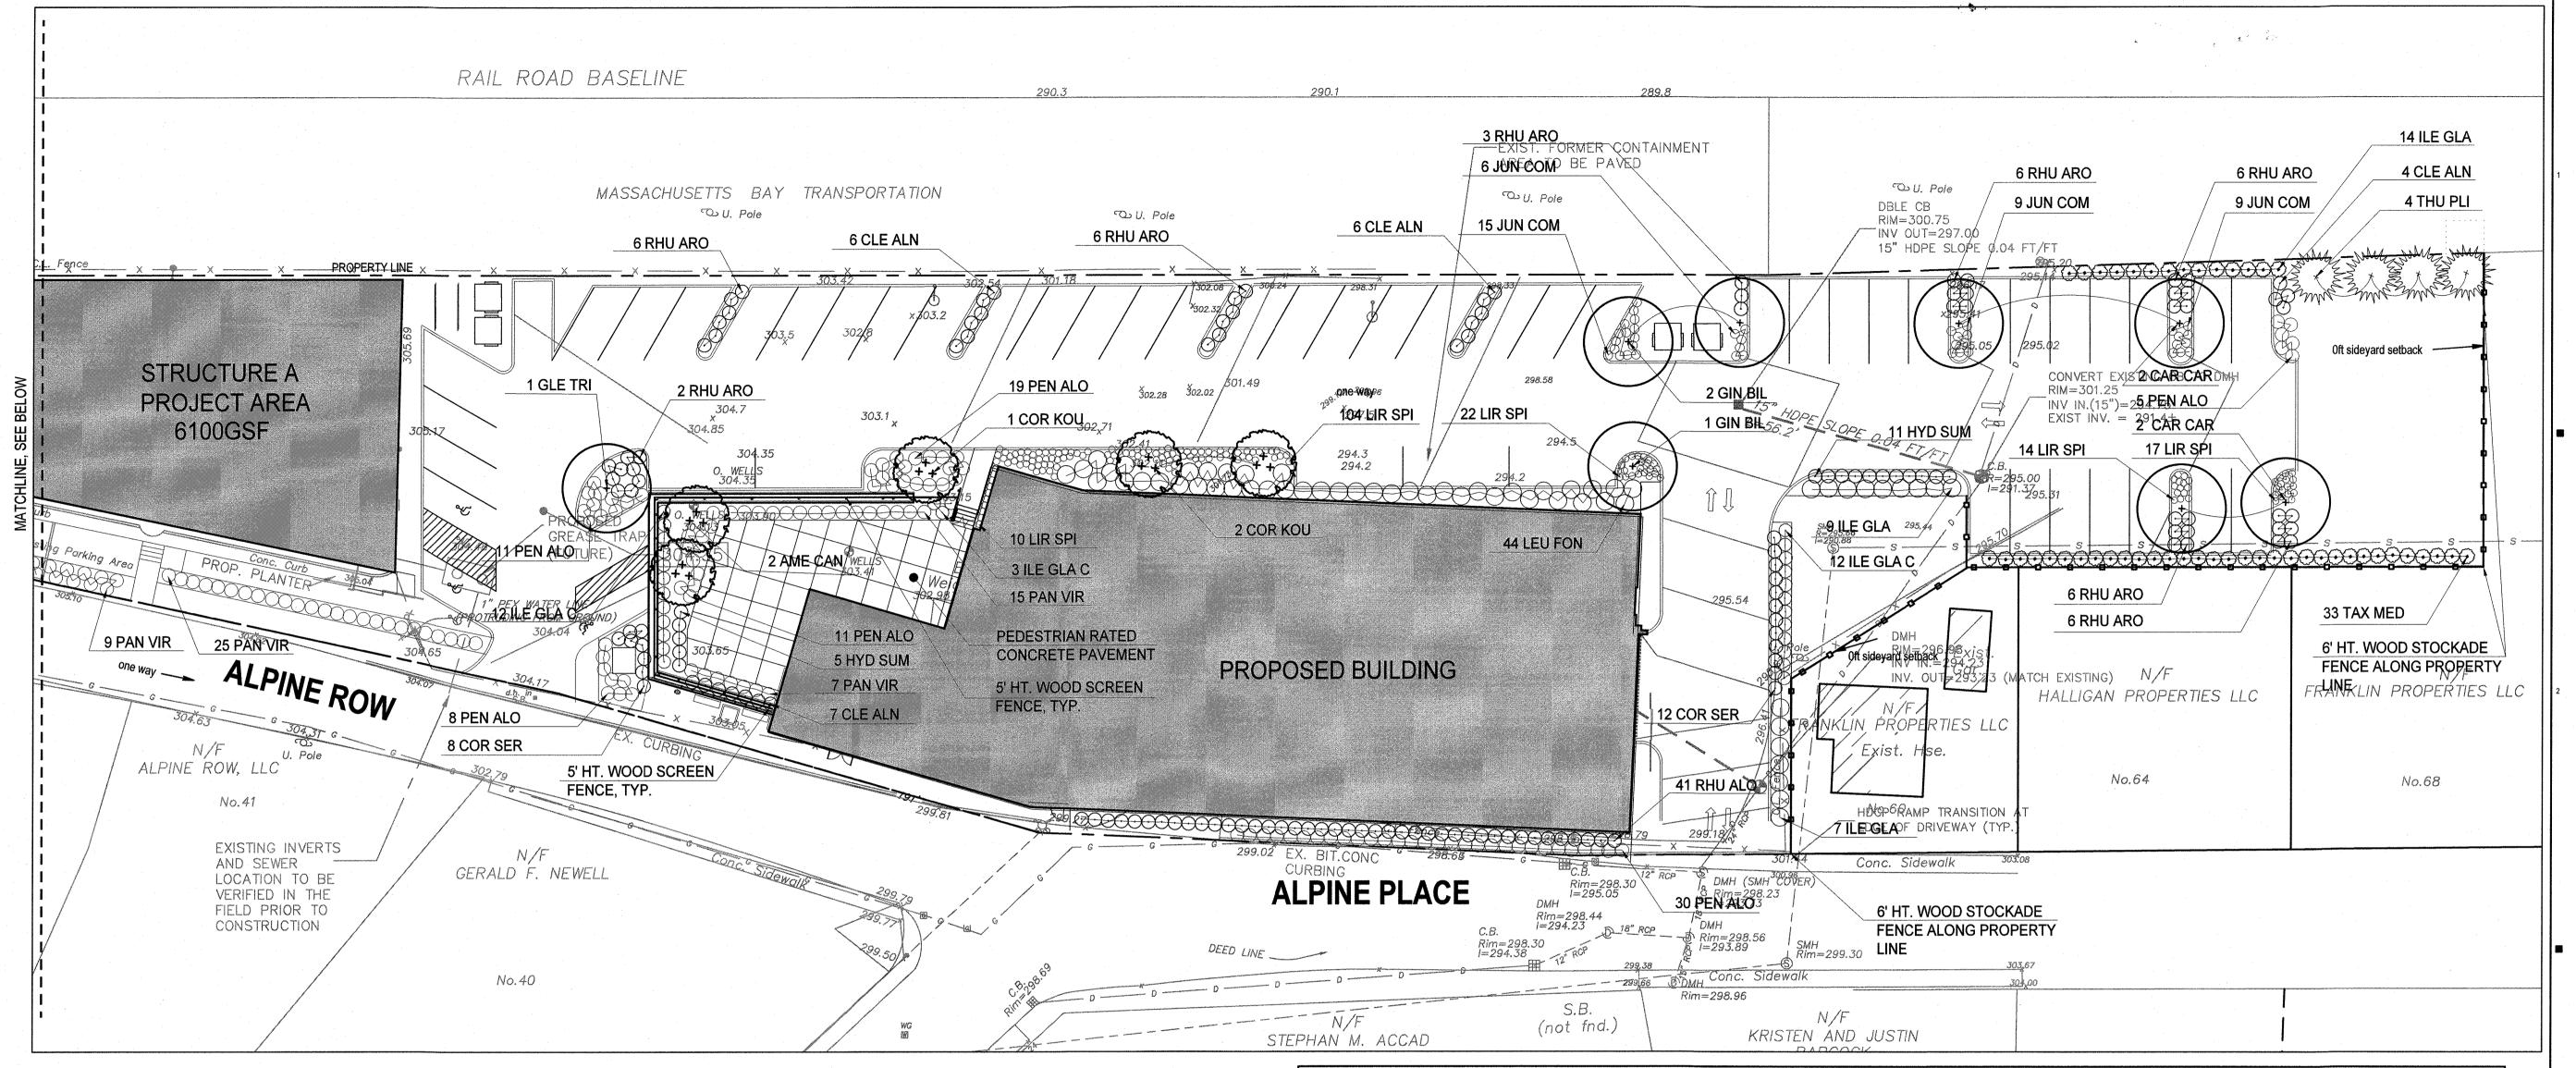

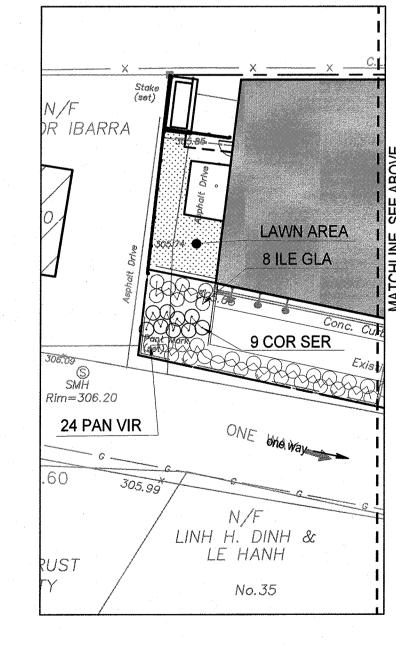

PLANTING NOTES

- 1. BASE FILE SURVEY INFORMATION PROVIDED BY JOE THE ARCHITECT, MAY 05, 2021.
- 2. IF DISCREPANCIES EXIST BETWEEN THE NUMBER OF PLANTS DRAWN ON THE PLANTING PLAN AND THE NUMBER OF PLANTS IN THE PLANT LIST, THE PLANTING PLAN SHALL GOVERN.
- 3. ALL NEW PLANT MATERIAL SHALL CONFORM TO THE MINIMUM GUIDELINES ESTABLISHED FOR NURSERY STOCK PUBLISHED BY THE AMERICAN NURSERY AND LANDSCAPE ASSOCIATION. IN ADDITION, ALL NEW PLANT MATERIAL FOR THE PROJECT SHALL BE OF SPECIMEN QUALITY.
- 4. ALL NEW PLANTS TO BE BALLED AND BURLAPPED OR CONTAINER-GROWN, UNLESS OTHERWISE NOTED ON THE PLANT LIST.
- 5. THE CONTRACTOR SHALL SUPPLY ALL NEW PLANT MATERIAL IN QUANTITIES SUFFICIENT TO COMPLETE THE PLANTING SHOWN ON THE DRAWINGS.
- 6. ANY PROPOSED SUBSTITUTIONS OF PLANT SPECIES SHALL BE MADE WITH PLANTS OF EQUIVALENT OVERALL FORM, HEIGHT, BRANCHING HABIT, FLOWER, LEAF, COLOR, FRUIT AND CULTURE, AND ONLY AFTER WRITTEN APPROVAL OF THE LANDSCAPE ARCHITECT.
- 7. CONTRACTOR SHALL LOCATE AND VERIFY ALL EXISTING UTILITY LINES PRIOR TO PLANTING AND SHALL REPORT ANY CONFLICTS TO THE LANDSCAPE ARCHITECT.
- 8. STAKE LOCATION OF ALL PROPOSED PLANTING FOR APPROVAL BY OWNER'S REP PRIOR TO THE COMMENCEMENT OF PLANTING.
- 9. NEW SHRUBS AND GROUND COVER SHALL BEAR THE SAME RELATIONSHIP TO GRADE AS IT BORE TO PREVIOUS GRADE. TREES SHALL BE SET 3" HIGHER THAN PREVIOUS GRADE. NO TREES SHALL BE PLANTED BEFORE ACCEPTANCE OF ROUGH GRADING.
- 10. ALL PLANT BEDS TO RECEIVE THREE INCHES (3") OF BARK MULCH AS PER THE SPECIFICATIONS.
- 11. ALL EXISTING TREES TO REMAIN SHALL BE PROPERLY PROTECTED DURING CONSTRUCTION. PROTECTION TECHNIQUES SHALL BE REVIEWED AND APPROVED BY THE OWNER'S REP.
- 12. PRUNE EXISTING AND NEW TREES IN ACCORDANCE WITH THE SPECIFICATIONS.
- 13. CONTRACTOR SHALL PROVIDE FULL DEPTHS OF LOAM AS NOTED ON DETAILS AND AS SPECIFIED, FOR ALL PLANTING.
- 14. ALL TREES TO BE REMOVED FROM SCOPE OF WORK SHALL INCLUDE GRINDING OF STUMP AND REMOVAL OFF-SITE.
- 15. ANY EXISTING TREES AFFECTED BY CONSTRUCTION SHALL HAVE ROOTS PRUNED PER THE SPECIFICATIONS.
- 16. ALL PLANTS ON THE PLANTING SCHEDULE COMPLY WITH THE TOWN OF FRANKLIN'S BEST DEVELOPMENT PRACTICES GUIDEBOOK. PLANTS INDICATED AS NATIVE CAN BE FOUND ON THE TOWN'S RECOMMENDED LIST OF PLANTS. ALL OTHER PLANTS INDICATED ARE NON-INVASIVE AND PER THE GUIDEBOOK ARE APPROVED TO BE INSTALLED IN THIS LOCATION. THEY HAVE BEEN SELECTED FOR HARDINESS, TOLERANCE TO SALT, POLLUTION AND SOLAR ORIENTATION PREFERENCES.

LANTIN	NG SC	HEDULE			
SYM	QTY	BOTANICAL NAME	COMMON NAME	SIZE	SPACING/NOTES
SHADE TREES				1	
GIN BIL	3	Ginkgo biloba	Ginkgo	2 - 2 ½" CAL	B&B
GLE TRI	1	Gleditsia triacanthos	Honeylocust	2 - 2 ½" CAL	B&B
CAR CAR	4	Carpus carolinia	American Hornbeam	2 - 2 ½" CAL	B&B, NATIVE
ORNAMENTAL T	REES				
AME CAN	2	Amelanchier canadensis	Serviceberry	8-10' HT.	B&B Multi-stem, NATIVE
COR KOU	3	Cornus kousa	Kousa Dogwood	8-10' HT.	B&B Multi-stem
EVERGREEN TR	REES				
THU PLI	4	Thuja plicata 'Nana'	Dwarf Western Arbovitae	8-10' HT.	B&B
EVERGREEN	SHRUBS				
ILE GLA C	27	llex glabra 'compacta'	Compact Inkberry	24"-36" HT	36" O.C. NATIVE
ILE GLA	38	llex glabra	Inkberry	24"-36" HT	42" O.C. NATIVE
LEU FON	44	Leucothoe fontanesiana 'Compacta'	Compact Drooping Leucothoe	2 Gal.	48" O.C. NATIVE
TAX MED	33	Taxus media 'Hill's Upright'	Hill's Upright Yew	36"-48" HT	36" O.C.
DECIDUOUS SH	RUBS				
CLE ALN	23	Clethra alnifolia 'Compacta;	Compact Summersweet	3 Gal.	48" O.C. NATIVE
COR SER	29	Cornus Sericea 'kelseyi'	Kelsey Dogwood	3 Gal.	48" O.C. NATIVE
HYD SUM	16	Hydrangea 'Endless Summer'	Endless Summer Hydrangea	3 Gal.	36" O.C.
RHU ARO	83	Rhus aromatica 'Gro Low'	Gro-Low Fragrant Sumac	3 Gal.	36" O.C. NATIVE
DRNAMENTAL G	GRASSES A	ND PERENNIALS			
JUN COM	21	Juniperus communis	Common Juniper	1 Gal.	24" O.C. NATIVE
LIR SPI	177	Liriope spicata	Lily Turf	1 Gal.	18" O.C.
PAN VIR	80	Pannicum virgatum 'Shenandoah'	Switch Grass	1 Gal.	36" O.C. NATIVE
PEN ALO	84	Pennisetum alopecuroides 'hameln'	Hameln Fountain Grass	1 Gal.	36" O.C.


Joe The Architect, LLC

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5 MT. ROYAL AVENUE, MARLBOROUGH, MA 01752

CONSULTANT



KEY PLAN

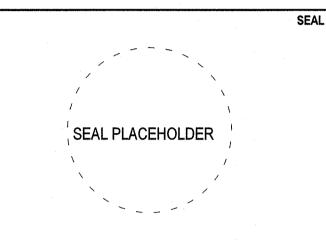APPROVED DATE:
FRANKLIN PLANNING BOARD

TO AND TO A

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OCTOBER 8, 2021

440

PROJECT NUMBER


JL CHECKED

JL APPROVED

1"= 20'-0"

SCALE


SITE LANDSCAPE PLAN

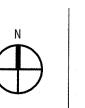


LA-01

SHEET NUMBER


SHEET NAME

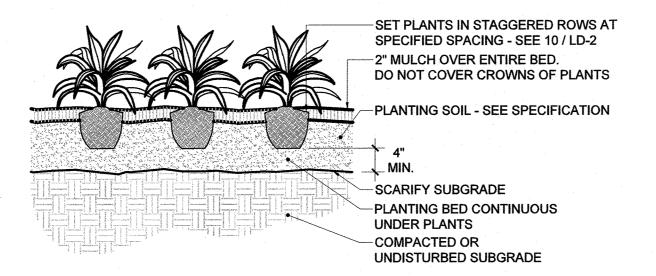

4 PERENNIAL/GROUNDCOVER PLANTING SCALE: NTS

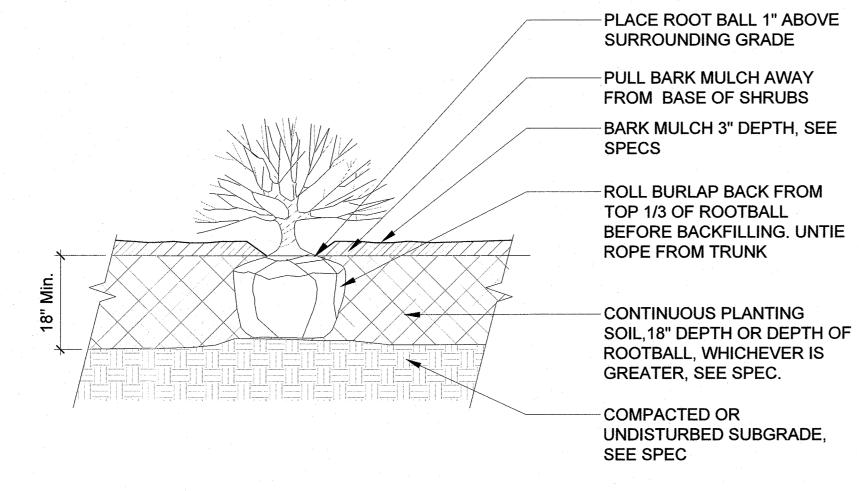


5 SHRUB PLANTING
SCALE: NTS

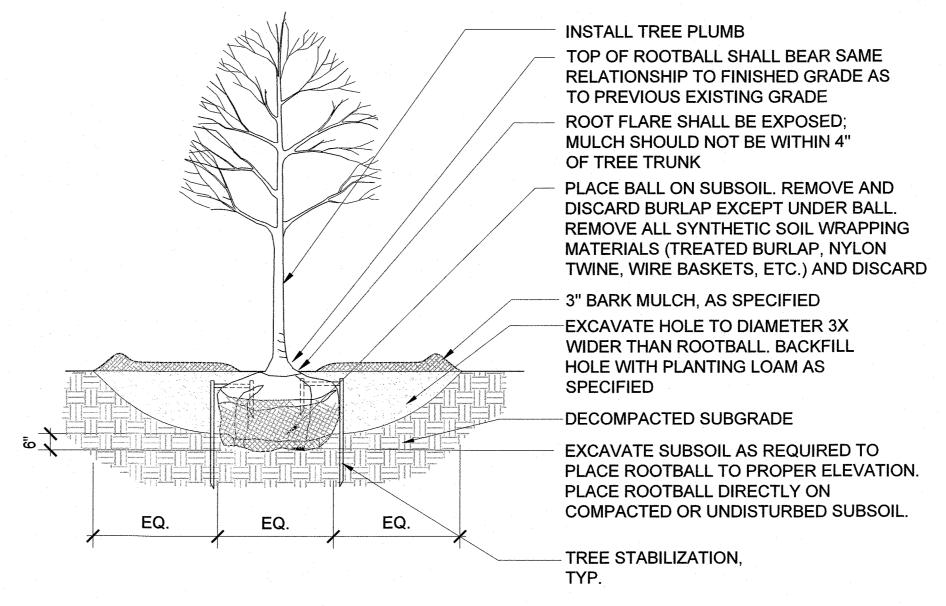

DECIDUOUS TREE PLANTING -INSTALL TREE PLUMB -ROOTFLARE SHALL BE EXPOSED; BARK MULCH SHOULD NOT BE WITHIN 4" OF TREE TRUNK TOP OF ROOTBALL SHALL BEAR SAME RELATIONSHIP TO FINISHED GRADE AS TO PREVIOUS EXISTING GRADE BARK MULCH 3" DEPTH, SEE SPECIFICATION -CONTINUOUS PLANTING SOIL, SEE SPECIFICATION FOR SOIL VOLUME REQUIREMENTS EXCAVATE SUBSOIL AS REQUIRED TO PLACE ROOTBALL TO PROPER ELEVATION. PLACE ROOTBALL DIRECTLY ON COMPACTED OR UNDISTURBED SUBSOIL SOIL. BACKFILL TREE HOLE WITH SPECIFIED PLANTING SOIL. - DECOMPACTED OR UNDISTURBED SUBGRADE, SEE SPECS TREES STAPLES, TYP. (3) PER TREE, SEE DETAIL 8 / LD-4G EQ EQ EQ

2 EVERGREEN TREE PLANTING
SCALE: NTS

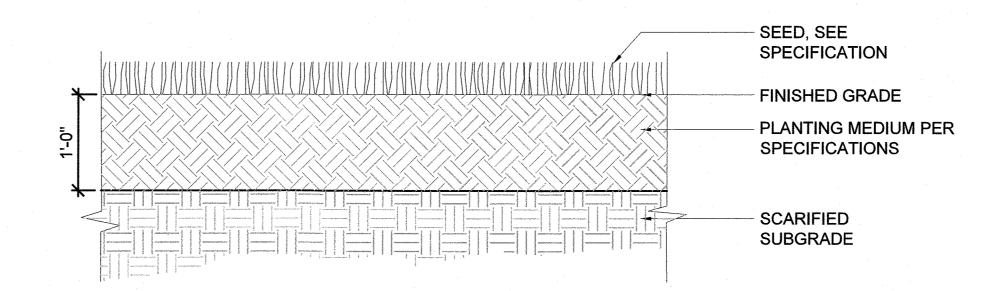

3 SEEDED LAWN
SCALE: NTS


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343 Medford Street, Suite 4C Somerville, MA 02145 t: +1(617) 764-3593 e: askjoe@joethearchitect.com www.joethearchitect.com




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WARNING:


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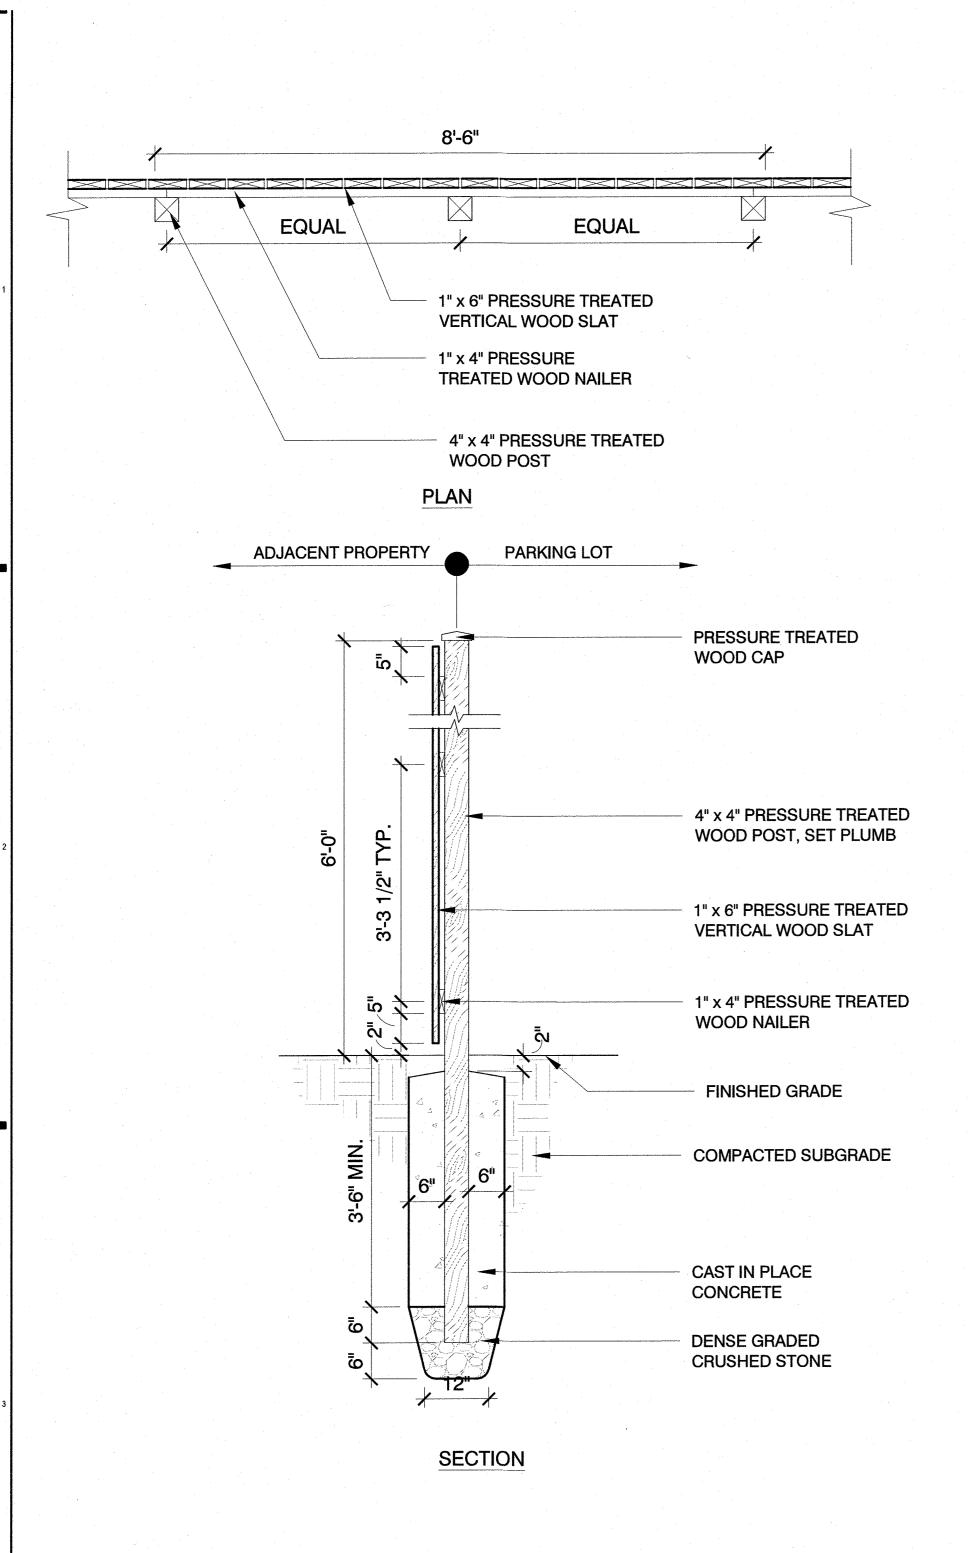
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PROJECT NUMBER	440
CHECKED	JL
APPROVED	JL
SCALE	"= 20'-0"
SHEET NAME	

SITE LANDSCAPE DETAILS

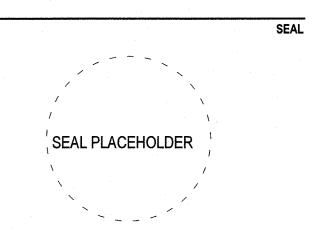

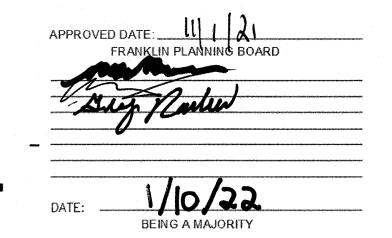
_A-02

SHEET NUMBER

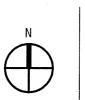

6' HT. WOOD STOCKADE FENCE

POST POST POST POST - FENCE POST CAP, TYP. - FENCE POST, TYP. <u>-</u>[0-[0 <u></u> 4-10 <u>-</u><u></u>¶∽ - FENCE SLAT B, TYP. - KO- FO FENCE SLAT A, TYP. 72 72 - HOLD TOP OF FOOTING 1" 2/2 ABOVE FINISH GRADE, TYP. - FINISH GRADE FENCE POST TO FOOTING FENCE POST TO FOOTING CONNECTION; SEE CONNECTION; SEE **ENLARGEMENT BELOW** ENLARGEMENT - 8" Ø 4000 P.S.I. CONCRETE FOOTING, TYP. - COMPACTED AGGREGATE BASE SCREEN FENCE A - ELEVATION SCREEN FENCE A - SECTION

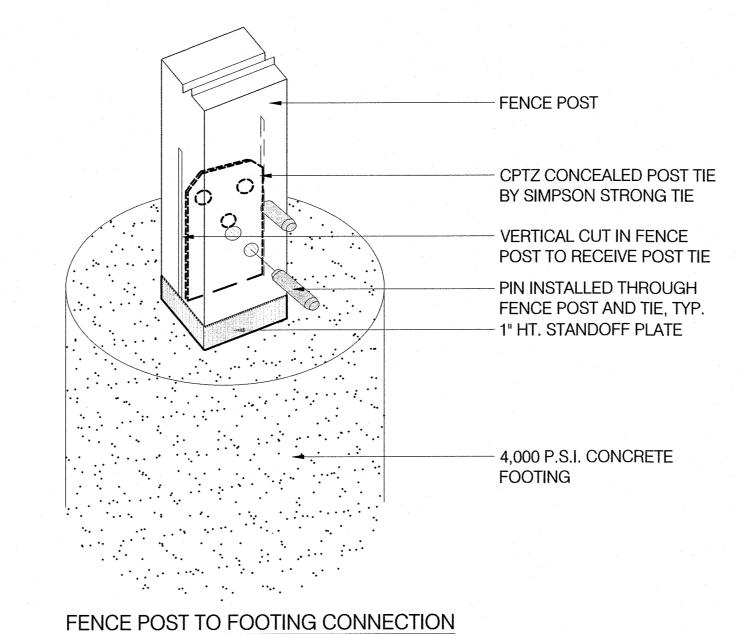

FENCE POST

STAINLESS STEEL

DECKING SCREWS,

TYP.

FENCE SLAT B, TYP.

FENCE SLAT A, TYP.

FENCE SLAT CONNECTION

EQ. EQ. EQ.

NOTES:

- 1. FENCE POST SHALL BE 4X4 NOM. EASTERN RED CEDAR POST
- FENCE SLAT 'A' SHALL BE 2X6 NOM. EASTERN RED CEDAR BOARD
 FENCE SLAT 'B' SHALL BE 2X2 NOM. EASTERN RED CEDAR BOARD
- 4. GAPS BETWEEN FENCE SLATS SHALL BE 2" CLEAR, TYP. EXCEPT
- WHERE SHOWN ON THE DETAIL
- 5. ALL FENCE PANELS SHALL BE INSTALLED PARALLEL WITH VARYING
- HORIZONTAL, AND LINEAR OFFSETS.

 6. PROVIDE SHOP DRAWINGS PRIOR TO FABRICATION.

WOOD SCREEN FENCE AT OUTDOOR TERRACE

SCALE: NTS


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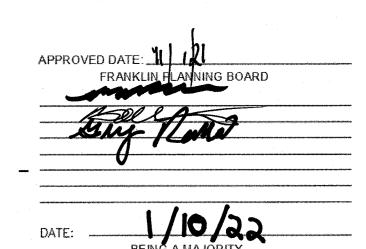
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DATE		OCTOBER 8, 2021
PROJECT NUMBER	440	
CHECKED	JL	
APPROVED	JL	
SCALE	0'-0"	1"= 2

SITE LANDSCAPE DETAILS

SHEET NUMBER




_A-03

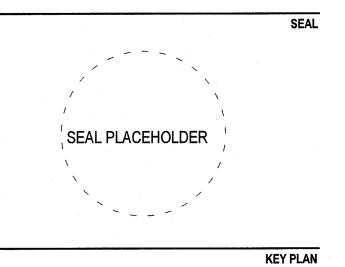SHEET NAME

DECIDUOUS TREES Comparing administration of the comparing the comparin

TREE PLANTING OPTIONS

MAY 17, 2021

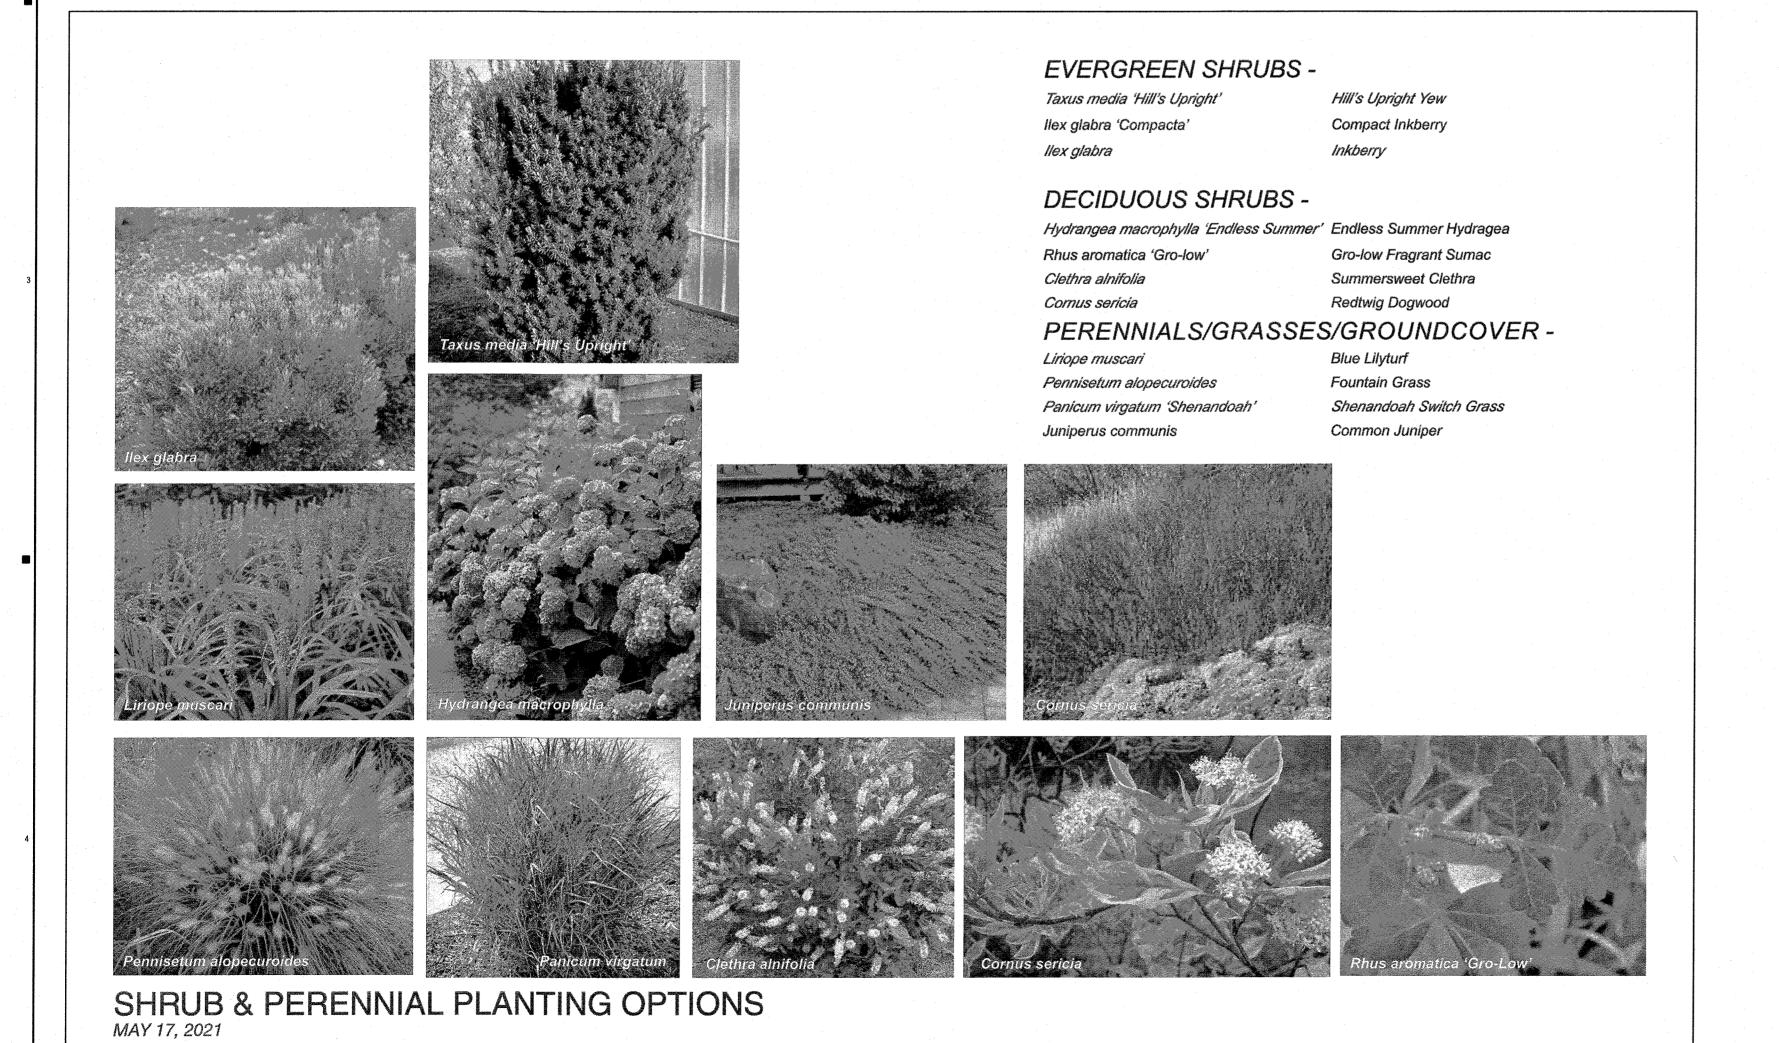

J t A

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SITE LANDSCAPE PLANT IMAGERY



LA-04

SHEET NUMBER

No.65A

No.64

DRAWN BY:
DATE: 06/23/
NOTES:

S

PROJECT:

Calculation Summary Label CalcType Units Avg/Min Max/Min BASKETBALL COURT Illuminance GREEN SPACE Illuminance N.A. PARKING LOT Illuminance 1.61 N.A. SIDEWALK Illuminance SPILL LIGHT Illuminance STRUCTURE A STORAGE AREA Illuminance 29.50 STRUCTURE A STREET AREA Illuminance 1.48 0.0 4.4 N.A. N.A. TRACKS Illuminance 0.00 0.1 0.0 N.A. N.A.

KRISTEN AND JUSTIN BABCOCK

No.67

2.5 2.4 1.8 1.2

WL3 2.5 2.4 1.8 1.2

2.2 2.1 1.5 1.0

TOTAL LOT

0 0.0 0.1 0.3 0.4 0.3


• 0.0 • 0.0

No.40

No.43

No.39

Luminaire Schedule Qty Label Arrangement LLF Description Lum. Lumens 0.900 FL1A-BLT(BLACK)-RND-C4-K1-118-0 / M 428 LL1 SINGLE WL1 SINGLE 0.900 | H18110-91(BLACK)-1-2-HL-A-91(BLACK) | 1295 DL1 SINGLE 0.900 | FM-W9100-FINISH 924 WL3 3587 SINGLE 0.900 RWL1-48L-25-3K7-3-U SL4 SINGLE 0.900 RAR-1-80L-50-3K7-4W-BC 3663 WL5 1346 SINGLE 0.900 | SG1-10-3K BL1 SINGLE 0.900 | S-KK0103US-16A-0870007A-730-16US | 1255 **WALL LIGHT** SINGLE 0.900 | RWL1-48L-45-3K7-4W-U 5484

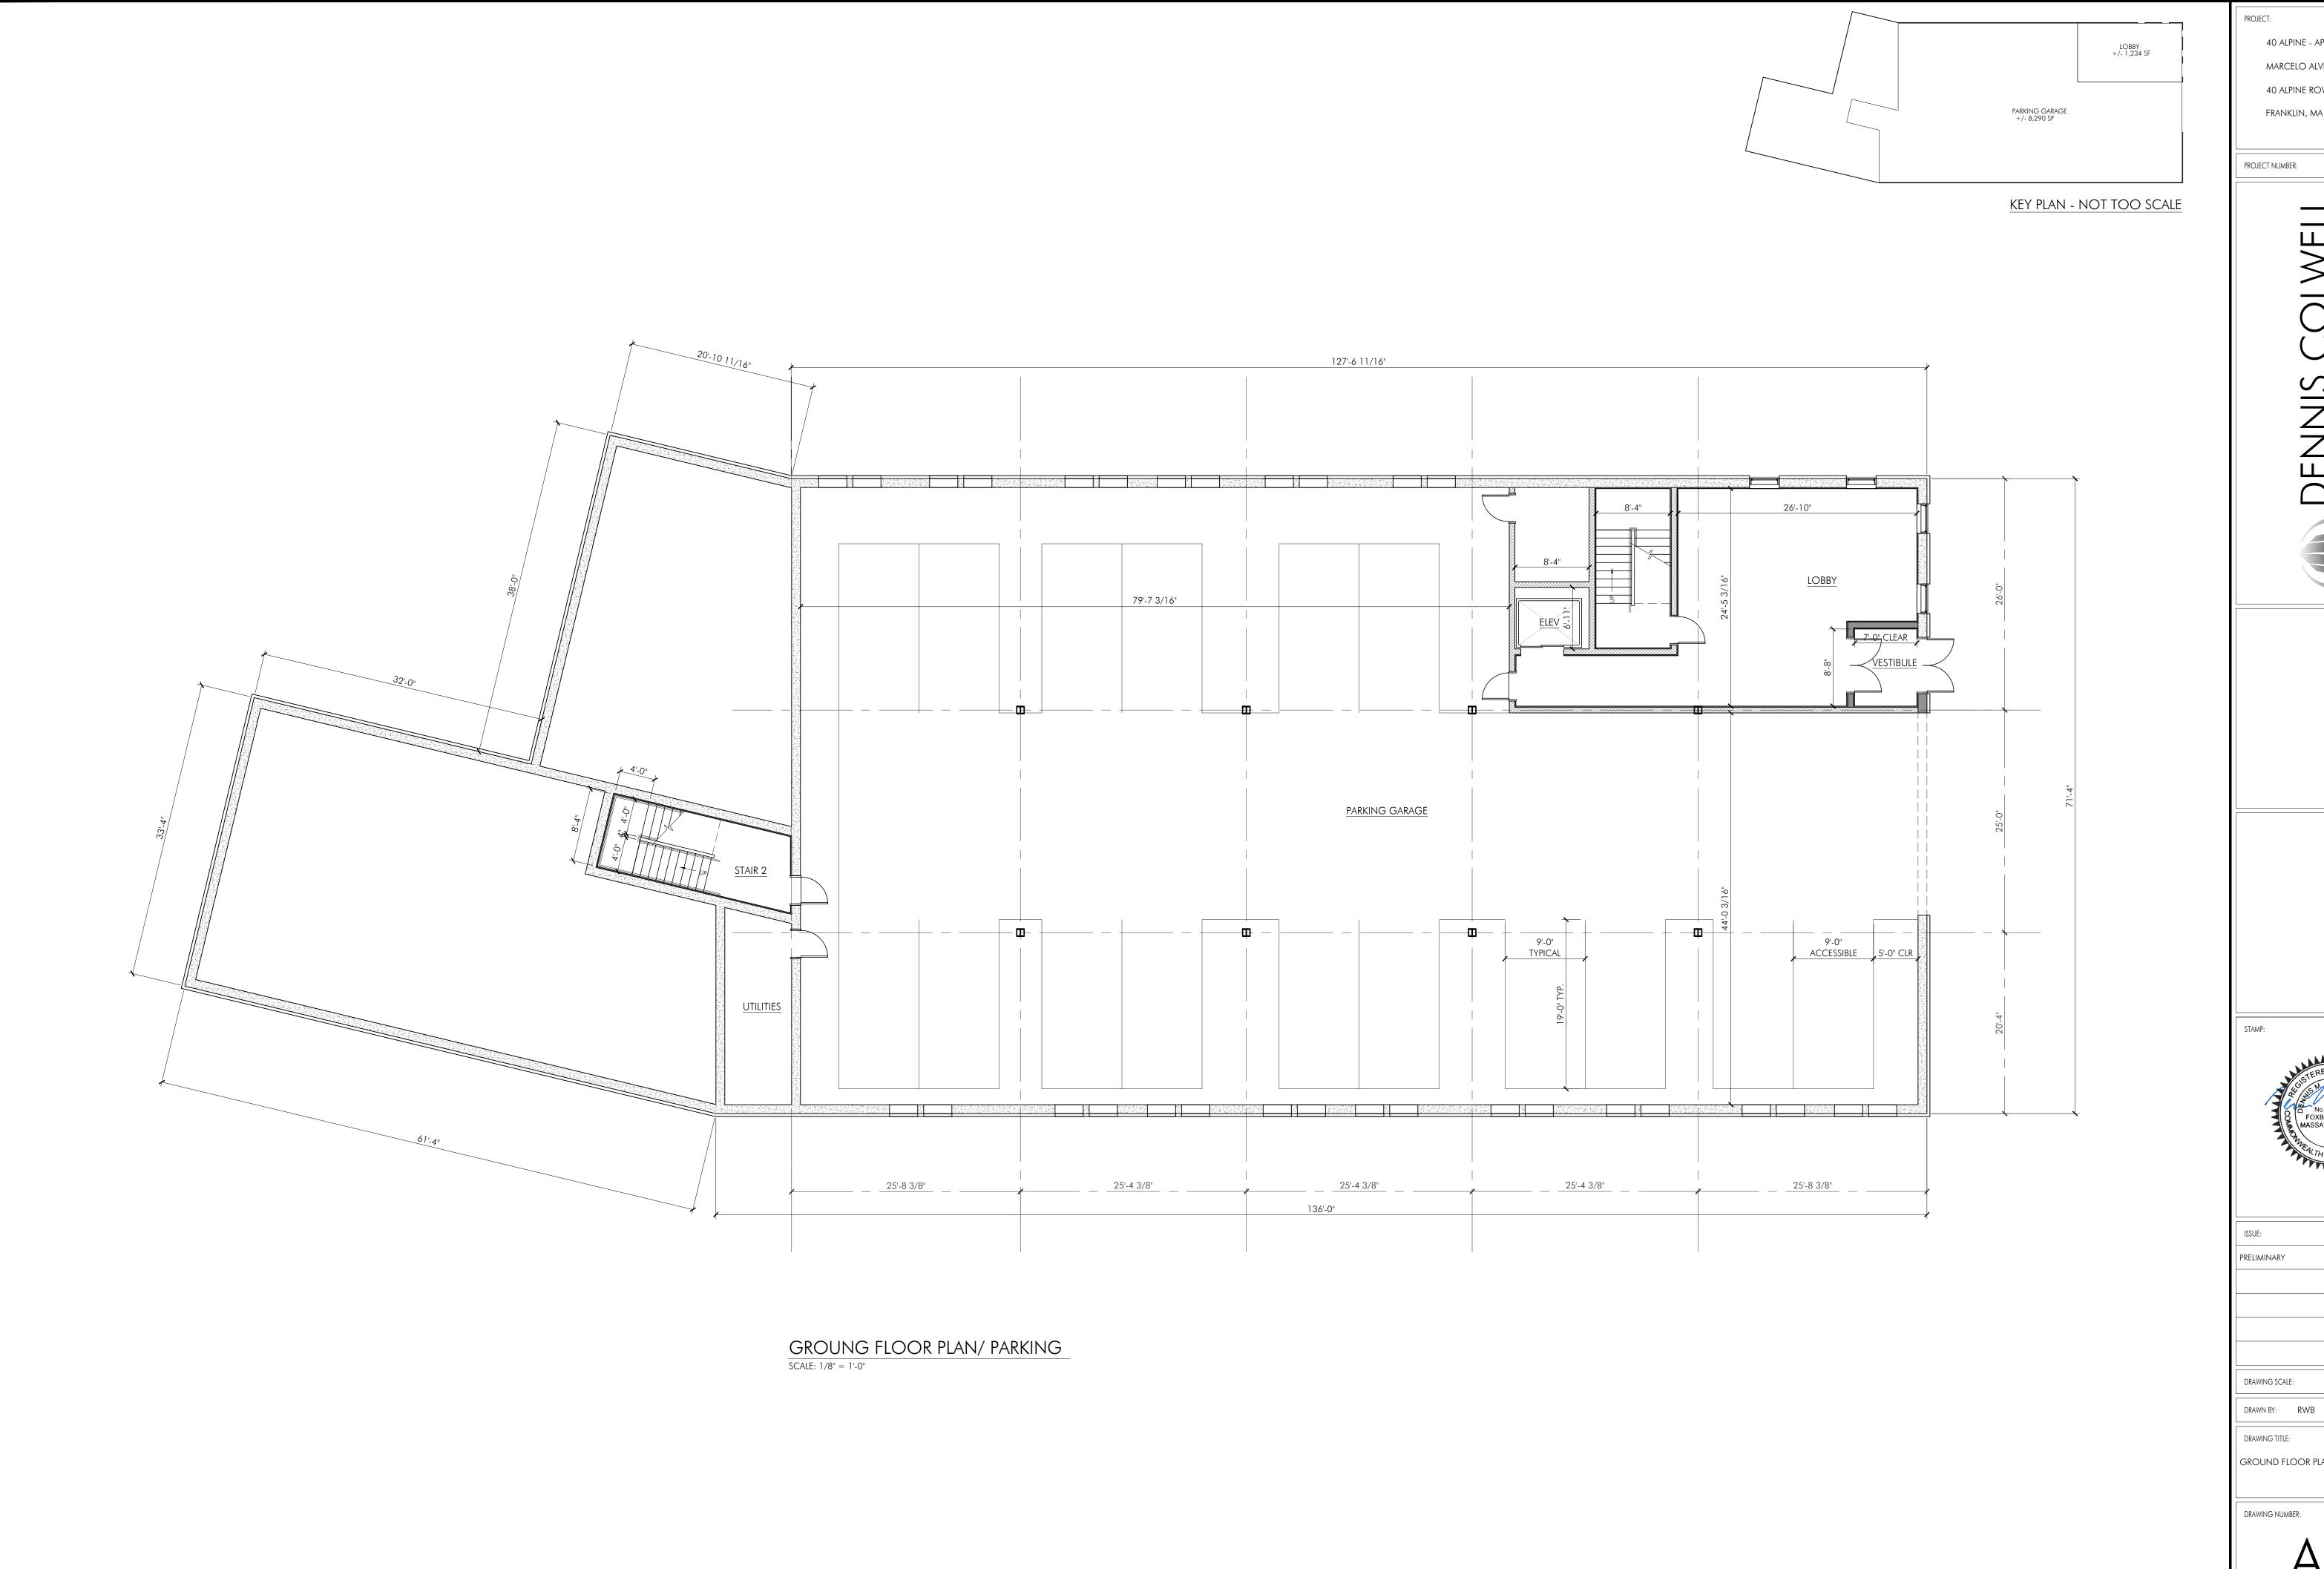

40 ALPINE - APARTMENT BUILDING MARCELO ALVES 40 ALPINE ROW FRANKLIN, MA 02038


PROJECT NUMBER: 23078






ISSUE:		DATE:
PRELIMINARY		05.05.2023
DRAWING SCALE:	1,	/8" = 1'-0"
DRAWN BY: RWB	CHECKED	BY: DMC

GROUND FLOOR PLAN - GARAGE

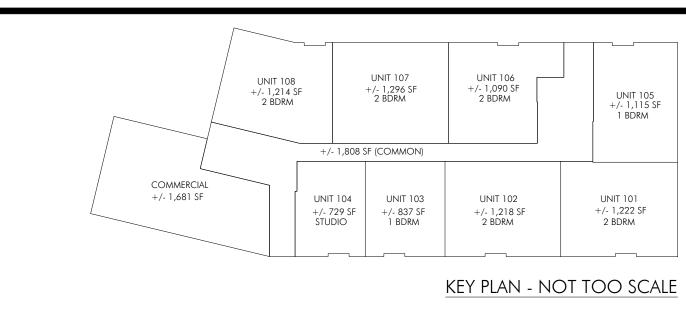

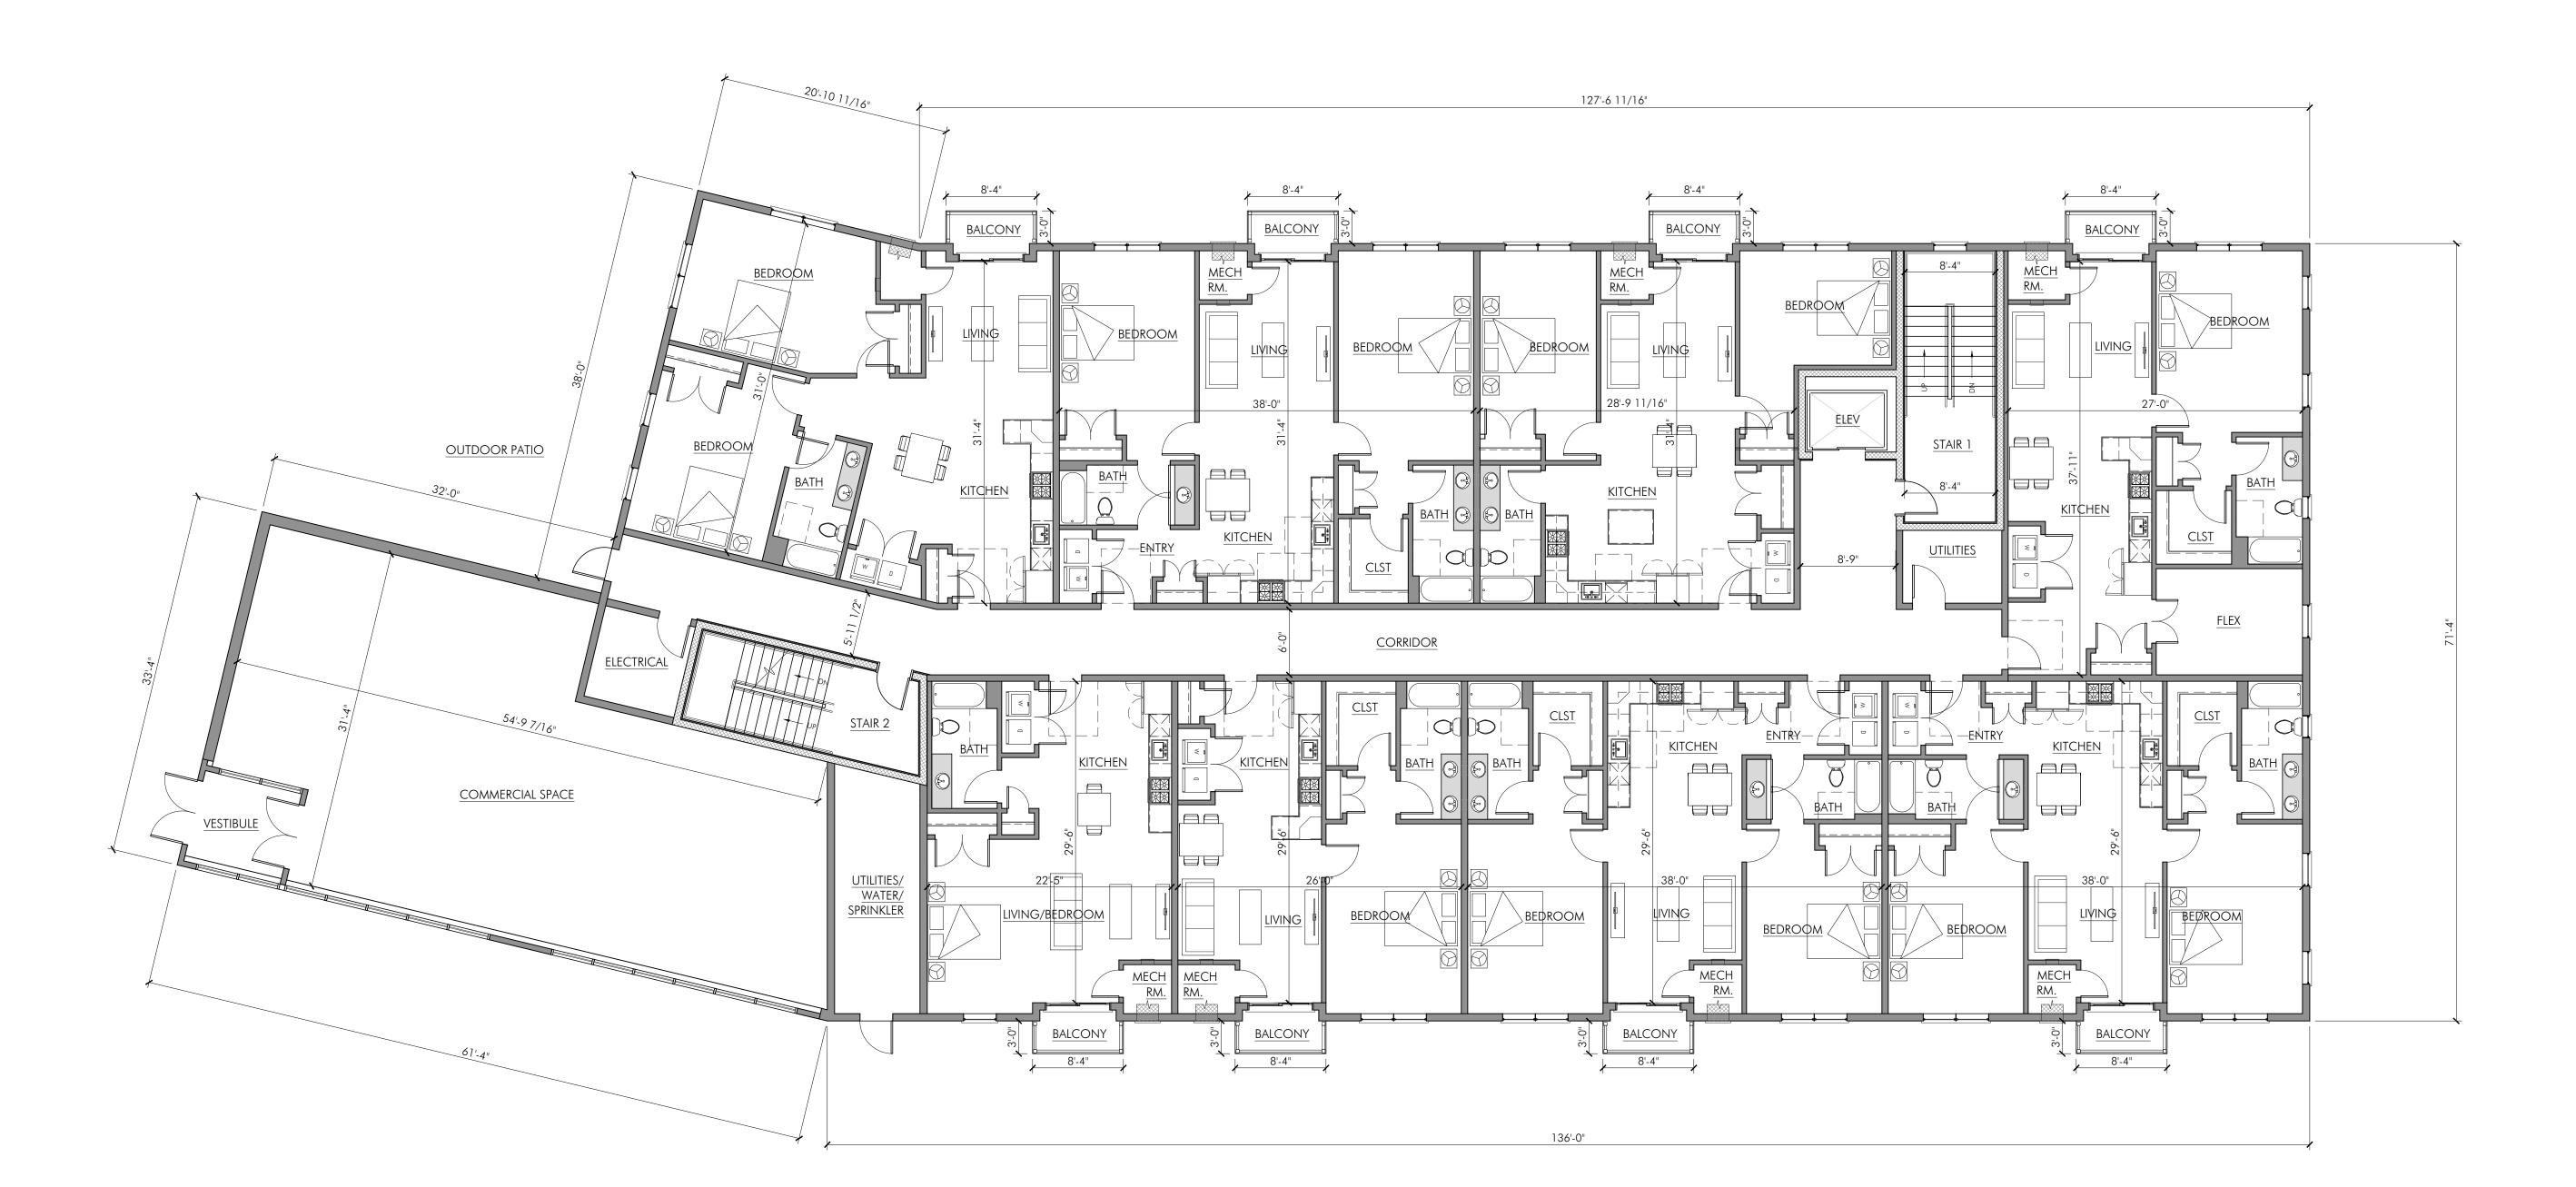

FIRST FLOOR PLAN

SCALE: 1/8" = 1'-0"

PROJECT:

40 ALPINE - APARTMENT BUILDING

MARCELO ALVES

40 ALPINE ROW

PROJECT NUMBER: 23078

FRANKLIN, MA 02038

DENNIS COLWELL

A R C H I T E C T S

132 CENTRAL STREET, SUITE 203, FOXBOROUGH, MA 02035
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STAMP:

STERED ARCHITICAL NO. 50216 POXBOROUGH
MASSACHUSETTS


MASS

ISSUE:	DATE:
PRELIMINARY	05.05.2023
DRAWING SCALE:	1/8" = 1'-0"
DRAWN BY: RWB	CHECKED BY: DMC

DRAWING TITLE:
FIRST FLOOR PLAN

DRAWING NUMBER:

A1.1

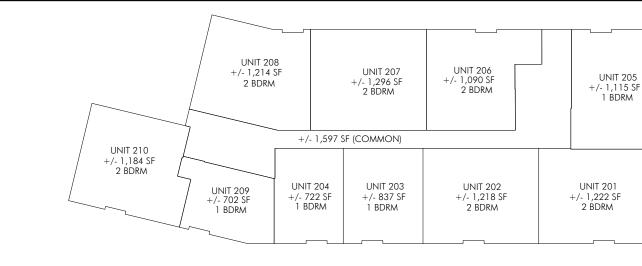

KEY PLAN - NOT TOO SCALE



2ND FLOOR PLAN

SCALE: 1/8" = 1'-0"

PROJECT:

40 ALPINE - APARTMENT BUILDING

MARCELO ALVES

40 ALPINE ROW

FRANKLIN, MA 02038

PROJECT NUMBER: 23078

DENNIS COLWELL

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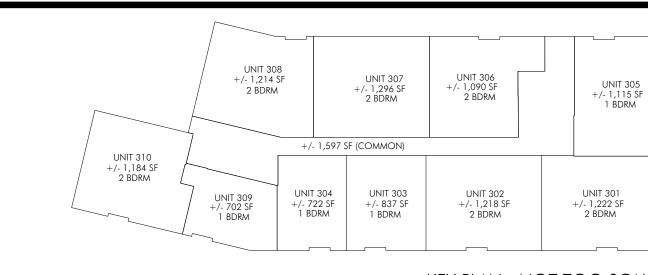


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PRELIMINARY	05.05.2023			
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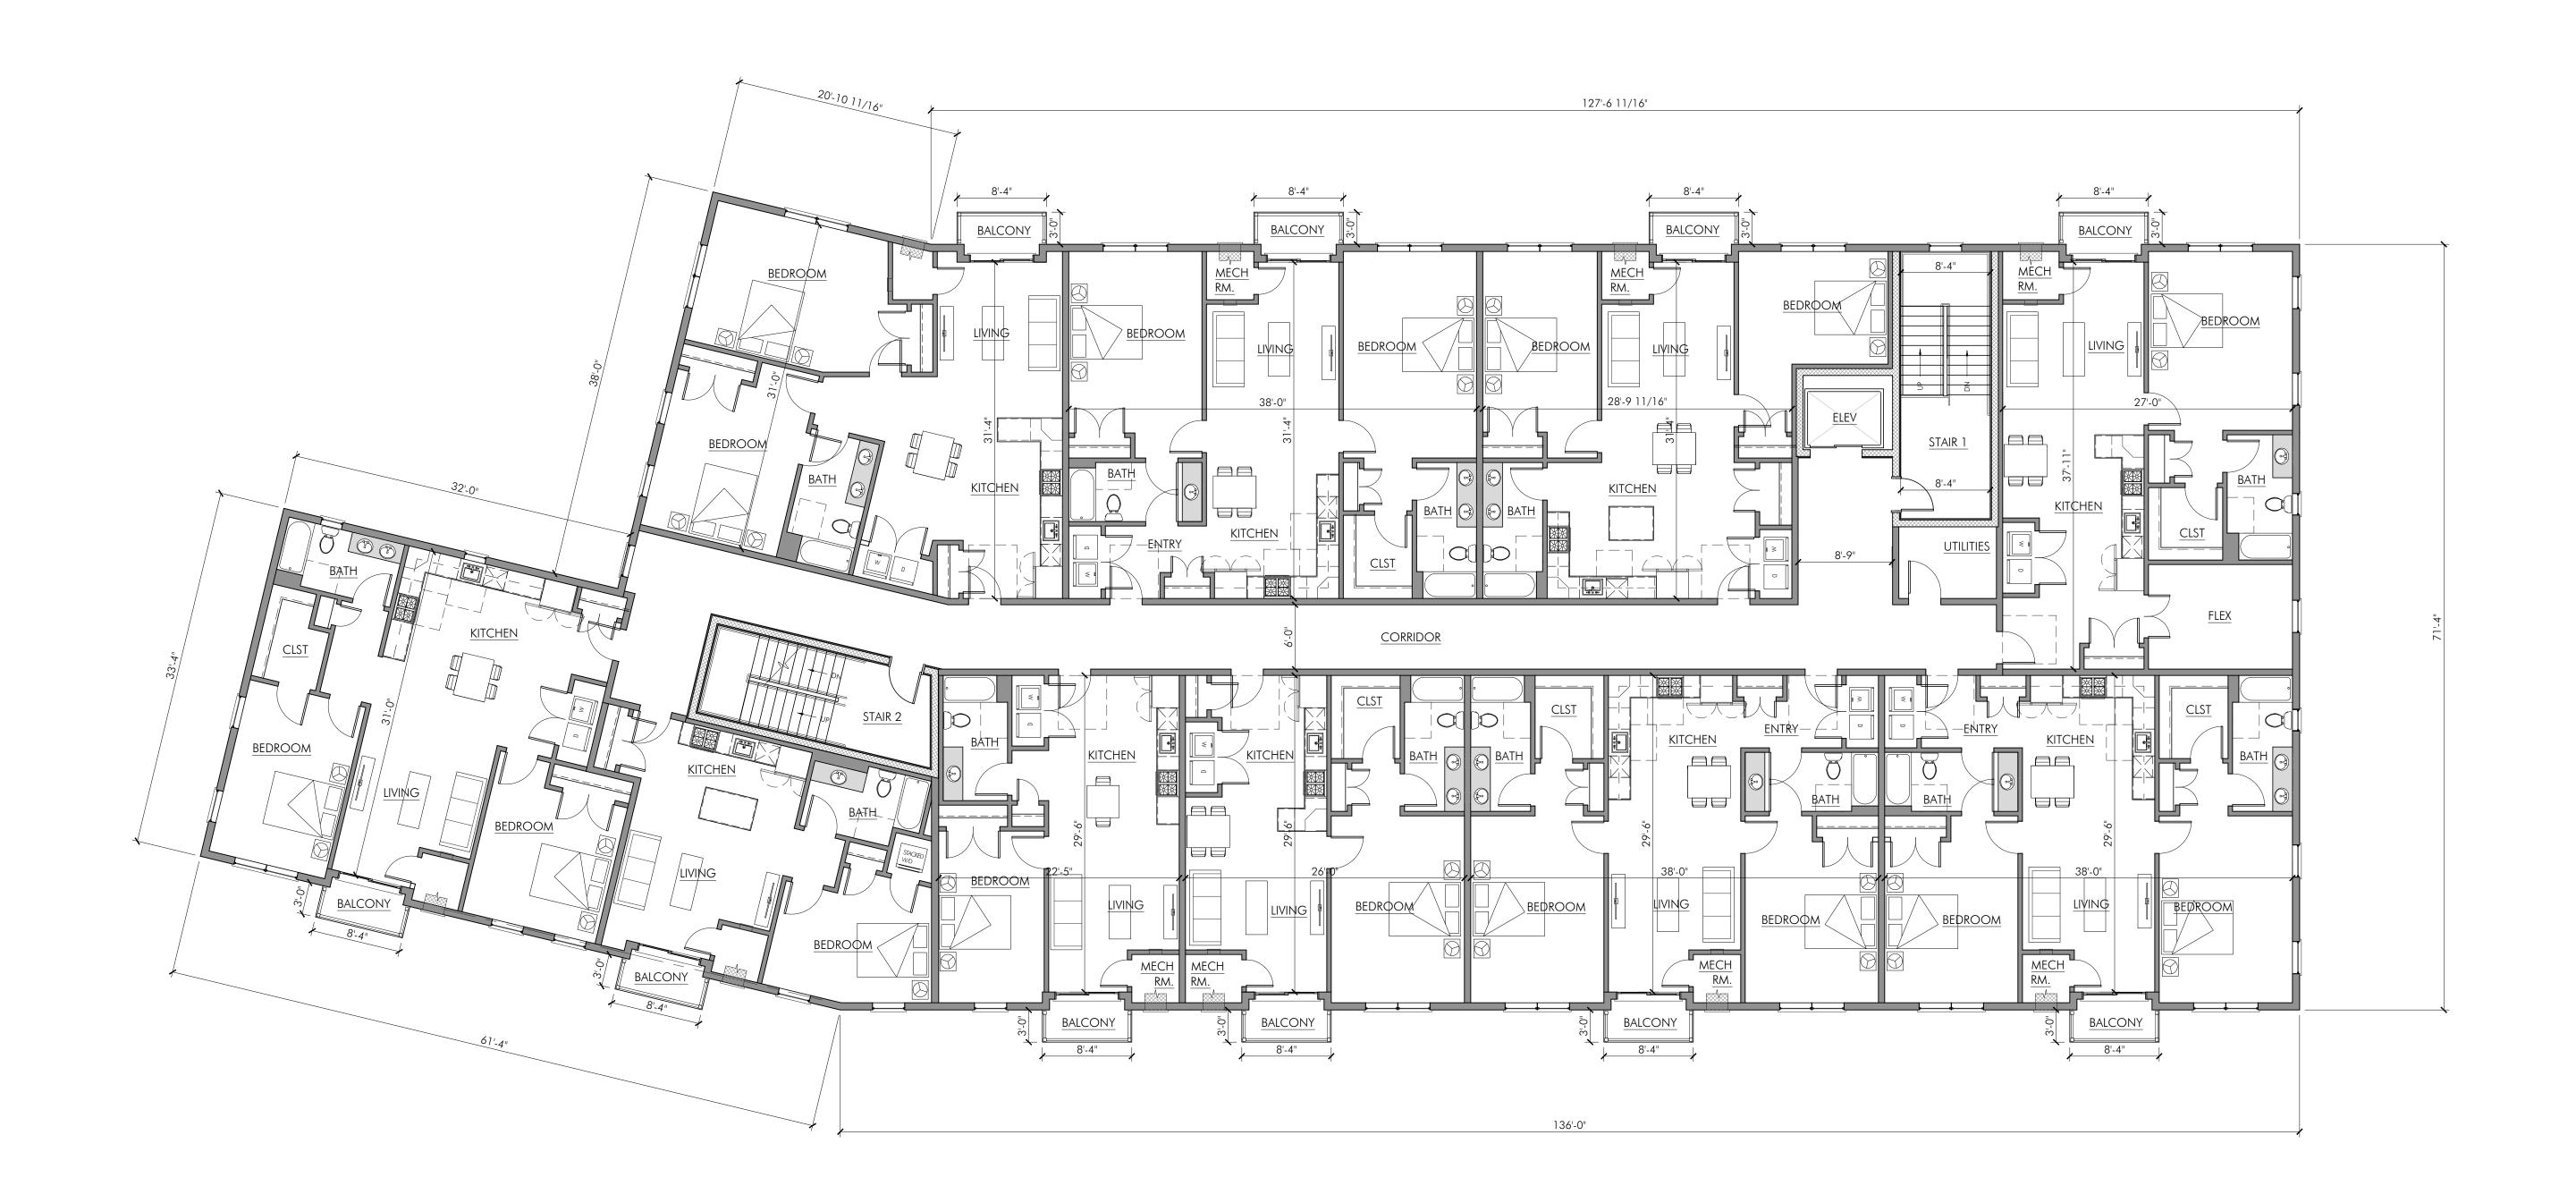
DRAWING TITLE:
SECOND FLOOR PLAN

DRAWING NUMBER:

A1.2



KEY PLAN - NOT TOO SCALE



3RD FLOOR PLAN

SCALE: 1/8" = 1'-0"

PROJECT:

40 ALPINE - APARTMENT BUILDING

MARCELO ALVES

40 ALPINE ROW

FRANKLIN, MA 02038

PROJECT NUMBER: 23078

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DRAWN BY: RWB	CHECKED	BY: DMC				
DRAWING TITLE:						

THIRD FLOOR PLAN

DRAWING NUMBER:

A1.3







SOUTHWEST

SCALE: 1/8" = 1'-0"

40 ALPINE - APARTMENT BUILDING MARCELO ALVES **40 ALPINE ROW** FRANKLIN, MA 02038 PROJECT NUMBER: 23078 STAMP: DATE: PRELIMINARY 05.05.2023 1/8" = 1'-0" DRAWING SCALE: DRAWN BY: RWB CHECKED BY: DMC DRAWING TITLE: BUILDING ELEVATIONS DRAWING NUMBER:








New Generation Custom Homes

Office Renovation


40 Alpine Row


Franklin, MA 02038

ARCHITECT
DENNIS COLWELL ARCHITECTS, INC.
BOB BOYNTON
EMAIL: BOB@DC-ARCHITECT.COM
PHONE: 508-241-2122 X 104
ADDRESS: 132 CENTRAL STREET, SUITE 203
FOXBOROUGH, MA 02035

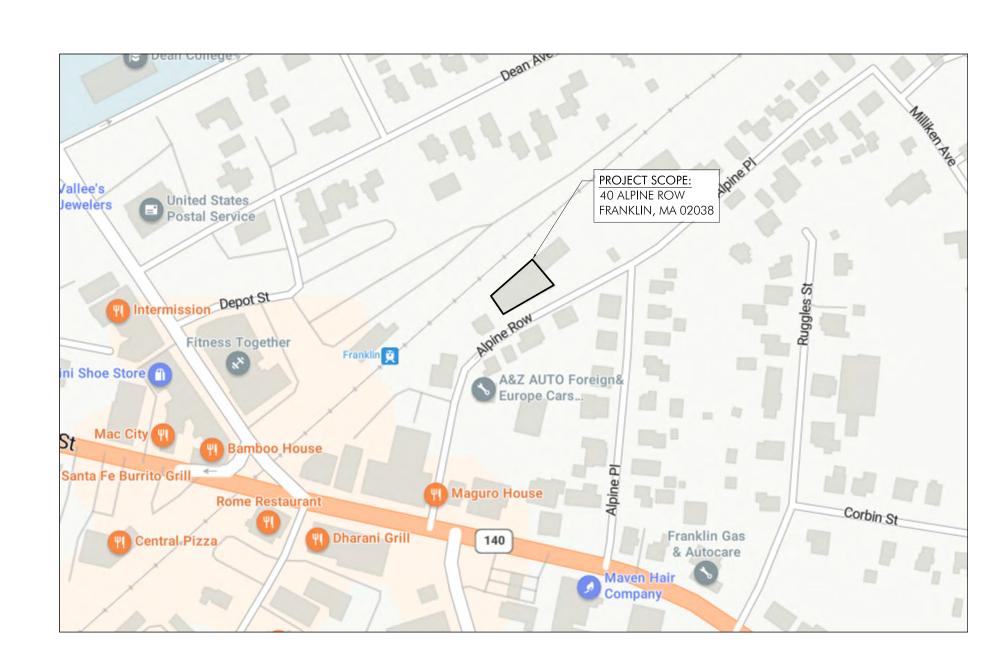

SITE LOCATION

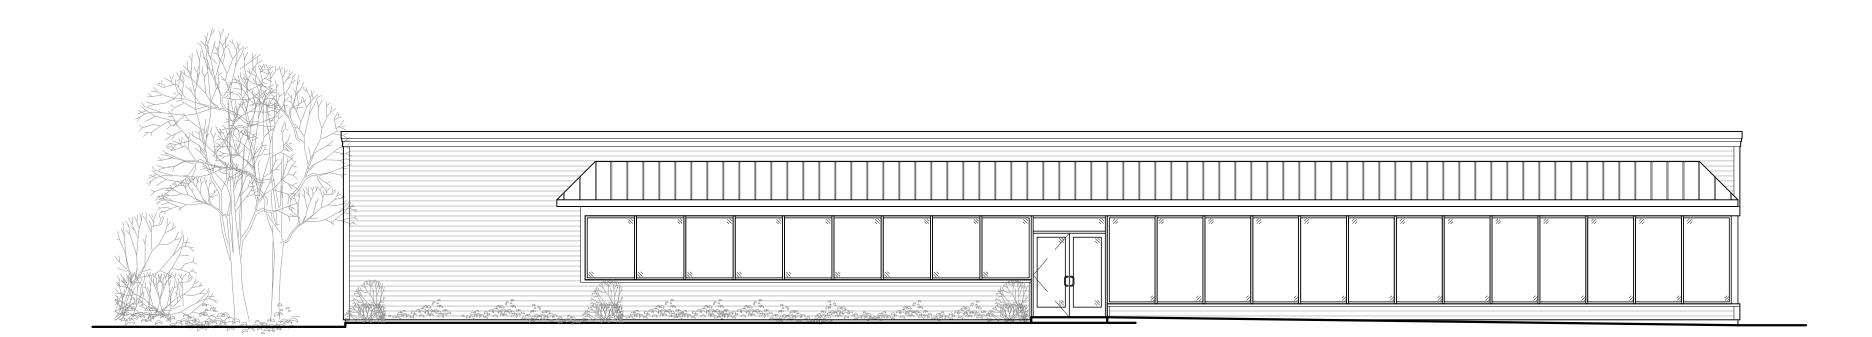


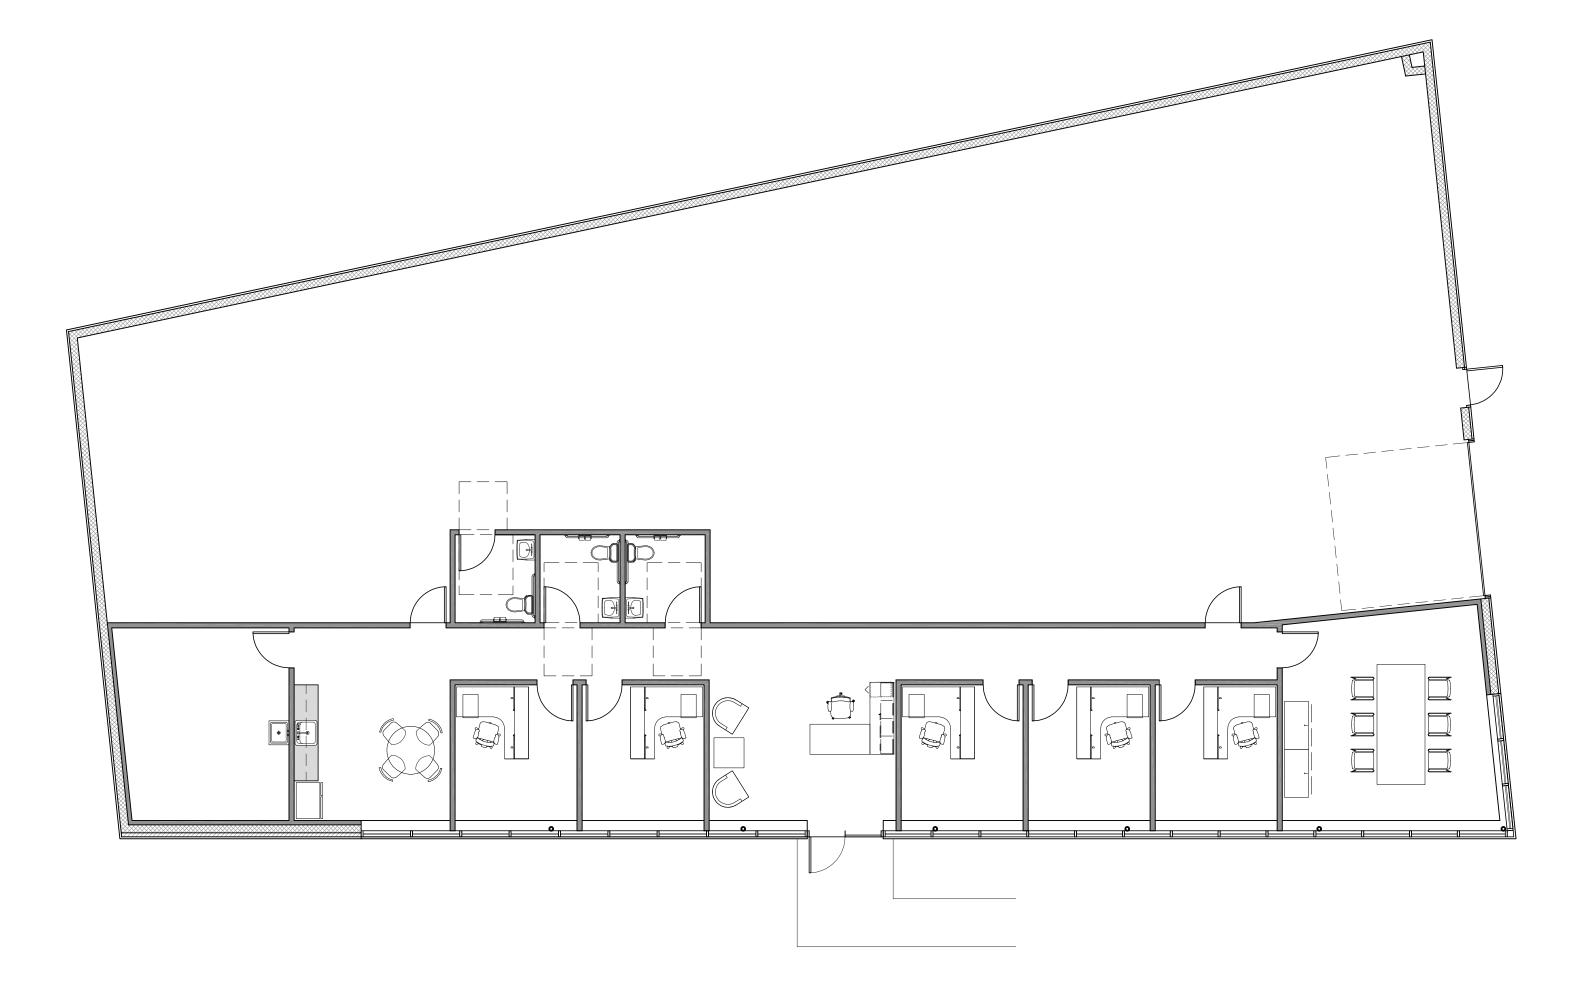






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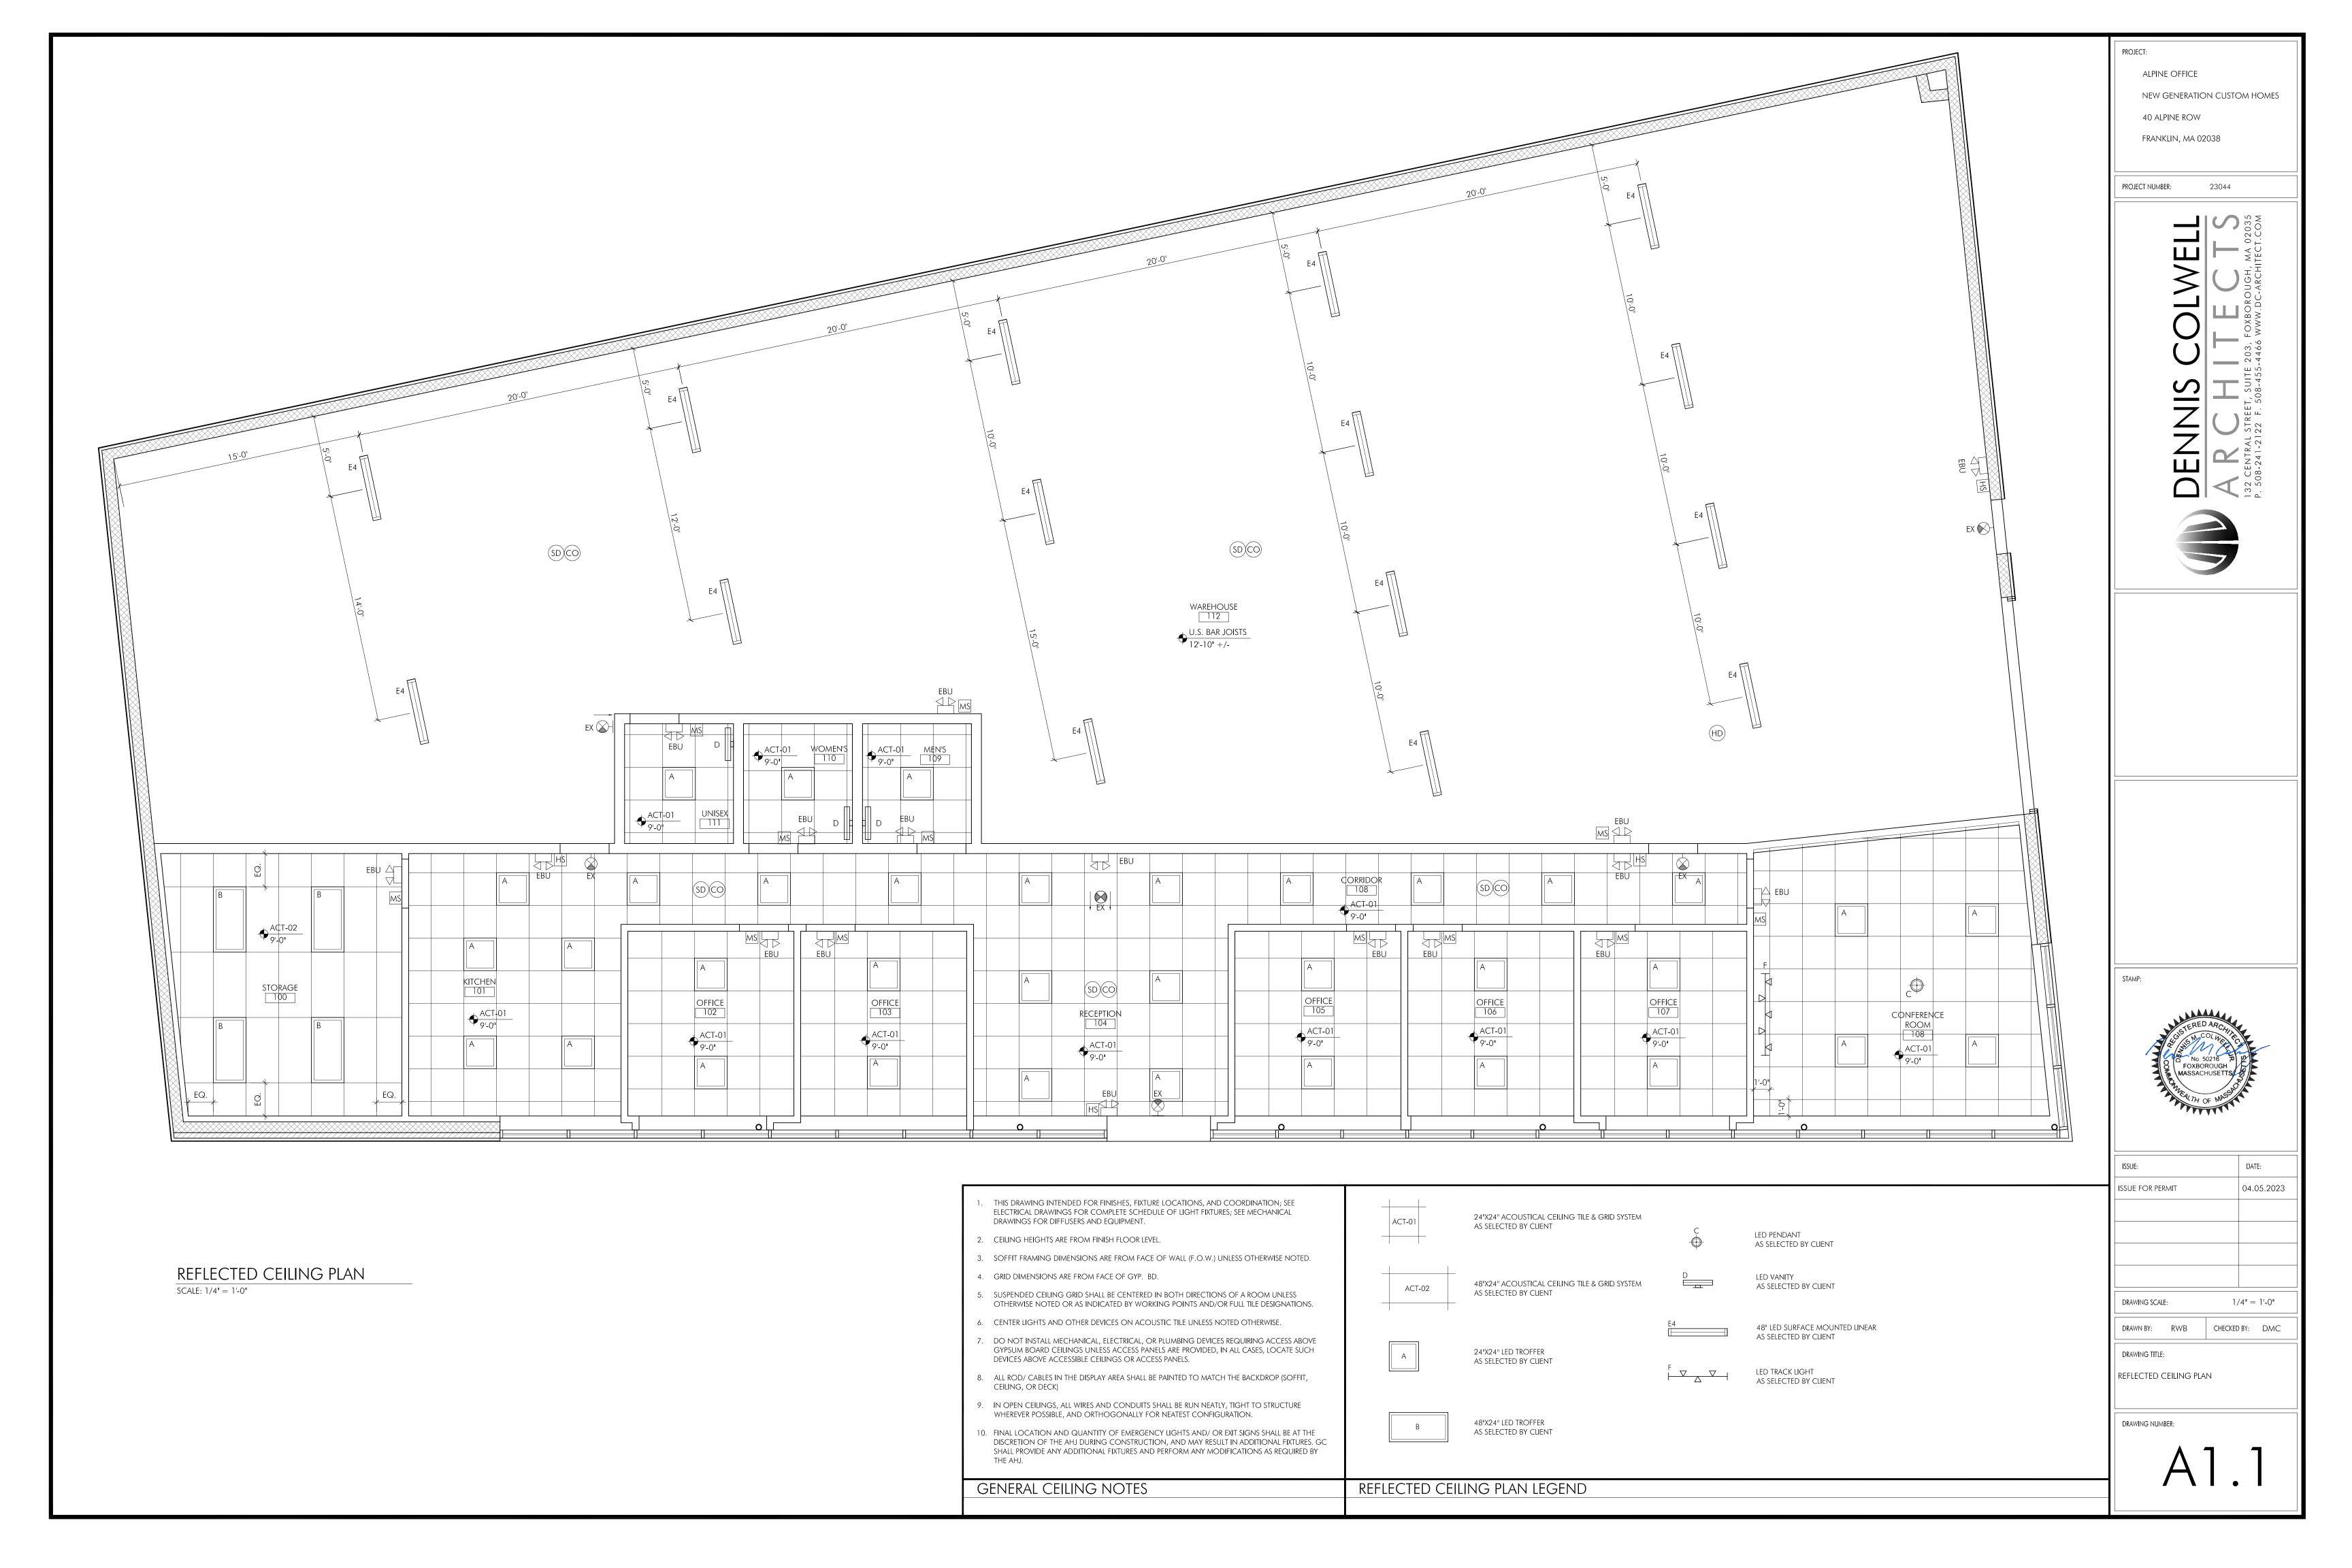





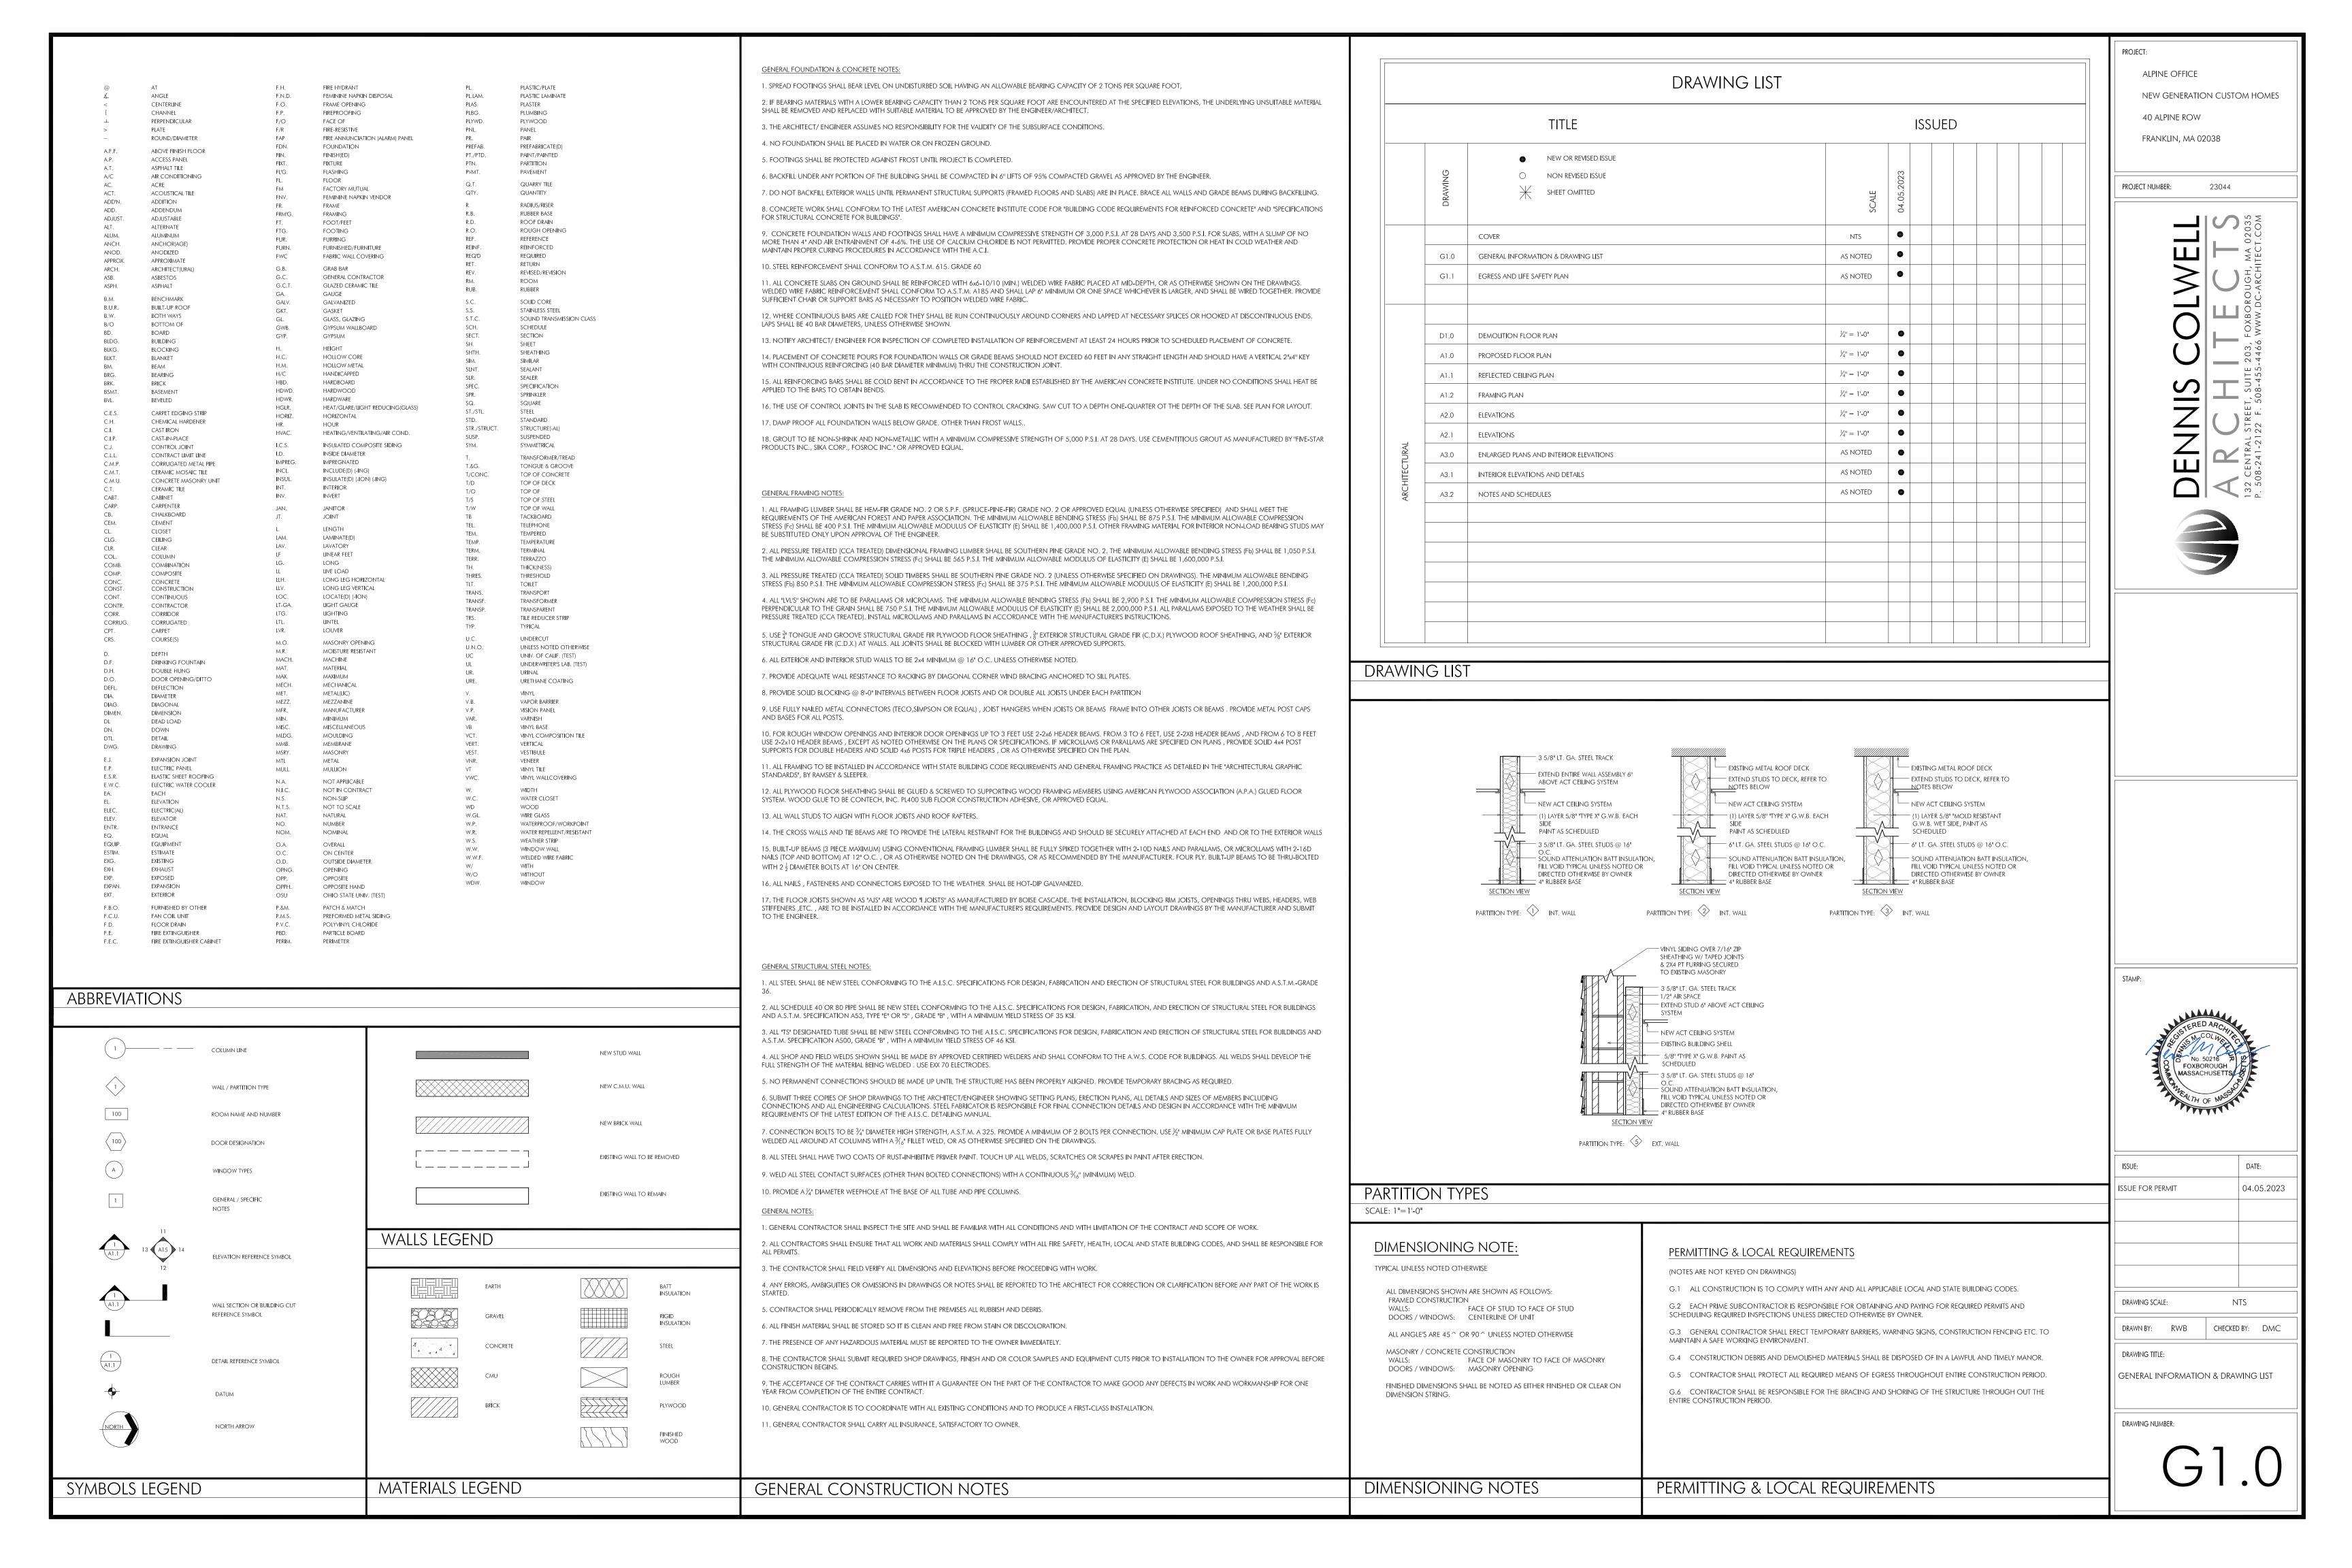


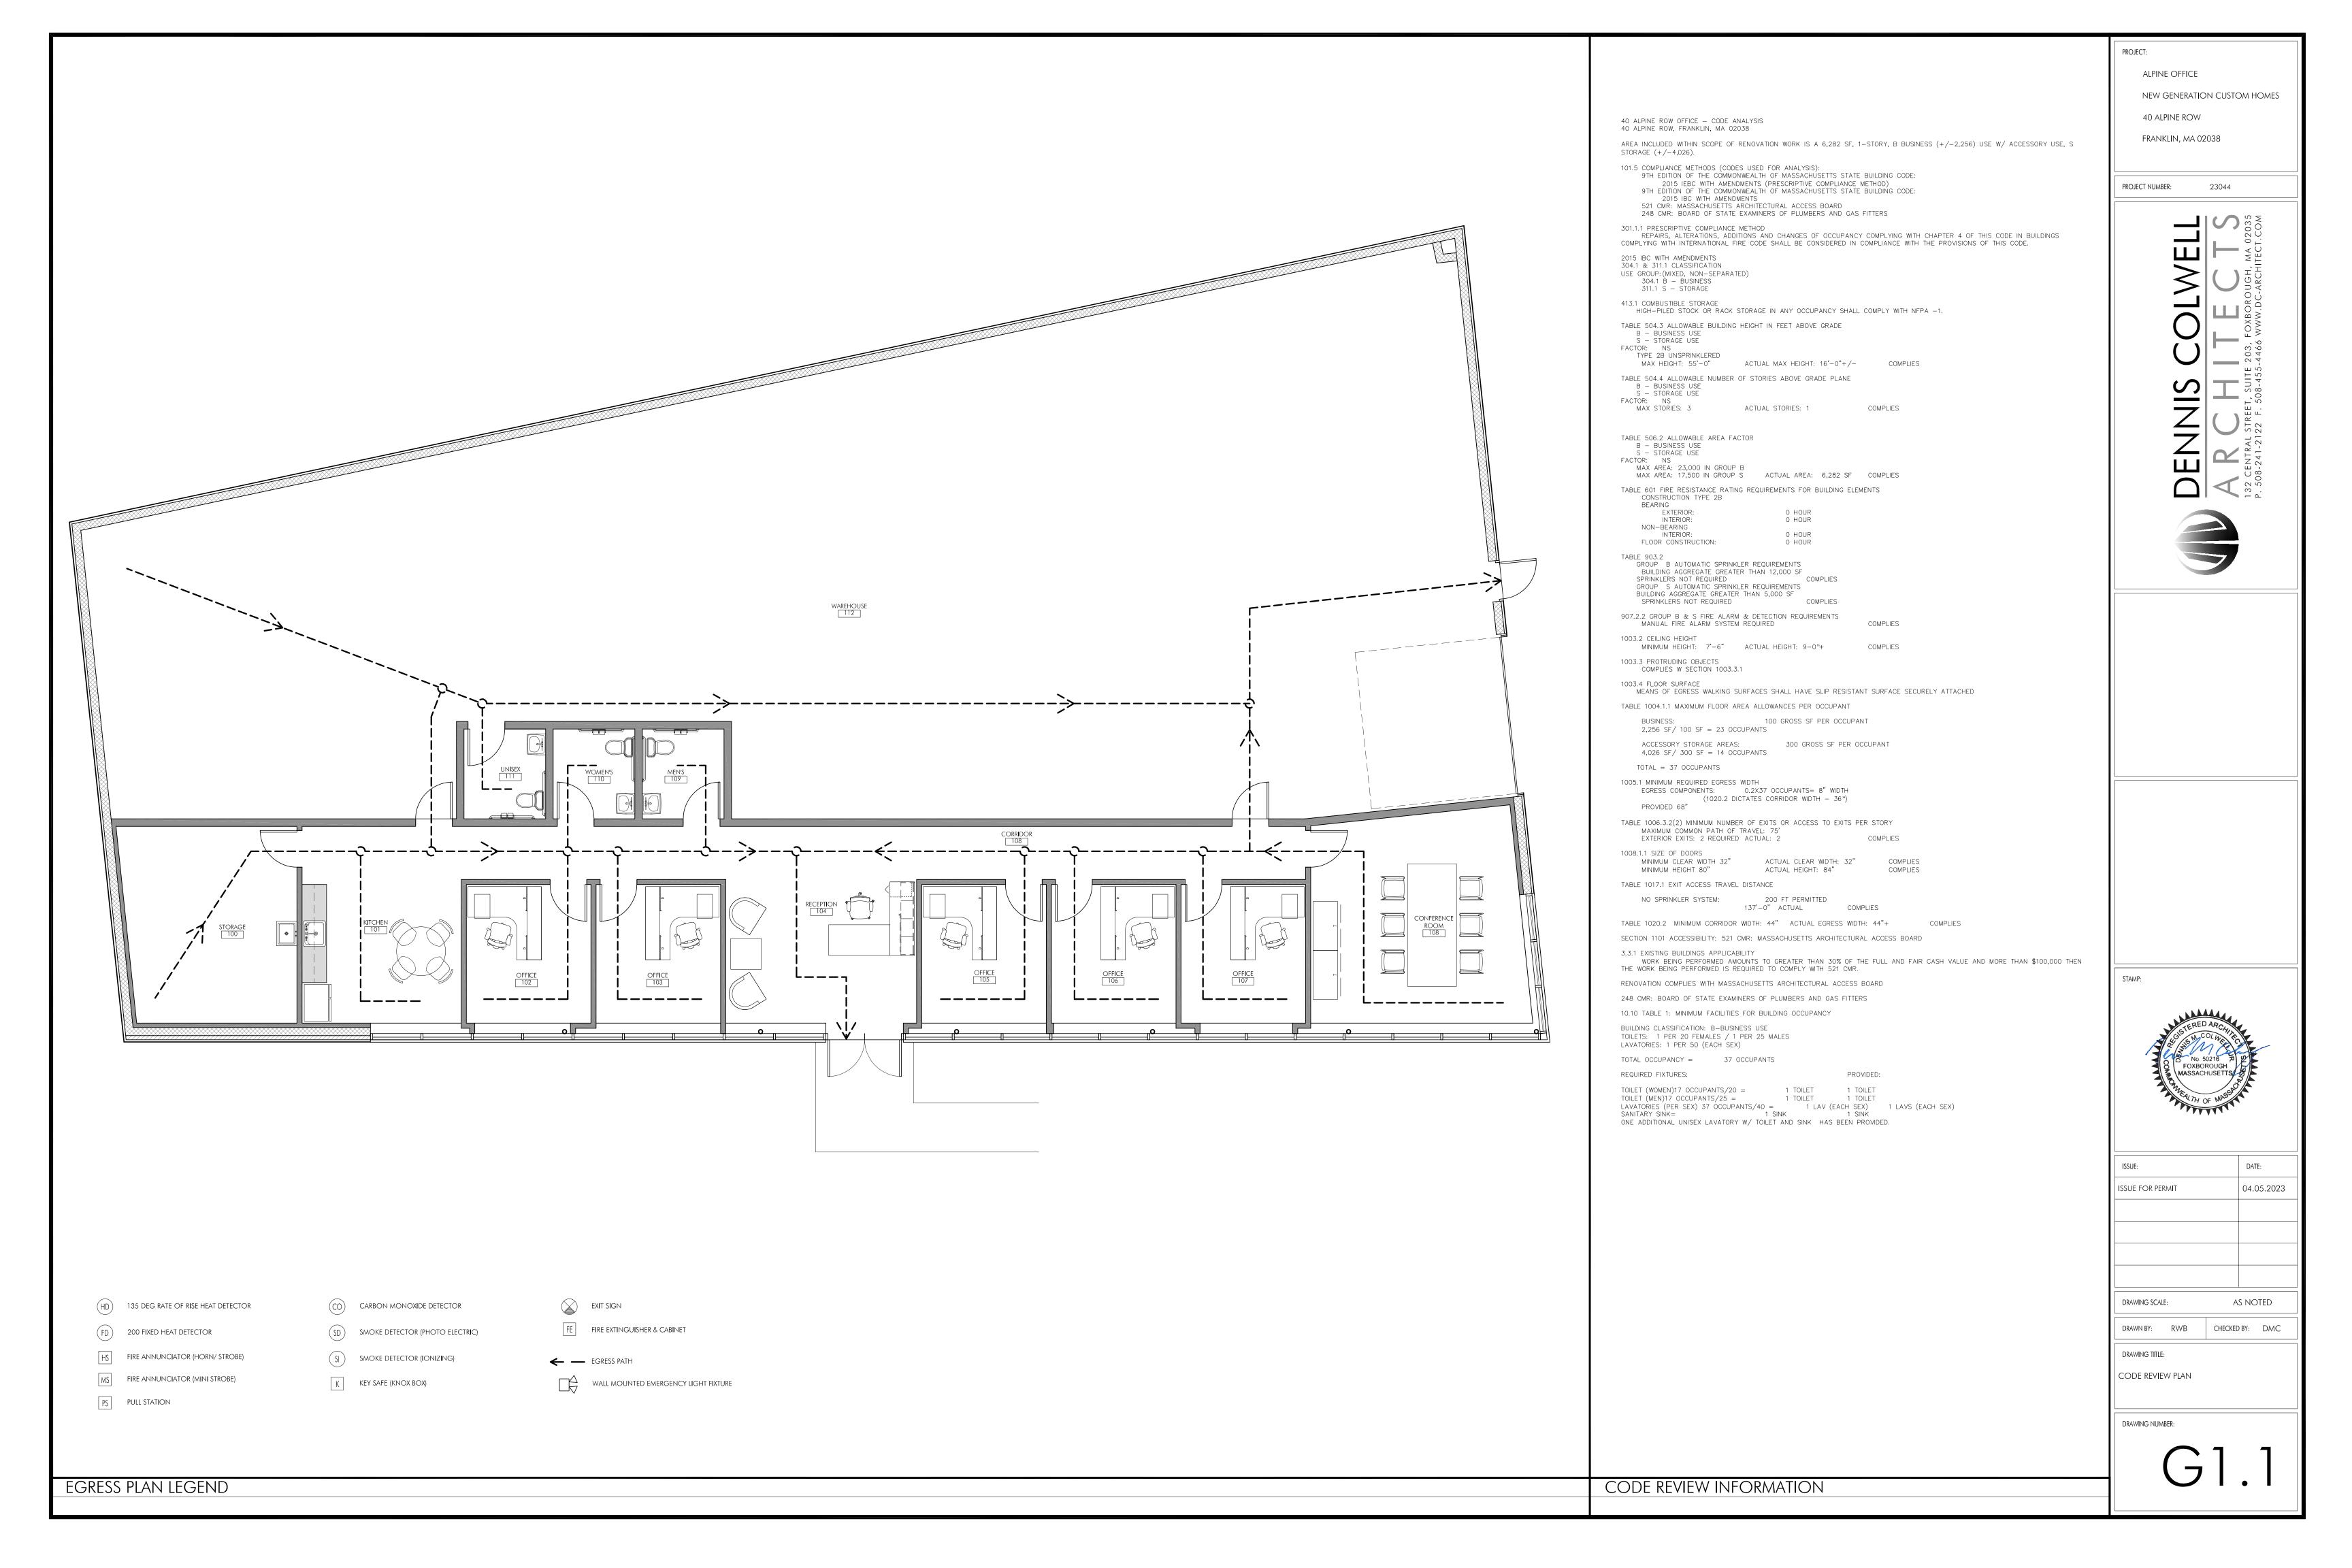


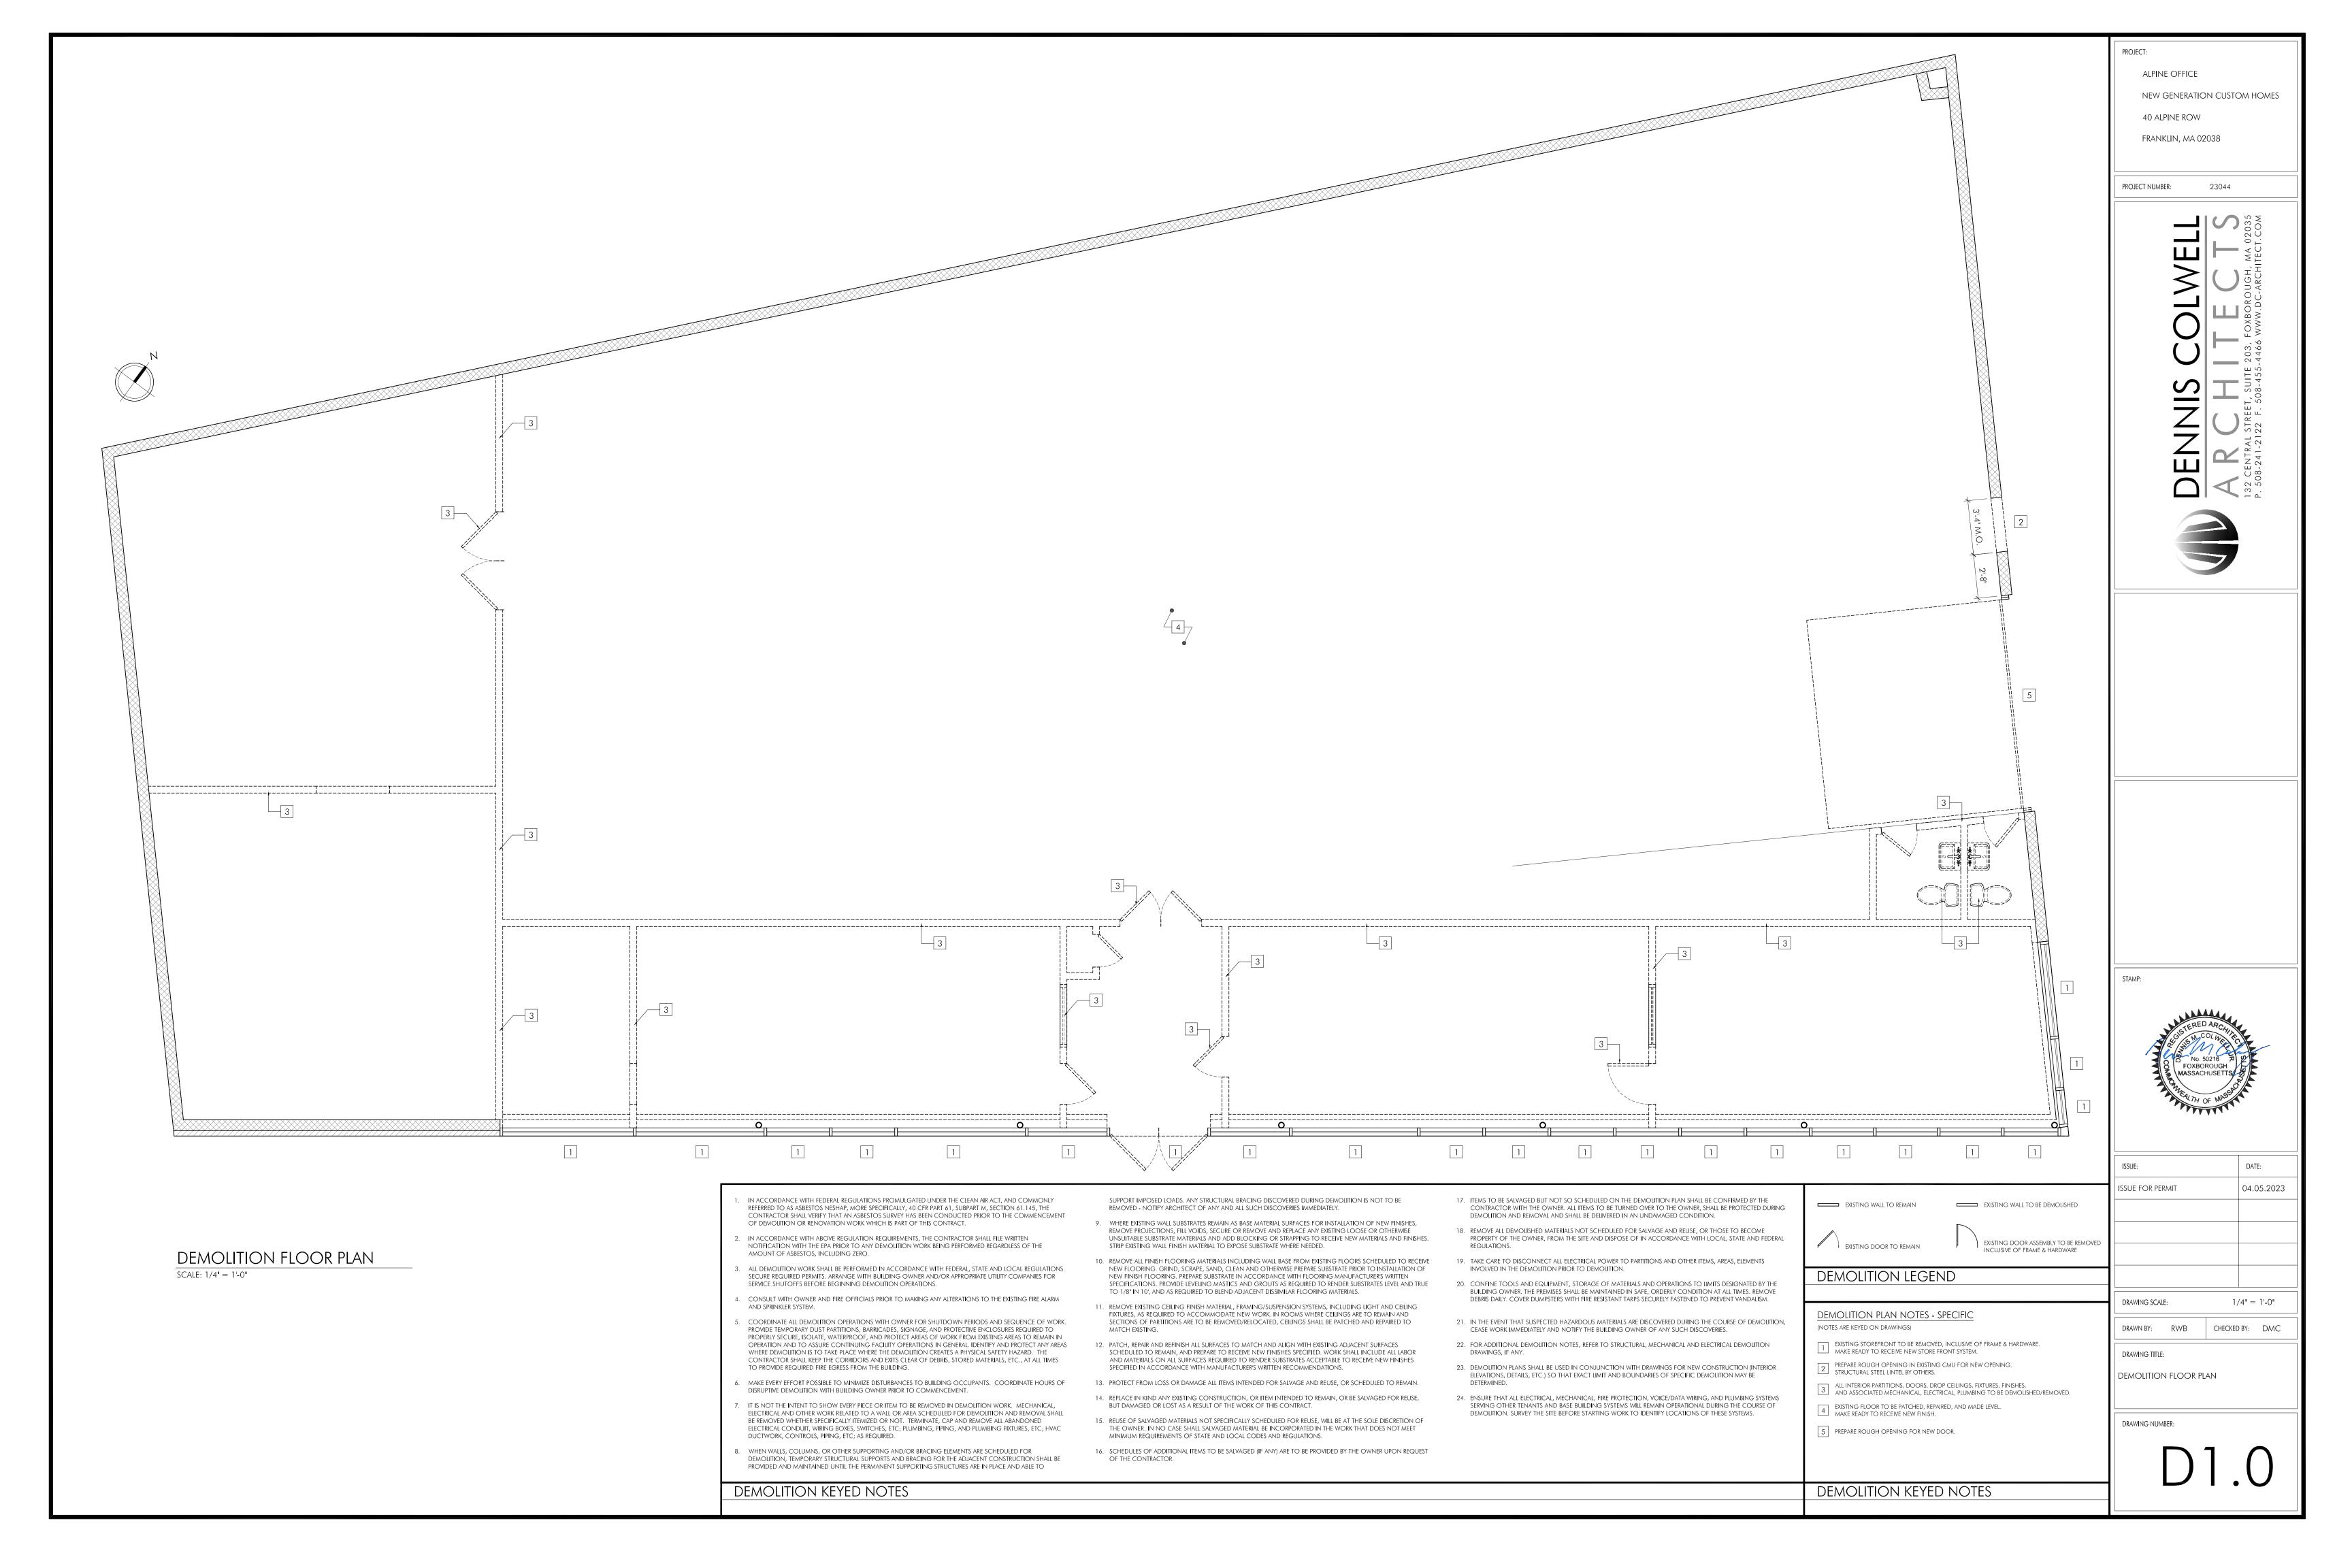


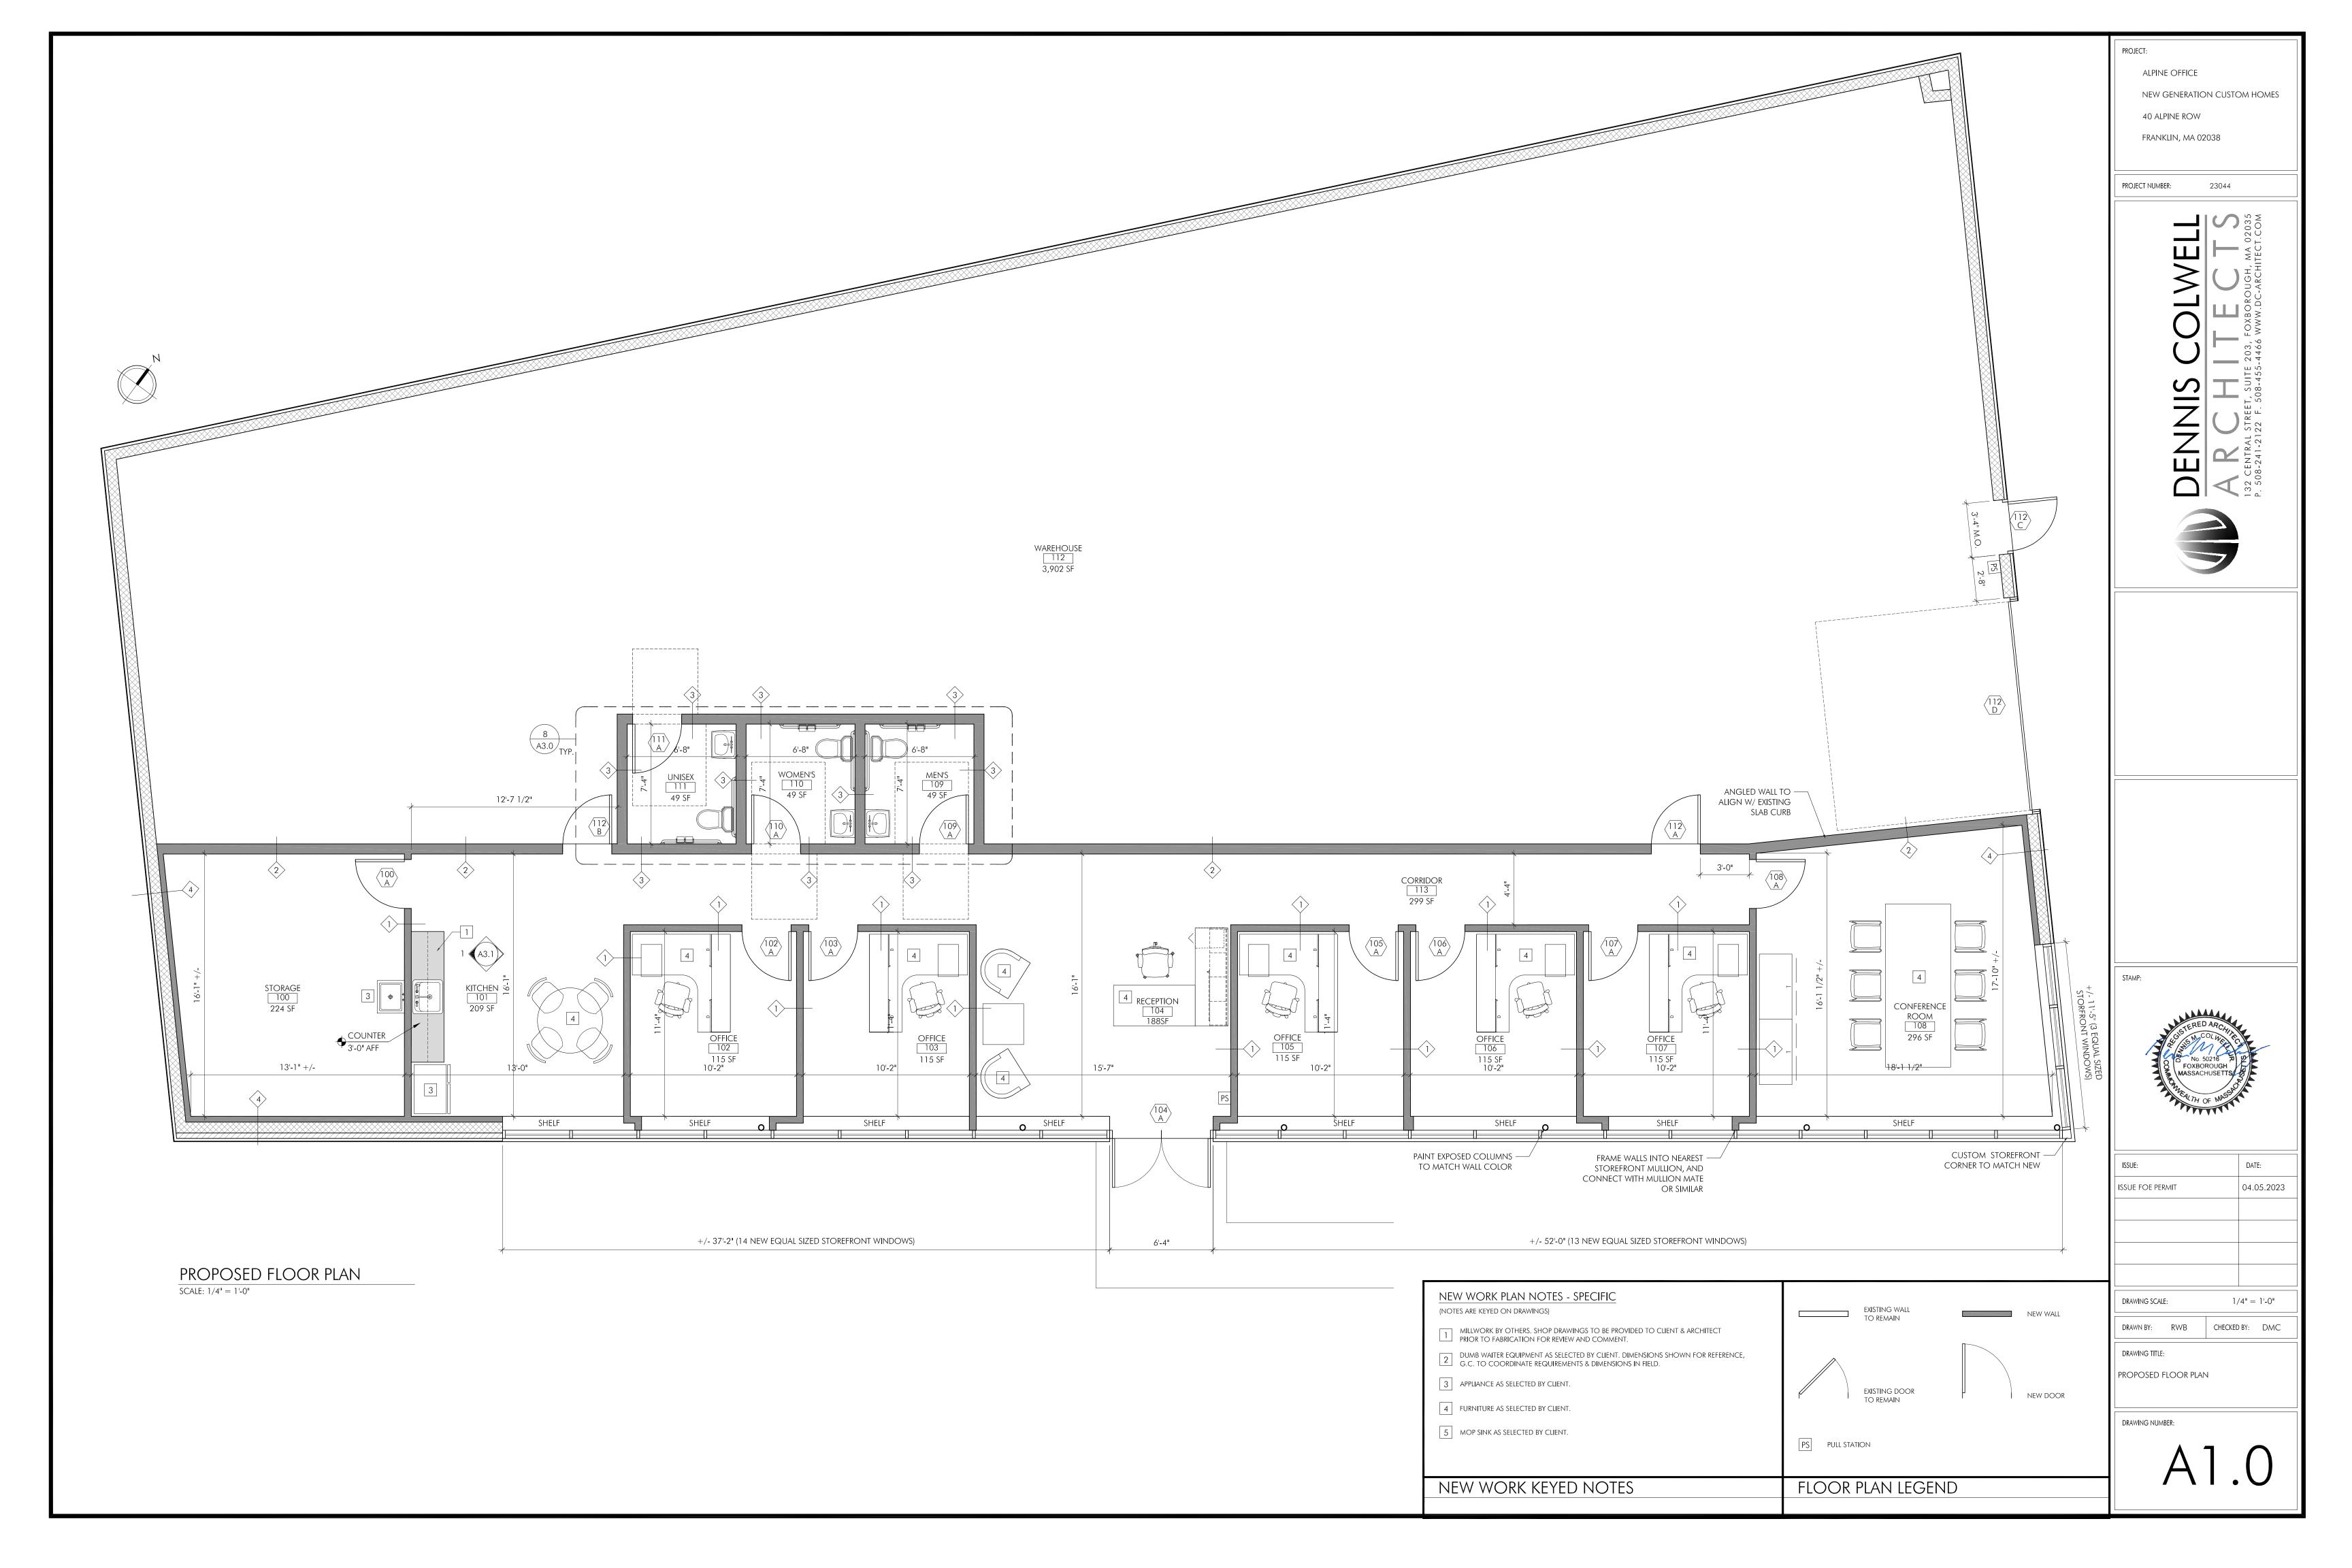

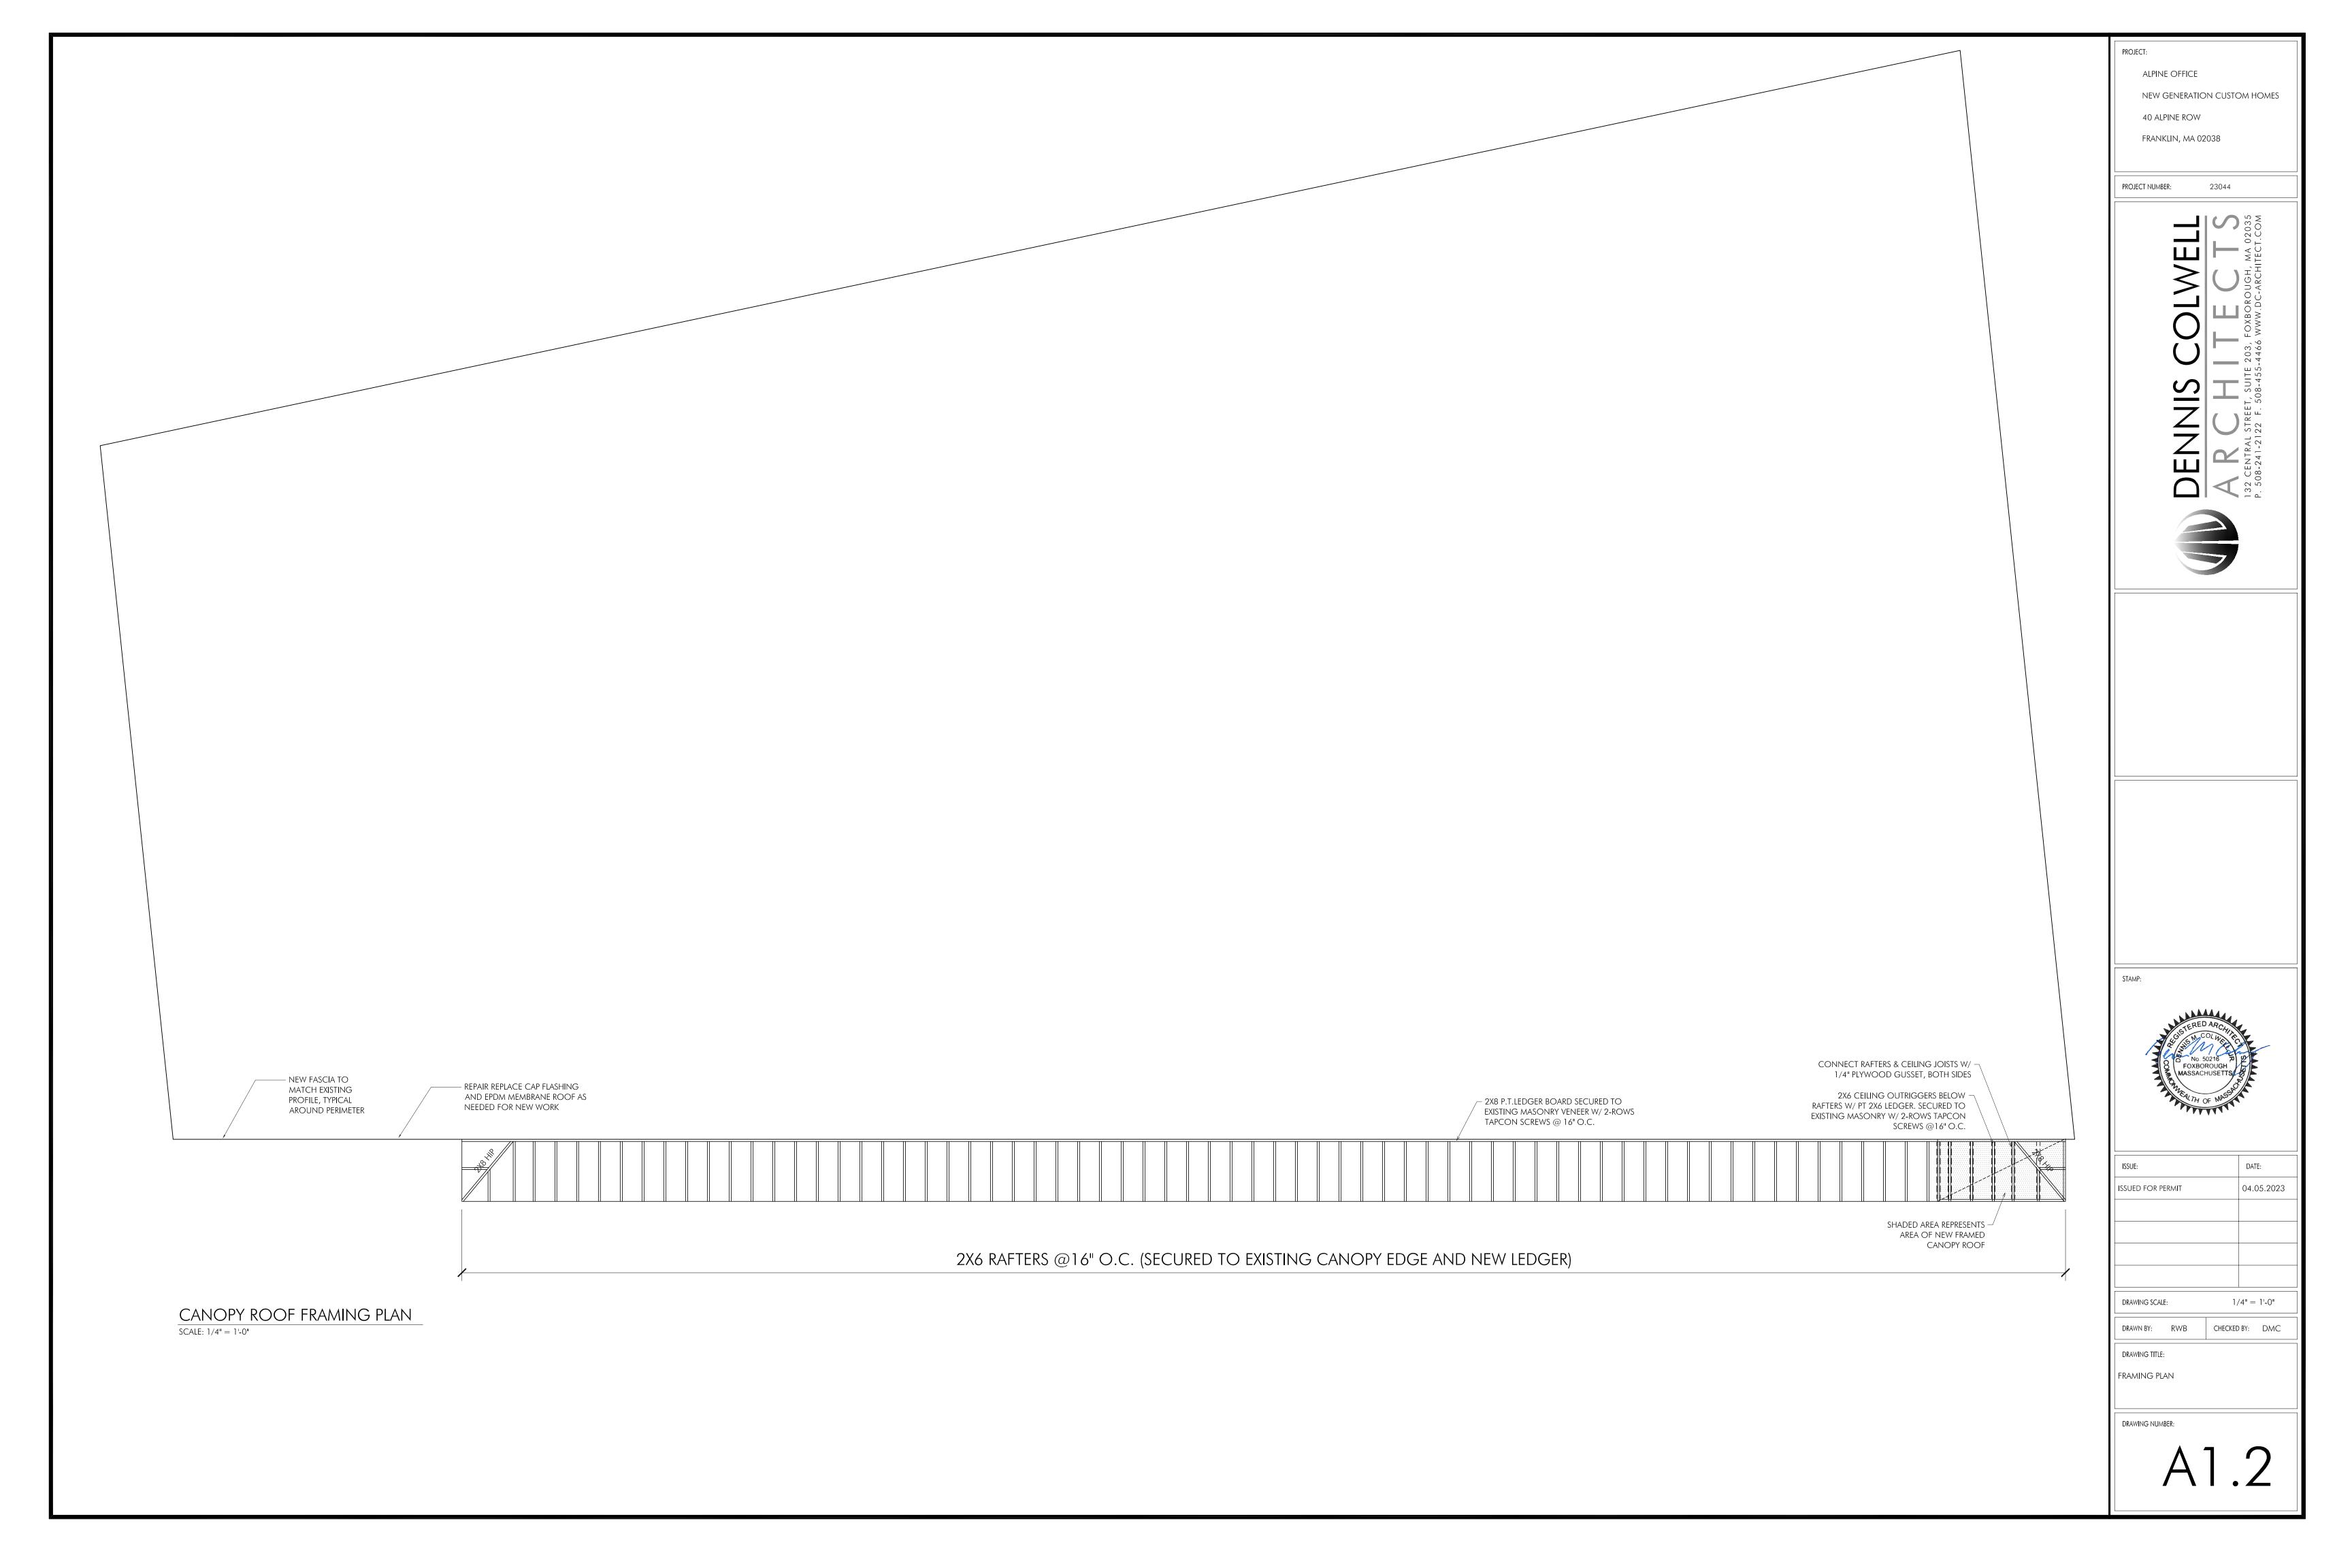

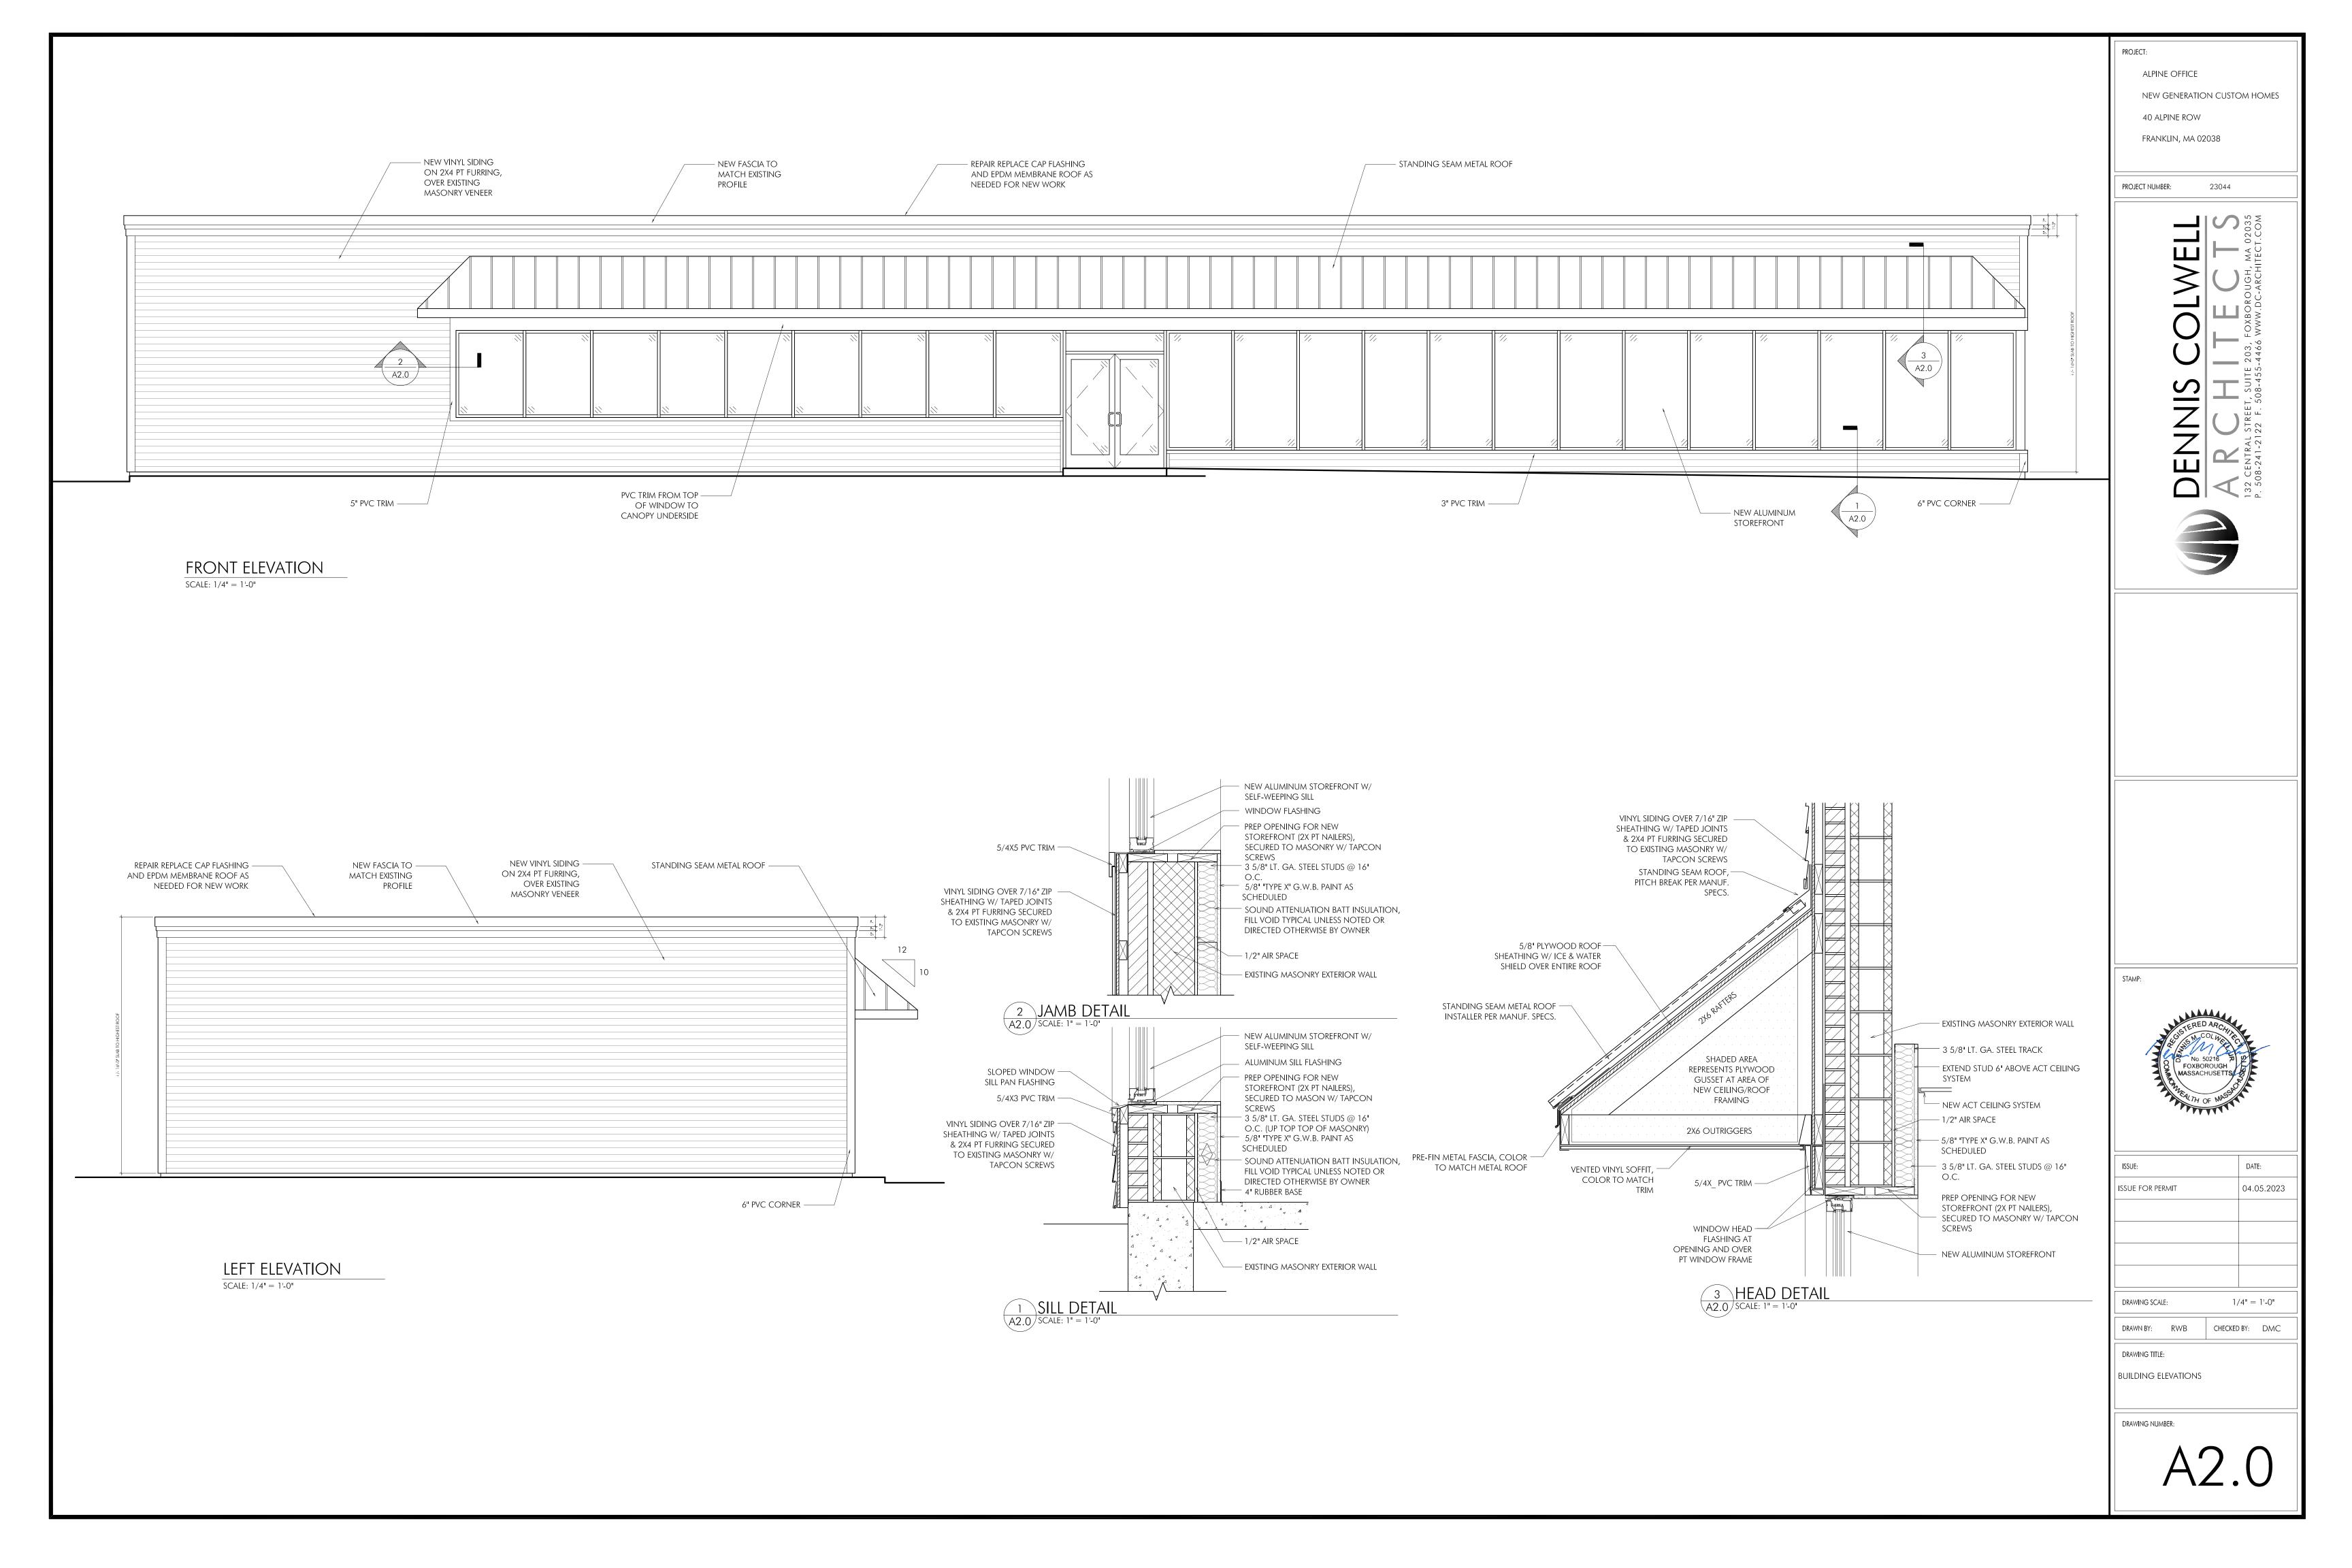

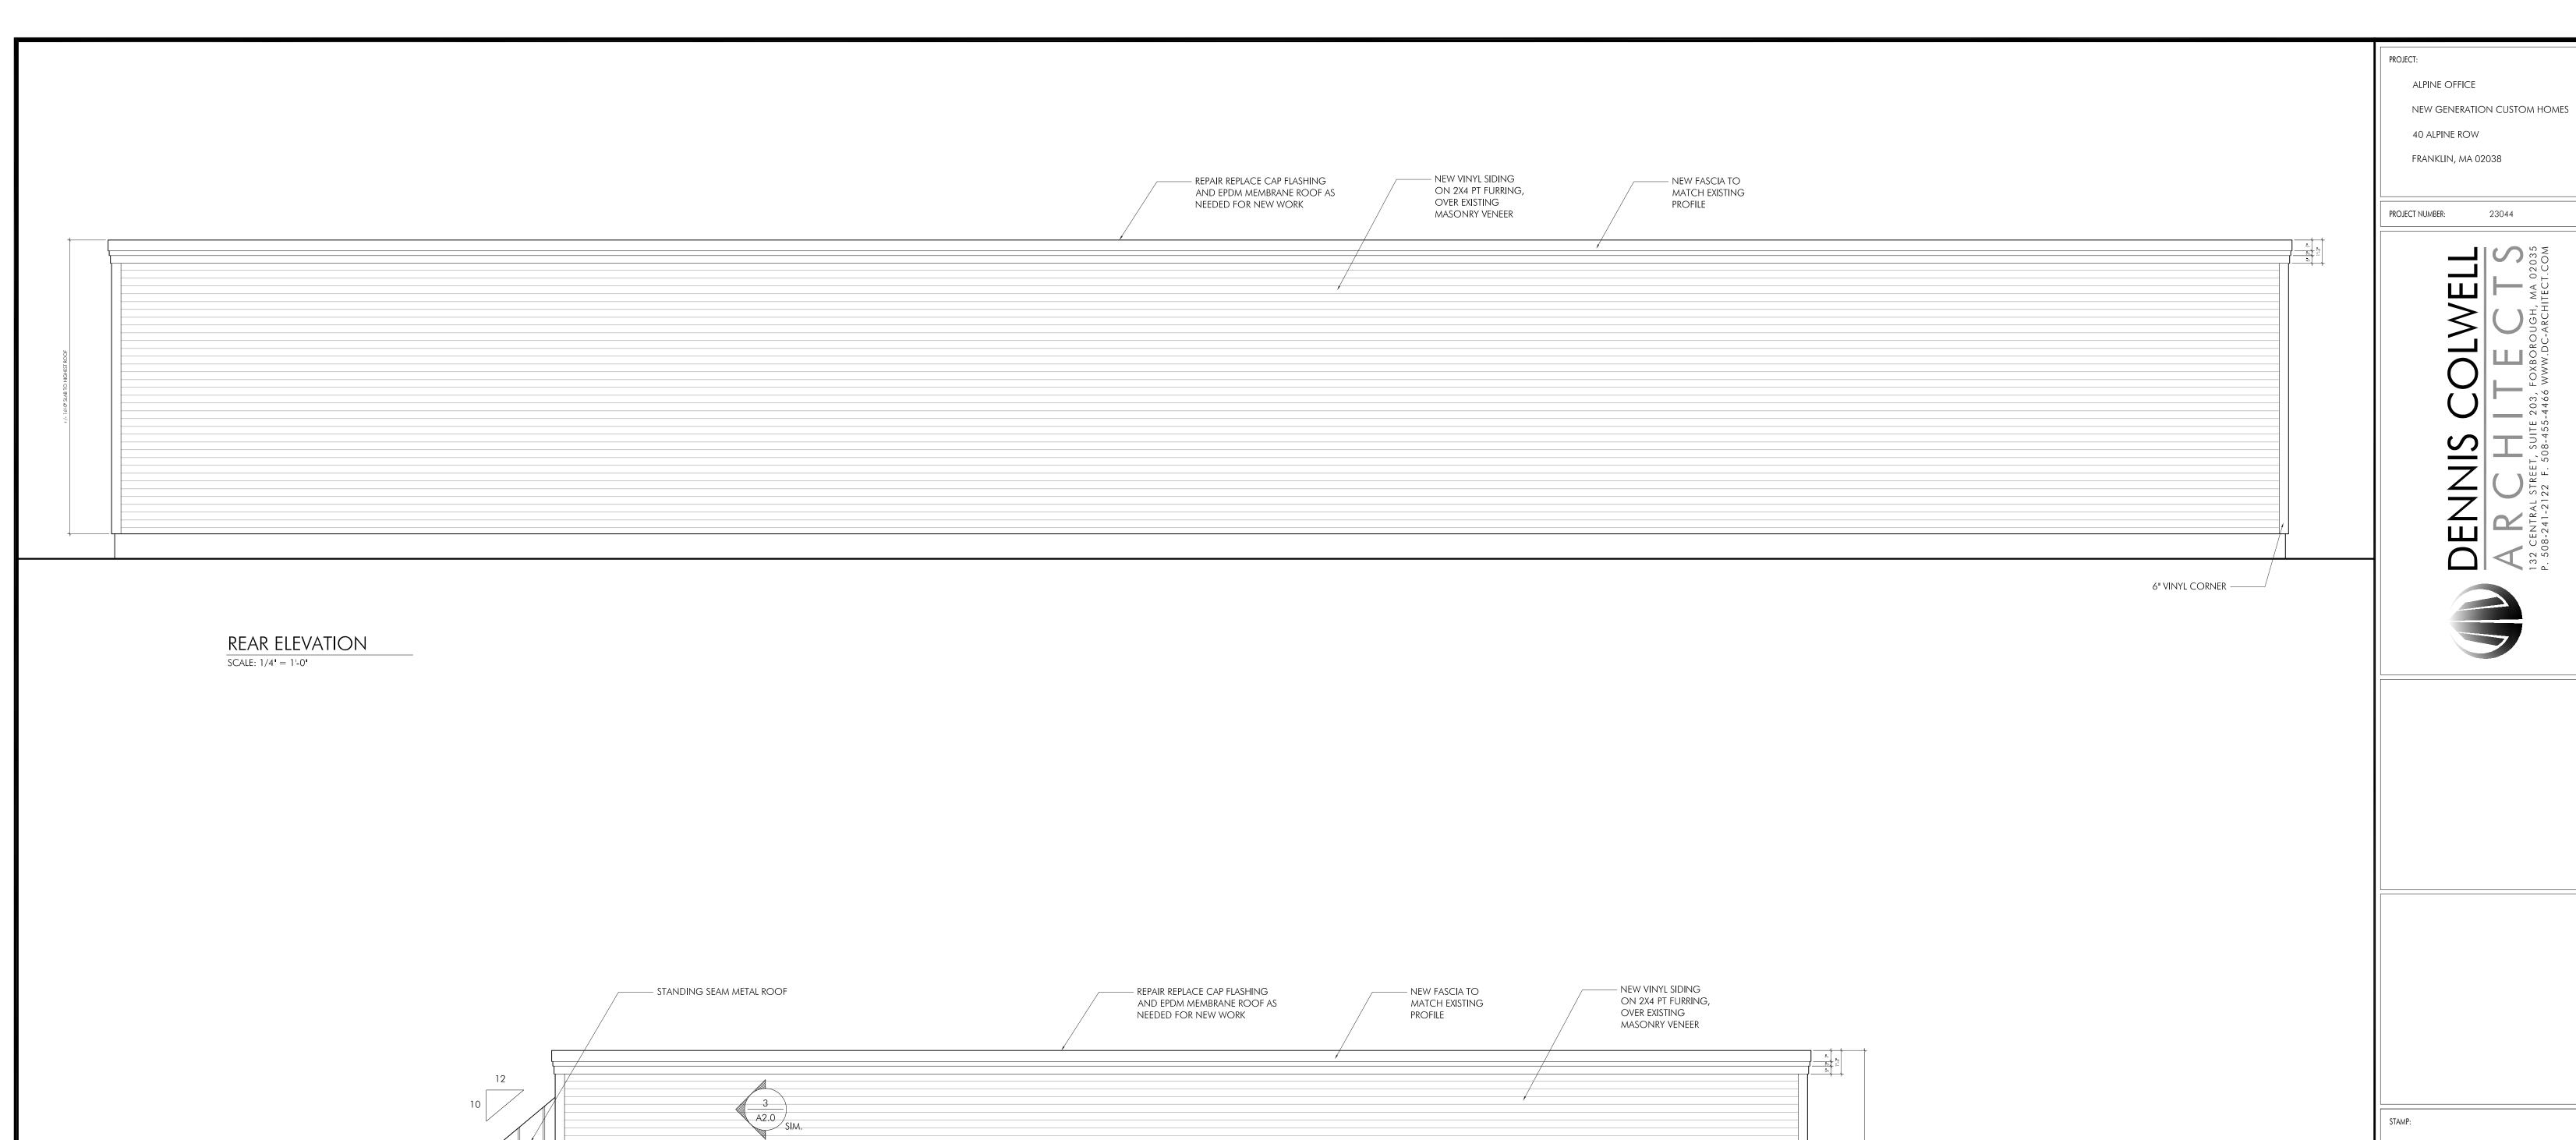

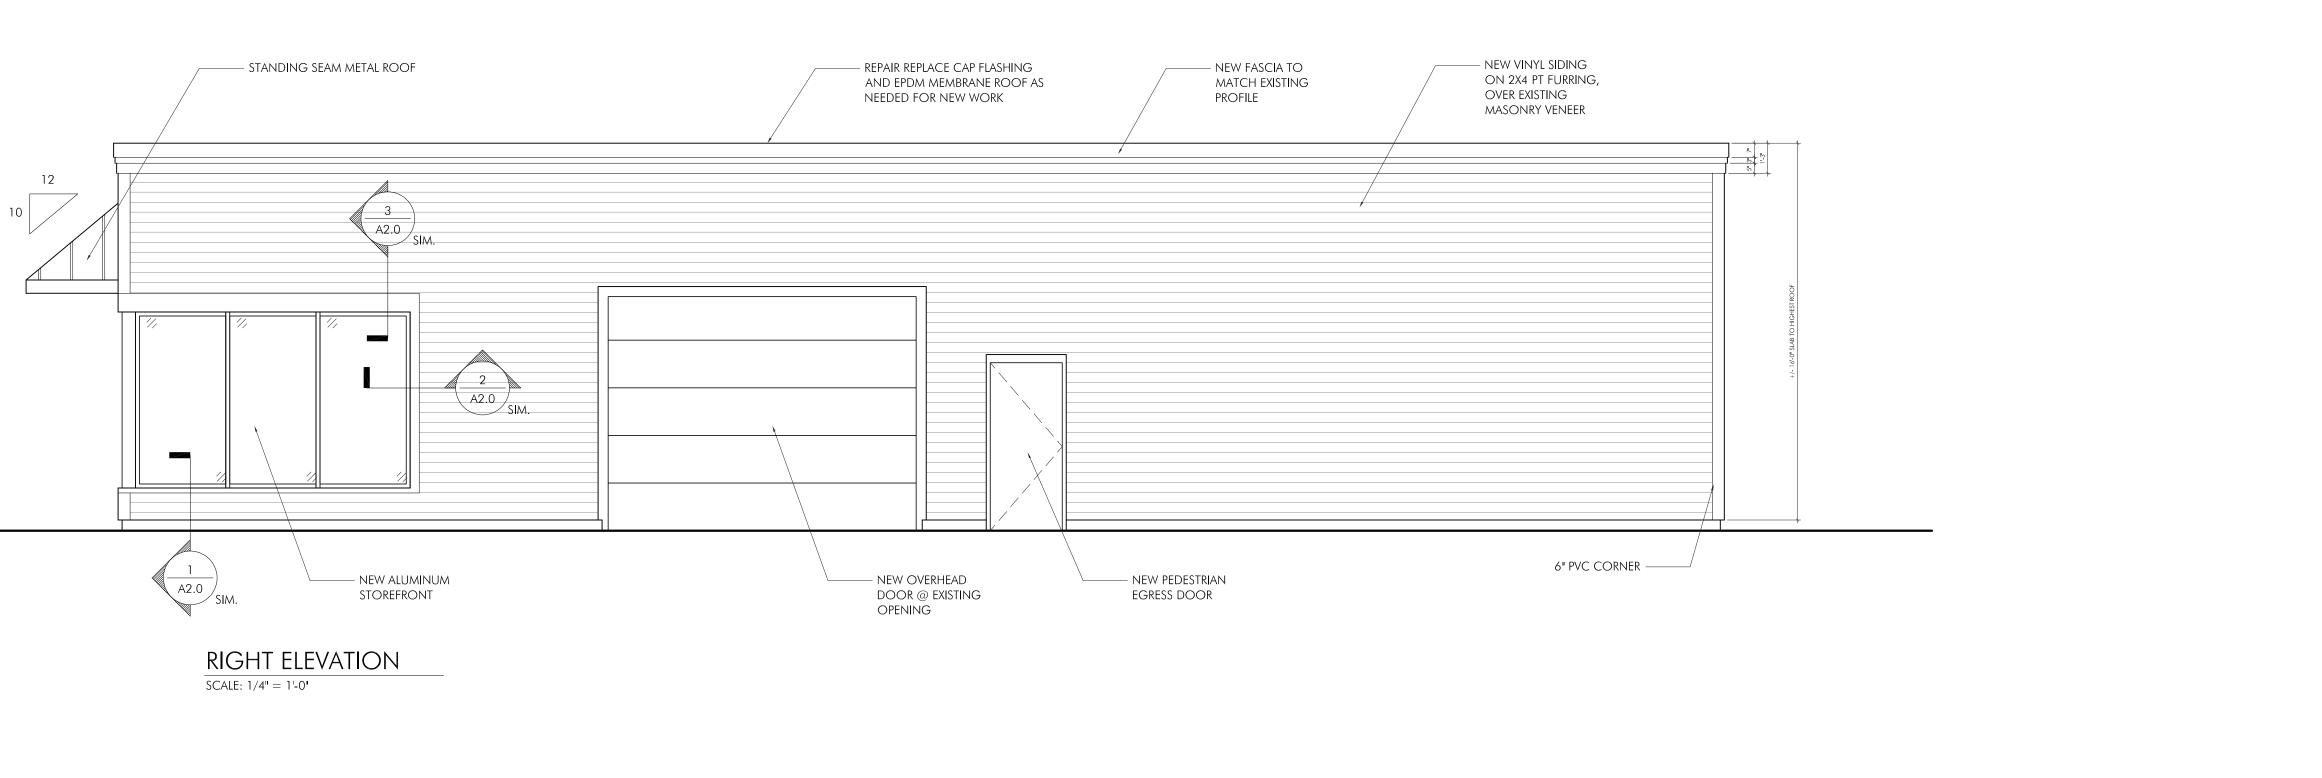

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PROJECT: ALPINE OFFICE NEW GENERATION CUSTOM HOMES 40 ALPINE ROW FRANKLIN, MA 02038

PROJECT NUMBER: 23044







ISSUE:			DATE:
ISSUE FOR PER	RMIT		04.05.2023
DRAWING SCALI	E:	1,	/4" = 1'-0"
DRAWN BY:	RWB	CHECKED	D BY: DMC

DRAWING TITLE:

ENLARGED PLANS AND INTERIOR ELEVATIONS


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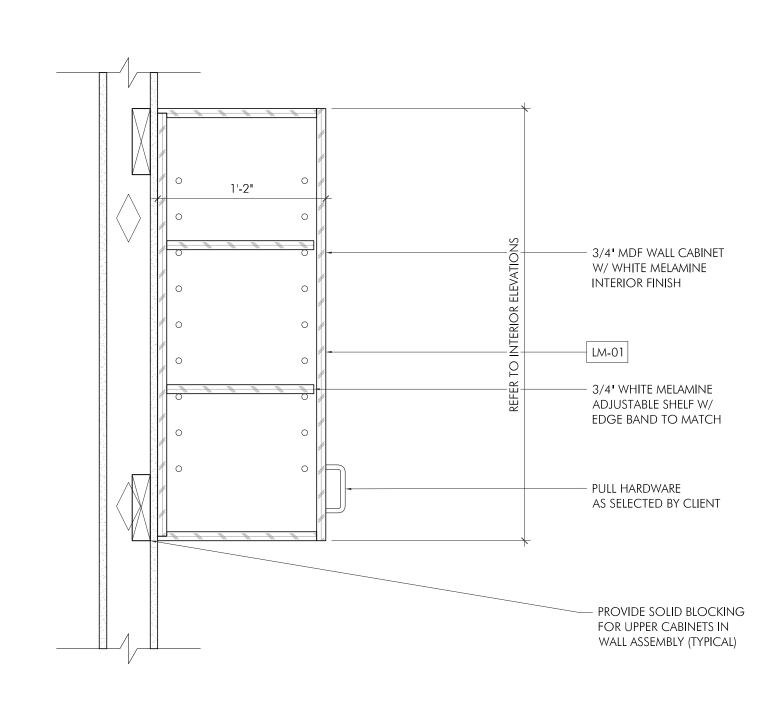


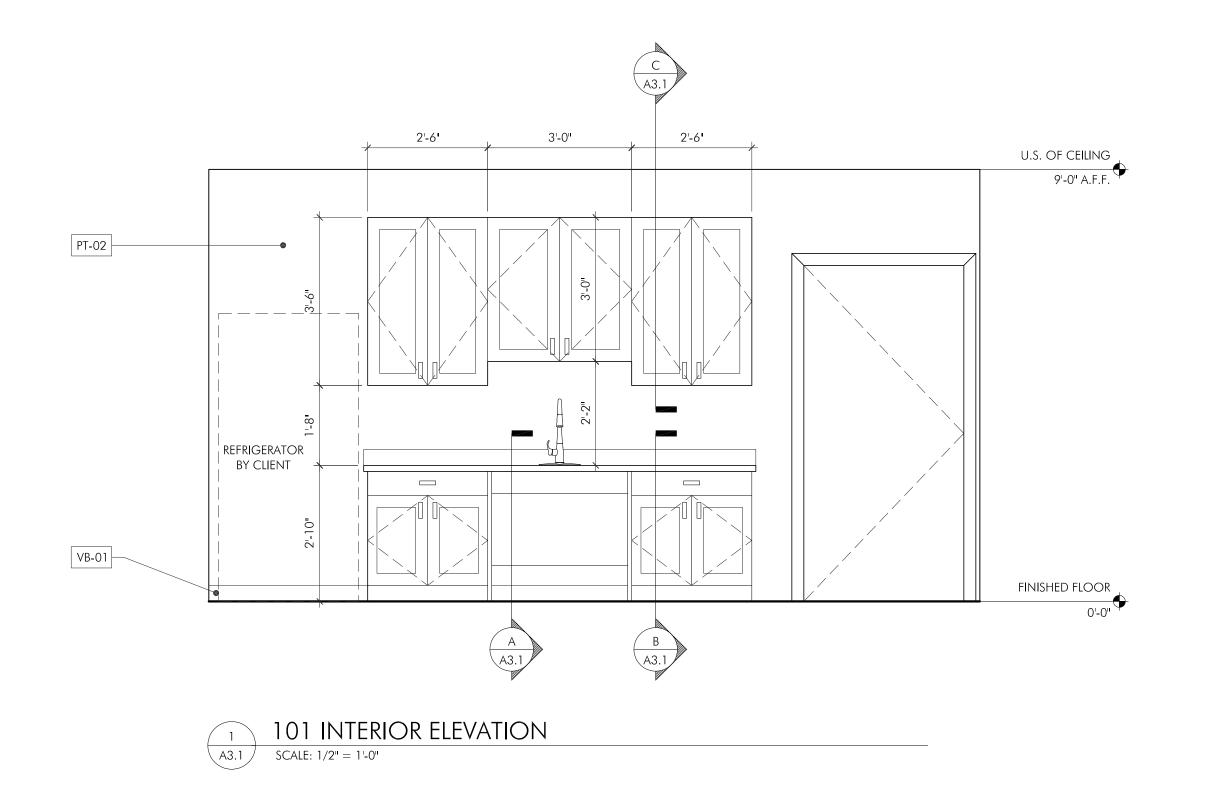NOTE:
SHOP DRAWINGS TO BE PROVIDED PRIOR TO
FABRICATION FOR REVIEW AND COMMENT

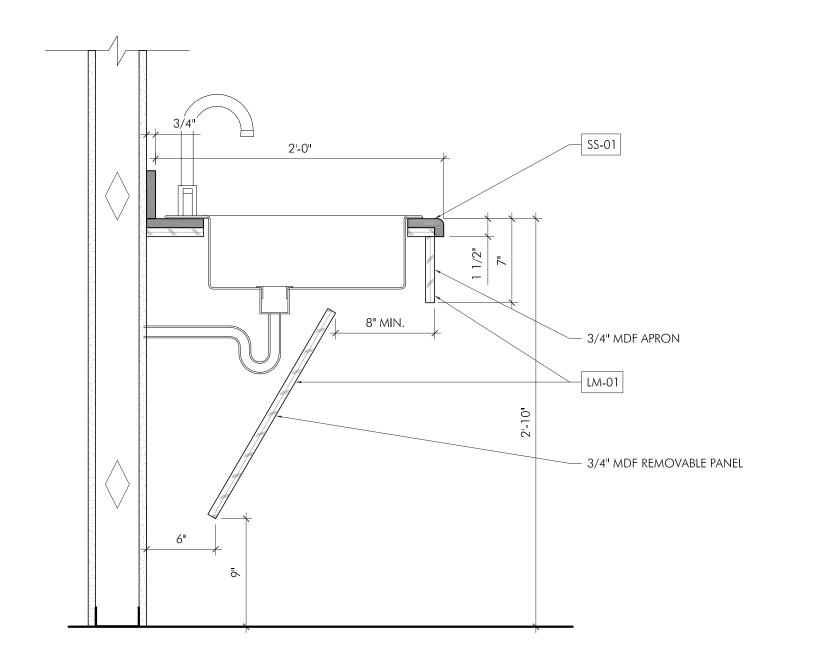



NOTE:
SHOP DRAWINGS TO BE PROVIDED PRIOR TO
FABRICATION FOR REVIEW AND COMMENT

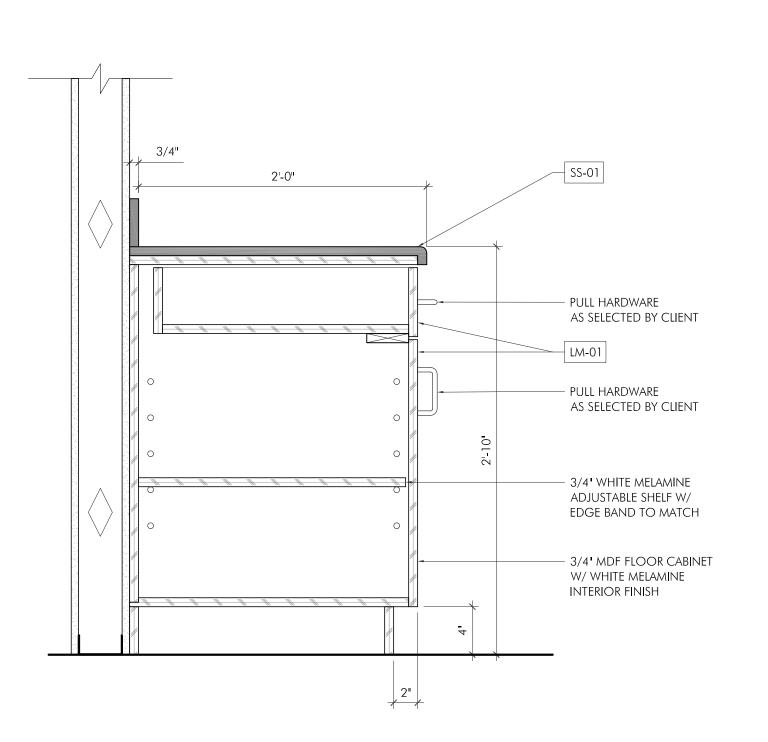



NOTE:
SHOP DRAWINGS TO BE PROVIDED PRIOR TO
FABRICATION FOR REVIEW AND COMMENT

PROJECT:

ALPINE OFFICE

NEW GENERATION CUSTOM HOMES

40 ALPINE ROW

FRANKLIN, MA 02038

PROJECT NUMBER: 23044

DENUNIS COLWELL

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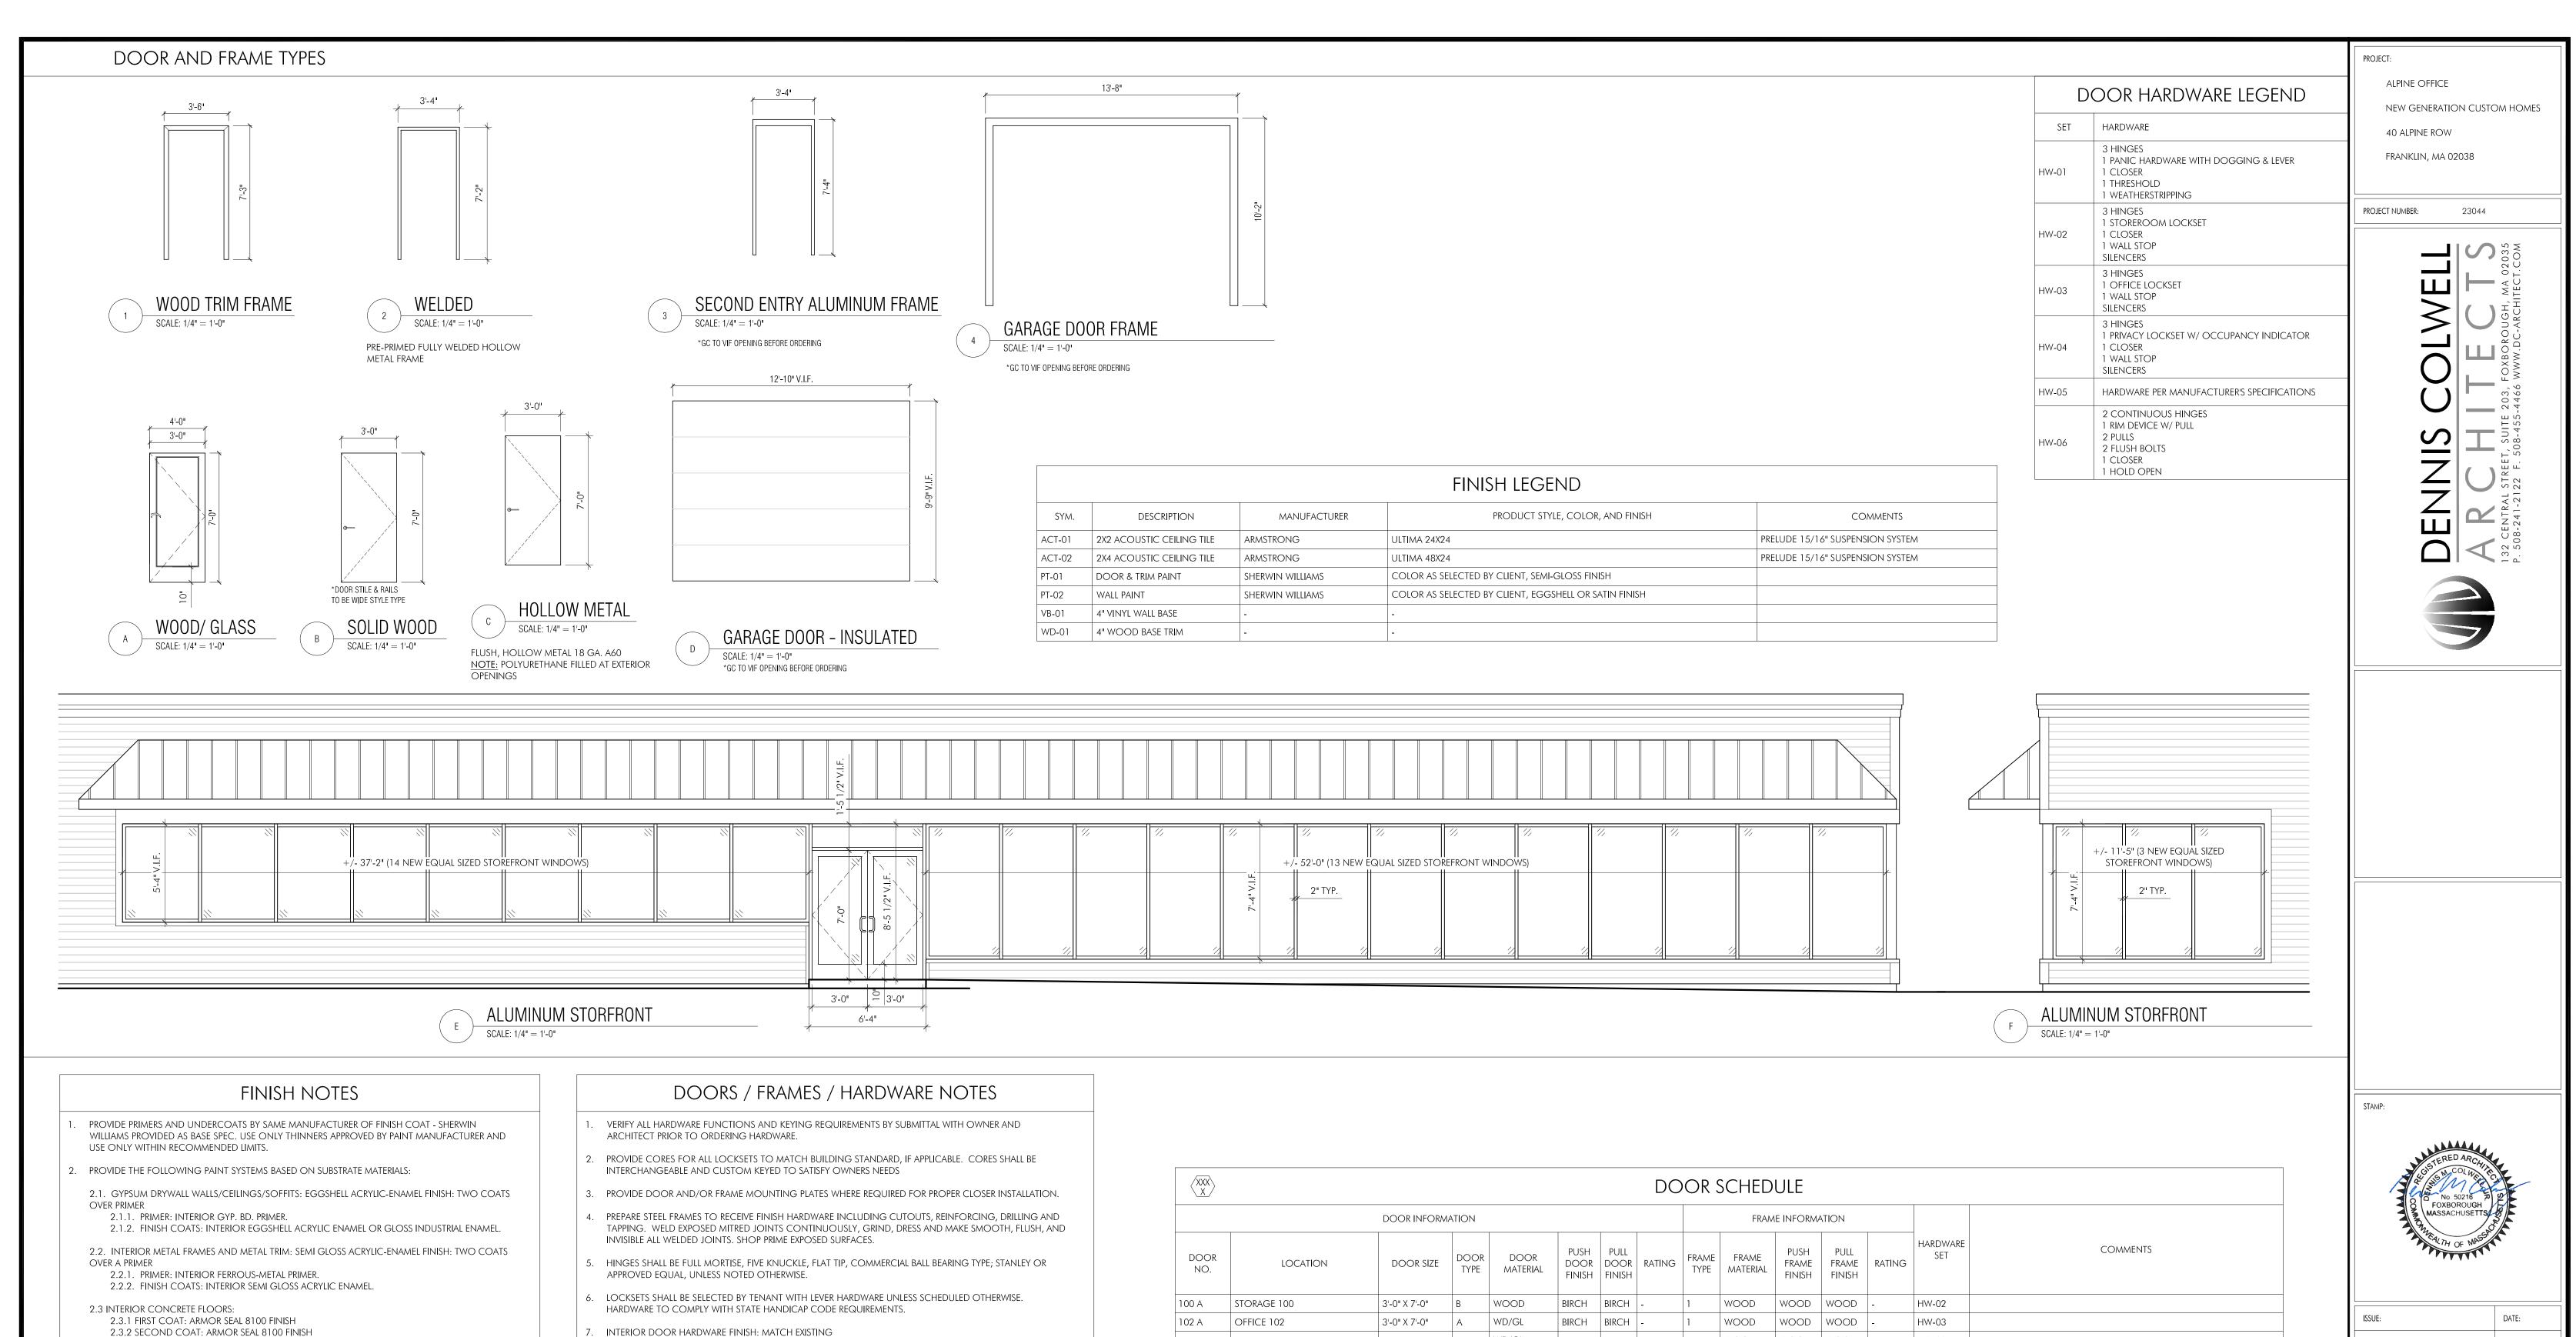
ISSUE:	ISSUE:						
ISSUE FOR PE	RMIT		04.0	05.2023			
DRAWING SCAL	E:	1,	/4" =	1'-0"			
DRAWN BY:	RWB	CHECKED	BY:	DMC			

DRAWING TITLE:

INTERIOR ELEVATIONS AND DETAILS

DRAWING NUMBER:

A3.1



3. ALL FINISHES SHALL BE INSTALLED IN STRICT ACCORDANCE WITH MANUFACTURERS WRITTEN instructions.

OTHERWISE NOTED, PROVIDE VINYL STRIPS AT JUNCTION OF CARPET AND VINYL.

- 4. PROVIDE VINYL COVE BASE AT VINYL AND TILE FLOORS. PROVIDE VINYL STRAIGHT BASE AT CARPETED
- FLOORS. . PROVIDE TRANSITION STRIPS AT JUNCTION OF DISSIMILAR FLOORING MATERIALS. IF NOT
- U.N.O. PROVIDE METAL TRANSITION STRIP AT THE JUNCTION OF TILE FLOORS (SCHLUTER, OR EQUAL). SUBMIT PRODUCT DATA AND SAMPLES FOR SELECTION. 6. SUBMIT SAMPLES OF ALL COLORS ON VARIOUS SUBSTRATE MATERIALS SPECIFIED ON DRAWINGS, AS WELL AS ANY COLOR SUBSTITUTIONS REQUESTED BY OWNER, UNTIL FINAL APPROVAL OF PAINT AND
- 7. ALL FINISHES SHALL BE SELECTED AND APPROVED BY OWNER.

STAIN COLORS IS OBTAINED.

- 8. ALL NEW INTERIOR DOORS TO HAVE 16 GA. KNOCK-DOWN HOLLOW METAL FRAMES, FACTORY PRIMED, UNLESS NOTED OTHERWISE.
- 9. PROVIDE MANUFACTURER'S STANDARD REINFORCING CLIPS AT KNOCK-DOWN FRAME CORNERS.
- 10. ALL DOOR HARDWARE TO COMPLY WITH STATE HANDICAP CODE REQUIREMENTS AND ADA REQUIREMENTS.
- 11. UNLESS OTHERWISE NOTED, WOOD DOORS TO BE 5 PLY SOLID CORE.
- 12. G.C. TO SUBMIT PRODUCT DATA / SHOP DRAWINGS TO ARCHITECT FOR APPROVAL FOR ALL DOORS, FRAMES, & HARDWARE.
- 13. CAULK ALL AROUND HEAD, JAMB, AND SILL, AT JUNCTURE OF H.M. FRAMES TO WALL FINISH.
- 14. VERIFY FRAME HEIGHTS BASED ON TOP OF SLAB AND FINISH FLOOR CONDITIONS AT EACH FRAME.
- 15. PROVIDE 20 GA. DOUBLE STUD FRAMING AT JAMBS.
- 16. PROVIDE 1/2" UNDERCUT AT BOTTOM OF DOORS UNLESS NOTED OTHERWISE.
- 17. THE HINGE SIDE OF ALL DOOR FRAMES SHALL BE LOCATED 4" FROM ADJACENT WALL UNLESS INDICATED/NOTED OTHERWISE.
- 18. PROVIDE MIN. (3) JAMB ANCHORS PER JAMB @ NEW DOOR FRAMES.
- 19. ALL DOOR CLOSERS (NEW AND EXISTING) SHALL BE COMPLIANT W/ STATE HANDICAP CODE OPENING FORCE
- 20. G.C. TO COORDINATE ALL SECURITY CAMERAS, WIRING, ELECTRIC STRIKES ETC. WITH DOOR AND HARDWARE SUPPLIER AND ELECTRICAL CONTRACTOR.

$\langle XXX \rangle$		DOOR SCHEDULE												
	DOOR INFORMATION				FRAME INFORMATION									
DOOR NO.	LOCATION	DOOR SIZE	DOOR TYPE	DOOR MATERIAL	PUSH DOOR FINISH	PULL DOOR FINISH	rating	FRAME TYPE	FRAME MATERIAL	PUSH FRAME FINISH	PULL FRAME FINISH	rating	HARDWARE SET	COMMENTS
100 A	STORAGE 100	3'-0" X 7'-0"	В	WOOD	BIRCH	BIRCH	-	1	WOOD	WOOD	WOOD	-	HW-02	
102 A	OFFICE 102	3'-0" X 7'-0"	А	WD/GL	BIRCH	BIRCH	-	1	WOOD	WOOD	WOOD	-	HW-03	
103 A	OFFICE 103	3'-0" X 7'-0"	А	WD/GL	BIRCH	BIRCH	-	1	WOOD	WOOD	WOOD	-	HW-03	
104 A	RECEPTION 104	(2)3'-0" X 7'-0"	E	ALUM/GL	ALUM	ALUM	-	-	ALUM	ALUM	ALUM	-	HW-06	
105 A	OFFICE 105	3'-0" X 7'-0"	А	WD/GL	BIRCH	BIRCH	-	1	WOOD	WOOD	WOOD	-	HW-03	
106 A	OFFICE 106	3'-0" X 7'-0"	А	WD/GL	BIRCH	BIRCH	-	1	WOOD	WOOD	WOOD	-	HW-03	
107 A	OFFICE 107	3'-0" X 7'-0"	А	WD/GL	BIRCH	BIRCH	-	1	WOOD	WOOD	WOOD	-	HW-03	
108 A	CONFERENCE ROOM 108	3'-0" X 7'-0"	А	WD/GL	BIRCH	BIRCH	-	1	WOOD	WOOD	WOOD	-	HW-03	
109 A	MEN'S BATHROOM 109	3'-0" X 7'-0"	В	WOOD	BIRCH	BIRCH	-	1	WOOD	WOOD	WOOD	-	HW-04	
110 A	WOMEN'S BATHROOM 110	3'-0" X 7'-0"	В	WOOD	BIRCH	BIRCH	-	1	WOOD	WOOD	WOOD	-	HW-04	
111A	UNISEX BATHROOM 111	3'-0" X 7'-0"	В	WOOD	BIRCH	BIRCH	-	2	H.M.	PT-1	PT-1	-	HW-04	
112A	WAREHOUSE 112	3'-0" X 7'-0"	В	WOOD	BIRCH	BIRCH	-	2	H.M.	PT-1	PT-1	-	HW-01	
112B	WAREHOUSE 112	3'-0" X 7'-0"	В	WOOD	BIRCH	BIRCH	-	2	H.M.	PT-1	PT-1	-	HW-01	
112C	WAREHOUSE 112	3'-0" X 7'-0"	С	НМ	PT-1	PT-1	-	3	H.M.	PT-1	PT-1	-	HW-01	
112D	WAREHOUSE 112	12'-10" X 9'-9"	D	FIBERGLASS	PREFIN	PREFIN	-	4	H.M.	PT-1	PT-1	-	HW-05	G.C. TO VERIFY WIDTH AND HEIGHT PRIOR TO ORDERING

ISSUE FOR PERMIT 04.05.2023 1/4" = 1'-0"DRAWING SCALE:

CHECKED BY: DMC

DRAWING TITLE:

NOTES AND SCHEDULES

DRAWING NUMBER:

DRAWN BY: RWB



