### DESIGN REVIEW COMMISSION AGENDA

July 6, 2021 7:00 PM.

### **Virtual Meeting**

Due to the growing concerns regarding the COVID-19 virus, we will be conducting a remote/virtual Design Review Commission Meeting. In an effort to ensure citizen engagement and comply with open meeting law regulations, citizens will be able to dial into the meeting using the provided phone number (Cell phone or Landline Required) OR citizens can participate by copying the link (Phone, Computer, or Tablet required). Please click on <a href="https://us02web.zoom.us/j/89260522253">https://us02web.zoom.us/j/89260522253</a> or call on your phone at 1-929-205-6099, meeting ID is 89260522253

**7:00 PM Botera** – 1256 West Central Street

Install two sets of Channel letter signs and update freestanding sign

7:05 PM iFix Phones – 15 East Main Street

Install Belt sign

**7:10 PM Marathon** – 251 East Central Street

Reface existing Speedway signage to Marathon

**7:15 PM Bamboo House** – 2 Main Street

Install sign

**7:20 PM** Engine Yard -40 Alpine Row

Street level commercial and 28 Residential units above street level

### **General Matters:**

Approval of Minutes: 6-15-2021

COMMENTS: These listing of matters are those reasonably anticipated by the Chair which may be discussed at the meeting. Not all items listed may in fact be discussed and other items not listed may also be brought up for discussion to the extent permitted by law.

This agenda is subject to change. Last updated: 07-01-2021

The next meeting of the Design Review Commission is scheduled for July 20, 2021

### FORM Q

### TOWN OF FRANKLIN DESIGN REVIEW APPLICATION FOR §185-31(2) OF THE ZONING BY-LAW

A) General Information
Name of Business or Project: Botera
Property Address 1256 West Central Street
Assessors' Map # Parcel #
Zoning District (select applicable zone):
Zoning History: Use VarianceNon-Conforming Use
B) Applicant Information:
Applicant Name: Best Price Signs and Printing
Address: 244 Liberty Street Brockton, ma 02301
Telephone Number: (508) 388 - 9568
Contact Person: Gilmar Da Silva
C) Owner Information (Business Owner & Property Owner if different)
Business Owner: (Same as property Address: Property Owner: 1256 West Central St Franklin, MA 12038
All of the information is submitted according to the best of my knowledge Executed as a sealed instrument this day of 20
Signature of Applicant Signature of Owner
Print name of Applicant Best Price Signs Print name of Owner
*FOR SIGNS COMPLETE PAGES 1 & 2 ONLY. FOR SITE PLANS, BUILDING PLANS, PROJECTS, COMPLETE PAGES 1 – 4
SEE ADDENDA ATTACHED FOR ASSISTANCE IN COMPLETION OF FORM Q

D) Architect/Engineer/Sign Company Information (if not the applicant)
a. Sign Company
Business Name: Best Price Signs and Printing
Contact Person: Gilmar Da Silva
Address 244 Liberty Street, Brockton, MA 02301
Telephone Number: (508) 388- 9568
b. Architect/Engineer (when applicable)
Business Name:
Contact Person:
Address
Telephone Number:
E) Work Summary
Summary of work to be done: Install two sets of Channel
letter signs and update freestanding sign-
J T
Information & Materials to be Calmitted with A 11 1

### F) Information & Materials to be Submitted with Application

### a) FOR SIGN SUBMISSIONS ONLY:

### NINE (9) COPIES OF THE FOLLOWING MUST BE SUBMITTED WITH APPLICATION

1. Drawing of Proposed Sign which must also include

type of sign (wall, pylon etc.)

colors materials

size/dimensions style of lettering

lighting-illuminated, non-illuminated and style

- 2. Drawing and/or pictures indicating location of new sign.
- 3. Picture of existing location and signs (if previously existing location)

### b) <u>FOR BUILDINGS/DEVELOPMENTS OR PROJECT SUBMISSIONS</u>:

### NINE (9) COPIES OF THE FOLLOWING MUST BE SUBMITTED W/APPLICATION

- 1. Site Plan including Landscape Plan showing plantings. Plantings must be from Best Development Practices Guide
- 2. Lighting Plan indicating lighting levels & specifications of proposed lights
- 3. Building drawings, indicating size and height of building(s); front, rear and side elevations (when there are no adjoining buildings) and floor plans
- 4. Drawings or pictures of existing conditions
- 5. If any signage on the building or site, provide information from above Signage Checklist

Note: Please bring a sample of the following to the meeting: materials samples (brick, siding, roofing etc.) as well as samples of paint colors.


### SIGN DETAIL

DRAWING:

### **EXISTING**





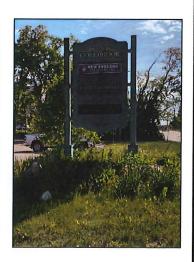

### CLIENT BOTERA ADDRESS 1256 WEST CENTRAL STREET FRANKLIN, MA PROJECT SIGNAGE

FILE NAME

GILMAR COMMENTS

### **PROPOSAL**







2 Sets of Channel Letter signs (same size) installed against the side and back of the building, 12' long and 2' tall

Update freestanding sign to an aluminum post and panel sign, 6' long and 10' tall

WWW.BPSIGNSANDPRINTING.COM

E-mail: signs@bpsignsandprinting.com



Office: 508-388-9568 Cell: 508-825-3024 1034 N. Montello Street - Brockton, MA 02301

### FORM Q

### TOWN OF FRANKLIN DESIGN REVIEW APPLICATION FOR §185-31(2) OF THE ZONING BY-LAW

A) General Information
Name of Business or Project:
Property Address 15 F. Main St.
Assessors' Map # Parcel #_ 279 - 176 - 000 - 000
Zoning District (select applicable zone):
Zoning History: Use VarianceNon-Conforming Use
B) Applicant Information:
Applicant Name: Signs By Cam, Inc.
Address:  Signs By Cam, Inc.  837 Upper Union Street  Suite C-18  Franklin, MA 02038
Telephone Number: 508-364-2905
Contact Person: Con
C) Owner Information (Business Owner & Property Owner if different)
Business Owner: Alex Mannadou Property Owner: Anna Klarke  Address: 15 E. Control 31.  Frankly MA 02020  Quincy MA 02189
All of the information is submitted according to the best of my knowledge  Executed as a sealed instrument this day of  Signature of Applicant  Signature of Owner
Print name of Applicant  AULLARKE  Print name of Owner
Print name of Applicant Print name of Owner

\*FOR SIGNS COMPLETE PAGES 1 & 2 ONLY.
FOR SITE PLANS, BUILDING PLANS, PROJECTS, COMPLETE PAGES 1 – 4

SEE ADDENDA ATTACHED FOR ASSISTANCE IN COMPLETION OF FORM Q

D) Architect/Engineer/S	ign Company Infor	mation (if not the applicant)
a. Sign Company		
Business Name:	Signs By	Cam Inc
Contact Person:	837 Upp	er Union Street
Address	Franklin.	MA 02036
Telephone Number:		Cam, Inc. er Union Street 8 MA 02038
b. Architect/Engineer (		
Contact Person:		
Address		
Telephone Number:		
E) Work Summary		
		ell belt Sign.
F) Information & Mate  a) FOR SIGN SUBMIS  NINE (9) COPIES OF TAPPLICATION  1. Drawing of Proposed	rials to be Submitte SIONS ONLY: HE FOLLOWING Sign which must also ll, pylon etc.) co	MUST BE SUBMITTED WITH  include lors
2. Drawing and/or picture	es indicating location	of new sign.
3. Picture of existing loca	ation and signs (if pre	eviously existing location)
b) <u>FOR BUILDINGS/DE</u>	EVELOPMENTS O	R PROJECT SUBMISSIONS:
NINE (9) COPIES OF T	HE FOLLOWING	MUST BE SUBMITTED W/APPLICATION
1. Site Plan including Lar Practices Guide	ndscape Plan showing	g plantings. Plantings must be from Best Development
3. Building drawings, inc	licating size and heig	pecifications of proposed lights ht of building(s); front, rear and side elevations
(when there are no 4. Drawings or pictures of	adjoining buildings) f existing conditions	

5. If any signage on the building or site, provide information from above Signage Checklist


Note: Please bring a sample of the following to the meeting: materials samples (brick, siding, roofing

etc.) as well as samples of paint colors.







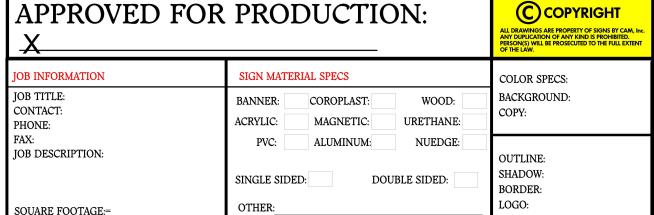

### FORM Q

### TOWN OF FRANKLIN DESIGN REVIEW APPLICATION FOR §185-31(2) OF THE ZONING BY-LAW

A) General Information
Name of Business or Project:
Property Address 251 E Control St
Assessors' Map # Parcel # <u>285 -106 -000 -000</u>
Zoning District (select applicable zone):
Zoning History: Use Variance Non-Conforming Use
B) Applicant Information:
Applicant Name: Total Image Salutions
Address: 196 Theater Rd South Hill VA 23970
Telephone Number: 434-584-9716
Contact Person: Mckenzie Smith
C) Owner Information (Business Owner & Property Owner if different)
Business Owner: The least Property Owner: Hess Refail Stores LC Address: Gfs Hamilton St 5395 Main St Fidlay OH 45840
All of the information is submitted according to the best of my knowledge Executed as a scaled instrument this day of 1777 2021
Signature of Applicant Signature of Owner
Mckenzie Smith  Print name of Applicant  Print name of Owner

\*FOR SIGNS COMPLETE PAGES 1 & 2 ONLY.
FOR SITE PLANS, BUILDING PLANS, PROJECTS, COMPLETE PAGES 1 – 4

SEE ADDENDA ATTACHED FOR ASSISTANCE IN COMPLETION OF FORM Q

D) Architect/Engineer/Sign Company Inform	mation (if not the applicant)
a. Sign Company	
Business Name:	
Contact Person:	
Address	
Telephone Number:	
b. Architect/Engineer (when applicable) Business Name:	
Contact Person:	
Address	
Telephone Number:	
E) Work Summary	
Summary of work to be done: Reface Signage to Marathor	existing speedway
F) Information & Materials to be Submitte	ed with Application
a) FOR SIGN SUBMISSIONS ONLY:	
NINE (9) COPIES OF THE FOLLOWING APPLICATION	MUST BE SUBMITTED WITH
type of sign (wan, pyron out.)	so include colors materials
	ighting-illuminated, non-illuminated and style
2. Drawing and/or pictures indicating location	on of new sign.
3. Picture of existing location and signs (if p	reviously existing location)
b) FOR BUILDINGS/DEVELOPMENTS	OR PROJECT SUBMISSIONS:

### NINE (9) COPIES OF THE FOLLOWING MUST BE SUBMITTED W/APPLICATION

1. Site Plan including Landscape Plan showing plantings. Plantings must be from Best Development Practices Guide

2. Lighting Plan indicating lighting levels & specifications of proposed lights

3. Building drawings, indicating size and height of building(s); front, rear and side elevations (when there are no adjoining buildings) and floor plans

4. Drawings or pictures of existing conditions

5. If any signage on the building or site, provide information from above Signage Checklist

Note: Please bring a sample of the following to the meeting: materials samples (brick, siding, roofing etc.) as well as samples of paint colors.

8. Advertising Features – The size, location, design, color, texture, lighting and materials of all permanent signs and outdoor advertising structures shall not detract from the use and enjoyment of the proposed buildings and structures and the surrounding properties.  Same as
9. Heritage – Removal or disruption of historic, traditional or significant uses, structures or architectural elements shall be minimized insofar as practicable.  NIA
10. <b>Energy Efficiency</b> – To the maximum extent reasonably practicable, proposals shall utilize energy-efficient technology and renewable energy resources and shall adhere to the principles of energy-conscious design with regard to orientation, building materials, shading, landscaping and other elements.
11. <b>Landscape</b> - The landscape should improve the character and appearance of the surrounding area and parking areas should be located to the side or rear of buildings when reasonably possible.

SEE ADDENDA ATTACHED FOR INSTRUCTIONS TO ASSIST IN COMPLETING APPLICATION.

### DESIGN STANDARDS

Explain how each of the design standards outlined below has been incorporated into the design of the proposed development. Fill in the information in the spaces provided or use a separate sheet.

1. <b>Height</b> —The height of any proposed alteration shall be compatible with the surrounding buildings, within zoning requirements. ID 15 0A	ne style and character of
2. <b>Proportions of Windows and Doors</b> – The proportions and relationships windows shall be compatible with the architectural style and character of the <b>N</b>	between doors and surrounding area.
3. Relations of Building Masses and Spaces – The relationship of a structubetween it and adjoining structures shall be compatible.	re to the open space
4. Roof Shape – The design and pitch of the roof shall be compatible with the character of the surrounding buildings.  NA	ne architectural style and
5. Scale – The scale of the structure shall be compatible with its architectura the surrounding buildings.  NIA	al style and the character of
6. Façade, Line, Shape & Profile – Facades shall blend with other structur with regard to the dominant vertical or horizontal context:  JUST DIFFERENT COLORS   WORDING	es in the surrounding area  S QXISTING
7. Architectural Details – Architectural details, including signs, materials, be treated so as to be compatible with the existing and adjacent architectural preserving and enhancing the surround area.  Red. White, 4 blue	character, thereby

# Mobil MID Sign

# - 2 product LED price sign (Reg/Diesel Efficient)

Proposed Sign: 64.5 sq. ft, 15' 0AH

Existing Sign: 64.5 sq. ft, 15' 0AH







196 Theater Rd. South Hill, VA 23970

P: (434) 447-3347 F: (434) 447-3266 Mobil
Address
Address
Site ID
#2460
Branded Wholesaler
Project Sonic
7 Eleven
Date
6-17-21
Revisions
1
Designed By
Raheem R.


FOR PERMITTING PURPOSES ONLY

# Mobil Gas Canopy


# Existing Canopy:



# Proposed Canopy:

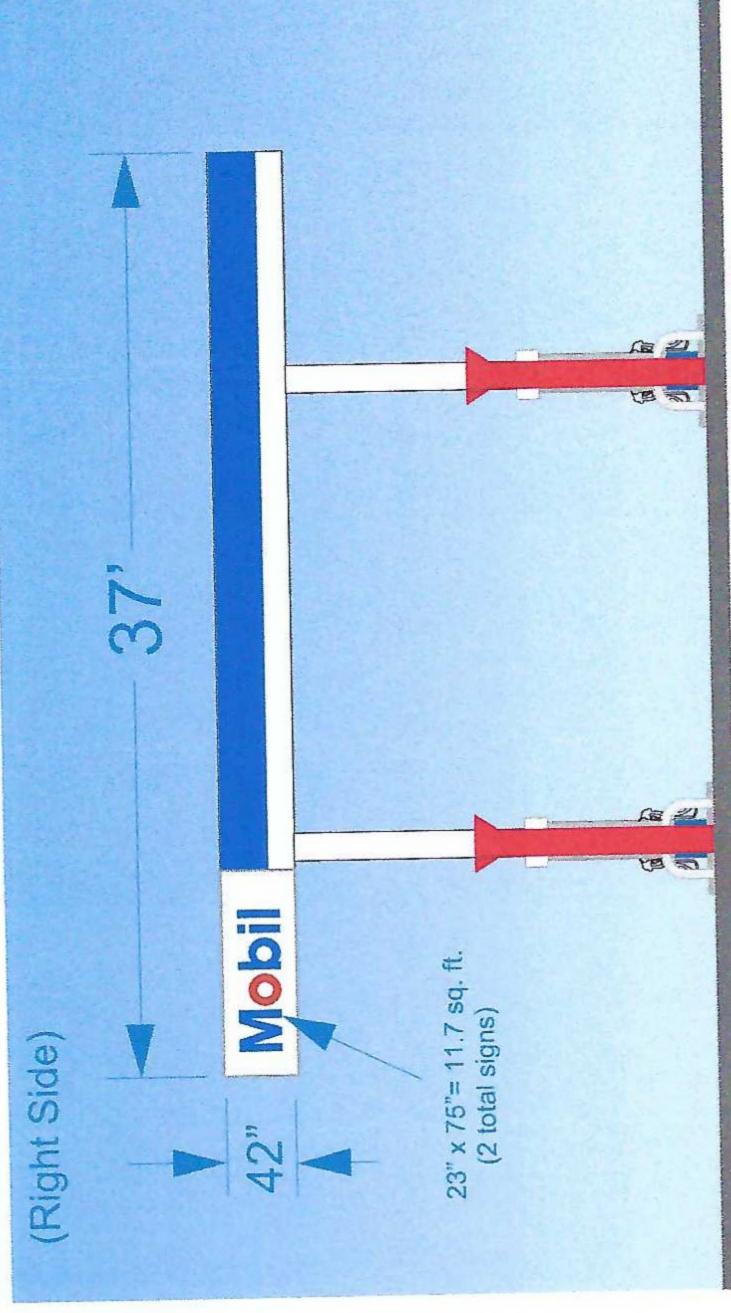

Secondary Fascia

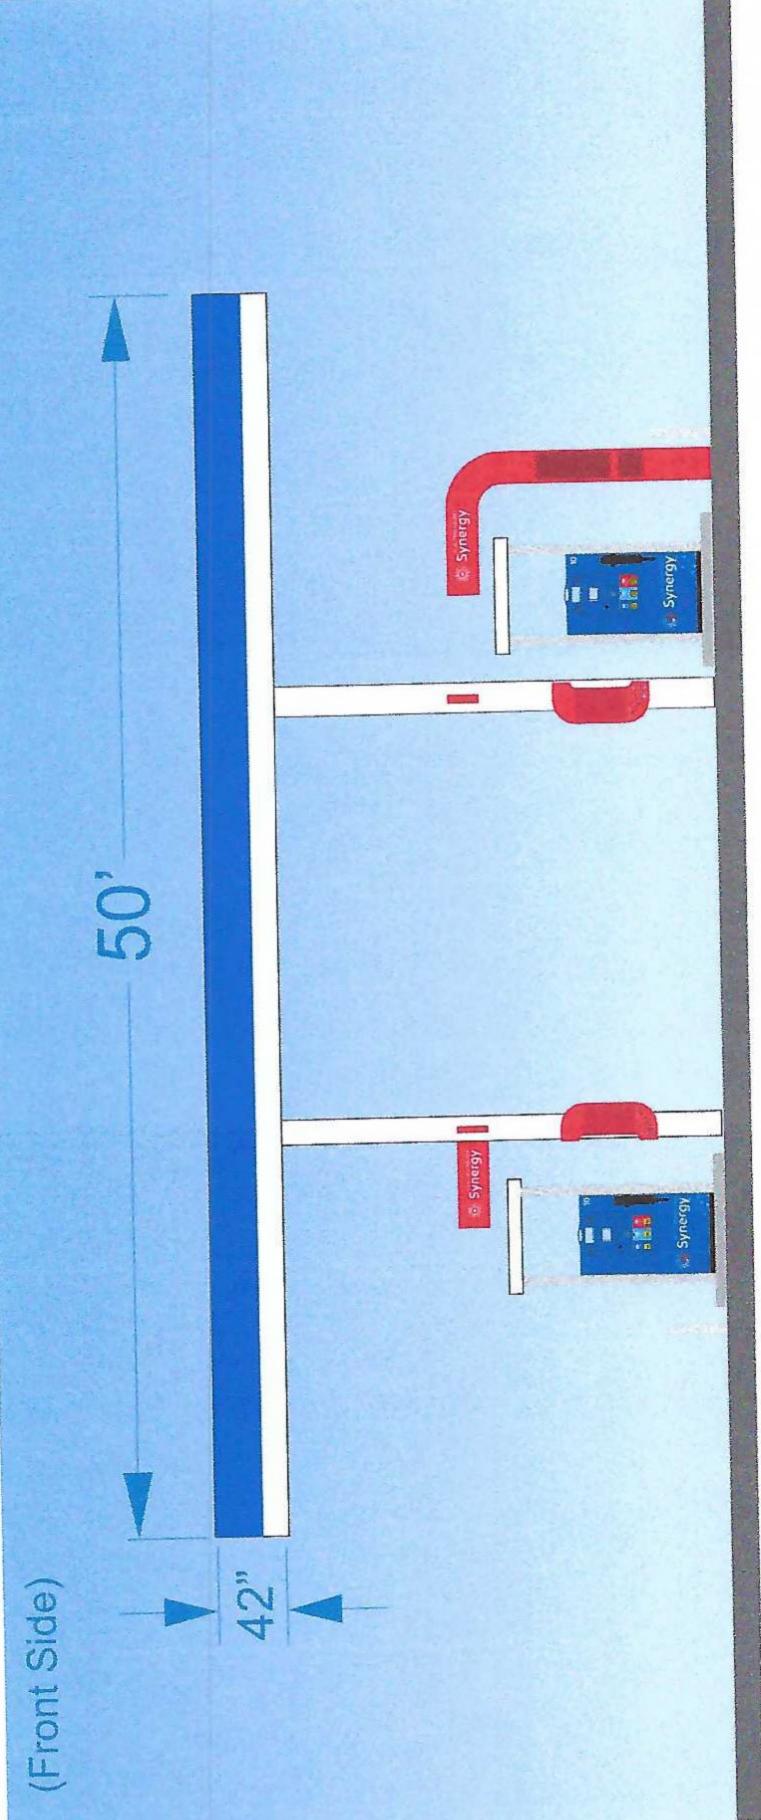

Primary Fascia



totalimagesolutions.com

196 Theater Rd. South Hill, VA 23970

P: (434) 447-3347 F: (434) 447-3266 Brand

Mobil

Address

251 E Central St.
Franklin, MA 02038


#2460

Branded Wholesaler

Project Sonic
7 Eleven
Date

6-17-21
Revisions
1
Designed By
Raheem R.

FOR PERMITTING PURPOSES ONLY

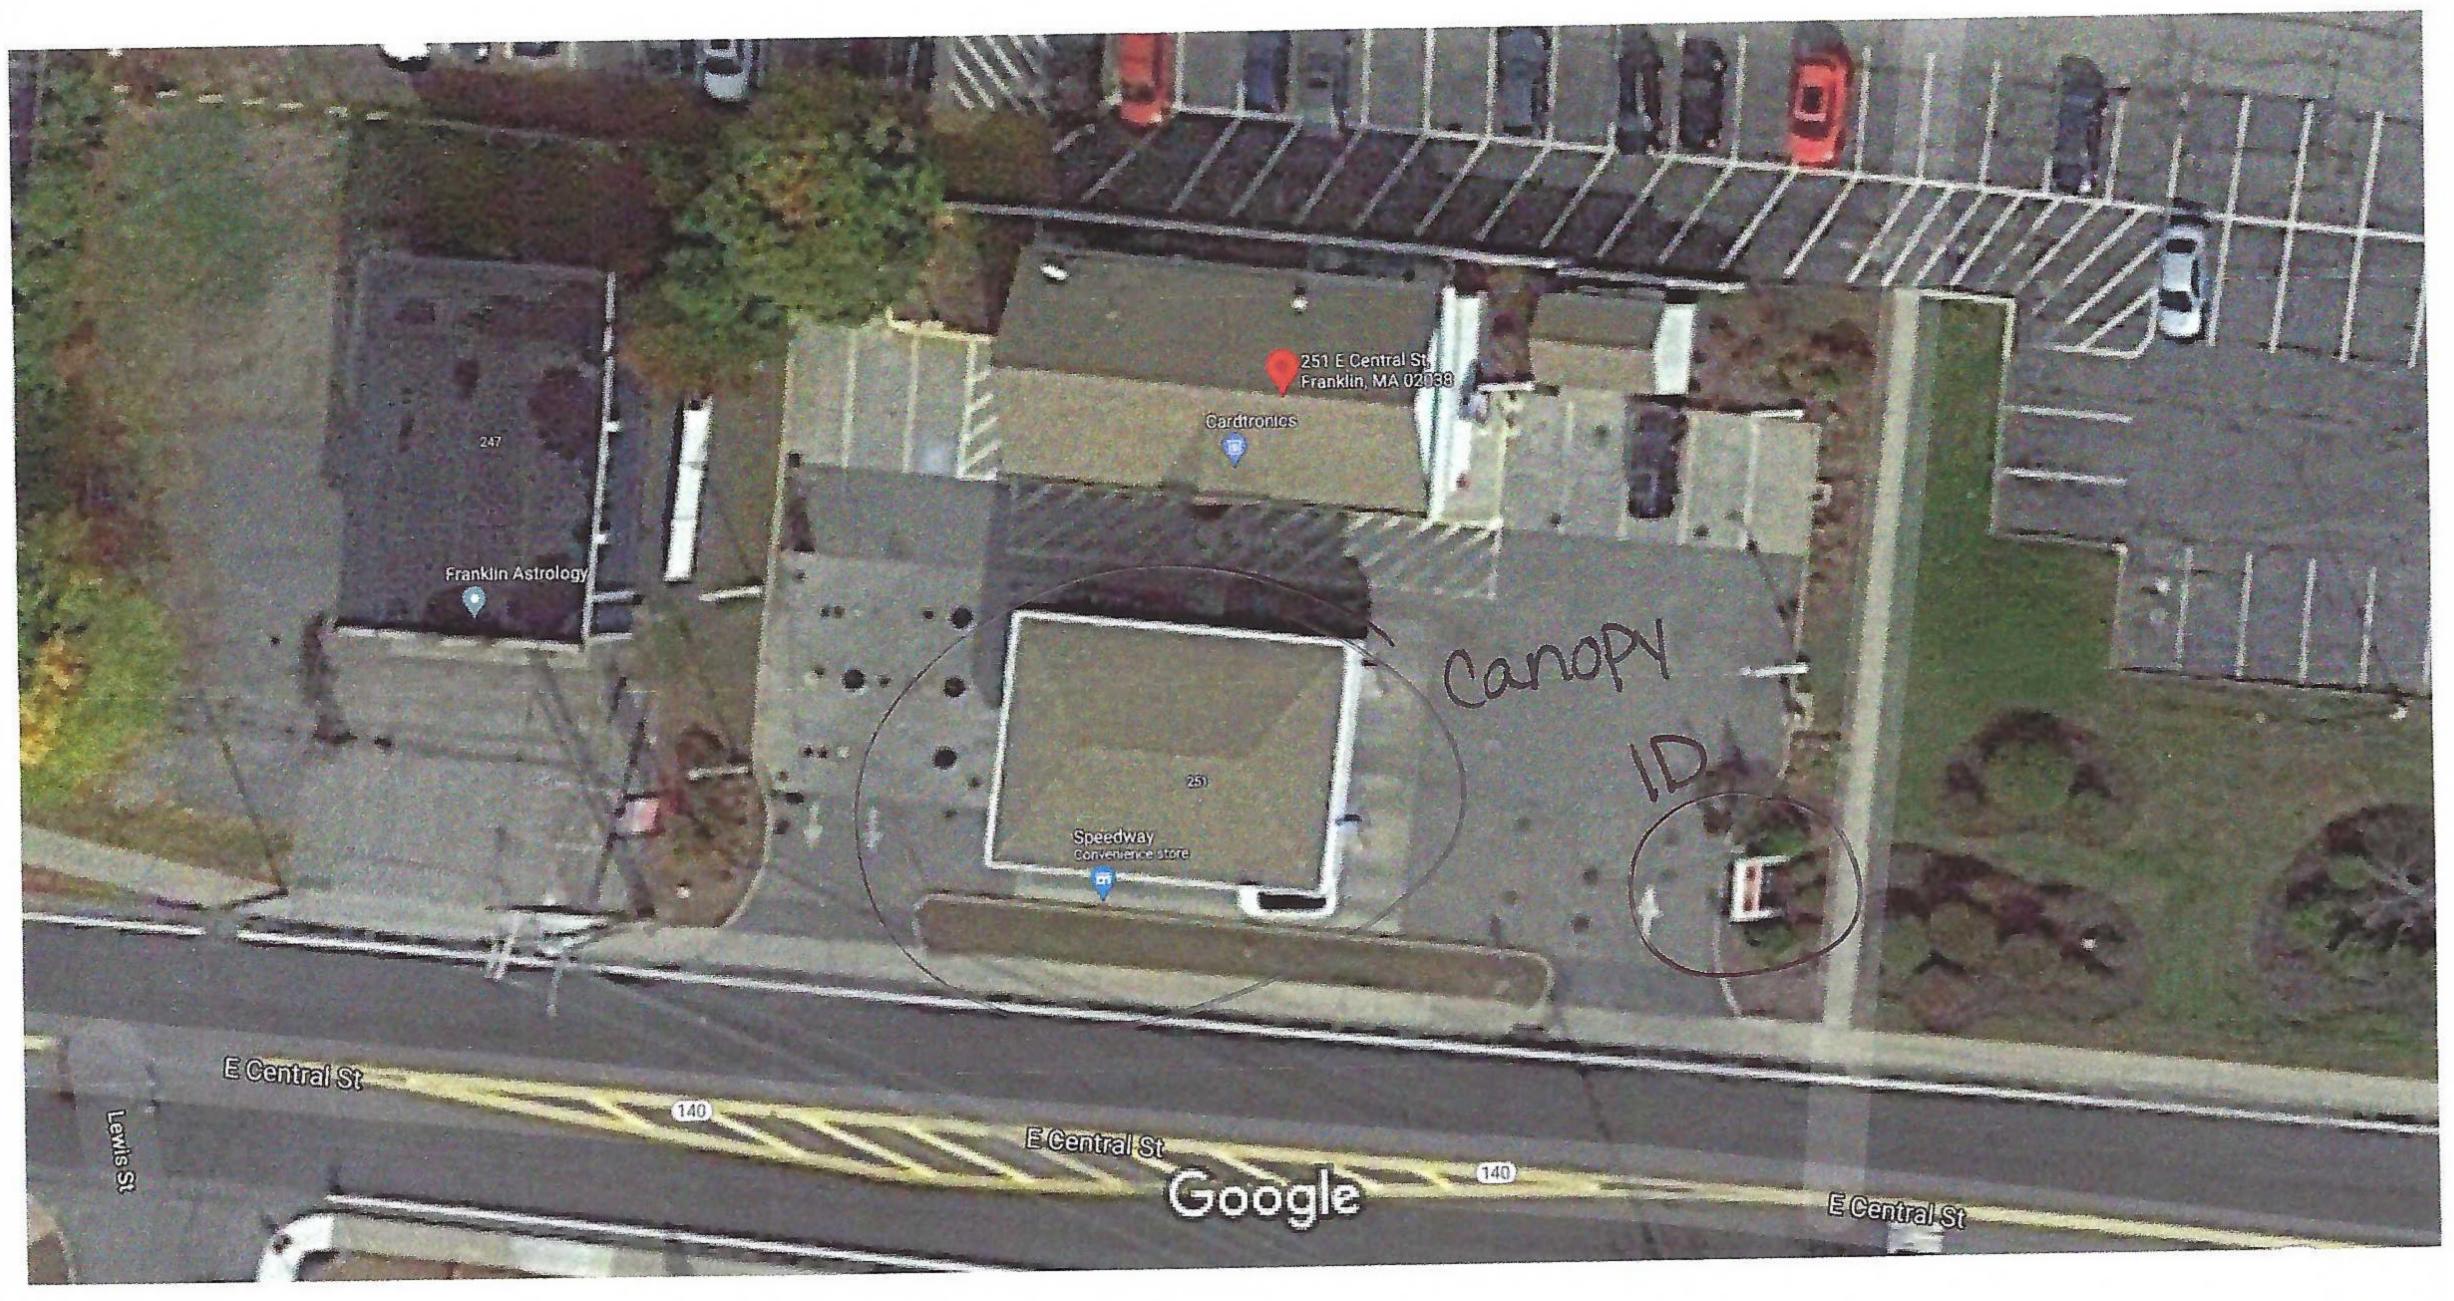

Map data ©2021, Map data ©2021 5 m



### 251 E Central St

Franklin, MA 02038 Building











Nearby

Send to your phone

Share

### FORM Q

### TOWN OF FRANKLIN DESIGN REVIEW APPLICATION FOR §185-31(2) OF THE ZONING BY-LAW

A) General Information	ZOMING BY-LAW
Name of Business or Drain	
Name of Business or Project: Bam)  Property Address O III	200 House
Property Address 2 Main St  Assessors' Map # 279	Franklin, MA, 02038.
	rcel #
Zoning History: Use Variance  Non-Conforming Use	
B) Applicant Information:	
Applicant Name: Limei Qiv.	
Address: 2 Main Street Fray	Klin, MA, 02038.
Telephone Number: 508 528 95	88.
Contact Person:	
C) Owner Information (Business Owner	r & Property Owner if different)
Business Owner: ZhuJiang Inc / Limei Address: 2 Main St Franklin, MA	Qu Property Owner: NJN LCC  CO Nabil K. Nakhoul.
All of the information is submitted according executed as a sealed instrument this	ng to the best of my knowledge day of 20
ignature of Applicant	Signature of Owner
1: mai Qiu.	NABIL NAKITOUL /NJNLLC.
rint name of Applicant	Print name of Owner
OR SIGNS COMPLETE PAGES 1 & 2	ONLY.

\*FOR SIGNS COMPLETE PAGES 1 & 2 UNLY.

FOR SITE PLANS, BUILDING PLANS, PROJECTS, COMPLETE PAGES 1 – 4

FOR SITE PLANS, BUILDING PLANS, PROJECTS, COMPLETION OF FORM (

SEE ADDENDA ATTACHED FOR ASSISTANCE IN COMPLETION OF FORM Q

### Bamboo House



D) Architect/Engineer/Sign Company Information (if not the applicant)
a. Sign Company Business Name: \( \text{LUCA SIGNS} \)
Business Name: ZUCH STENS  Contact Person: HUNG LE
Contact Person: HUNG LE Address 1286 DORCHESTER AVE, DORCHESTER, MA 02122
Telephone Number: 617-834-9311
b. Architect/Engineer (when applicable)
Business Name:
Contact Person:
Addiess
Telephone Number:
E) Work Summary
Summary of work to be done: SIEN 18" x 59"
a) FOR SIGN SUBMISSIONS ONLY: NINE (9) COPIES OF THE FOLLOWING MUST BE SUBMITTED WITH
APPLICATION
1. Drawing of Proposed Sign which must also include type of sign (wall, pylon etc.) colors
type of sign (wall, pylon etc.) colors size/dimensions materials style of lettering lighting-illuminated, non-illuminated and style
2. Drawing and/or pictures indicating location of new sign.
3. Picture of existing location and signs (if previously existing location)
b) FOR BUILDINGS/DEVELOPMENTS OR PROJECT SUBMISSIONS:
NINE (9) COPIES OF THE FOLLOWING MUST BE SUBMITTED W/APPLICATION
<ol> <li>Site Plan including Landscape Plan showing plantings. Plantings must be from Best Development Practices Guide</li> <li>Lighting Plan indicating lighting levels &amp; specifications of proposed lights</li> </ol>

- 3. Building drawings, indicating size and height of building(s); front, rear and side elevations (when there are no adjoining buildings) and floor plans
- 4. Drawings or pictures of existing conditions
- 5. If any signage on the building or site, provide information from above Signage Checklist

Note: Please bring a sample of the following to the meeting: materials samples (brick, siding, roofing etc.) as well as samples of paint colors.

### FORM Q

### TOWN OF FRANKLIN DESIGN REVIEW APPLICATION FOR §185-31(2) OF THE ZONING BY-LAW

A) General Information		
Name of Business or Project: Engine Ya	ard	
Property Address 40 Alpine Row		
Assessors' Map # 279Parce	el # <u>181</u>	
Zoning District (select applicable zone):	Downtown Commercial	
Zoning History: Use Variance N/A Non-Conforming Use		
B) Applicant Information:		
Applicant Name: Walker Development &	& Construction Management, Inc.	
Address: 5 Mount Royal Avenue Marlborough MA 01752		
Telephone Number: <u>978-443-3600</u>		
Contact Person: <u>Jeffrey Walker</u>		
C) Owner Information (Business Own	ner & Property Owner if different)	
Business Owner:Landscape Network LLO Address: 99 Highland Street Franklin MA	CProperty Owner: <u>Same</u>	
All of the information is submitted according Executed as a sealed instrument this	ding to the best of my knowledge day of 20	
Signature of Applicant	Signature of Owner	
Jeff Walker	Michael Lang	
Print name of Applicant	Print name of Owner	

\*FOR SIGNS COMPLETE PAGES 1 & 2 ONLY. FOR SITE PLANS, BUILDING PLANS, PROJECTS, COMPLETE PAGES 1 – 4

SEE ADDENDA ATTACHED FOR ASSISTANCE IN COMPLETION OF FORM Q

### D) Architect/Engineer/Sign Company Information (if not the applicant) a. Sign Company Business Name: Signs by Cam Contact Person: Cam Afonso Address 837 Upper Union st Suite C-18 Telephone Number 508-364-2905 b. Architect/Engineer (when applicable) Business Name: Joe the Architect LLC Contact Person: Alberto Cabre Address 343 Medford Street 4C, Somerville MA 02145 Telephone Number: 617-764-3593 E) Work Summary Summary of work to be done: Street level commercial and 28 residential units above street level

### F) Information & Materials to be Submitted with Application

### a) FOR SIGN SUBMISSIONS ONLY:

### NINE (9) COPIES OF THE FOLLOWING MUST BE SUBMITTED WITH APPLICATION

1. Drawing of Proposed Sign which must also include

type of sign (wall, pylon etc.) colors size/dimensions materials

style of lettering lighting-illuminated, non-illuminated and style

- 2. Drawing and/or pictures indicating location of new sign.
- **3.** Picture of existing location and signs (if previously existing location)

### b) FOR BUILDINGS/DEVELOPMENTS OR PROJECT SUBMISSIONS:

### NINE (9) COPIES OF THE FOLLOWING MUST BE SUBMITTED W/APPLICATION

- 1. Site Plan including Landscape Plan showing plantings. Plantings must be from Best Development Practices Guide
- 2. Lighting Plan indicating lighting levels & specifications of proposed lights
- **3.** Building drawings, indicating size and height of building(s); front, rear and side elevations (when there are no adjoining buildings) and floor plans
- **4.** Drawings or pictures of existing conditions
- 5. If any signage on the building or site, provide information from above Signage Checklist

Note: Please bring a sample of the following to the meeting: materials samples (brick, siding, roofingetc.) as well as samples of paint colors.

### **DESIGN STANDARDS**

Explain how each of the design standards outlined below has been incorporated into the design of the proposed development. Fill in the information in the spaces provided or use a separate sheet.

We fall within	the height restrictions of the town's height requirement.
windows shall	ons of Windows and Doors – The proportions and relationships between doors and ll be compatible with the architectural style and character of the surrounding area. In and aesthetically follow a new England style the works with Franklin's down town
between it an	of Building Masses and Spaces – The relationship of a structure to the open space d adjoining structures shall be compatible.
Building mass	favors the street front and provides privacy in the rear and promotes pedestrian walkability. It med
The open	space requirements of the town.
character of the	<b>pe</b> – The design and pitch of the roof shall be compatible with the architectural style as the surrounding buildings
Proposed roof t	type matches flat roof style of the downtown district.
the curroundi	ne scale of the structure shall be compatible with its architectural style and the character ng buildings
Designed to fit	into the topography of the site and fits within the towns scale requirements.
with regard to	Line, Shape & Profile – Facades shall blend with other structures in the surrounding at the dominant vertical or horizontal context:  the same or similar styles to the down town district
be treated so	ural Details – Architectural details, including signs, materials, colors and textures sha as to be compatible with the existing and adjacent architectural character, thereby ad enhancing the surround area.

8. <b>Advertising Features</b> – The size, location, design, color, texture, lighting and materials of all
permanent signs and outdoor advertising structures shall not detract from the use and enjoyment of the
proposed buildings and structures and the surrounding properties
Commercial and tenant signage to be designed to the town guidelines, The residential signage uis not lit only the
commercial building has minimal lighting
9. <b>Heritage</b> – Removal or disruption of historic, traditional or significant uses, structures or
architectural elements shall be minimized insofar as practicable. There is no existing historical
significance to this site, However the site in the 1800's was a engine Yard. The proposed building
will have character to the past use
10. <b>Energy Efficiency</b> – To the maximum extent reasonably practicable, proposals shall utilize energy-efficient technology and renewable energy resources and shall adhere to the principles of energy-conscious design with regard to orientation, building materials, shading, landscaping and other elements. The land scape and building envelope will be in compliance to the energy code and standards the fixtures will promote water conservation as well as the site drainage will maximize re charge to the site
11. <b>Landscape</b> - The landscape should improve the character and appearance of the surrounding area
and parking areas should be located to the side or rear of buildings when reasonably possible.
the parking is in the rear in keeping with the down town commercial district zoning and all the landscaping species match
The best development practices and the design review guidelines. The planting design promotes a walkability to the down
town as well as promotes the buildings aesthetics

SEE ADDENDA ATTACHED FOR INSTRUCTIONS TO ASSIST IN COMPLETING APPLICATION.

### **ADDENDA**

### INSTRUCTIONS FOR COMPLETION OF FORM Q-DESIGN REVIEW APPLICATION

- A. General Information
  - Please list name of Business as it will appear on sign or name of project or development, as the case may be, as well as the property address
  - Assessors' Map & Parcel numbers may be obtained from tax bill, Town website
     <a href="https://www.franklin.ma.us/Town/Assessors/PropertyTax">www.franklin.ma.us/Town/Assessors/PropertyTax</a> or from the computer located outside the Assessor's Office, first floor, Municipal Building, 355 East Central Street.
  - Zoning District and Zoning History information may be obtained at the Building Department, 1<sup>st</sup> floor, Municipal Building
- B. Applicant Information complete and include name of contact person w/ phone number
- C. Owner Information if business owner and property owner are not the same, please include information for both. If signage is within a shopping plaza—obtain letter of approval of sign changes from plaza owner.

### Page 2 –

- D. Architect/Engineer or Sign Company Information:
  - Signs only Name of Sign Company and Contact Person
  - Developments & Projects Engineer and Architect Information as well
- E. Work Summary: Include brief summation of work to be

### donePages 3 & 4

- F. Information & Materials to be Submitted w/Application
  - a) SIGNS ONLY -
    - Nine (9) Copies of sign drawings and photos, which include information listed on Page 2 of the application
  - b) SITE PLAN APPLICATIONS FOR BUILDINGS/DEVELOPMENTS/PROJECTS.
    - Nine (9) Copies of all plans including information listed on Page 2 of application.
    - Please bring samples of siding and roofing materials and paint color samples to the meeting when scheduled.

<u>**DESIGN STANDARDS**</u> – For Buildings/Projects and Developments, please complete Pages 3 and 4 as they apply to your project.

ALL APPLICATIONS WITH NINE (9) COPIES OF SUPPLEMENTARY INFORMATION MUST BE FILED BY CLOSE OF BUSINESS ON WEDNESDAY PRIOR TO THE FOLLOWING TUESDAY MEETING. MEETINGS ARE GENERALLY TWICE A MONTH THE  $2^{\rm ND}$  &  $4^{\rm TH}$  TUESDAY OF THE MONTH.

FOR SIGN APPLICATIONS ONLY, YOU NEED ONLY COMPLETE PAGES 1 & 2 OFAPPLICATION.

### THE ENGINE YARD



40 ALPINE ROW FRANKLIN, MA 02038

### WALKER DEVELOPMENT

PROJECT NUMBER: 440

FOR ZONING DATE: 06/23/2021

### INDEX OF DRAWINGS

	SHEET LIST
Sheet Number	Sheet Name
A000	COVER SHEET
C-1.0	EXISTING CONDITIONS
C-2.0	LAYOUT & MATERIALS
C-3.0	GRADING & UTILITIES
C-3.1	EROSION CONTROL
C-4.0	TYPICAL DETAILS
C-4.1	TYPICAL DETAILS
LA-01	SITE LANDSCAPE PLAN
LA-02	SITE LANDSCAPE DETAILS
LA-03	SITE LANDSCAPE DETAILS
LA-04	SITE LANDSCAPE PLAN IMAGERY
AL001	SITE LIGHTING PHOTOMETRICS
A007	EXISTING SITE CONTEXT IMAGES
A031	EXISTING BUILDING ELEVATIONS
A200	EXTERNAL ELEVATIONS
A201	EXTERNAL ELEVATIONS
A202	EXTERNAL ELEVATIONS
A210	EXTERNAL SIGNAGE
A910	PROPOSED BUILDING RENDERINGS

WARNING:

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3. to the extent permitted by law, all conditions and warranties concerning this document or any use to which they may be put (whether as to quality, outcome, fitness, care, skill or otherwise) whether express or implied by statute, common law, equity, trade, custom or usage or

otherwise are expressly excluded.


4. any person using or relying document releases and indemnifies and will keep indemnified Joe The Architect LLC against all claims, liabilities, loss, costs and expenses arising directly or indirectly out of or in connection with such use or reliance including without limitation any misrepresentation, error or defect in this document.


Contractors to use Architectural drawings for set out.
Contractors to check and verify all Dimensions on Site prior to Construction/Fabrication. Figured Dimensions take precedence over Scaled Dimensions. Any discrepancies should be immediately referred to the Architect. All work to comply with I.B.C. Statutory Authorities and relevant


JOE THE ARCHITECT
343 Medford Street, Suite 4C Somerville, MA 02145
t: +1(617) 764-3593
e: askjoe@joethearchitect.com

t: +1(617) 764-3 e: askjoe@joetf www.joethearch

LEGEND  EXISTING PROPOSED	
CONTOUR — 100 1. EXISTING CONDITIONS WERE OBTAINED FROM PLANS PREPARED BY GUERRIERE & HALNON,  STORM DRAIN — 100 1. EXISTING CONDITIONS WERE OBTAINED FROM PLANS PREPARED BY GUERRIERE & HALNON,  INC. FRANKLIN, MA, ENTITLED "SITE PLAN AND SPECIAL PERMIT, AS—BUILT BREWING, 40  ALPINE ROW, FRANKLIN, MASSACHUSETTS" DATED MAY 6, 2019, AS AMENDED JULY 12, 2019.	NO DATE REVISIONS  1 06/21/2021 PERMIT SUBMISSION
WATER WATER ALPINE ROW, FRANKLIN, MASSACHUSETIS DATED MAY 6, 2019, AS AMENDED JULY 12, 2019.	
SYSTEM IN ALPINE PRIOR TO CROSSING THE PROPERTY. THE EXISTING CB'S WE UTILIZED AS	
A "KNOWN" FOR PURPOSES OF THIS INVESTIGATION.  S — SANITARY SEWER ————— 2. THE LOCATION OF EXISTING UTILITIES IS APPROXIMATE, THE CONTRACTOR SHALL VERIFY THE	
HYDRANT NOTIFY  "DIG-SAFE" AT 1-888-344-7233 AT LEAST 72 HOURS PRIOR TO ANY SITE DEMOLITION OR  SEWER MANHOLE START OF CONSTRUCTION. NOTIFY  EXCAVATION.	
© DRAIN MANHOLE   ✓ VALVE	
CURB	
429x5 SPOT GRADE 429.5 HP RAMP	
SEDIMENTATION x X CONTROL BARRIER	SEAL 6/21/202)
□ LIGHT POLE     □ TREE     □ UTILITY POLE	DANIEL R. CAMPBELL CIVIL
POST INDICATOR VALVE PRV  TRAFFIC DIRECTION	No. 46245
TRAFFIC BIRCOTION ————————————————————————————————————	TONAL EN CO
	DATE : JUNE 21, 2021  DRAWN : DRC  SCALE : 1" = 20'
RAIL ROAD BASELINE	
<u> </u>	
MASSACHUSETTS BAY TRANSPORTATION	
AN PLBK.252 PL.804A,B  Qu. Pole  Qu. Pole	
X X X X X X X X X X X X X X X X X X X	
(set)	ting Containment Walls
1st Floor=305.47  AREA= 6,061± SF.  Existing   Containment   Walls   St.   St.	S S S S S S S S S S S S S S S S S S S
CONVERTED COMMERCIAL USE  1st Floor=304.94    304.7   303.1	
302.41 APEA-57.500+CE	
No. 40  No. 40	
O. Wells 303.99  Solution	
## 306.20  1" PEX WATER LINE  1" PEX WATER LINE  1" PEX WATER LINE  1" PEX WATER LINE  296.18  296.18  296.18  296.18	
ONE W. 302.99	
ALPINIC -	PERTIES LLC FRANKLIN PROPERTIES LL PROPERTIES LL
INH H DINH 80 COT. 299 COT. 29	
LINH H. DINH & TOP OF Wall=302.08  305.6  TOP OF Wall=302.08  305.6  TOP OF Wall=302.08  305.6  TOP OF Wall=302.08  307.63  SOLUTION TOP OF Wall=302.08  307.63  SOLUTION TOP OF Wall=302.08  307.63  SOLUTION TOP OF Wall=302.08	
T LE HANH  No.35  N/F  ALPINE ROW, LLC  SO2.30  ALPINE ROW, LLC  SO2.30  SO3.63  SO3.6	No.68
T LE HANH  No.35  N/F  ALPINE ROW, LLC  SO2.79  No.64	
T LE HANH  No.35  LE HANH  No.35  ALPINE ROW, LLC  TO SOLUTION  SO	COMME PARCE 40 ALPI FRANK
T LE HANH  No.35  N/F  ALPINE ROW, LLC  N/F  GERALD F. NEWELL  SOLUTION  SOL	PARC FRAN
No.35 No.41  No.35 No.41  No.35 No.64  No.41  No.64  No.65  No.64  No.66  No.64  No.64  No.64  No.64  No.66  No.66	LEVEL SIGN GROUP CIVIL ENGINEERING / LAND SURVEYING
No. 35  No. 35  No. 35  No. 36  No. 36  No. 36  No. 36  No. 37  No. 30  No. 36  No. 37  No. 38  No. 30  No. 30	LEVEL SIGN GROUP CIVIL ENGINEERING / LAND SURVEYING
T LE HANH  No.35  NF  ALPINE ROW, LLC  NO.41  NO.40  NO.40	DESIGN GROUP CIVIL ENGINEERING / LAND SURVEYING 249 SOUTH STREET UNIT 1 PLAINVILLE, MA 02762 TEL. (508) 695-2221 FAX. (508) 695-2219
ALPINE PLACE  No.40  SEE HANH  NO.40  NO.40  SEE HANH  NO	LEVEL SIGN GROUP CIVIL ENGINEERING / LAND SURVEYING
NO. 40  NO. 67  NO. 67  NO. 67  NO. 67  NO. 67	LEVEL  DESIGN GROUP  CIVIL ENGINEERING / LAND SURVEYING  249 SOUTH STREET  UNIT 1  PLAINVILLE, MA 02762  TEL. (508) 695-2221 FAX. (508) 695-2219  EXISTING  CONDITIONS
NO.35  ALFORE ROW, LLC  NO.41  GERALD F. NEWELL  STEPHAN M. ACCAD  NO.67  NO.66	EXISTING CONDITIONS  EXISTING CONDITIONS
NE ALPINE ROW, LLC  NO. 40  CERALD F. NEWELL  SOCIETY OF THE PLACE  NO. 40  STEPHAN M. ACCAD  NO. 67  NO. 67	LEVEL  DESIGN GROUP  CIVIL ENGINEERING / LAND SURVEYING  249 SOUTH STREET  UNIT 1  PLAINVILLE, MA 02762  TEL. (508) 695-2221 FAX. (508) 695-2219  EXISTING  CONDITIONS
NATE OF THE PLACE  NO.41  STEPHAN M. ACCAD  NO.62  NO.63  NO.64  NO.65  NO.66	EVEL  Design group CIVIL ENGINEERING / LAND SURVEYING 249 SOUTH STREET UNIT 1 PLAINVILLE, MA 02762 TEL. (508) 695-2221 FAX. (508) 695-2219  EXISTING CONDITIONS  TO SHEET 2 OF 7

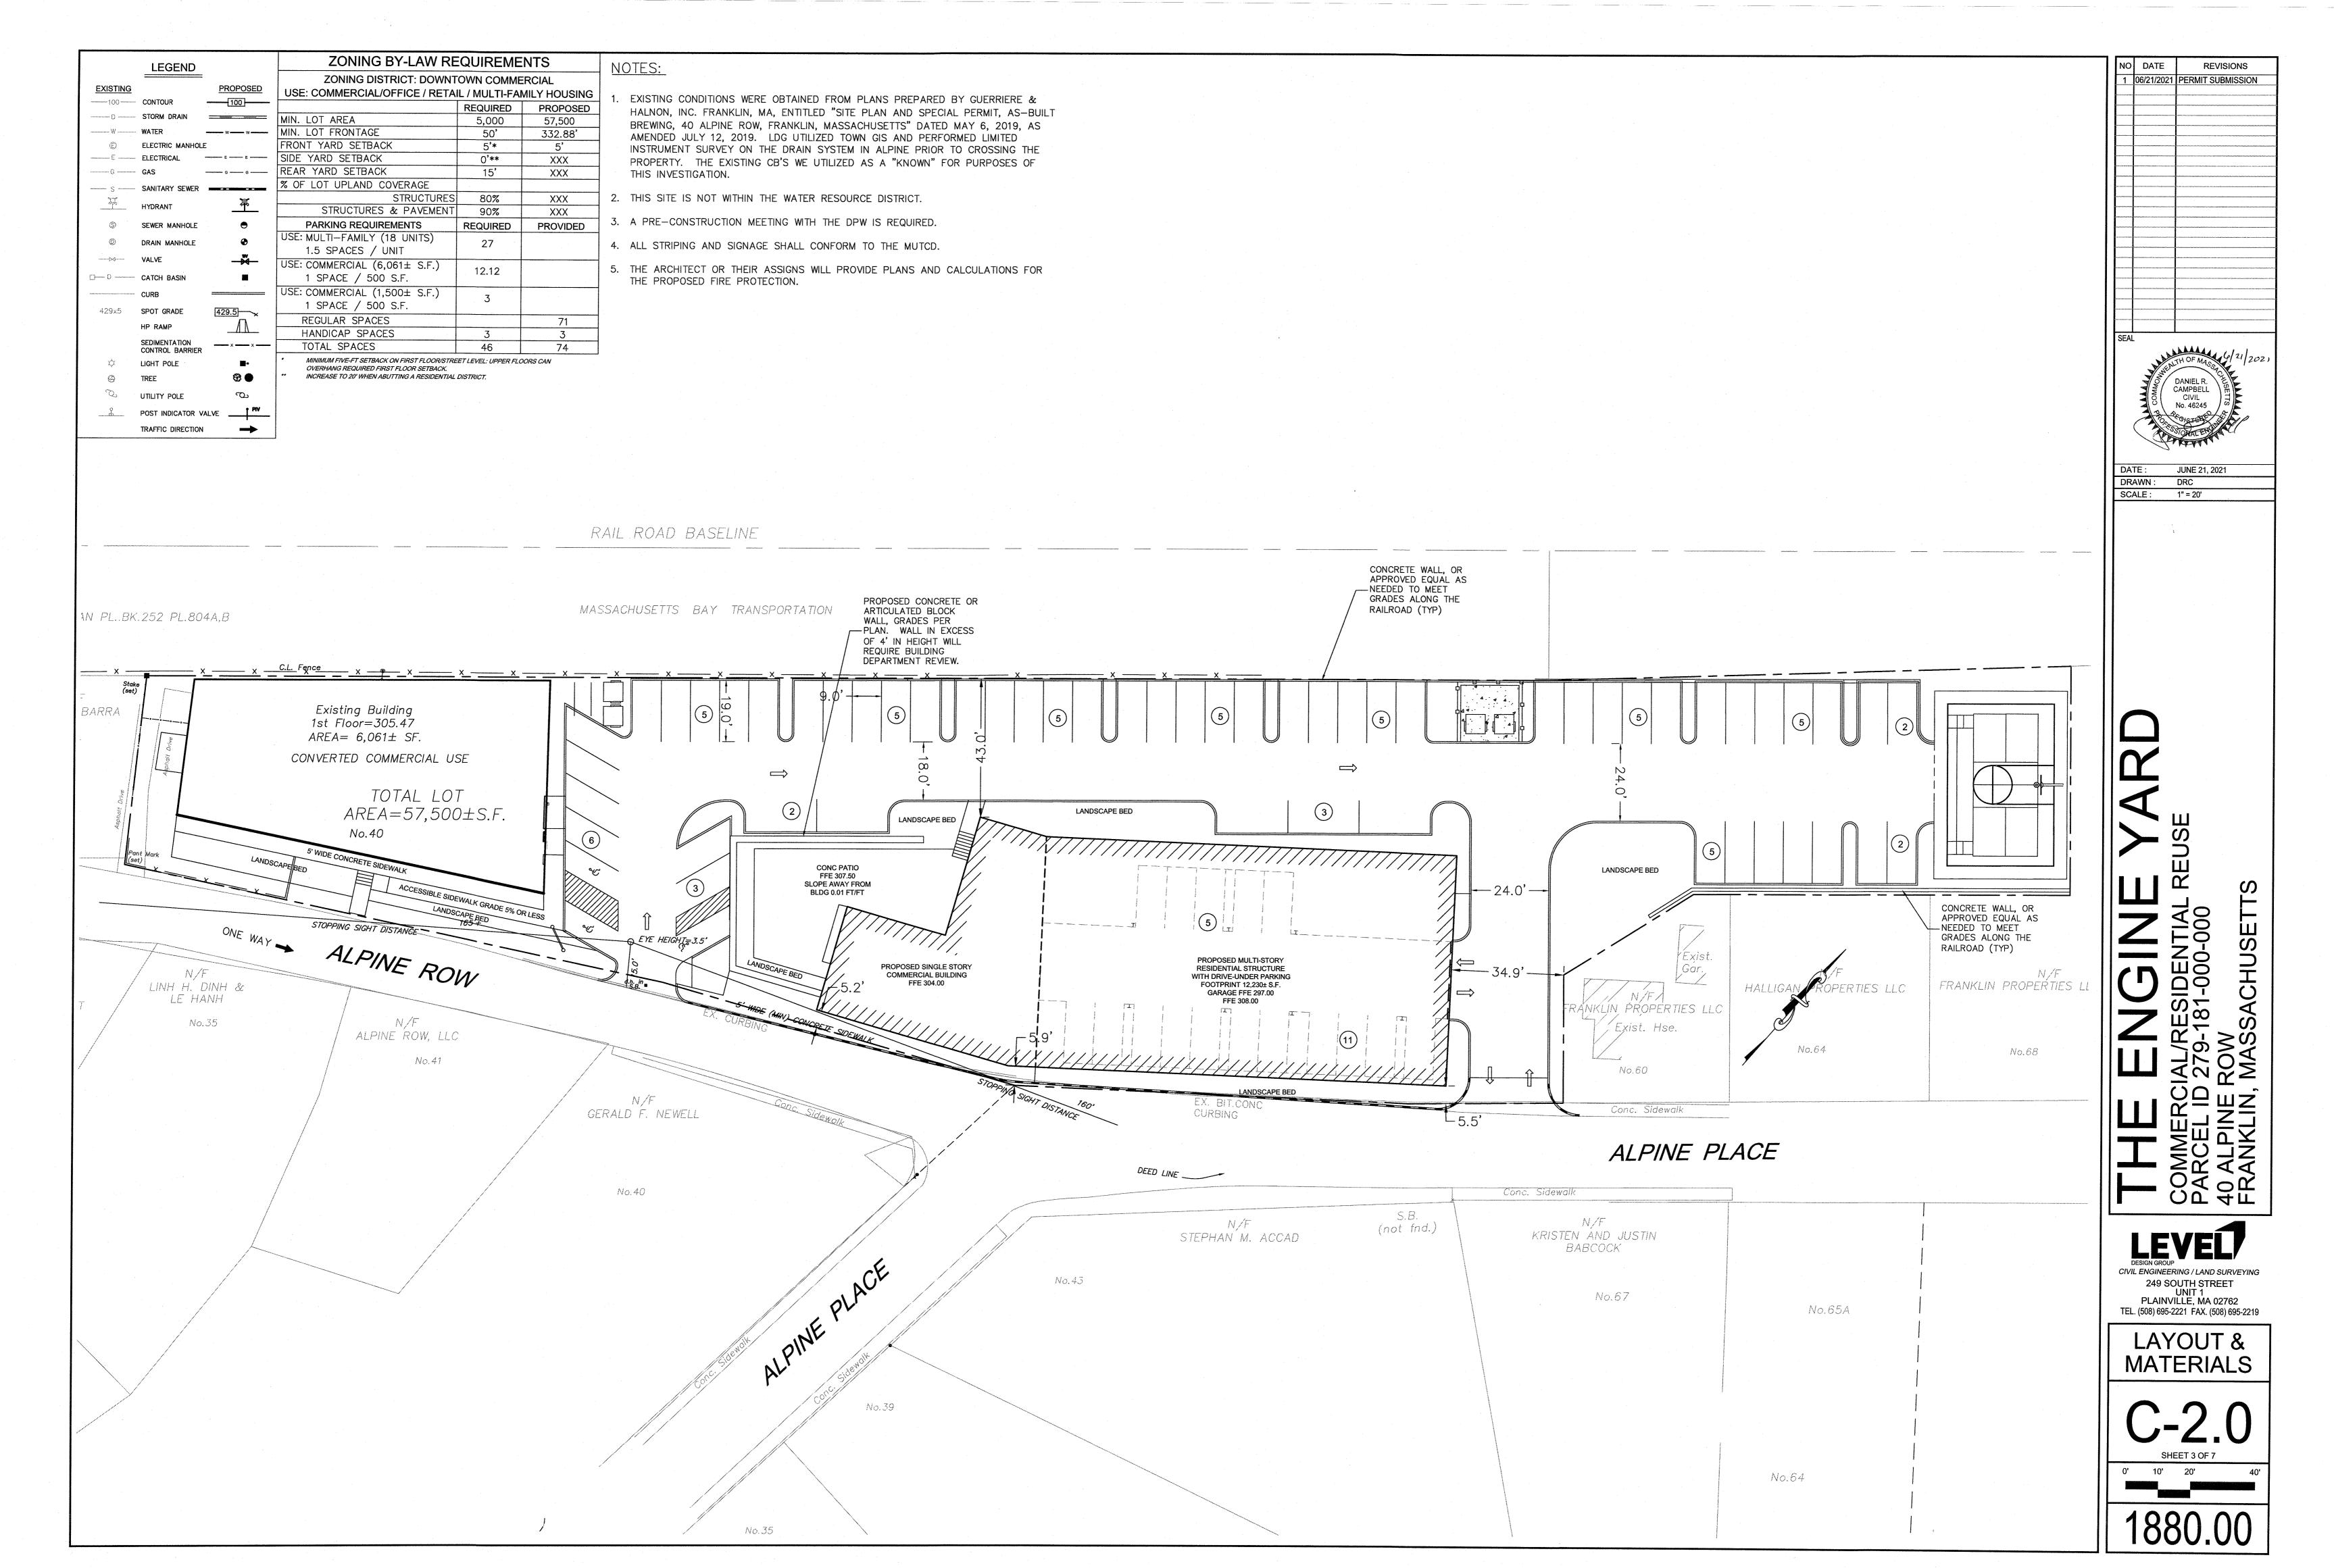

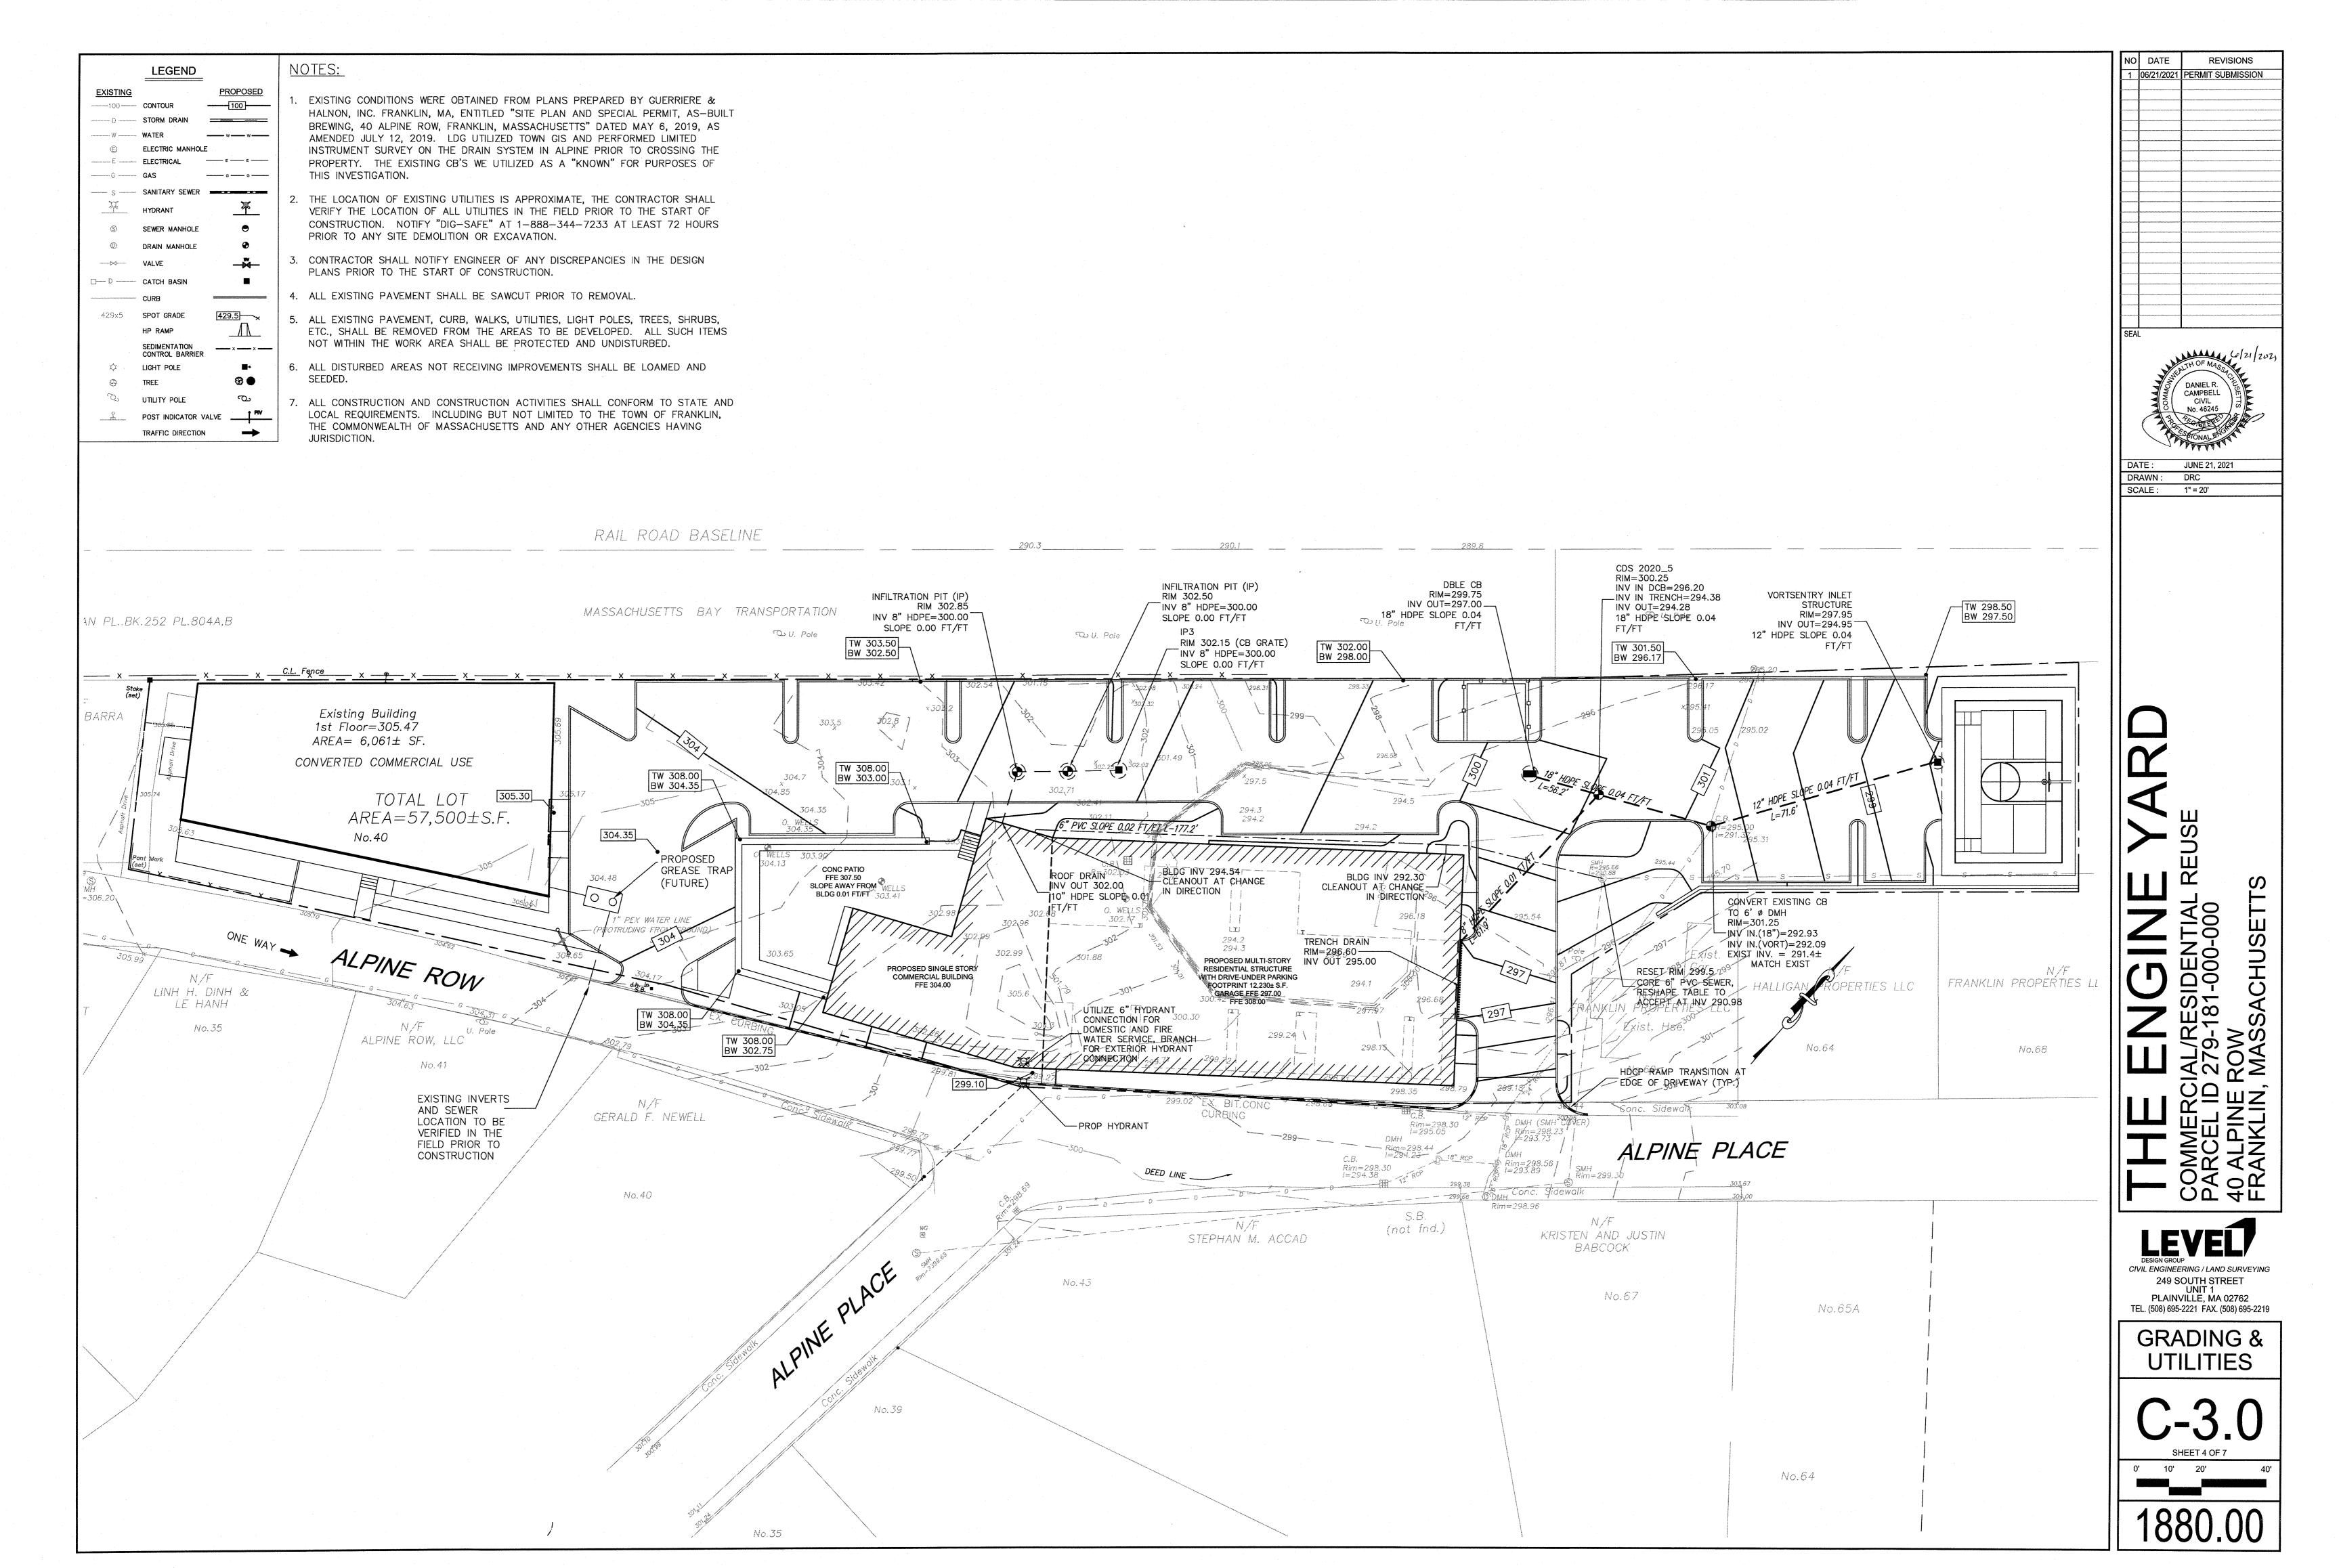

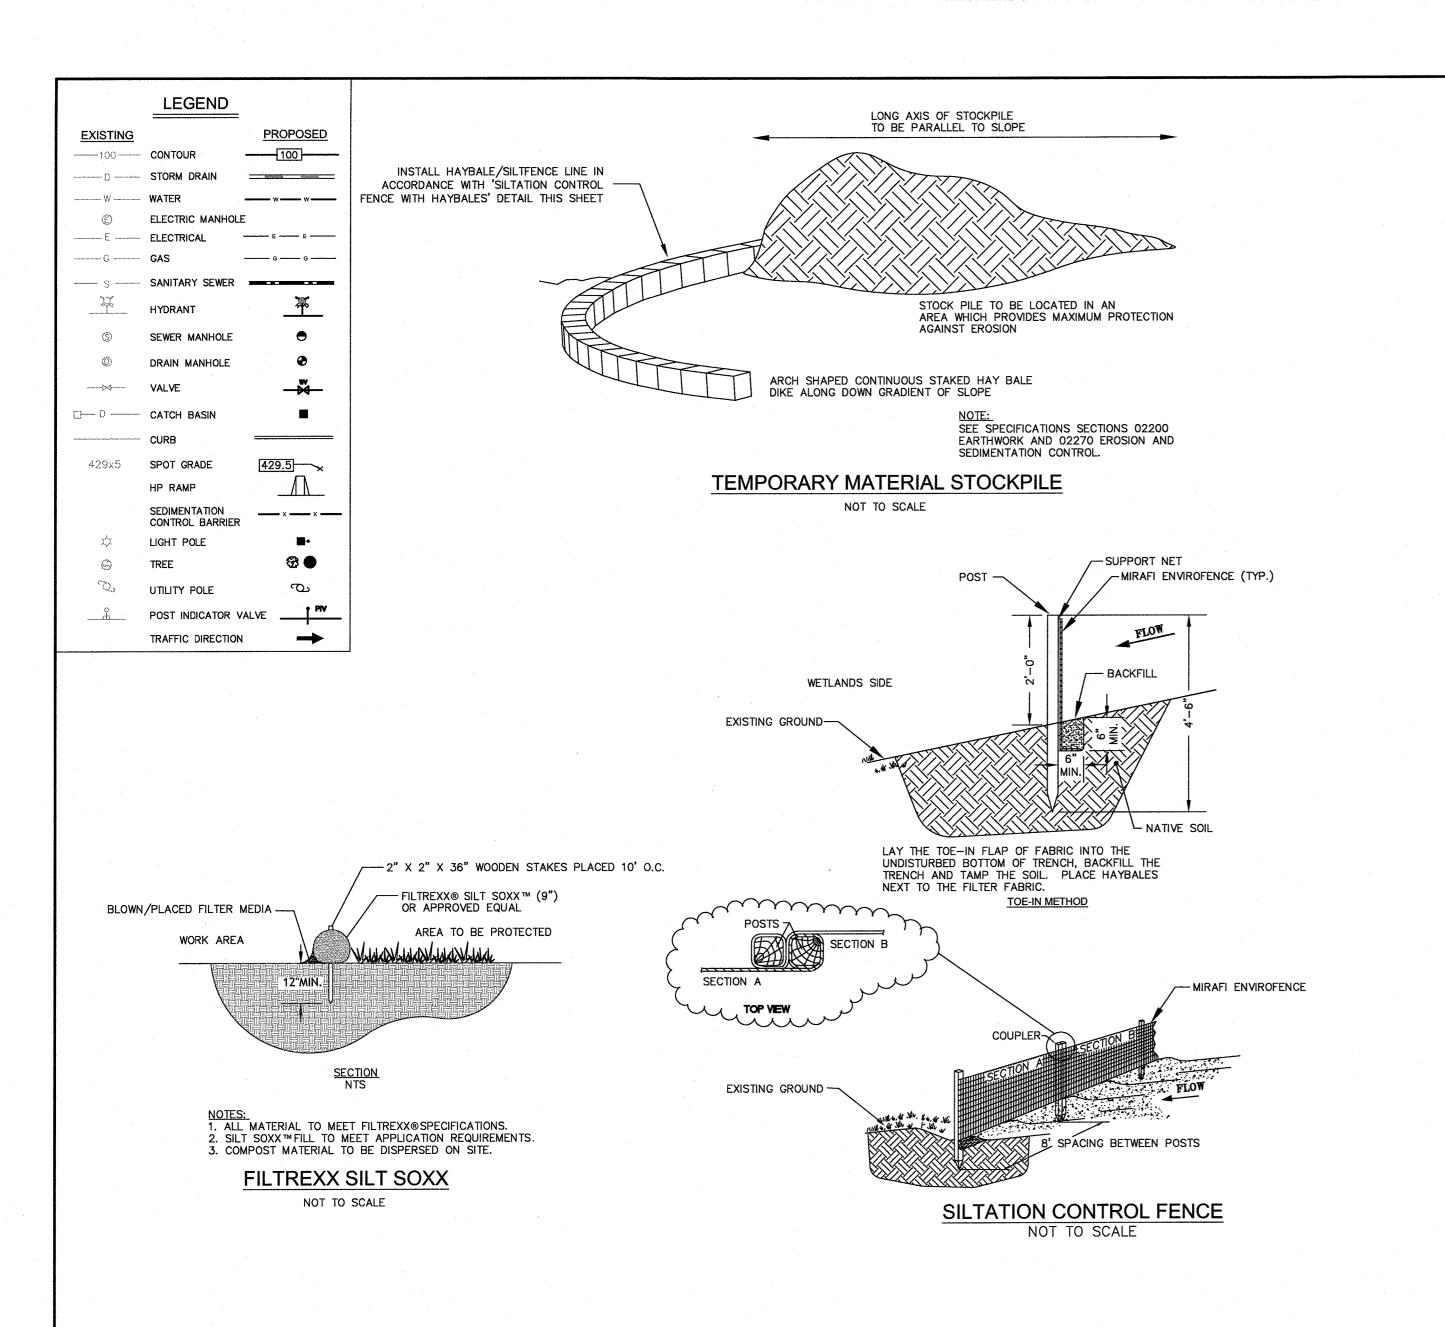


RAIL ROAD BASELINE

GENERAL NOTES:

- REFER TO SHEET C-1.0 FOR EXISTING CONDITIONS AND PROPERTY BOUNDARY NOTES.
- REFER TO SHEET C-2.0 FOR CONSTRUCTION SEQUENCE AND NOTES.

2 % OR GREATER

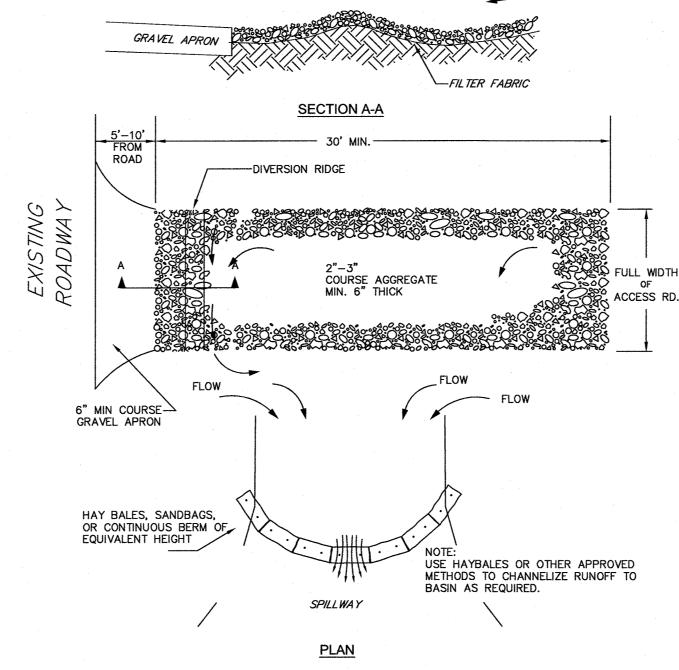

DIVERSION RIDGE REQUIRED

WHERE GRADE EXCEEDS 2%

NOTES:

1. THE ENTRANCE SHALL BE MAINTAINED IN A CONDITIONS THAT WILL PREVENT TRACKING OR FLOWING OF SEDIMENT ONTO PUBLIC RIGHT—OF—WAYS. THIS MAY REQUIRE TOP DRESSING, REPAIR AND/OR CLEANOUT OF ANY MEASURES USED TO TRAP SEDIMENT.

2. WHEN NECESSARY, WHEELS SHALL BE CLEANED PRIOR TO ENTRANCE ONTO PUBLIC RIGHT-OF-WAY.

3. WHEN WASHING IS REQUIRED IT SHALL BE DONE ON AN AREA STABILIZED WITH CRUSHED STONE WHICH DRAINS TO AN APPROVED SEDIMENT TRAP OR

TEMPORARY CONSTRUCTION
ENTRANCE/EXIT DETAIL
NOT TO SCALE

SILTFENCE ALONG RAILROAD 9" COMPOST SOCK MASSACHUSETTS BAY TRANSPORTATION N PL..BK.252 PL.804A,B TW 302.00 BW 298.00 TW 301.50 BW 296.17 Existing Building 1st Floor=305.47 BARRA AREA= 6,061± SF. CONVERTED COMMERCIAL USE TW 308.00 BW 304.35 TOTAL LOT 305.30  $AREA = 57,500 \pm S.F.$ ALPINE ROW FRANKLIN PROPERTIES LLC OPERTIES LLC N/F No.35 ALPINE ROW, LLC No.68 GERALD F. NEWELL SILT SACK (TYP.) ALPINE PLACE (not fnd.) KRISTEN AND JUSTIN STEPHAN M. ACCAD BABCOCK No.65A

### **EROSION CONTROL NOTES**

SILTATION CONTROL USING EROSION CONTROL FENCE WITH STRAW WATTLE, OR APPROVED EQUEROSION CONTROL LINE IS TO BE VISUALLY INSPECTED AFTER EVERY RAIN FALL AND REPAIRS MAD AS REQUIRED TO THE SILTATION CONTROL FENCE AND STRAW WATTLE AFTER EACH RAIN FALL. CLEANOUT OF ACCUMULATED SEDIMENT BEHIND THE WATTLE IS NECESSARY IF ½ OF THE ORIGINAL HEIGHT OF THE WATTLE APPEARS TO HAVE BEEN INUNDATED WITH SEDIMENT.

### PRESERVE TOPSOIL

SITE OWNERS AND OPERATORS MUST PRESERVE EXISTING TOPSOIL ON THE CONSTRUCTION SITE TO MAXIMUM EXTENT FEASIBLE AND AS NECESSARY TO SUPPORT HEALTHY VEGETATION, PROMOTE SOIL STABILIZATION, AND INCREASE STORMWATER INFILTRATION RATES IN THE POST—CONSTRUCTION PHAS OF THE PROJECT.

### STABILIZATION OF SOILS

UPON COMPLETION AND ACCEPTANCE OF SITE PREPARATION AND INITIAL INSTALLATION OF EROSION, RUNOFF, AND SEDIMENT CONTROLS AND TEMPORARY POLLUTION PREVENTION MEASURES, THE OPERATOR SHALL INITIATE APPROPRIATE TEMPORARY OR PERMANENT STABILIZATION PRACTICES DURING ALL PHASES OF CONSTRUCTION ON ALL DISTURBED AREAS AS SOON AS POSSIBLE, BUT NO MORE THAN FOURTEEN (14) DAYS AFTER THE CONSTRUCTION ACTIVITY IN THAT AREA HAS TEMPORARILY OR PERMANENTLY CEASED. SLOPES IN EXCESS OF 3:1 SHALL HAVE 22 MONTH EROSIC CONTROL FABRIC INSTALLED OVER A SLOPE MIX SEED MIX WITH TACKIFIER UNLESS OTHERWISE SPECIFIED.

ANY DISTURBED AREAS THAT WILL NOT HAVE ACTIVE CONSTRUCTION ACTIVITY OCCURRING WITHIN 14 DAYS MUST BE STABILIZED USING THE CONTROL MEASURES DEPICTED IN SITE PLANS, IN ACCORDANCE WITH THE STORMWATER POLLUTION PREVENTION PLAN, AND PER MANUFACTURER PRODUCT SPECIFICATIONS.

ONLY AREAS THAT CAN BE REASONABLY EXPECTED TO HAVE ACTIVE CONSTRUCTION WORK BEING PERFORMED WITHIN 14 DAYS OF DISTURBANCE WILL BE CLEARED/GRUBBED AT ANY ONE TIME. IT IS NOT ACCEPTABLE TO CLEAR AND GRUB THE ENTIRE CONSTRUCTION SITE IF PORTIONS WILL NOT BE ACTIVE WITHIN THE 14-DAY TIME FRAME. PROPER PHASING OF CLEARING AND GRUBBING ACTIVITIES SHALL INCLUDE TEMPORARY STABILIZATION TECHNIQUES FOR AREAS CLEARED AND GRUBBED THAT WILL NOT BE ACTIVE WITHIN THE 14-DAY TIME FRAME.

### STORMWATER INLET PROTECTION

INLET PROTECTION — WILL BE UTILIZED TO PREVENT SOIL AND DEBRIS FROM ENTERING STORM DRAIN INLETS AND SHALL BE INSTALLED WITHIN BASINS DOWNSTREAM OF DISTURBANCE WITHIN 200' OF THE PROPOSED DISTURBANCE. THESE MEASURES ARE USUALLY TEMPORARY AND ARE IMPLEMENTED BEFORE A SITE IS DISTURBED.

MAINTENANCE — THE OPERATOR MUST CLEAN, OR REMOVE AND REPLACE THE INLET PROTECTION MEASURES AS SEDIMENT ACCUMULATES, THE FILTER BECOMES CLOGGED, AND/OR AS PERFORMANCE IS COMPROMISED. ACCUMULATED SEDIMENT ADJACENT TO THE INLET PROTECTION MEASURES SHOULD BE REMOVED BY THE END OF THE SAME WORK DAY IN WHICH IT IS FOUND OR BY THE END OF THE FOLLOWING WORK DAY IF REMOVAL BY THE SAME WORK DAY IS NOT FEASIBLE.

STORMWATER BASINS — ALL AREAS CONTAINING STORMWATER BASINS (ABOVE OR BELOW GROUND) SHALL BE PROTECTED THROUGHOUT CONSTRUCTION. THESE ARES ARE NOT BE USED FOR MATERIAL STOCKPILES OR FOR PARKING EQUIPMENT. SURFACE BASINS ARE TO BE ROUGH GRADED AND PROTECTED UNTIL STABILIZED AND BROUGHT ON—LINE FOR STORMWATER MANAGEMENT OF THE STABILIZED SITE.

### ONSTRUCTION ENTRANCES

CONSTRUCTION ENTRANCES SHALL BE USED IN CONJUNCTION WITH THE STABILIZATION OF CONSTRUCTION ROADS TO REDUCE THE AMOUNT OF SEDIMENT TRACKING OFF THE PROJECT. ANY CONSTRUCTION SITE ACCESS POINT MUST EMPLOY THE CONTROL MEASURES ON THE APPROVED SITE PLANS AND IN ACCORDANCE WITH THE STORMWATER POLLUTION PREVENTION PLAN. CONSTRUCTION ENTRANCES SHALL BE USED IN CONJUNCTION WITH THE STABILIZATION OF CONSTRUCTION ROADS TO REDUCE THE AMOUNT OF MUD PICKED UP BY CONSTRUCTION VEHICLES. ALL CONSTRUCTION ACCESS ROADS SHALL BE CONSTRUCTED PRIOR TO ANY ROADWAY ACCEPTING CONSTRUCTION TRAFFIC.

THE SITE OWNER AND OPERATOR MUST WILL RESTRICT VEHICLE USE TO PROPERLY DESIGNATED EXIT POINTS, USE PROPERLY DESIGNED AND CONSTRUCTED CONSTRUCTION ENTRANCES AT ALL POINTS THAT EXIT ONTO PAVED ROADS SO THAT SEDIMENT REMOVAL OCCURS PRIOR TO VEHICLE EXIT. WHEN AND WHERE NECESSARY, USE ADDITIONAL CONTROLS TO REMOVE SEDIMENT FROM VEHICLE TIRES PRIOR TO EXIT (I.E. WHEEL WASHING RACKS, RUMBLE STRIPS, AND RATTLE PLATES). WHERE SEDIMENT HAS BEEN TRACKED OUT FROM THE CONSTRUCTION SITE ONTO THE SURFACE OF OFF—SITE STREETS, OTHER PAVED AREAS, AND SIDEWALKS, THE DEPOSITED SEDIMENT MUST BE REMOVED BY THE END OF THE SAME WORK DAY IN WHICH THE TRACK OUT OCCURS. TRACK—OUT MUST BE REMOVED BY SWEEPING, SHOVELING, OR VACUUMING THESE SURFACES, OR BY USING OTHER SIMILARLY EFFECTIVE MEANS OF SEDIMENT REMOVAL.

### STOCKPILE CONTAINMENT

SHALL BE USED ONSITE TO MINIMIZE OR ELIMINATE THE DISCHARGE OF SOIL, TOPSOIL, BASE MATERIAL OR RUBBLE, FROM ENTERING DRAINAGE SYSTEMS OR SURFACE WATERS. ALL STOCKPILES MUST BE LOCATED WITHIN THE LIMIT OF DISTURBANCE, PROTECTED FROM RUN—ON WITH THE USE OF TEMPORARY SEDIMENT BARRIERS AND PROVIDED WITH COVER OR STABILIZATION TO AVOID CONTACT WITH PRECIPITATION AND WIND WHERE AND WHEN PRACTICAL. STOCK PILE MANAGEMENT CONSISTS OF PROCEDURES AND PRACTICES DESIGNED TO MINIMIZE OR ELIMINATE THE DISCHARGE OF STOCKPILED MATERIAL (SOIL, TOPSOIL, BASE MATERIAL, RUBBLE) FROM ENTERING DRAINAGE SYSTEMS OR SURFACE WATERS.


FOR ANY STOCKPILES OR LAND CLEARING DEBRIS COMPOSED, IN WHOLE OR IN PART, OF SEDIMENT OR SOIL, YOU MUST COMPLY WITH THE FOLLOWING REQUIREMENTS — LOCATE PILES WITHIN THE DESIGNATED LIMITS OF DISTURBANCE OUTSIDE OF THE 100—FOOT BUFFER ZONE, PROTECT FROM CONTACT WITH STORMWATER (INCLUDING RUN—ON) USING A TEMPORARY PERIMETER SEDIMENT BARRIER; WHERE PRACTICABLE, PROVIDE COVER OR APPROPRIATE TEMPORARY VEGETATIVE OR STRUCTURAL STABILIZATION TO AVOID DIRECT CONTACT WITH PRECIPITATION OR TO MINIMIZE SEDIMENT DISCHARGE; NEVER HOSE DOWN OR SWEEP SOIL OR SEDIMENT ACCUMULATED ON PAVEMENT OR OTHER IMPERVIOUS SURFACES INTO ANY STORMWATER CONVEYANCE, STORM DRAIN INLET, OR SURFACE WATER; TO THE MAXIMUM EXTENT PRACTICABLE, CONTAIN AND SECURELY PROTECT FROM WIND.

### TEMPORARY SEDIMENT BASINS

IF REQUIRED, ADDITIONAL TEMPORARY SEDIMENT BASINS SHALL BE CONSTRUCTED TO MITIGATE THE POTENTIAL SEDIMENT LOADING TO THE ADJACENT RESOURCE AREAS. TEMPORARY SEDIMENT BASINS ARE TO BE LOCATED OUTSIDE OF THE 50—FOOT BUFFER ZONE TO THE BORDERING VEGETATED WETLANDS AND SHALL NOT BE LOCATED IN AN AREA WHERE AN INFILTRATION BASIN IS PROPOSED. TEMPORARY SEDIMENT BASIN GRADING LOCATION SHALL BE DICTATED BY THE DESIGN ENGINEER. AT A MINIMUM THE THE VOLUME OF THE TEMPORARY SEDIMENT BASIN, AS MEASURED FROM THE BOTTOM OF THE BASE TO THE ELEVATION OF THE CREST OF THE PRINCIPAL SPILLWAY SHALL BE AT LEAST 3,600 CUBIC FEET PER ACRE OF DRAINAGE AREA. THIS 3,600 CUBIC FEET IS EQUIVALENT TO 1.0 INCH OF SEDIMENT PER ACRE OF DRAINAGE AREA. ADDITIONAL STORAGE IN THE FORM OF A PERMANENT WET POOL SHALL BE PROVIDED WHENEVER PRACTICABLE, BUT MAY NOT BE USED TO FULFILL THE TEMPORARY STORAGE VOLUME REQUIREMENT.

SEDIMENT BASINS SHALL BE CLEANED OUT WHEN THE VOLUME REMAINING AS DESCRIBED ABOVE IS REDUCED BY SEDIMENTATION TO 1,800 CUBIC FEET PER ACRE OF DRAINAGE AREA (50 PERCENT FULL). IN NO CASE SHALL THE SEDIMENT LEVEL BE PERMITTED TO BUILD UP HIGHER THAN ONE FOOT BELOW THE PRINCIPAL SPILLWAY CREST. AT THIS ELEVATION, CLEANOUT SHALL BE PERFORMED TO RESTORE THE ORIGINAL DESIGN VOLUME TO THE SEDIMENT BASIN. THE ELEVATION OF THE MAXIMUM ALLOWABLE SEDIMENT LEVEL SHALL BE DETERMINED AND SHALL BE STATED IN THE DESIGN DATA AS A DISTANCE BELOW THE TOP OF THE RISER AND BE CLEARLY MARKED ON THE RISER. NO AREA OF DETENTION SHALL BE UTILIZED FOR TEMPORARY EROSION CONTROL OR DEWATERING ACTIVITIES.

	NO	DATE	REVISIONS
UAL	1	06/21/2021	PERMIT SUBMISSION
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DATE: JUNE 21, 2021

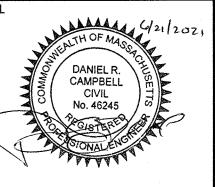DRAWN: DRC

SCALE: 1" = 20'

# E ENGINE YAR ERCIAL/RESIDENTIAL REUSE L ID 279-181-000-000

LEVEL DESIGN GROUP

CIVIL ENGINEERING / LAND SURVEYING 249 SOUTH STREET


PLAINVILLE, MA 02762
TEL. (508) 695-2221 FAX. (508) 695-2219

EROSION
CONTROL

C-3.1

SHEET 5 OF 7

1000 000

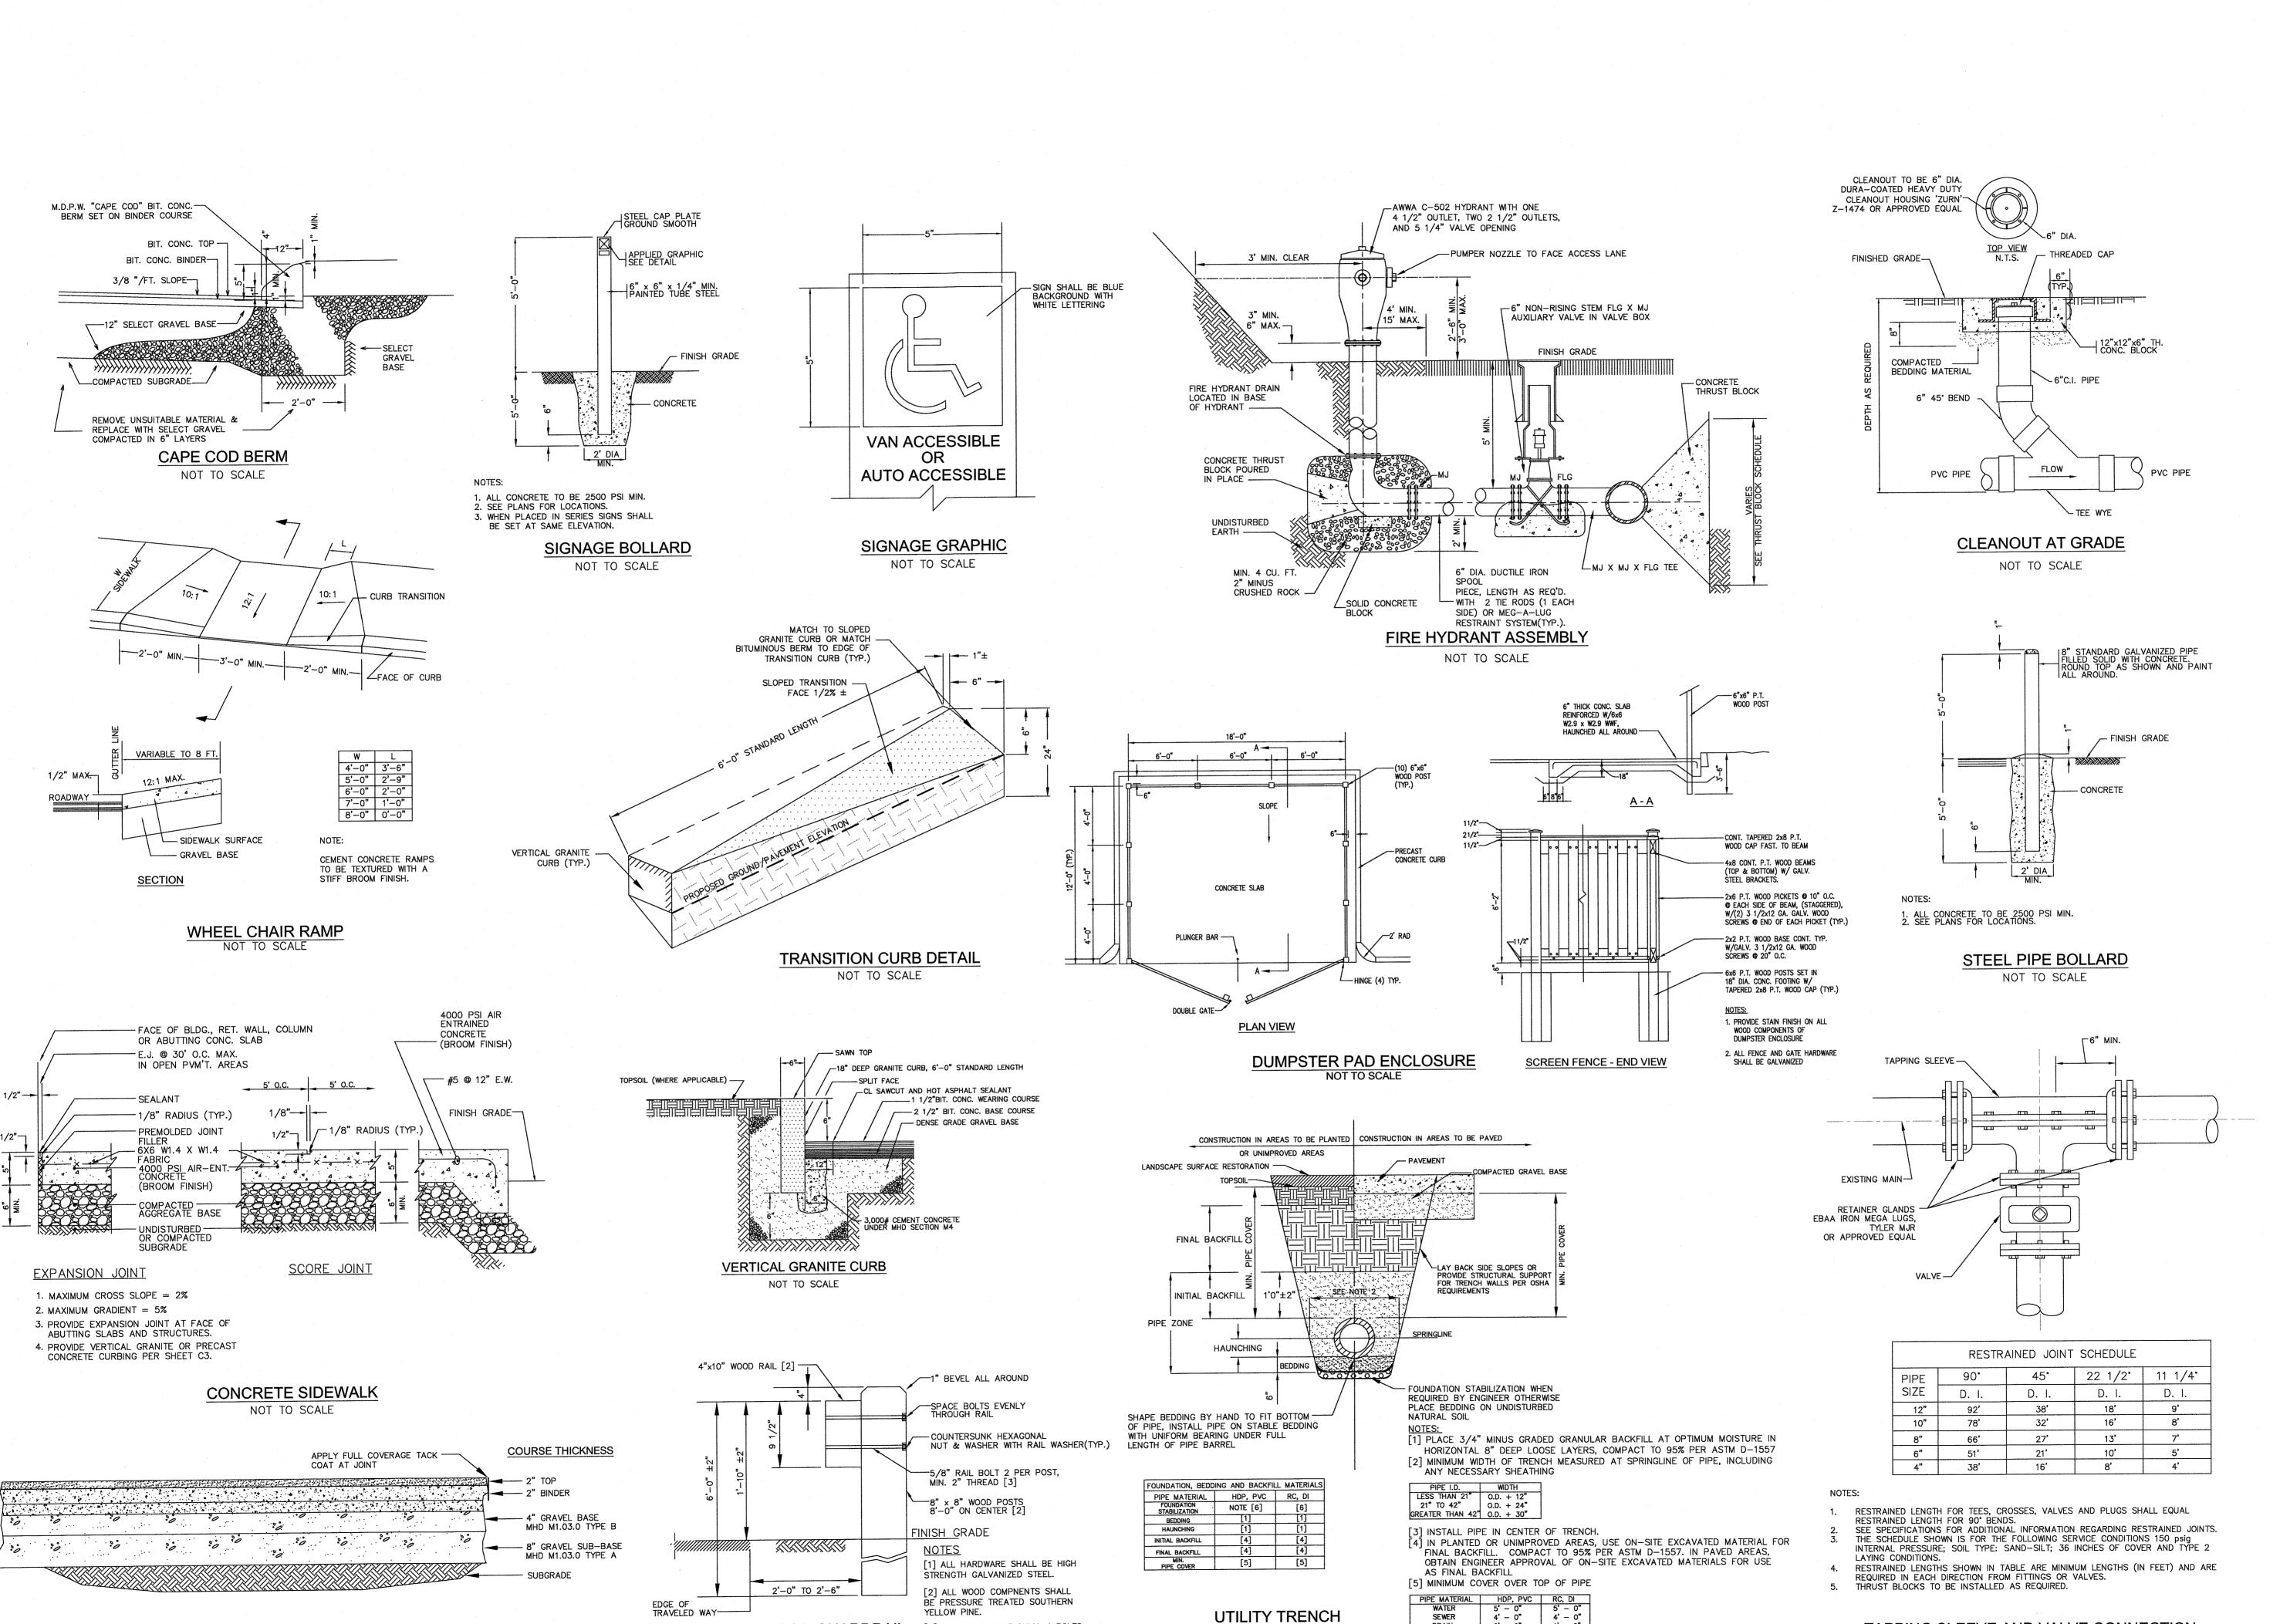

WOOD GUARDRAIL

NOT TO SCALE

TRUCK AREAS - BITUMINOUS CONCRETE PAVEMENT

NOT TO SCALE

[3] SPLICE AT POST ONLY, 4 BOLTS

EACH SPLICE POST.

CAMPBELL CIVIL No. 46245 DATE: JUNE 21, 2021 DRAWN: DRC SCALE: 1" = 20'

NO DATE

REVISIONS

1 06/21/2021 PERMIT SUBMISSION

O D CIVIL ENGINEERING / LAND SURVEYING

249 SOUTH STREET PLAINVILLE, MA 02762 TEL. (508) 695-2221 FAX. (508) 695-2219

**TYPICAL DETAILS** 

SHEET 6 OF 7


TAPPING SLEEVE AND VALVE CONNECTION NOT TO SCALE

4' - 0"

[6] FOR FOUNDATION STABILIZATION, USE 2" MINUS CRUSHED STONE

SEWER

NOT TO SCALE

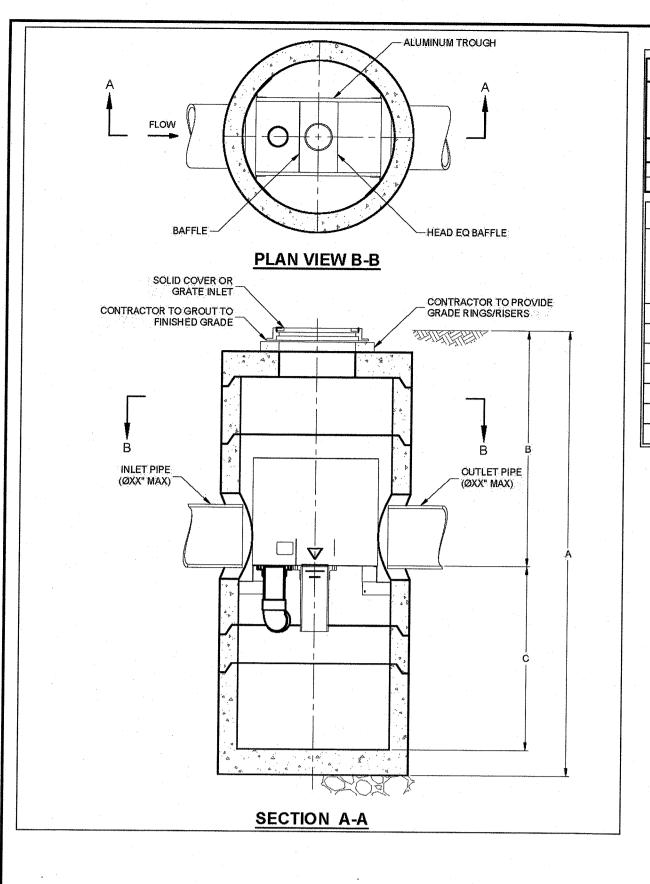

FIBERGLASS SEPARATION

PVC HYDRAULIC SHEAR

FIBERGLASS SEPARATION

CYLINDER AND INLET

INLET PIPE

OIL BAFFLE SKIRT

**SEPARATION** SCREEN

PVC HYDRAULIC SHEAR

STORAGE SUMP

(MULTIPLE INLET PIPES MAY


BE ACCOMMODATED)

CONTRACTOR TO GROUT


TO FINISHED GRADE

RINGS/RISERS

CYLINDER AND INLET

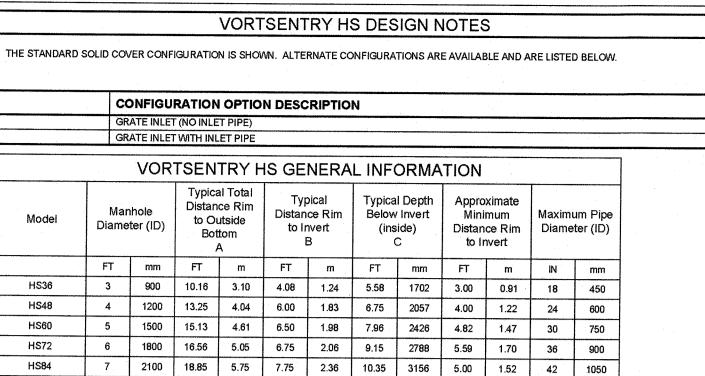

8 2400 20.87 6.36 8.50 2.59 11.54 3518 6.91 2.11 48 1200

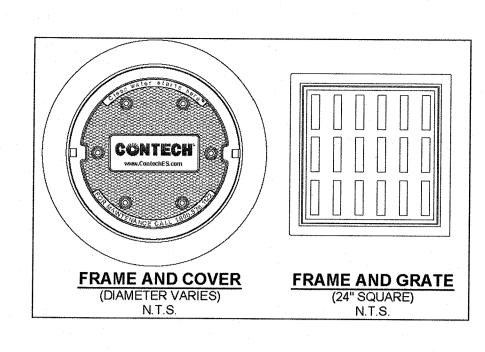

- DOWNSPOUT

**DOWNSPOUT CONNECTION TO DRAINAGE OUTLET** NOT TO SCALE

GENERAL NOTES


1. CONTECH TO PROVIDE ALL MATERIALS UNLESS NOTED OTHERWISE. . DIMENSIONS MARKED WITH ( ) ARE REFERENCE DIMENSIONS. ACTUAL DIMENSIONS MAY VARY. FOR FABRICATION DRAWINGS WITH DETAILED STRUCTURE DIMENSIONS AND WEIGHT, PLEASE CONTACT YOUR CONTECH ENGINEERED SOLUTIONS LLC REPRESENTATIVE. www.ContechES.com 1. VORTSENTRY HS WATER QUALITY STRUCTURE SHALL BE IN ACCORDANCE WITH ALL DESIGN DATA AND INFORMATION CONTAINED IN THIS DRAWING. 5. STRUCTURE SHALL MEET AASHTO HS20 AND CASTINGS SHALL MEET AASHTO M306 LOAD RATING, ASSUMING GROUNDWATER ELEVATION AT, OR BELOW, THE OUTLET PIPE INVERT ELEVATION. ENGINEER OF RECORD TO CONFIRM ACTUAL GROUNDWATER ELEVATION. INSTALLATION NOTES

1. ANY SUB-BASE, BACKFILL DEPTH, AND/OR ANTI-FLOTATION PROVISIONS ARE SITE-SPECIFIC DESIGN CONSIDERATIONS 2. CONTRACTOR TO PROVIDE EQUIPMENT WITH SUFFICIENT LIFTING AND REACH CAPACITY TO LIFT AND SET THE VORTSENTRY HS MANHOLE STRUCTURE (LIFTING CLUTCHES PROVIDED). 3. CONTRACTOR TO INSTALL JOINT SEALANT BETWEEN ALL STRUCTURE SECTIONS AND ASSEMBLE STRUCTURE. 4. CONTRACTOR TO PROVIDE, INSTALL, AND GROUT PIPES. MATCH PIPE INVERTS WITH ELEVATIONS SHOWN. 5. CONTRACTOR TO TAKE APPROPRIATE MEASURES TO ASSURE UNIT IS WATER TIGHT, HOLDING WATER TO FLOWLINE INVERT MINIMUM. IT IS SUGGESTED THAT ALL JOINTS BELOW PIPE INVERTS ARE GROUTED.

-FINISHED GRADE SLOPE AS SHOWN ON PLANS NOT TO SCALE ENCASE IN CONCRETE ---

FILL WITH GROUT -

VORTSENTRY DETAILS AND SPECIFICATIONS

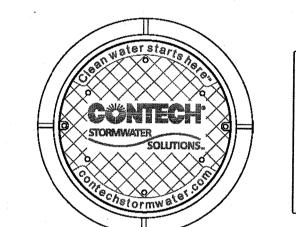

FRAME AND COVER

N.T.S.

GENERAL NOTES

1. CONTECH TO PROVIDE ALL MATERIALS UNLESS NOTED OTHERWISE.
2. DIMENSIONS MARKED WITH () ARE REFERENCE DIMENSIONS. ACTUAL DIMENSIONS MAY VARY.
3. FOR FABRICATION DRAWINGS WITH DETAILED STRUCTURE DIMENSIONS AND WEIGHTS, PLEASE CONTACT YOUR CONTECH CONSTRUCTION

5. STRUCTURE SHALL MEET AASHTO HS20 AND CASTINGS SHALL MEET AASHTO M306 LOAD RATING, ASSUMING GROUNDWATER ELEVATION AT, OR

INSTALLATION NOTES
1. ANY SUB-BASE, BACKFILL DEPTH, AND/OR ANTI-FLOTATION PROVISIONS ARE SITE-SPECIFIC DESIGN CONSIDERATIONS AND SHALL BE SPECIFIED

2. CONTRACTOR TO PROVIDE EQUIPMENT WITH SUFFICIENT LIFTING AND REACH CAPACITY TO LIFT AND SET THE CDS MANHOLE STRUCTURE

CONTRACTOR TO PROVIDE, INSTALL, AND GROUT PIPES. MATCH PIPE INVERTS WITH ELEVATIONS SHOWN.
 CONTRACTOR TO TAKE APPROPRIATE MEASURES TO ASSURE UNIT IS WATER TIGHT, HOLDING WATER TO FLOWLINE INVERT MINIMUM. IT IS


3. CONTRACTOR TO ADD JOINT SEALANT BETWEEN ALL STRUCTURE SECTIONS, AND ASSEMBLE STRUCTURE.

SUGGESTED THAT ALL JOINTS BELOW PIPE INVERTS ARE GROUTED.


PRODUCTS REPRESENTATIVE. www.contech-cpi.com
4. CDS WATER QUALITY STRUCTURE SHALL BE IN ACCORDANCE WITH ALL DESIGN DATA AND INFORMATION CONTAINED IN THIS DRAWIN


BELOW, THE OUTLET PIPE INVERT ELEVATION. ENGINEER OF RECORD TO CONFIRM ACTUAL GROUNDWATER ELEVATION.


6. PVC HYDRAULIC SHEAR PLATE IS PLACED ON SHELF AT BOTTOM OF SCREEN CYLINDER. REMOVE AND REPLACE AS NECESSARY DURING

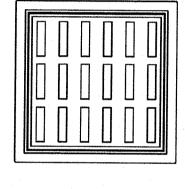



FRAME AND GRATE N.T.S.

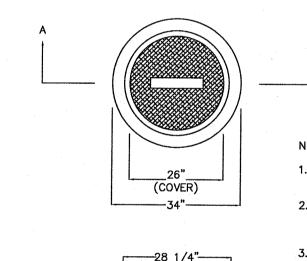


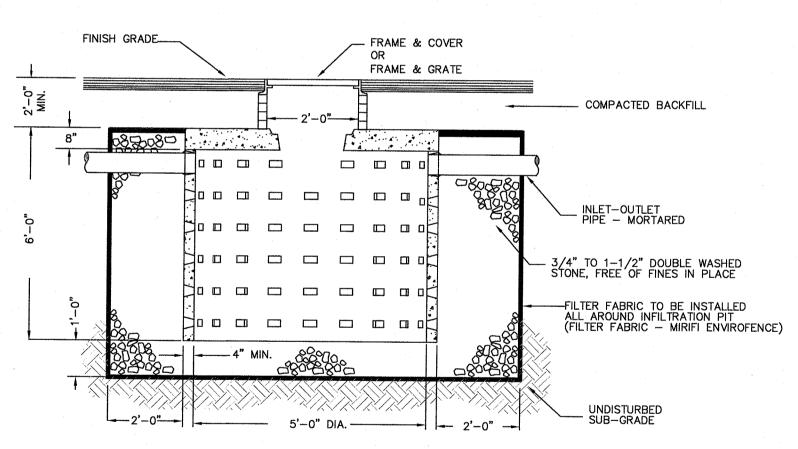


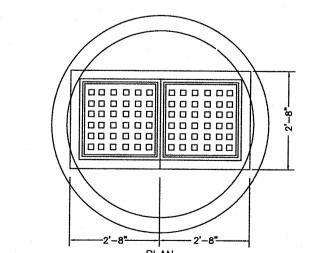

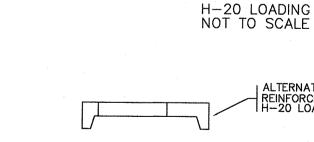

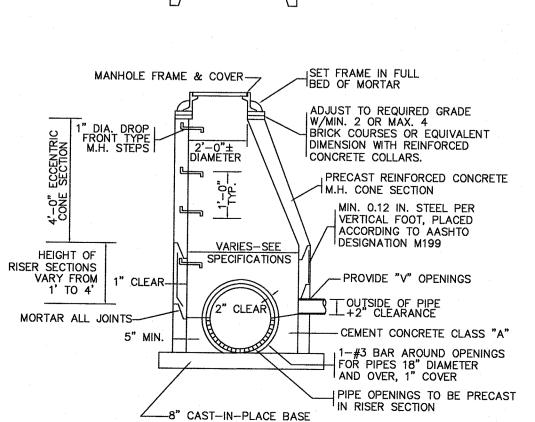

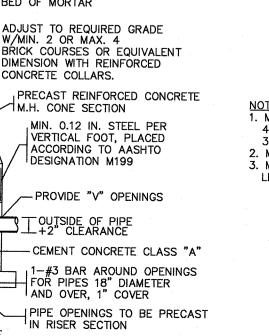

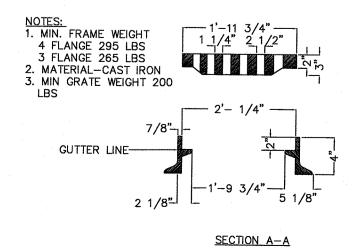

4TH FLANGE WHEN REQUIRED

STANDARD CATCH BASIN FRAME & GRATE NOT TO SCALE

N.T.S.	
CDS 2020-5-G UNIT (STANDAR	D)

**ELEVATION A-A** 

**PLAN VIEW B-B** 

~

CDS2020-5-C DESIGN NOTES	
CDS2020-5-C RATED TREATMENT CAPACITY IS 2.2 CFS, OR PER LOCAL REGULATIONS.	
THE STANDARD CDS2020-5-C CONFIGURATION IS SHOWN. ALTERNATE CONFIGURATIONS ARE AVAILABLE AND ARE LISTER CONFIGURATIONS MAY BE COMBINED TO SUIT SITE REQUIREMENTS.	ED BELOW. SOME
CONFIGURATION DESCRIPTION	Andrew Control of the
GRATED INLET ONLY (NO INLET PIPE)	
GRATED INLET WITH INLET PIPE OR PIPES	
CURB INLET ONLY (NO INLET PIPE)	
CURB INLET WITH INLET PIPE OR PIPES	
SEPARATE OIL BAFFLE (SINGLE INLET PIPE REQUIRED FOR THIS CONFIGURATION)	
SEDIMENT WEIR FOR NJDEP / NJCAT CONFORMING UNITS	· · · · · · · · · · · · · · · · · · ·

CENTER OF CDS

STRUCTURE, SCREEN

TOP SLAB ACCESS (SEE FRAME AND COVER

OUTLET PIPE

PERMANENT POOL ELEV.

(LIFTING CLUTCHES PROVIDED).

8" CAST-IN-PLACE BASE PRECAST CONCRETE DOUBLE CATCH BASIN WITH GAS AND OIL SEPARATOR

MORTAR ALL


HEIGHT OF

VARY FROM


1' TO 4'


RISER SECTIONS

JOINTS

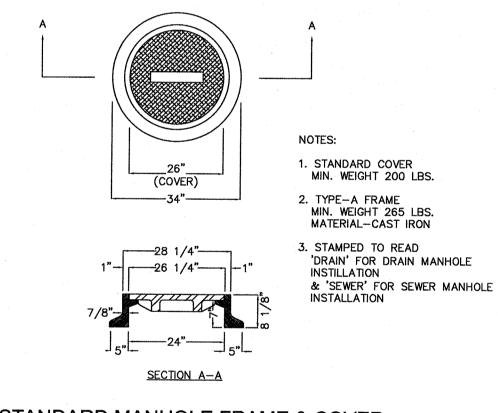

### STANDARD MANHOLE FRAME & COVER NOT TO SCALE

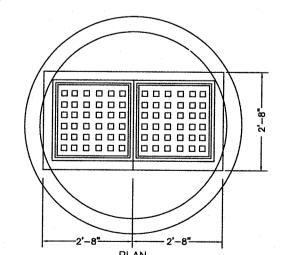

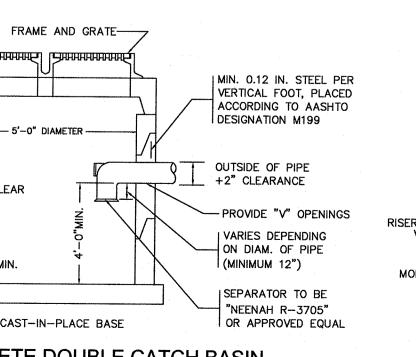

NOT TO SCALE

**INFILTRATION PIT W/ OVERFLOW** 

PRECAST CONCRETE DRAIN MANHOLE NOT TO SCALE

TIAI -000-**∭**∞

NO DATE

REVISIONS

06/21/2021 PERMIT SUBMISSION

JUNE 21, 2021

DRC

DRAWN:

SCALE: 1" = 20'

**TYPICAL DETAILS** 

SHEET 7 OF 7


CIVIL ENGINEERING / LAND SURVEYING


249 SOUTH STREET

PLAINVILLE, MA 02762

TEL. (508) 695-2221 FAX. (508) 695-2219



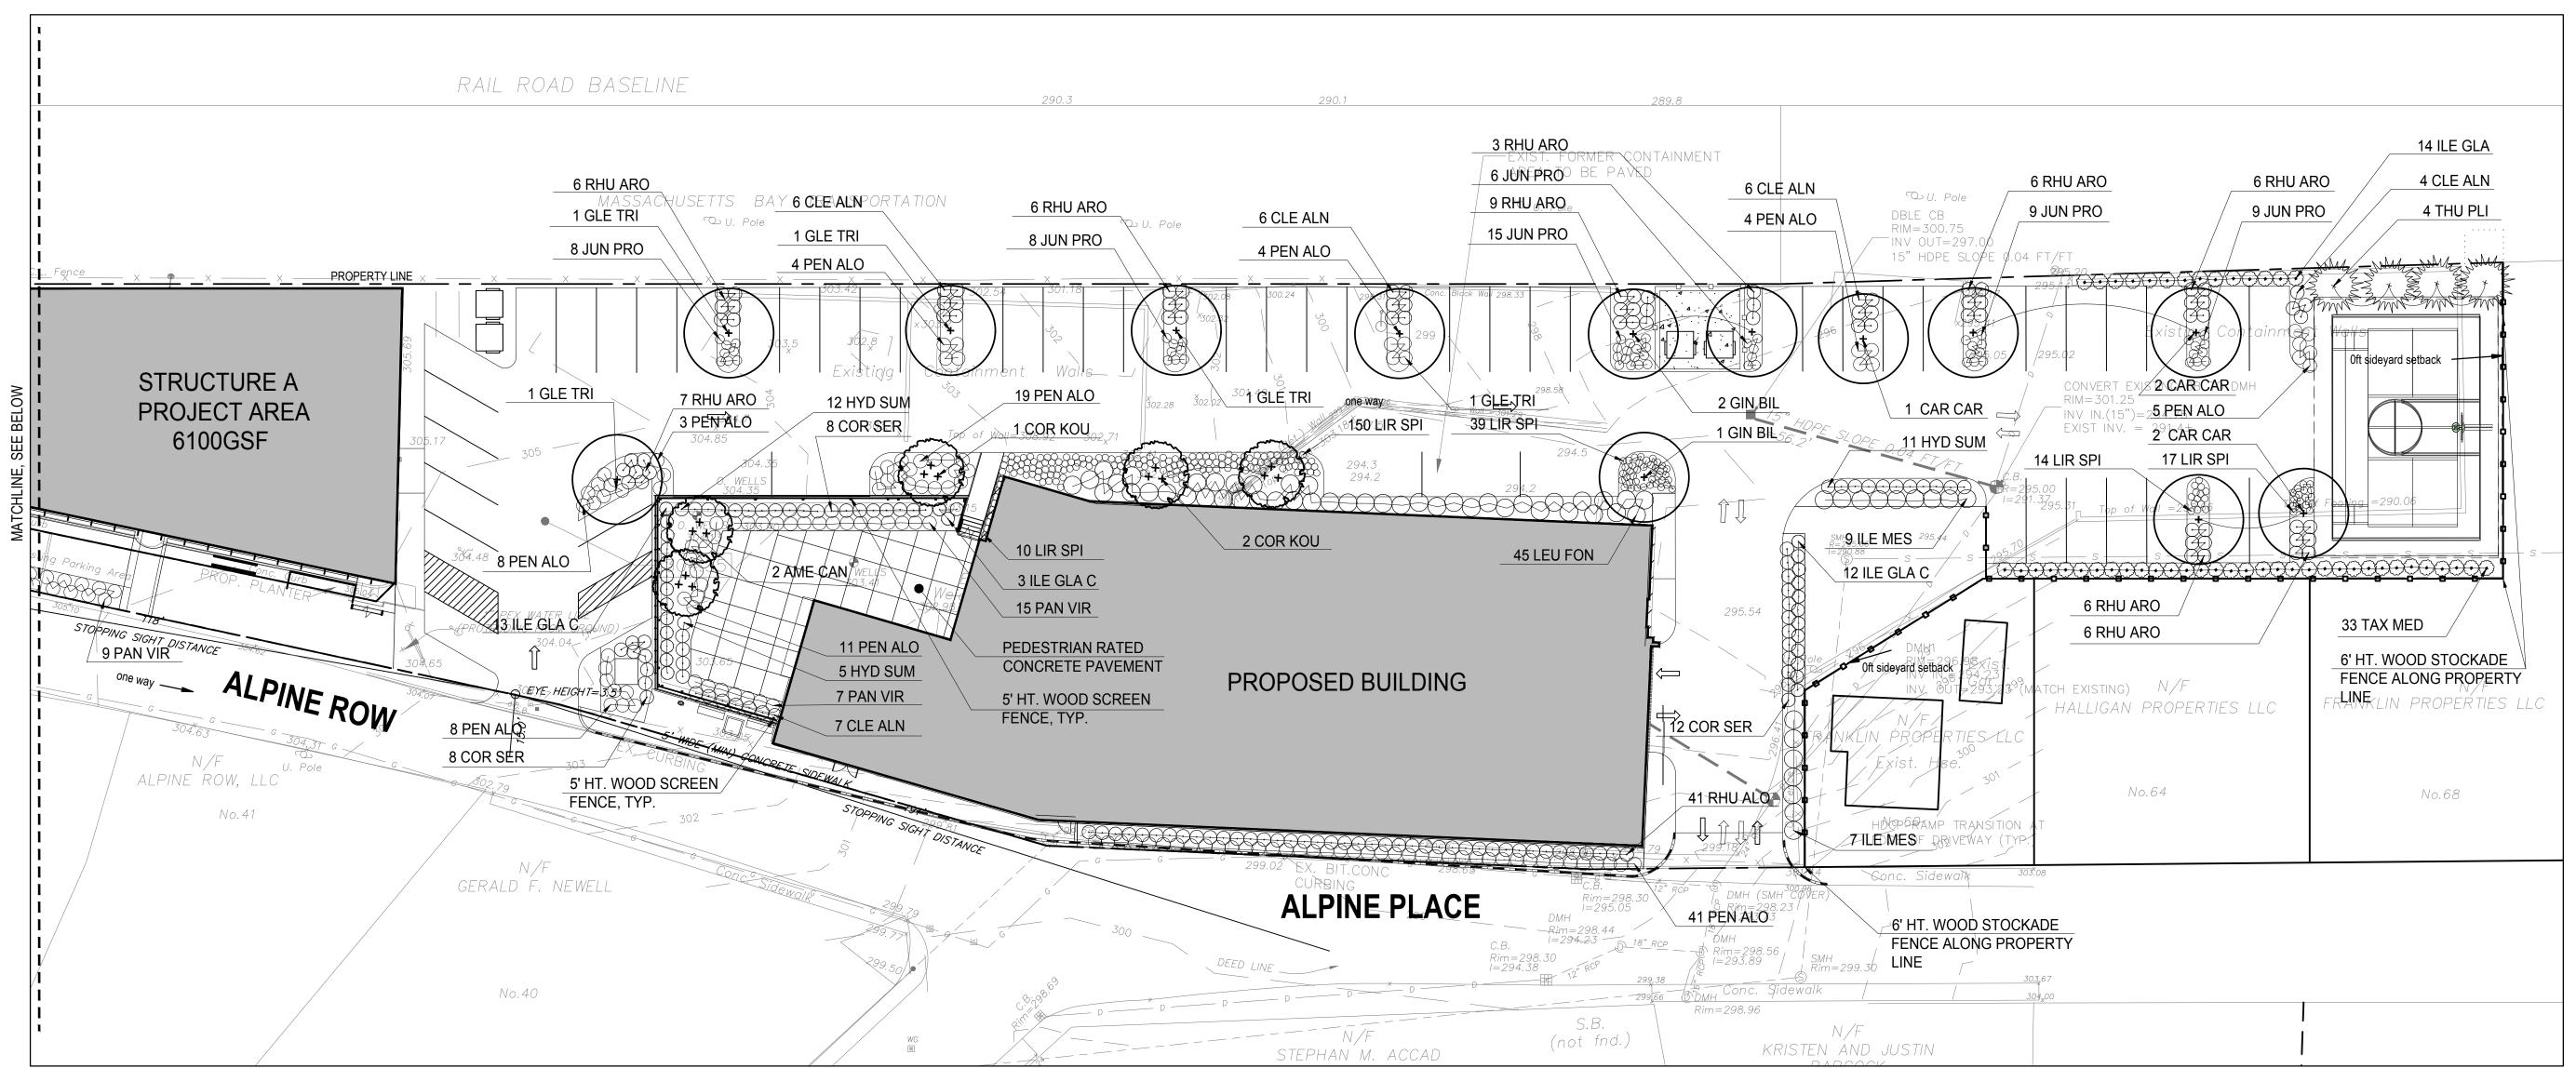

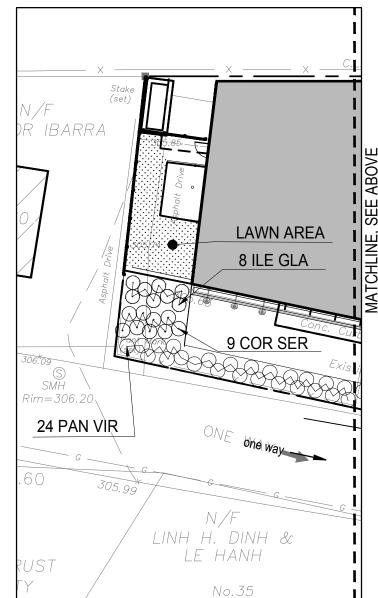

### PLANTING NOTES

- 1. BASE FILE SURVEY INFORMATION PROVIDED BY JOE THE ARCHITECT, MAY 05, 2021.
- 2. IF DISCREPANCIES EXIST BETWEEN THE NUMBER OF PLANTS DRAWN ON THE PLANTING PLAN AND THE NUMBER OF PLANTS IN THE PLANT LIST, THE PLANTING PLAN SHALL GOVERN.
- 3. ALL NEW PLANT MATERIAL SHALL CONFORM TO THE MINIMUM GUIDELINES ESTABLISHED FOR NURSERY STOCK PUBLISHED BY THE AMERICAN NURSERY AND LANDSCAPE ASSOCIATION. IN ADDITION, ALL NEW PLANT MATERIAL FOR THE PROJECT SHALL BE OF SPECIMEN QUALITY.
- 4. ALL NEW PLANTS TO BE BALLED AND BURLAPPED OR CONTAINER-GROWN, UNLESS OTHERWISE NOTED ON THE PLANT LIST.
- 5. THE CONTRACTOR SHALL SUPPLY ALL NEW PLANT MATERIAL IN QUANTITIES SUFFICIENT TO COMPLETE THE PLANTING SHOWN ON THE DRAWINGS.
- 6. ANY PROPOSED SUBSTITUTIONS OF PLANT SPECIES SHALL BE MADE WITH PLANTS OF EQUIVALENT OVERALL FORM, HEIGHT, BRANCHING HABIT, FLOWER, LEAF, COLOR, FRUIT AND CULTURE, AND ONLY AFTER WRITTEN APPROVAL OF THE LANDSCAPE ARCHITECT.
- 7. CONTRACTOR SHALL LOCATE AND VERIFY ALL EXISTING UTILITY LINES PRIOR TO PLANTING AND SHALL REPORT ANY CONFLICTS TO THE LANDSCAPE ARCHITECT.
- 3. STAKE LOCATION OF ALL PROPOSED PLANTING FOR APPROVAL BY OWNER'S REP PRIOR TO THE COMMENCEMENT OF PLANTING.
- 9. NEW SHRUBS AND GROUND COVER SHALL BEAR THE SAME RELATIONSHIP TO GRADE AS IT BORE TO PREVIOUS GRADE. TREES SHALL BE SET 3" HIGHER THAN PREVIOUS GRADE. NO TREES SHALL BE PLANTED BEFORE ACCEPTANCE OF ROUGH GRADING.
- 10. ALL PLANT BEDS TO RECEIVE THREE INCHES (3") OF BARK MULCH AS PER THE SPECIFICATIONS.
- 11. ALL EXISTING TREES TO REMAIN SHALL BE PROPERLY PROTECTED DURING CONSTRUCTION. PROTECTION TECHNIQUES SHALL BE REVIEWED AND APPROVED BY THE OWNER'S REP.
- 12. PRUNE EXISTING AND NEW TREES IN ACCORDANCE WITH THE SPECIFICATIONS.
- 13. CONTRACTOR SHALL PROVIDE FULL DEPTHS OF LOAM AS NOTED ON DETAILS AND AS SPECIFIED, FOR ALL PLANTING.
- 14. ALL TREES TO BE REMOVED FROM SCOPE OF WORK SHALL INCLUDE GRINDING OF STUMP AND REMOVAL OFF-SITE.
- 15. ANY EXISTING TREES AFFECTED BY CONSTRUCTION SHALL HAVE ROOTS PRUNED PER THE SPECIFICATIONS.

LANTIN	NG SC	HEDULE			
SYM	QTY	BOTANICAL NAME	COMMON NAME	SIZE	SPACING/NOTES
SHADE TREES		•	•		
GIN BIL	3	Ginkgo biloba	Ginkgo	2 - 2 ½" CAL	B&B
GLE TRI	5	Gleditsia triacanthos	Honeylocust	2 - 2 ½" CAL	B&B
CAR CAR	5	Carpus carolinia	American Hornbeam	2 - 2 ½" CAL	B&B, NATIVE
ORNAMENTAL 1	TREES	•	•	•	
AME CAN	2	Amelanchier canadensis	Serviceberry	8-10' HT.	B&B Multi-stem, NATIVE
COR KOU	3	Cornus kousa	Kousa Dogwood	8-10' HT.	B&B Multi-stem
EVERGREEN TF	REES	•	•	•	
THU PLI	4	Thuja plicata 'Nana'	Dwarf Western Arbovitae	8-10' HT.	B&B
EVERGREEN	SHRUBS				
ILE GLA C	28	llex glabra 'compacta'	Compact Inkberry	24"-36" HT	36" O.C. NATIVE
ILE GLA	22	llex glabra	Inkberry	24"-36" HT	42" O.C. NATIVE
ILE MES	16	Ilex meserveae 'Blue Prince'	Blue Prince Holly	24"-36" HT	48" O.C.
LEU FON	45	Leucothoe fontanesiana 'Compacta'	Compact Drooping Leucothoe	2 Gal.	48" O.C. NATIVE
TAX MED	33	Taxus media 'Hill's Upright'	Hill's Upright Yew	36"-48" HT	36" O.C.
DECIDUOUS SH	RUBS	•	•	•	
CLE ALN	29	Clethra alnifolia 'Compacta;	Compact Summersweet	3 Gal.	48" O.C. NATIVE
COR SER	37	Cornus Sericea 'kelseyi'	Kelsey Dogwood	3 Gal.	48" O.C. NATIVE
HYD SUM	28	Hydrangea 'Endless Summer'	Endless Summer Hydrangea	3 Gal.	36" O.C.
RHU ARO	90	Rhus aromatica 'Gro Low'	Gro-Low Fragrant Sumac	3 Gal.	36" O.C.
ORNAMENTAL (	GRASSES A	ND PERENNIALS	•	•	_
JUN PRO	37	Juniperus procumbens 'Nana'	Dwarf Juniper	1 Gal.	24" O.C.
LIR SPI	230	Liriope spicata	Lily Turf	1 Gal.	18" O.C.
PAN VIR	55	Pannicum virgatum 'Shenandoah'	Switch Grass	1 Gal.	36" O.C. NATIVE
PEN ALO	107	Pennisetum alopecuroides 'hameln'	Hameln Fountain Grass	1 Gal.	36" O.C.





WALKER DEVELOPMENT

5 MT. ROYAL AVENUE, MARLBOROUGH, MA 01752

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KEY PLAN

PROJECT INFORMATION
THE ENGINE YARD

40 ALPINE ROW FRANKLIN, MA 02038

FOR ZONING

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SITE LANDSCAPE PLAN

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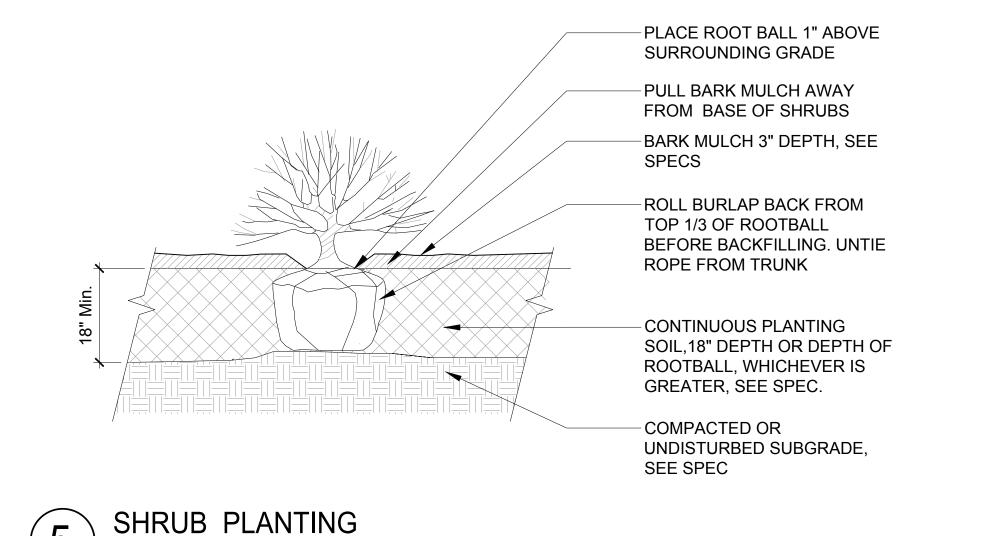
SCALE

SHEET NAME

LA-01


### 4 PERENNIAL/GROUNDCOVER PLANTING SCALE: NTS

SCALE: NTS




INSTALL TREE PLUMB TOP OF ROOTBALL SHALL BEAR SAME RELATIONSHIP TO FINISHED GRADE AS TO PREVIOUS EXISTING GRADE ROOT FLARE SHALL BE EXPOSED; MULCH SHOULD NOT BE WITHIN 4" OF TREE TRUNK PLACE BALL ON SUBSOIL. REMOVE AND DISCARD BURLAP EXCEPT UNDER BALL. REMOVE ALL SYNTHETIC SOIL WRAPPING MATERIALS (TREATED BURLAP, NYLON TWINE, WIRE BASKETS, ETC.) AND DISCARD 3" BARK MULCH, AS SPECIFIED EXCAVATE HOLE TO DIAMETER 3X WIDER THAN ROOTBALL. BACKFILL HOLE WITH PLANTING LOAM AS SPECIFIED -DECOMPACTED SUBGRADE **EXCAVATE SUBSOIL AS REQUIRED TO** PLACE ROOTBALL TO PROPER ELEVATION. PLACE ROOTBALL DIRECTLY ON COMPACTED OR UNDISTURBED SUBSOIL. EQ. TREE STABILIZATION, TYP.

DECIDUOUS TREE PLANTING

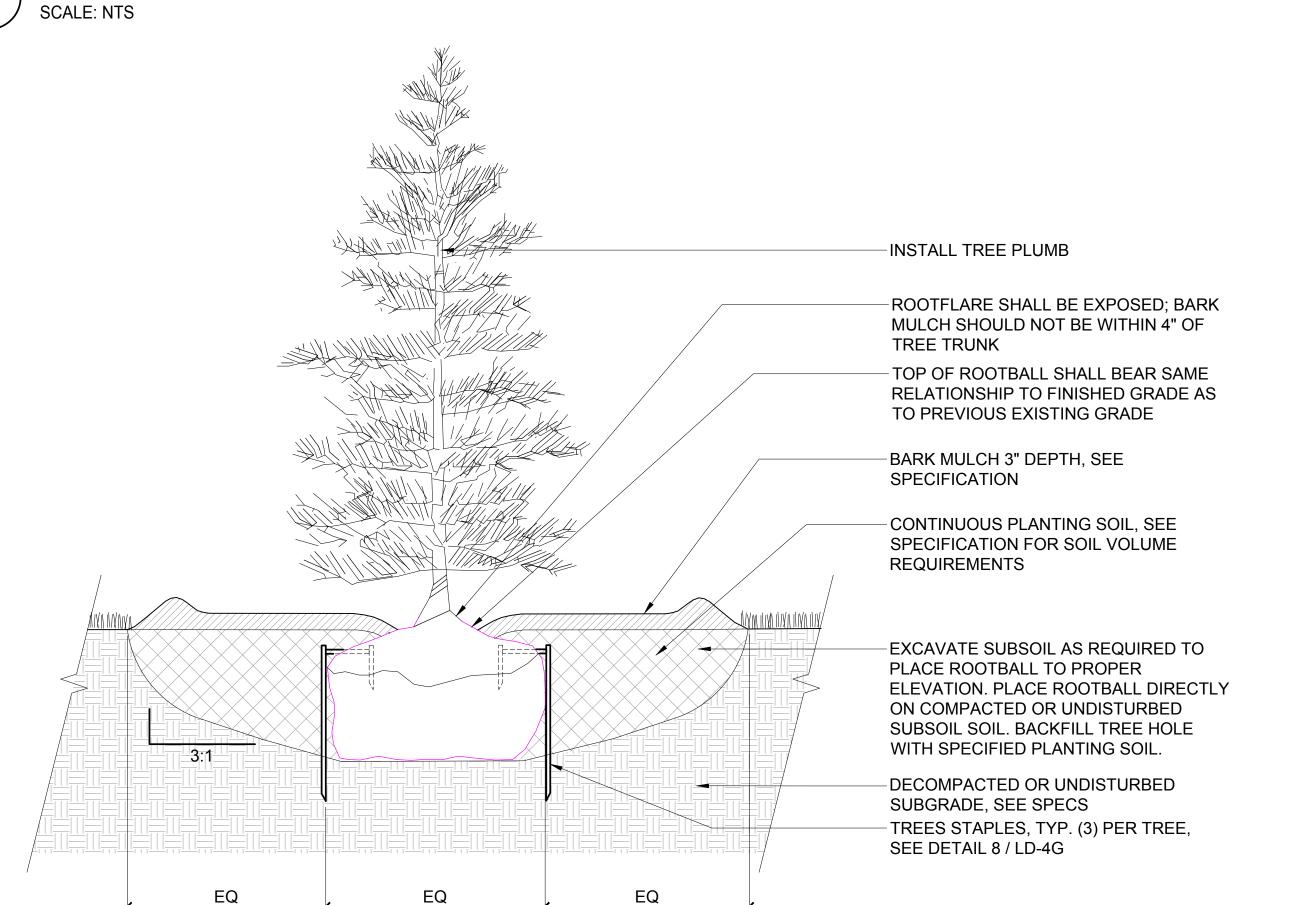

2 EVERGREEN TREE PLANTING
SCALE: NTS

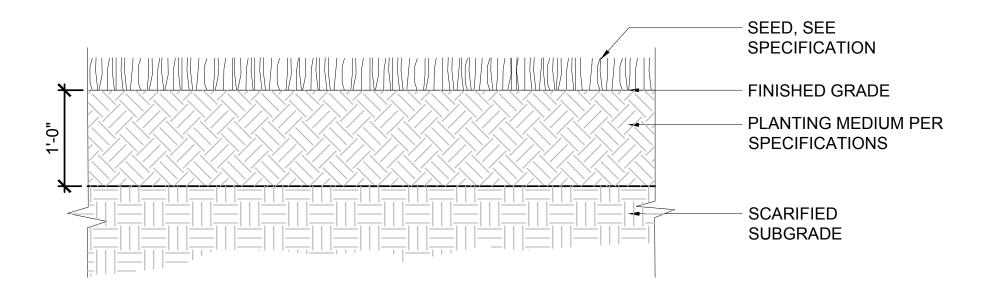

3 SEEDED LAWN
SCALE: NTS

Joe The Architect, LLC
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**DESIGN FIRM** 

CLIENT

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**WALKER DEVELOPMENT** 

5 MT. ROYAL AVENUE, MARLBOROUGH, MA 01752

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SEAL



KEY PLAN

PROJECT INFORMATION

THE ENGINE YARD

40 ALPINE ROW FRANKLIN, MA 02038

FOR ZONING

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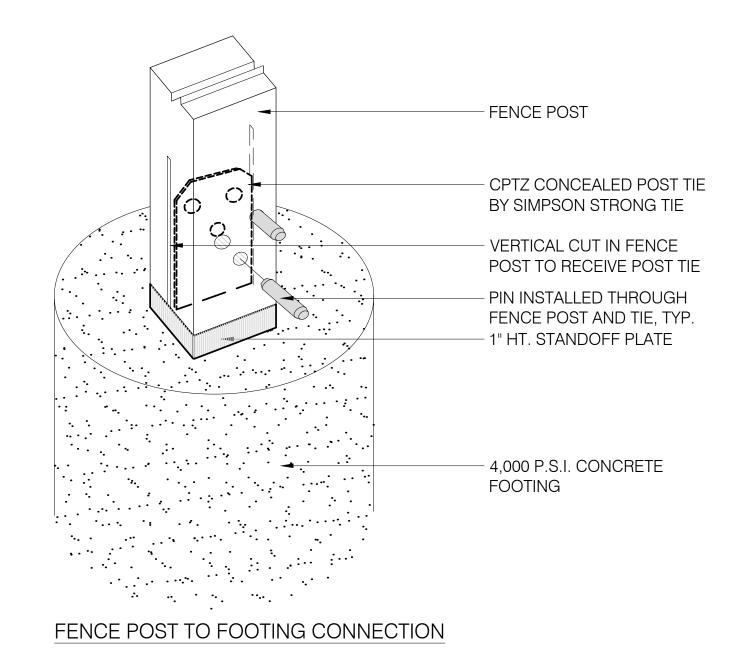
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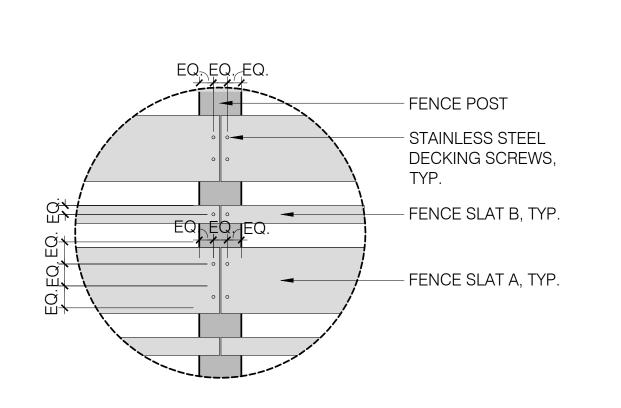
SHEET NAME

LA-02

6' HT. WOOD STOCKADE FENCE

POST POST POST - FENCE POST CAP, TYP. - FENCE POST, TYP. FENCE SLAT B, TYP. - FENCE SLAT A, TYP. 72 72 HOLD TOP OF FOOTING 1" 72 ABOVE FINISH GRADE, TYP. - FINISH GRADE FENCE POST TO FOOTING - FENCE POST TO FOOTING CONNECTION; SEE CONNECTION; SEE ENLARGEMENT BELOW **ENLARGEMENT** - 8" Ø 4000 P.S.I. CONCRETE FOOTING, TYP. - COMPACTED AGGREGATE BASE SCREEN FENCE A - ELEVATION SCREEN FENCE A - SECTION





FENCE SLAT CONNECTION

1. FENCE POST SHALL BE 4X4 NOM. EASTERN RED CEDAR POST

FENCE SLAT 'A' SHALL BE 2X6 NOM. EASTERN RED CEDAR BOARD
 FENCE SLAT 'B' SHALL BE 2X2 NOM. EASTERN RED CEDAR BOARD

4. GAPS BETWEEN FENCE SLATS SHALL BE 2" CLEAR, TYP. EXCEPT

WHERE SHOWN ON THE DETAIL

5. ALL FENCE PANELS SHALL BE INSTALLED PARALLEL WITH VARYING HORIZONTAL, AND LINEAR OFFSETS.

6. PROVIDE SHOP DRAWINGS PRIOR TO FABRICATION.

WOOD SCREEN FENCE AT OUTDOOR TERRACE
SCALE: NTS

DESIGN FIRM

Los The Architect II C

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www.joethearchitect.com

WALKER
DEVELOPMENT
& CONSTRUCTION MANAGEMENT


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KEY PLAN

PROJECT INFORMATION
THE ENGINE YARD

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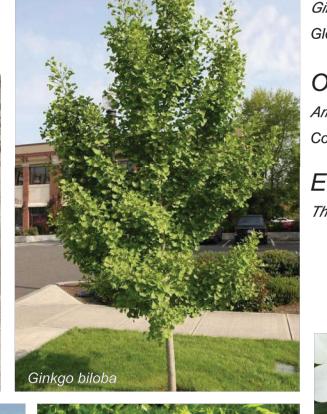






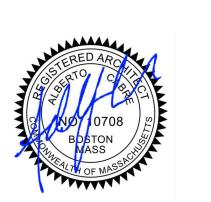








DECIDUOUS TREES -

Carpinus caroliniana

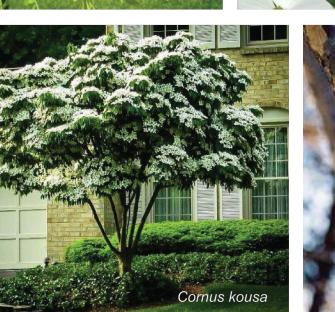





American Hornbeam

Thornless Honeylocust

Dwarf Western Arbovitae

Maidenhair Tree

Serviceberry

Kousa Dogwood



TREE PLANTING OPTIONS MAY 17, 2021

PD SD DD CD CA







Taxus media 'Hill's Upright' Hill's Upright Yew Ilex glabra 'Compacta' Compact Inkberry llex glabra Inkberry

llex meserveae 'Blue Prince' Blue Prince Holly DECIDUOUS SHRUBS -

Hydrangea macrophylla 'Endless Summer' Endless Summer Hydragea Rhus aromatica 'Gro-low' Gro-low Fragrant Sumac Clethra alnifolia Summersweet Clethra Cornus sericia Redtwig Dogwood

PERENNIALS/GRASSES/GROUNDCOVER -Blue Lilyturf Liriope muscari

Fountain Grass Pennisetum alopecuroides Shenandoah Switch Grass Panicum virgatum 'Shenandoah' Juniperus procumbens 'Nana' Dwarf Japanese Juniper







JO LIFARCIII CI









PD SD DD CD CA



343 Medford Street, Suite 4C Somerville, MA 02145 t: +1(617) 764-3593 e: askjoe@joethearchitect.com www.joethearchitect.com



WALKER DEVELOPMENT

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**KEY PLAN** 

PROJECT INFORMATION THE ENGINE YARD

> 40 ALPINE ROW FRANKLIN, MA 02038

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SITE LANDSCAPE **PLAN IMAGERY** 

SHEET NUMBER

SHEET NAME



SCALE

DRAWN BY: DATE: 06/23/21 NOTES:

Avg/Min Max/Min

N.A.

N.A.

N.A.

N.A.

N.A.

29.50

N.A.

N.A.

N.A.

6.70

N.A.

N.A.

• 0.0 | • | 0.0 • 0 TOTAL LOT 0 0.0 0.1 0.3 0.4 **1**.5 2.5 2.4 1.8 1.2 2<u>.2</u>3.2 2.9 2.0 1.3 WL3 2.5 2.4 1.8 1.2 MÅ 135 1.4 12.2 2.1 1.5 1.0 0.00.0 0.0KRISTEN AND JUSTIN No.40 No.67 No.65ANo.43 No.39 No.64

Calculation Summary

BASKETBALL COURT

STRUCTURE A STORAGE AREA

STRUCTURE A STREET AREA

**GREEN SPACE** 

PARKING LOT

SIDEWALK

SPILL LIGHT

TRACKS

CalcType

Illuminance

Illuminance

Illuminance

Illuminance

Illuminance

Illuminance

Illuminance

Illuminance

Units

Fc

Fc

Fc

Fc

Fc

Fc

0.86

1.60

1.05

1.61 7.3

1.34 5.9

1.48 4.4

0.00 0.1 0.0

0.0

0.0

0.0

0.0

0.2

0.0

Symbol	Qty	Label	Arrangement	LLF	Description	Lum. Lumens
0	2	LL1	SINGLE	0.900	FL1A-BLT(BLACK)-RND-C4-K1-118-0 / M	428
$\odot$	3	WL1	SINGLE	0.900	H18110-91(BLACK)-1-2-HL-A-91(BLACK)	1295
$\odot$	12	DL1	SINGLE	0.900	FM-W9100-FINISH	924
	4	WL3	SINGLE	0.900	RWL1-48L-25-3K7-3-U	3587
+	10	SL4	SINGLE	0.900	RAR-1-80L-50-3K7-4W-BC	3663
	1	WL5	SINGLE	0.900	SG1-10-3K	1346
•	5	BL1	SINGLE	0.900	S-KK0103US-16A-0870007A-730-16US	1255
	1	WALL LIGHT	SINGLE	0.900	RWL1-48L-45-3K7-4W-U	5484

**VIEW FROM COMMUTER RAIL PLATFORM** 



**VIEW DOWN ALPINE ROW** 




**VIEW DOWN ALPINE ROW** 

**VIEW OF PARKING LOT** 



VIEW OF EXISTING BUILDING FACADE

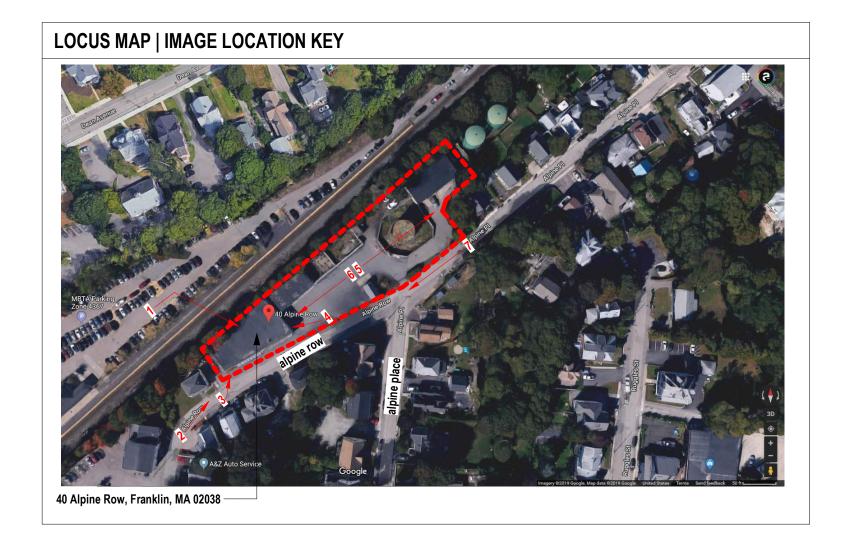

**VIEW OF PARKING LOT** 



VIEW TOWARD INTERSECTION OF ALPINE ROW & ALPINE PLACE



**NATIWALKER** 

WALKER DEVELOPMENT

5 MT. ROYAL AVENUE, MARLBOROUGH, MA 01752

STERED AROUSE TO COMPANY OF MASS

KEV D

THE ENGINE YARD

40 ALPINE RO

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 12" = 1'-0"
 SCALE

 SHEET NAME


**EXISTING SITE CONTEXT IMAGES** 

SHEET NUMBER

<SET PHASE>

/2021 10:17:58 PM

A007

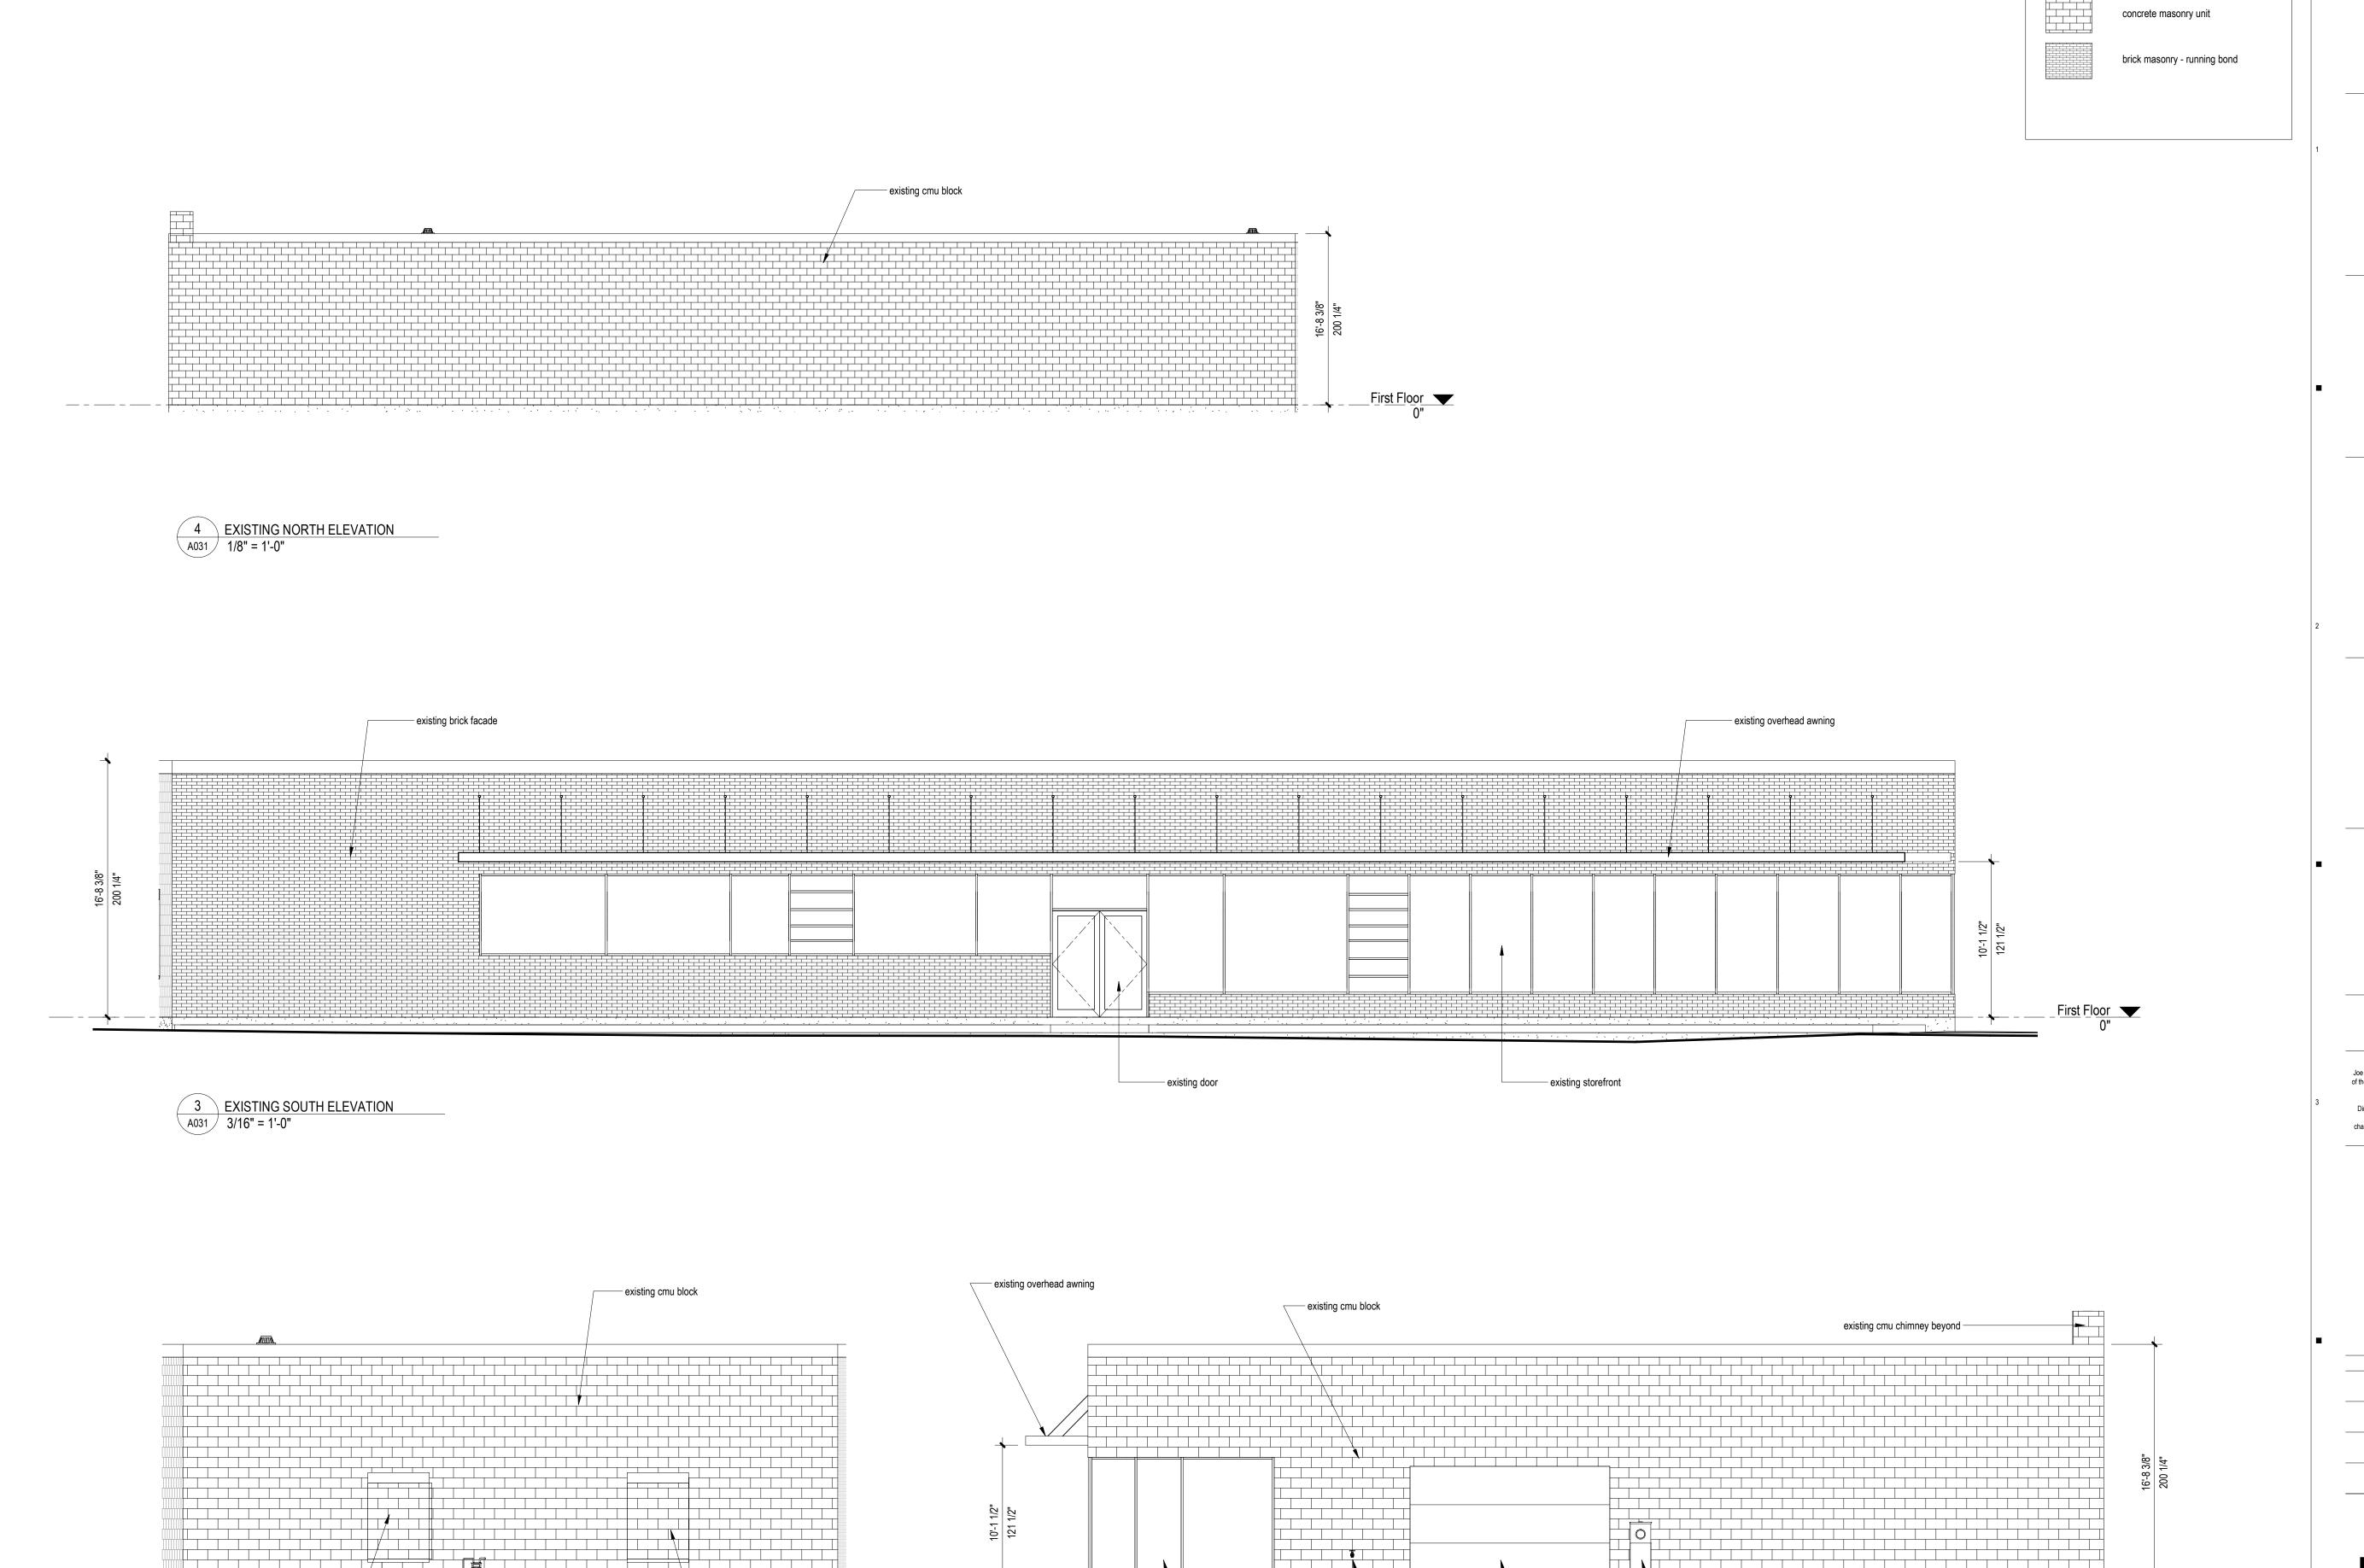

1 EXISTING EAST ELEVATION
A031 3/16" = 1'-0"

existing concrete curb -

- existing gas main into building

existing bollard -

2 EXISTING WEST ELEVATION
3/16" = 1'-0"

existing concrete foundation wall

Joe The Architect, LLC 343 Medford Street, Suite 4C Somerville, MA 02145 t: +1(617) 764-3593 e: askjoe@joethearchitect.com www.joethearchitect.com

**EXISTING BUILDING FINISH** 

WALKER DEVELOPMENT

5 MT. ROYAL AVENUE, MARLBOROUGH, MA 01752

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**KEY PLAN** 

PROJECT INFORMATION THE ENGINE YARD

40 ALPINE ROW

FRANKLIN, MA 02038

FOR ZONING

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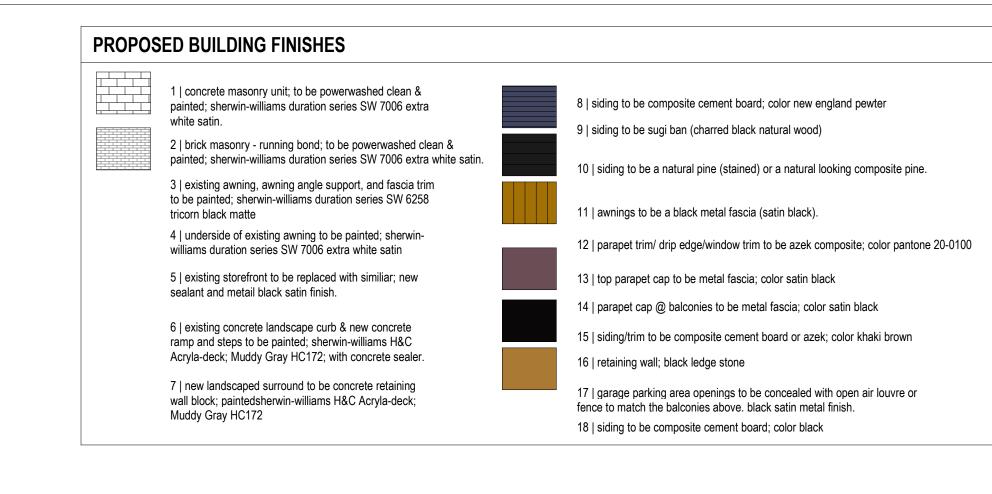
As indicated

**EXISTING BUILDING ELEVATIONS** 

First Floor

SHEET NUMBER

SHEET NAME





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WALKER DEVELOPMENT

5 MT. ROYAL AVENUE, MARLBOROUGH, MA 01752

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**KEY PLAN** 

existing overhead door to remain existing masonry vent WL3 loading zone for non-business hours

new door within new window within existing lintel existing lintel ----PROPOSED WEST ELEVATION -4 STRUCTURE A

A200 1/8" = 1'-0"

PROPOSED EAST ELEVATION - STRUCTURE A

 existing masonry chimney WL1 TENANT SIGNAGE HERE

PROJECT INFORMATION

THE ENGINE YARD

40 ALPINE ROW FRANKLIN, MA 02038

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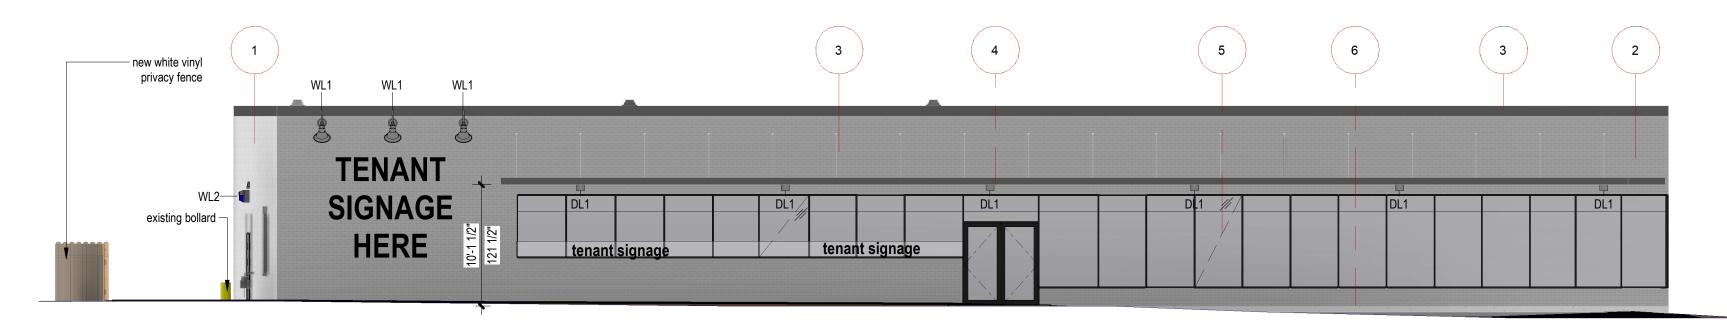
**DESIGN REVIEW** 

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**ISSUE CHART** 

PROPOSED NORTH ELEVATION STRUCTURE A
1/8" = 1'-0"




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> **EXTERNAL ELEVATIONS**

> > SHEET NUMBER

PROPOSED SOUTH ELEVATION STRUCTURE A
1/8" = 1'-0"



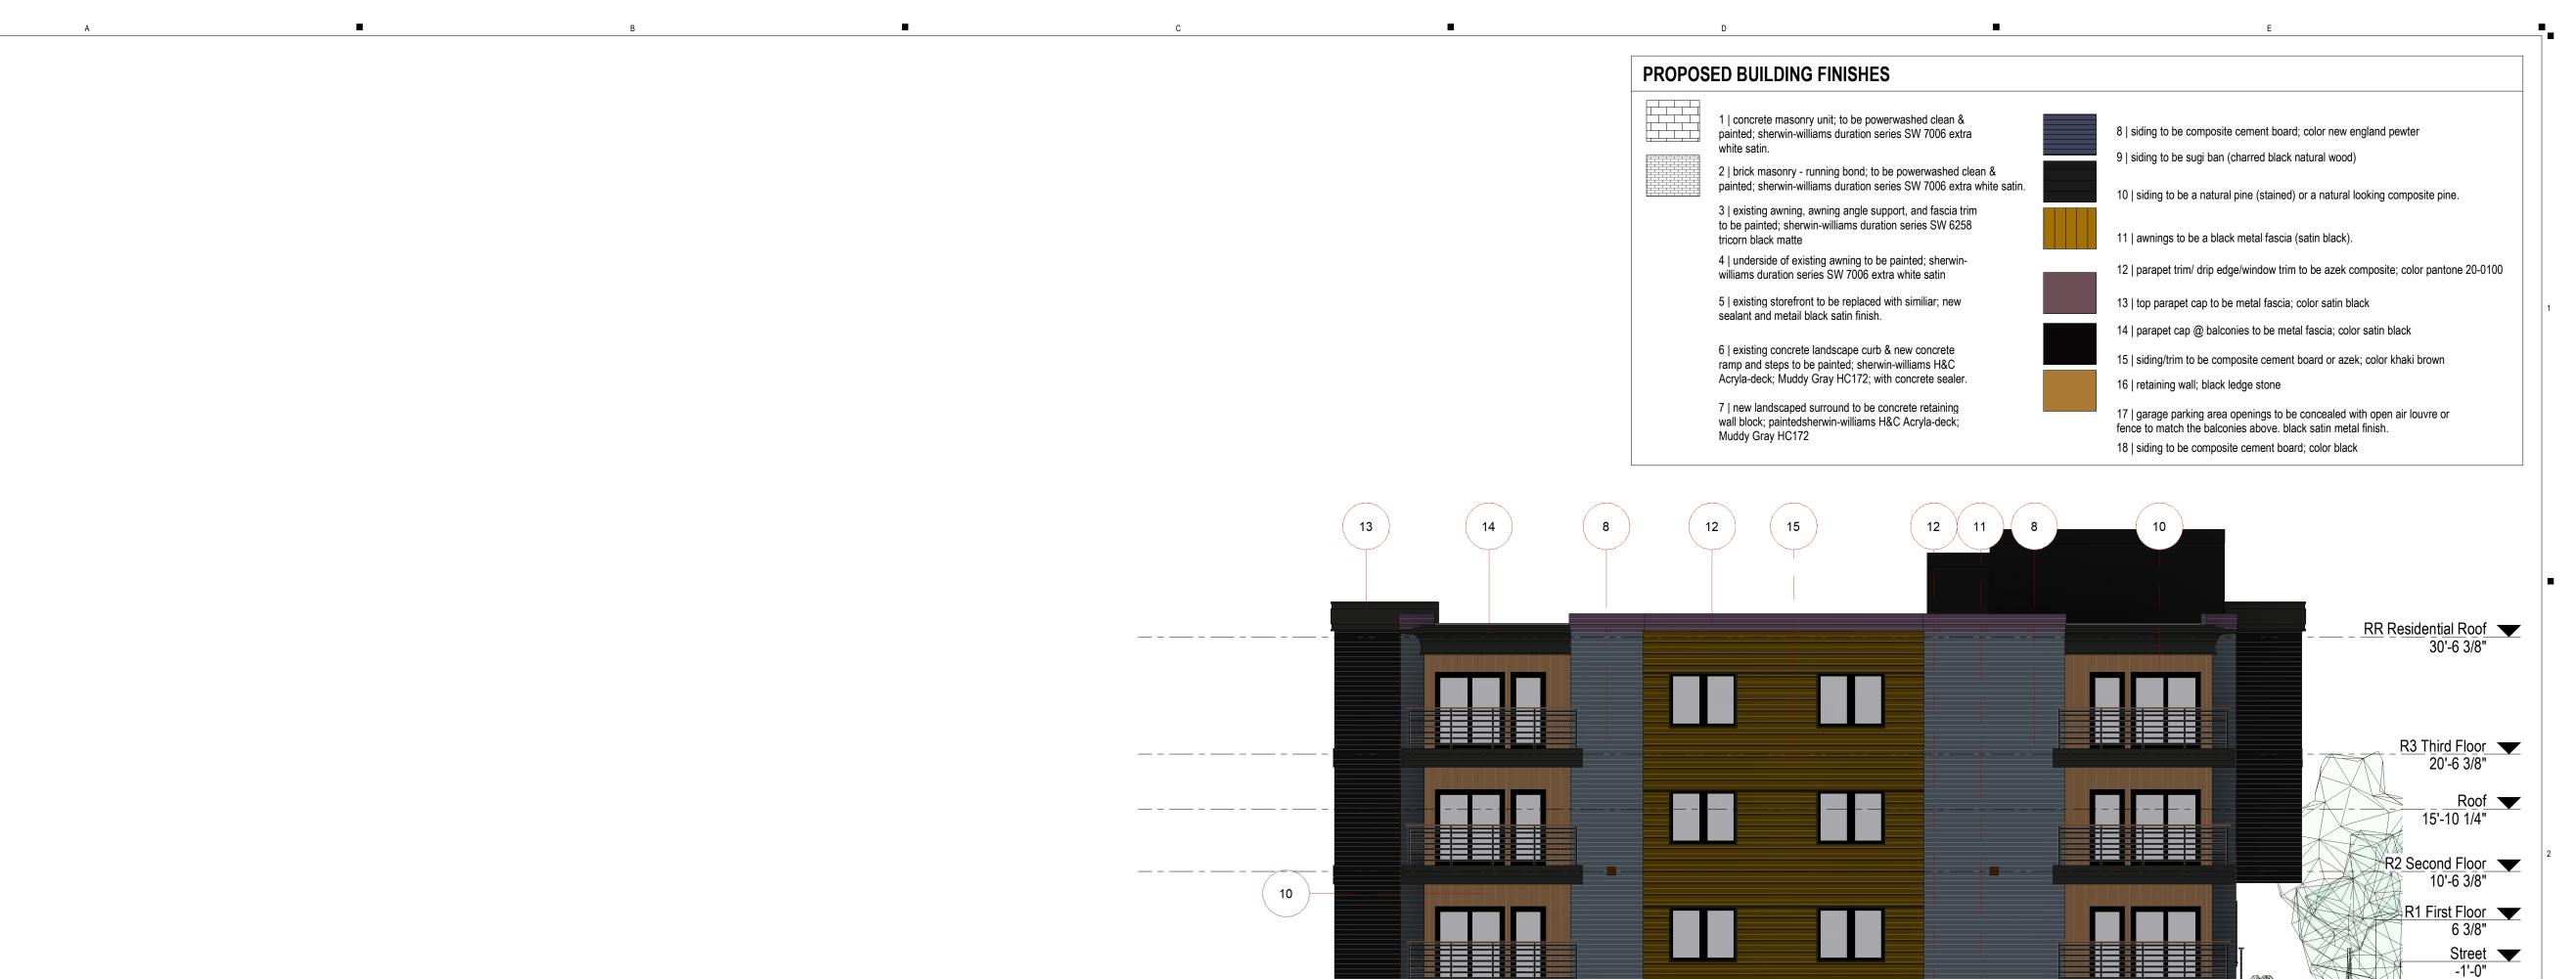

1 STRUCTURE B \ A201 \/ 1/8" = 1'-0" RR Residential Roof 30'-6 3/8" R3 Third Floor 20'-6 3/8" R2 Second Floor 

T R1 First Floor Street --1'-0" C1 Street Level

> Median Grade 🔻 -6'-5 5/8" B1 Entrance -8'-11 5/8"

B1 Parking 🔻 -9'-5 5/8"

-2'-5 5/8"

PROPOSED ELEVATION NORTH A -2 STRUCTURE B

PROPOSED ELEVATION EAST -

**DESIGN FIRM** 

Joe The Architect, LLC 343 Medford Street, Suite 4C Somerville, MA 02145 t: +1(617) 764-3593 e: askjoe@joethearchitect.com www.joethearchitect.com



WALKER DEVELOPMENT

5 MT. ROYAL AVENUE, MARLBOROUGH, MA 01752

SEAL

CONSULTANT

CLIENT

**KEY PLAN** 

PROJECT INFORMATION THE ENGINE YARD

> **40 ALPINE ROW** FRANKLIN, MA 02038

**FOR ZONING** 

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be notified in writing of any discrepancies prior to proceeding with the work. The scale of drawings may change when copied or faxed. All work to comply with I.B.C. Regulations and relevant American Standards.

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06/23/2021 06/23/2021	DESIGN REVIEW PLANNING BOARD	2	
DATE	ISSUE	N	
PROJECT NUMBER	440		
CHECKED	Checker		
APPROVED	Approver		
SCALE	1/8" = 1'-0"		

**EXTERNAL ELEVATIONS** 

SHEET NUMBER

SHEET NAME

PROPOSED ELEVATION NORTH B -

3 STRUCTURE B

A201 / 1/8" = 1'-0"



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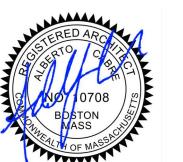
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**KEY PLAN** 

PROJECT INFORMATION

THE ENGINE YARD

**40 ALPINE ROW** 

FRANKLIN, MA 02038

**FOR ZONING** 

6/22/2021 10:18:17 PM

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**ISSUE CHART** 


DESIGN REVIEW PLANNING BOARD 06/23/2021 ISSUE PROJECT NUMBER CHECKED

**APPROVED** 1/8" = 1'-0"

SHEET NAME

**EXTERNAL ELEVATIONS** 

SHEET NUMBER

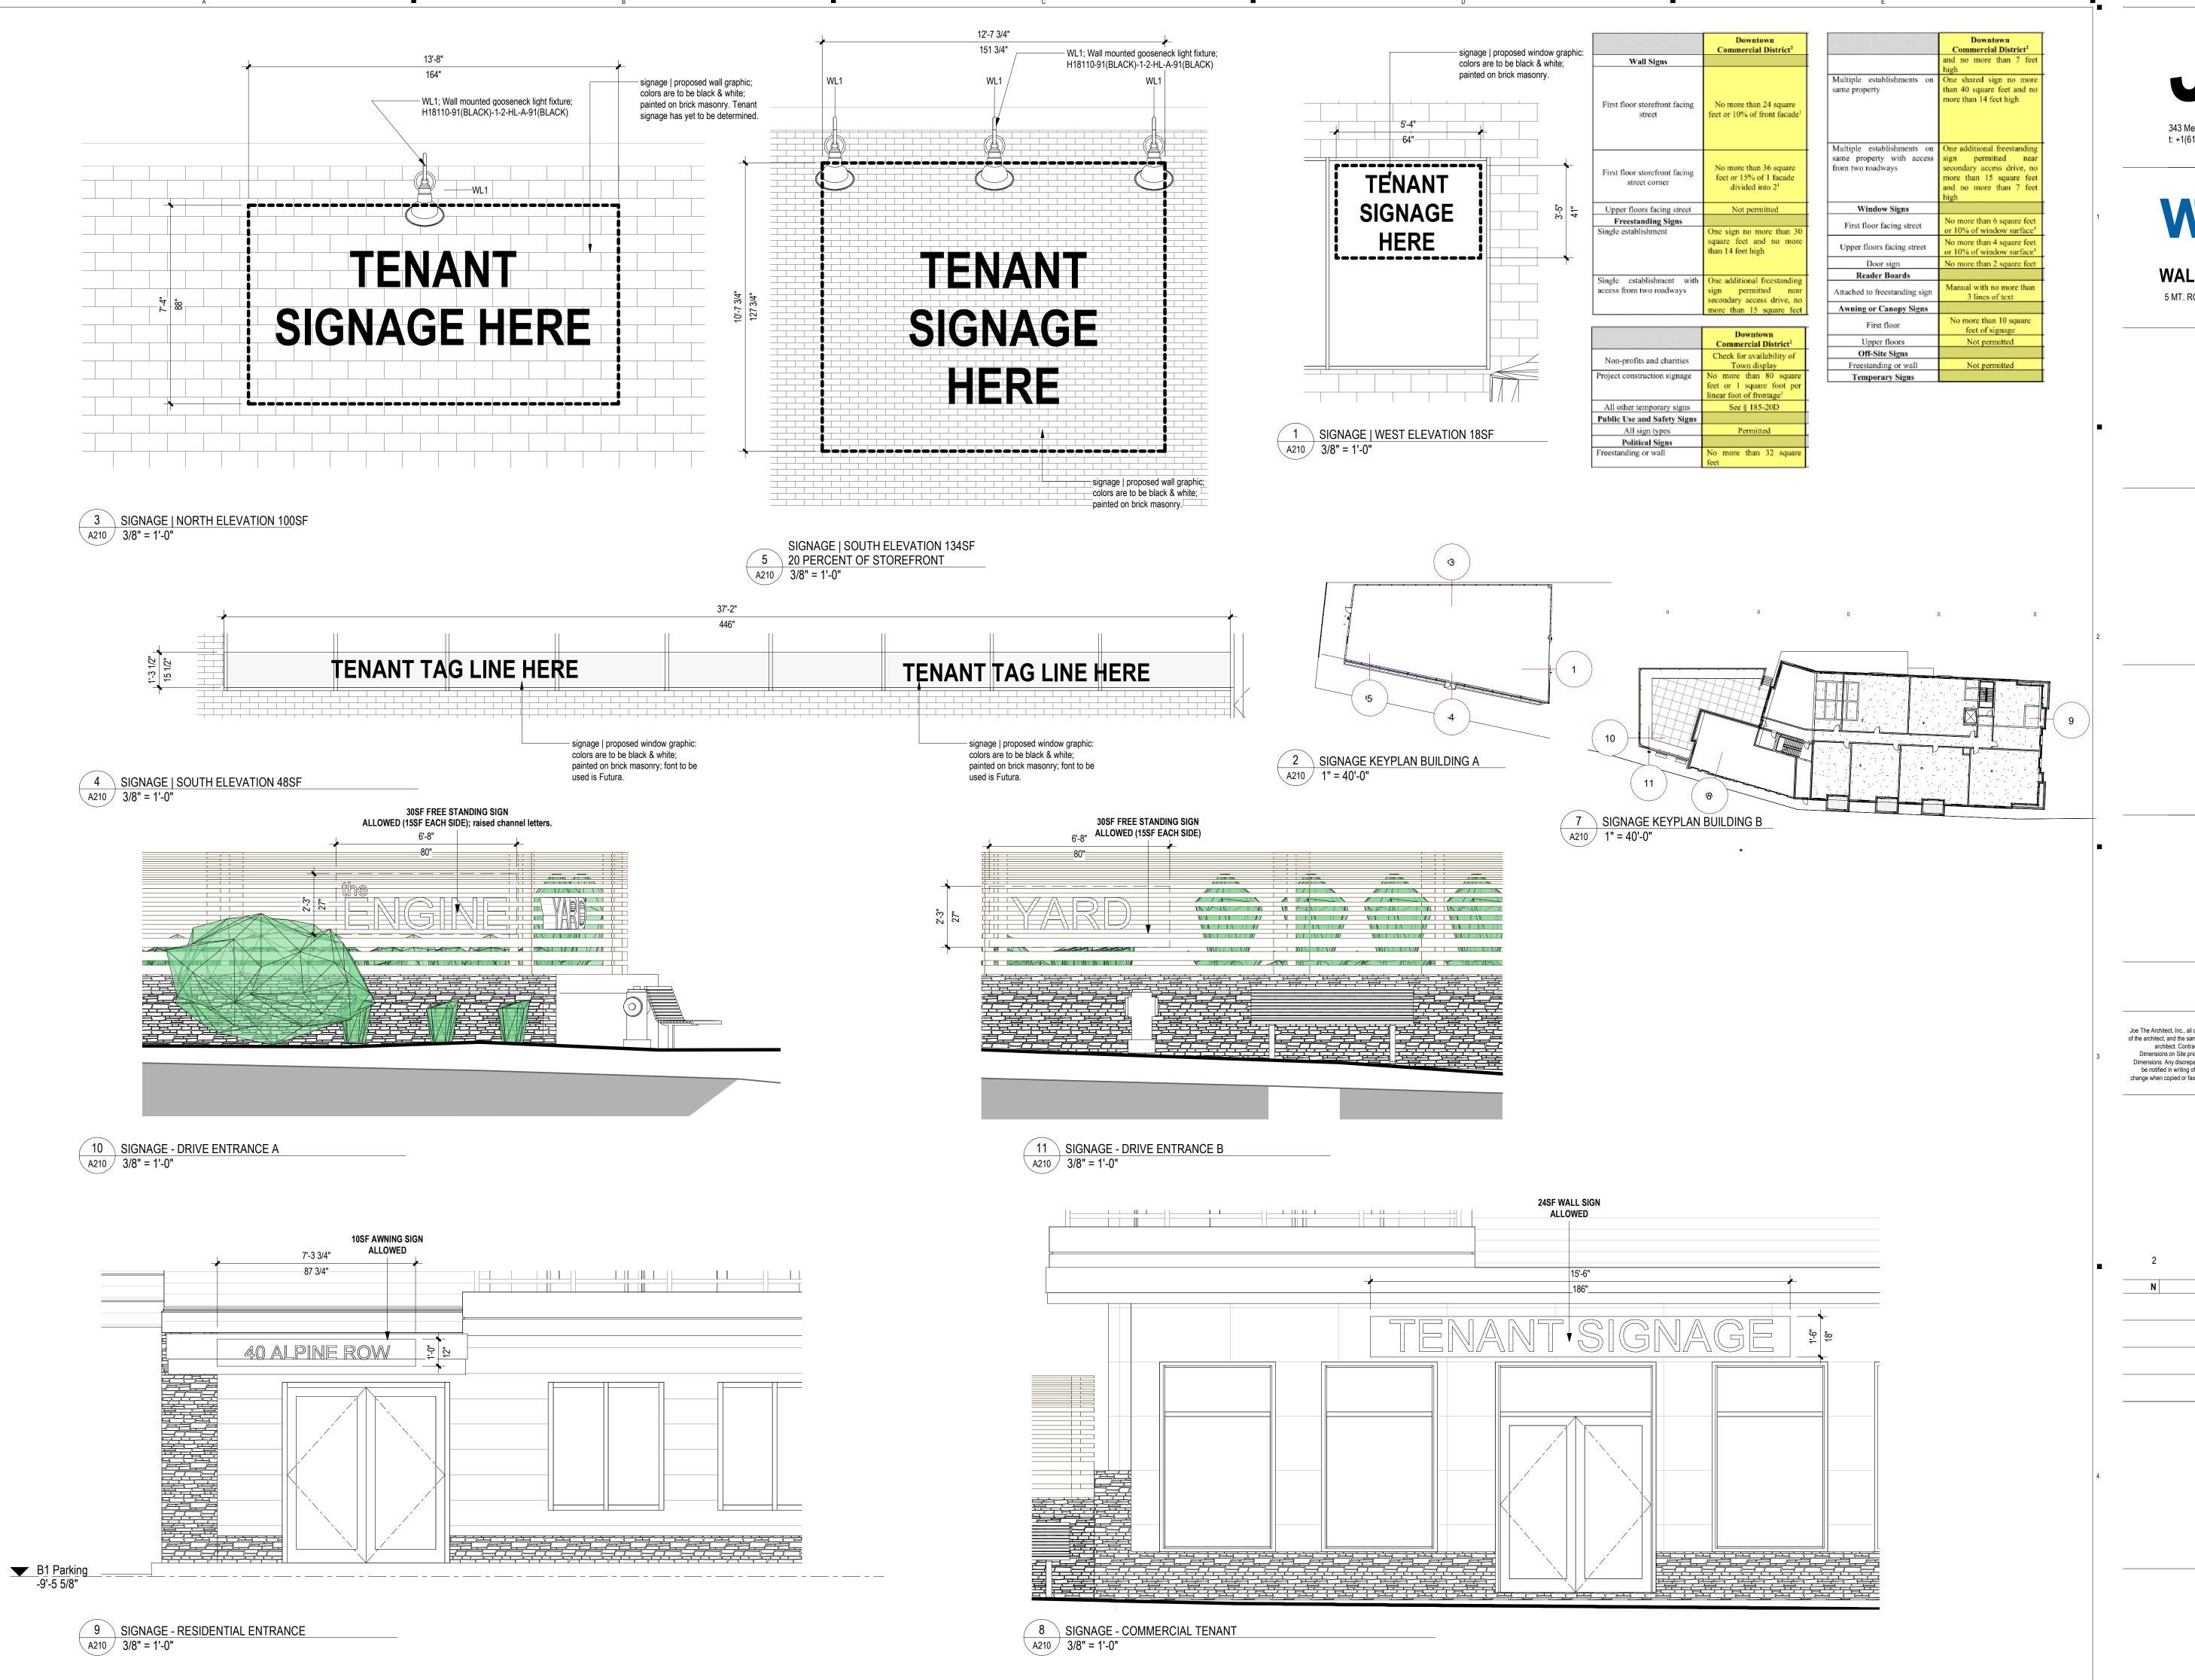

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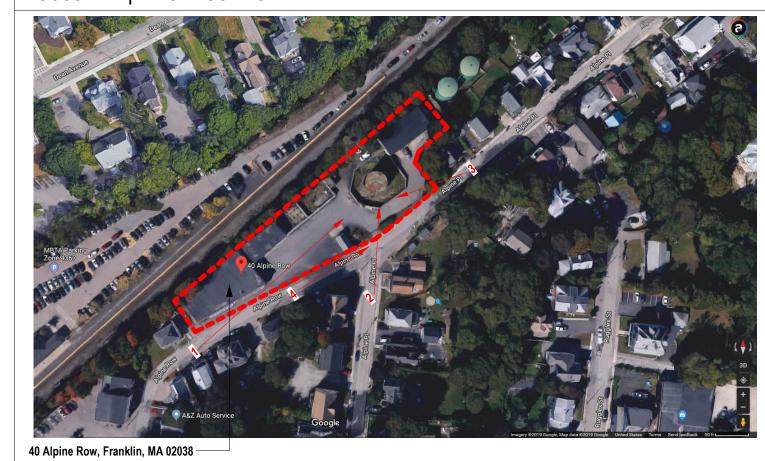
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DESIGN REVIEW **PROJECT NUMBER APPROVED** As indicated SHEET NAME

> **EXTERNAL SIGNAGE**

### LOCUS MAP | IMAGE LOCATION KEY



### GENERAL NOTES AND LEGENDS 3D VIEWS/RENDERING DISCLAIMER

the 3d views, photographs, and renderings on this sheet are to be used for general reference only. the contents of this sheet should not be used for any means of construction for the project. the contents of this sheet are strictly to provide a general idea of design intent. refer to the construction document technical drawings for specific information.
 landscaping is shown for illustration only. refer to landscape drawings for detailed information.







### WALKER DEVELOPMENT

5 MT. ROYAL AVENUE, MARLBOROUGH, MA 01752

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KEY PLAN

PROJECT INFORMATION THE ENGINE YARD

40 ALPINE ROW FRANKLIN, MA 02038

### FOR ZONING

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**DESIGN REVIEW** PLANNING BOARD

12" = 1'-0"

**PROPOSED** 

**RENDERINGS** 

**BUILDING** 

06/23/2021

SHEET NAME

PROJECT NUMBER







SHEET NUMBER

Tel: (508) 520-4907 Fax: (508) 520-4906

### Town of Franklin



### Design Review Commission

### Tuesday, June 15, 2021 Meeting Minutes

Chair James Bartro called the above-captioned meeting to order this date at 7:00 PM, **as a Remote Access Virtual Zoom Meeting.** Members in attendance: Chair James Bartro, Sam Williams, Mark Fitzgerald, Gerald Wood, Venkata Sompally. Members absent: Chris Baryluk. Also present: Maxine Kinhart, Administrative Assistant.

As stated on the agenda, due to the continued concerns regarding the COVID-19 virus, this meeting will be conducted as a Remote/Virtual Design Review Commission meeting. In an effort to ensure citizen engagement and comply with open meeting law regulations, citizens will be able to dial into the meeting using the provided phone number, or citizens can participate by using the Zoom link provided on the agenda.

Chair Bartro authorized Associate member Venkata Sompally to vote.

Note: Agenda items taken out of order.

1. Botera – 1256 West Central Street- Install two sets of channel letter signs and update freestanding sign.

Two representatives of Best Price Signs and Printing, representing the applicant, addressed the Commission. Representative stated there is currently a free-standing pylon sign; however, it is damaged to some capacity. They will be updating the sign. She stated that they will also install two sets of channel letter signs on the building of size 12' long x 2' tall. She reviewed the location of the two building signs and the location of the entrance door to the building. She confirmed the sign will be internally lit. Chair Bartro stated that he would like to see the white background have a translucency to help the light go through the logo and the letters. The representative stated that was not a problem. Mr. Fitzgerald noted that there were spaces for four signs on the pylon. He asked if there were space in the building for four tenants. He noted that at this time, Botera has maxed out the allowable signage on the building. Additional tenants could only use the pylon sign. The representative stated that Ford Auto Works already has a sign above the garage on the building. She noted that Botera owns the building. Mr. Fitzgerald suggested Botera, as the building owner, return to the Commission with a uniform presentation; the four tenants cannot have multiple signs all over the building as Botera has already utilized the allowed 48 sq. ft. of signage. He stated that the Commission can approve the pylon at this time. Chair Bartro requested the applicant provide a sign attachment method. The applicant agreed to return to the next Design Review Commission meeting regarding the building signage.

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**Motion:** To **Approve** the pylon sign as submitted with the stipulation of the shielding on the white background at night. Motioned by M. Fitzgerald. Seconded by S. Williams. Roll Call Vote: Bartro-YES; Williams-YES; Wood-YES; Sompally-YES; Fitzgerald-YES. Voted 5-0-0.

2. Shops at Franklin – 340 East Central Street- Install new double sided, internally illuminated pylon sign.

Christopher Ramm of Poyant Signs addressed the Commission. He reviewed the sign package submission to install new multiple tenants, double sided, internally illuminated pylon sign. He stated this passed through the ZBA. Chair Bartro stated that he had concerns about the white background. He stated that the Commission will need to review the signs for each individual tenant. Mr. Fitzgerald discussed the location of the signs on the building and the location of cables.

**Motion:** To **Approve** the sign cabinet as submitted with the condition that each tenant present their sign for review individually or as a group; this motion is not an approval of the individual tenant signs. Motioned by S. Williams. Seconded by G. Wood. Roll Call Vote: Bartro-YES; Williams-YES; Wood-YES; Sompally-YES; Fitzgerald-YES. Voted 5-0-0.

3. **iFixPhones** – **15 East Central Street-** Install a sign without connecting to electricity.

Chair Bartro confirmed there was no representative for this item present at the Zoom meeting. He stated that he still has concerns about the sign and attachment method shown on the submittal.

### **General Matters:**

Chair Bartro stated that Chris Baryluk submitted a letter requesting to step down as Vice Chair of the Design Review Commission and requested to become an Associate member of the Commission.

**Motion:** To **Nominate** Sam Williams as Vice Chair. Motioned by J. Bartro. Seconded by G. Wood. Roll Call Vote: Bartro-YES; Williams-YES; Wood-YES; Sompally-YES; Fitzgerald-YES. Voted 5-0-0.

Commission members agreed to recommend Venkata Sompally as Full member of the Commission.

### Approval of Meeting Minutes: May 18, 2021 and June 1, 2021

Commission members reviewed the meeting minutes. The sign approval and procedure for the Pop Shops was discussed. Chair Bartro stated that he was going to send a note to Building Commissioner Gus Brown regarding Pop Shop signage.

**Motion:** To **Approve** the May 18, 2021 Meeting Minutes as presented. Motioned by G. Wood. Seconded by S. Williams. Roll Call Vote: Bartro-YES; Williams-YES; Wood-YES; Sompally-YES; Fitzgerald-YES. Voted 5-0-0.

Chair Bartro noted that a letter was sent to Ms. Whalen; the Commission has not heard back from Ms. Whalen.

**Motion:** To **Approve** the June 1, 2021 Meeting Minutes as presented. Motioned by S. Williams. Seconded by G. Wood. Roll Call Vote: Bartro-YES; Williams-YES; Wood-YES; Sompally-YES; Fitzgerald-YES. Voted 5-0-0.

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**Motion** to **Adjourn** by G. Wood. Seconded by V. Sompally. Roll Call Vote: Bartro-YES; Williams-YES; Wood-YES; Sompally-YES; Fitzgerald-YES. Voted 5-0-0.

Meeting adjourned at 7:36 PM.

Respectfully submitted,

\_\_\_\_\_\_Iudith Lizardi

Judith Lizardi Recording Secretary