# SITE PLAN 175 EAST CENTRAL STREET FRANKLIN MASSACHUSETTS



#### ZONING:

THE FRANKLIN FORD SITE IS LOCATED WITHIN A COMMERCIAL II ZONE.

	REQUIREMENTS:	EXISTING	PROPOSED
INDUSTRIAL			
AREA:	40,000 S.F.	226,697± S.F.	226,697± S.F.
FRONTAGE:	175'	243.21	243.21'
DEPTH:	200'	759'±	759'±
HEIGHT:	3 STORIES 40'	21.1'	21.1' - 1 STOR
WIDTH:	157.5'	> 157.5'	> 157.5'
COVERAGE -	-		
STRUCTURES		12.1%	15.6%
STRUC. & P	AVING: 80%	66.6%	76.3%
SETBACKS-			
FRONT:	40'	55.9'	55.9'
RIGHT SIDE:	30"	54.1'	37.2'
LEFT SIDE	30'	20'	20'
REAR:	30'	37.8	37.8'

LOT COVERAGE CALCULATION AREA BASED ON UPLAND AREA

THE ENTIRE PROPERTY IS LOCATED WITHIN A FRANKLIN WATER RESOURCE DISTRICT AND A DEP ZONE II.
THE SITE AREA PROPOSED FOR DEVELOPMENT IS LOCATED IN A ZONE X BASED ON FEMA FIRM MAP 25021C0309E DATED JULY 17, 2012.

AREA WITHIN THE WATER RESOURCE DISTRICT - 226,697 $\pm$  SQ. FT. UPLAND AREA WITHIN THE WATER RESOURCE DISTRICT - 177,773 $\pm$  SQ. FT. IMPERVIOUS AREA WITHIN THE WATER RESOURCE DISTRICT - 135,580± SQ. FT. COVERAGE WITHIN THE WATER RESOURCE DISTRICT - = 76.3%

FRANKLIN FORD: BUILDING USE - AUTOMOBILE DEALERSHIP.

> ASSESSORS MAP 285 PARCEL 090-000-000 DEED BOOK 28674 PAGE 487 ASSESSORS MAP 285 PARCEL 092-000-000 DEED BOOK 3788 PAGE 197 PLAN 826 OF 1997 LIMITED SITE PLAN FRANKLIN FORD, LLC DATED SEPTEMBER 11, 2013 AND ENDORSED ON OCTOBER 21, 2013.

#### DRAWING INDEX:

1. COVER SHEET

- 2. EXISTING CONDITIONS PLAN
- 3. SITE LAYOUT PLAN
- 4. SITE GRADING AND UTILITY PLAN
- 5. SITE PLANTING PLAN
- 6. EROSION CONTROL PLAN
- 7. CONSTRUCTION DETAILS 1
- 8. CONSTRUCTION DETAILS 2 SITE LIGHTING-LIGHTING PLAN, PHOTOMETRICS AND SCHEDULES

BY SK & ASSOCIATES

MAP 285 PARCEL 090-000-000 FRANKLIN FORD, LLC 175 EAST CENTRAL STREET FRANKLIN, MASSACHUSETTS

MAP 285 PARCEL 092-000-000 HERBERT CATALANO 9 CHESTNUT STREET FRANKLIN, MASSACHUSETTS

APPLICANT: FRANKLIN FORD, LLC 175 EAST CENTRAL STREET FRANKLIN, MASSACHUSETTS

> SITE PLAN COVER SHEET

175 EAST CENTRAL STREET FRANKLIN, MASSACHUSETTS PREPARED FOR FRANKLIN FORD, LLC 175 EAST CENTRAL STREET FRANKLIN, MASSACHUSETTS

APRIL 14, 2022 SCALE: 1'' = 40'

SITE PLAN APPROVAL FRANKLIN PLANNING BOARD

3. TO ALLOW MINIMAL LIGHT SPILLAGE ONTO THE CHESTNUT

WAIVER REQUESTED:

MANIFOLDS AND POND 1.

STREET RIGHT OF WAY.

PIPE. PROPOSED CLASS V RCP.

DATE

GRAPHIC SCALE ( IN FEET ) 1 inch = 100 ft.


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	12.		allow Allueta State	4/22	DRAWN BY:	COMP	
DATE	DESCRIPTION	BY	CARLOS A. QUINTAL P.E. #30612	4/22	CHECKED BY:	CAQ	


**T NITED** INT. FIELD BOOK PG# 4/22 | CALCS BY: RRG 4/22 DESIGNED BY: RRG 850 FRANKLIN STREET SUITE 11D


WRENTHAM, MASSACHUSETTS 02093


508-384-6560 FAX 508-384-6566


APRIL 14, 2022 1" = 200'PROJECT UC1007 SHEET 1 of 8

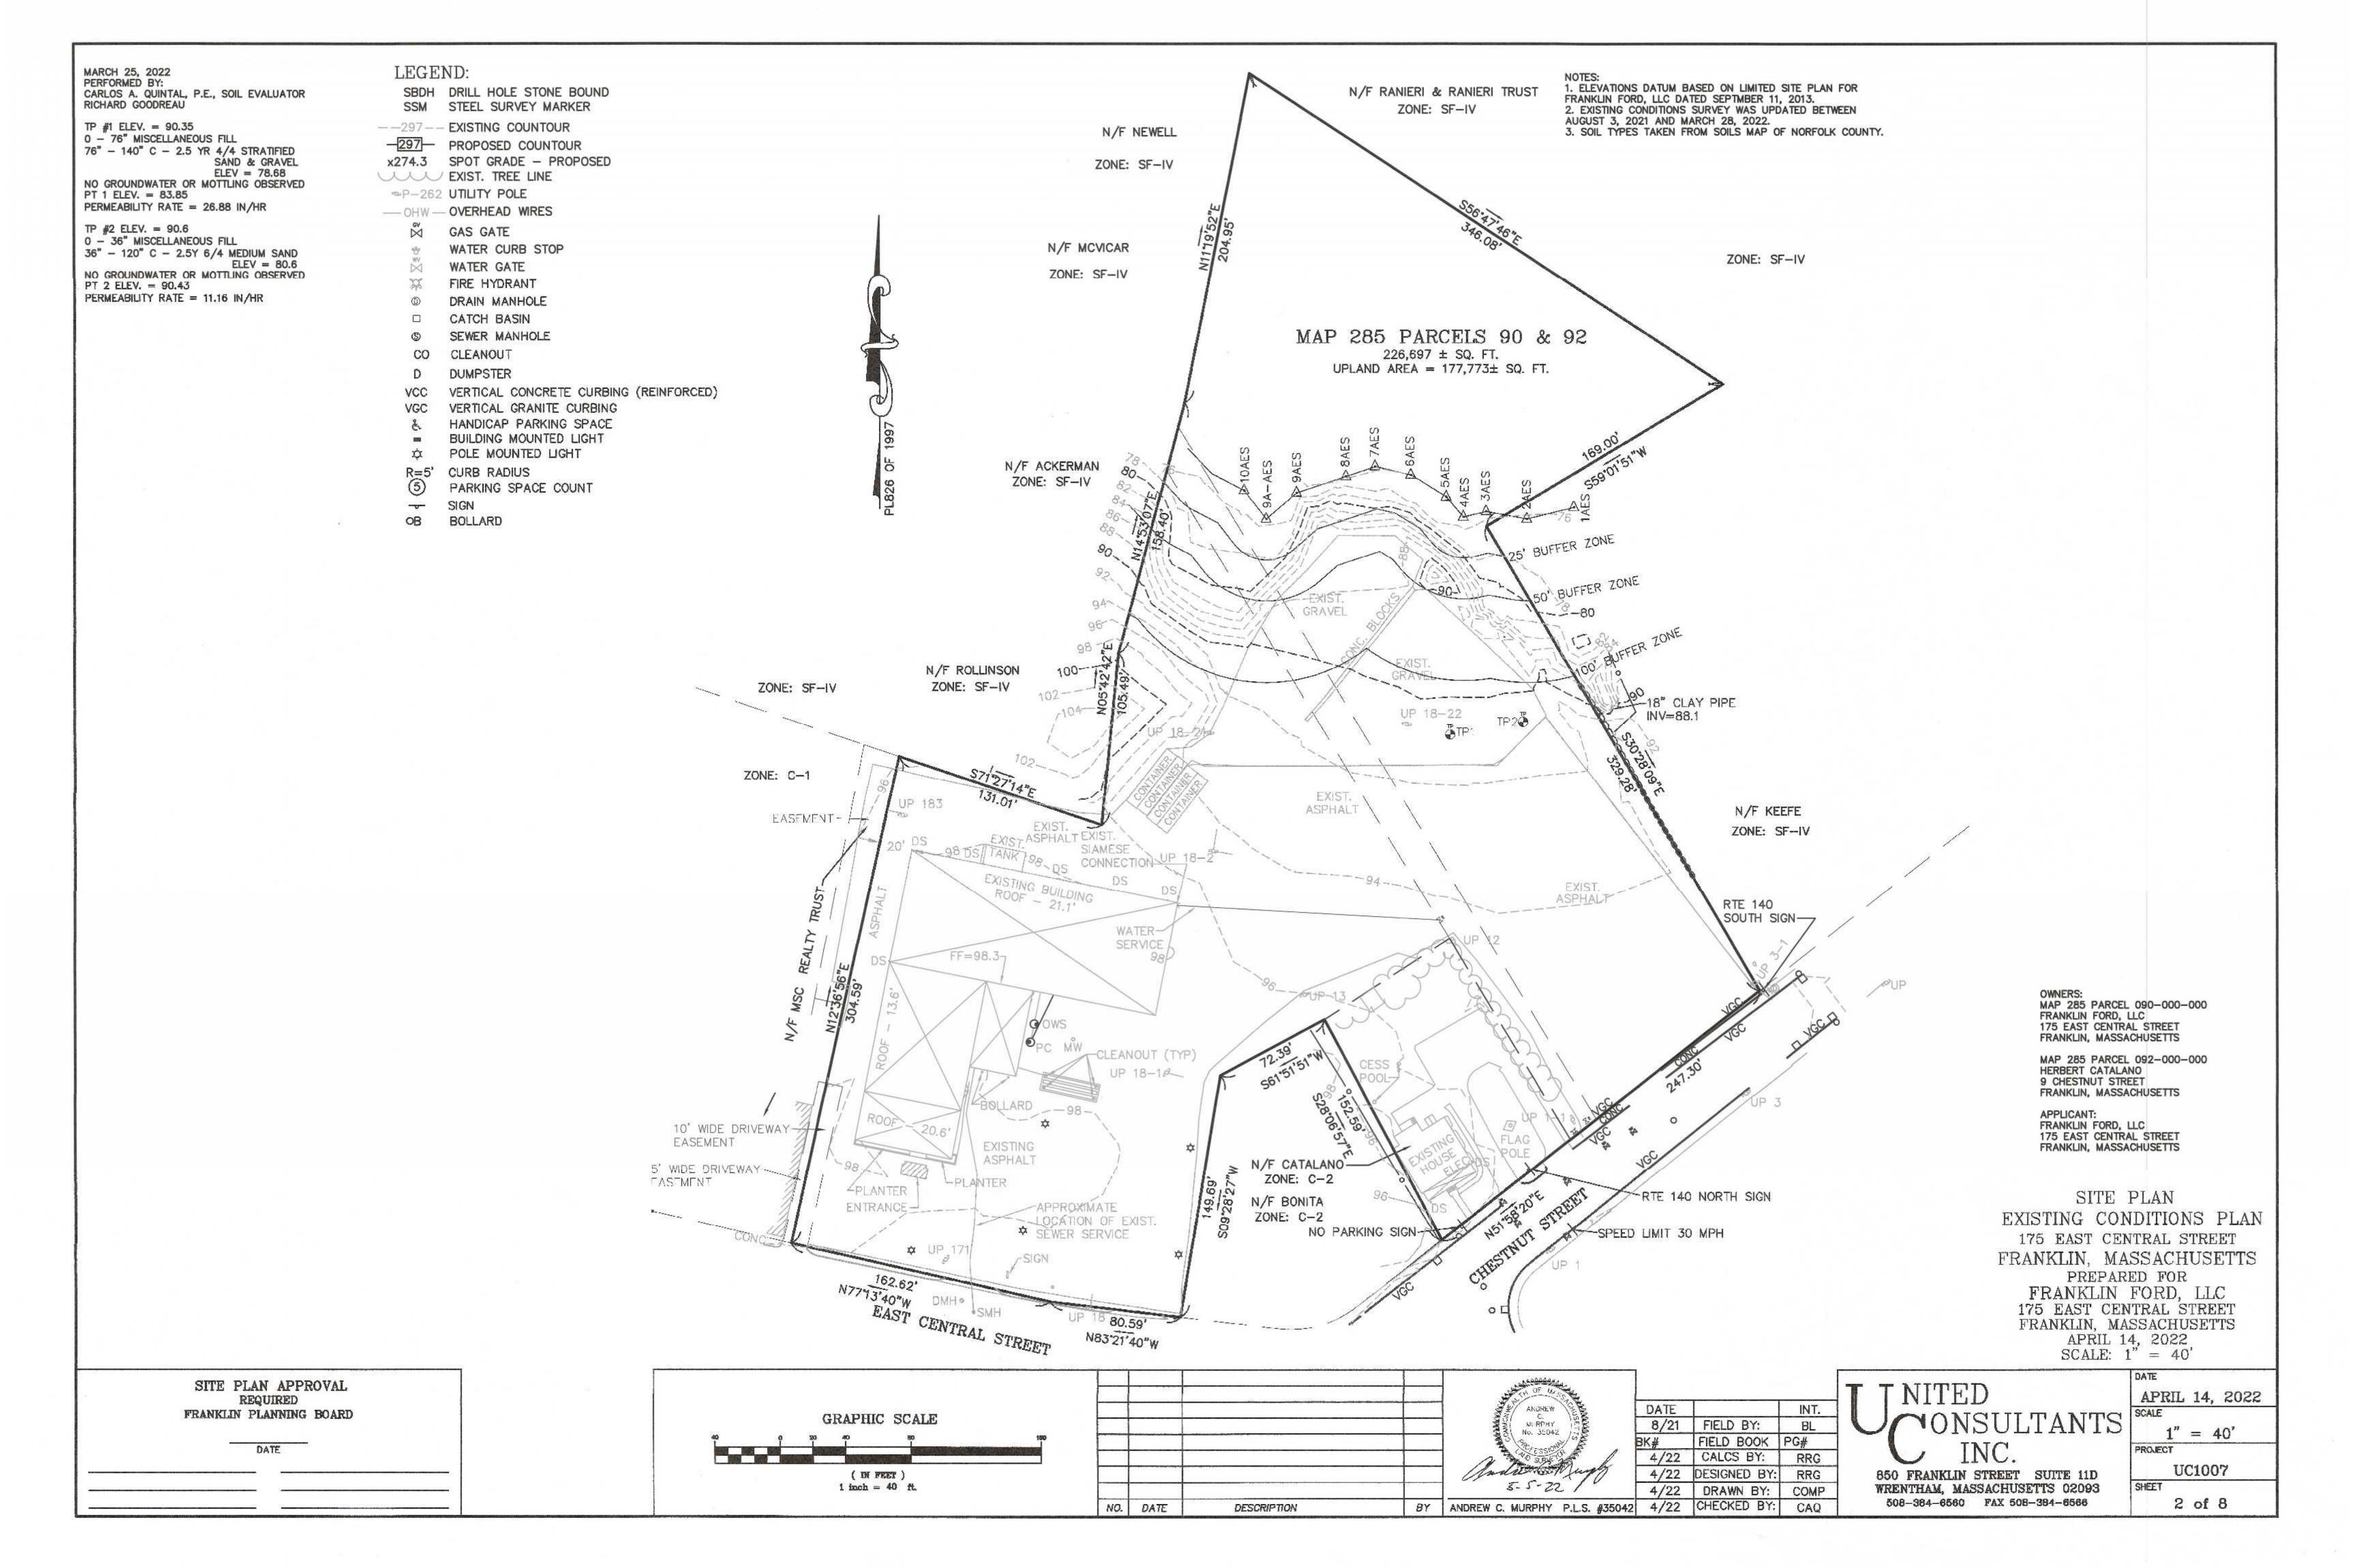


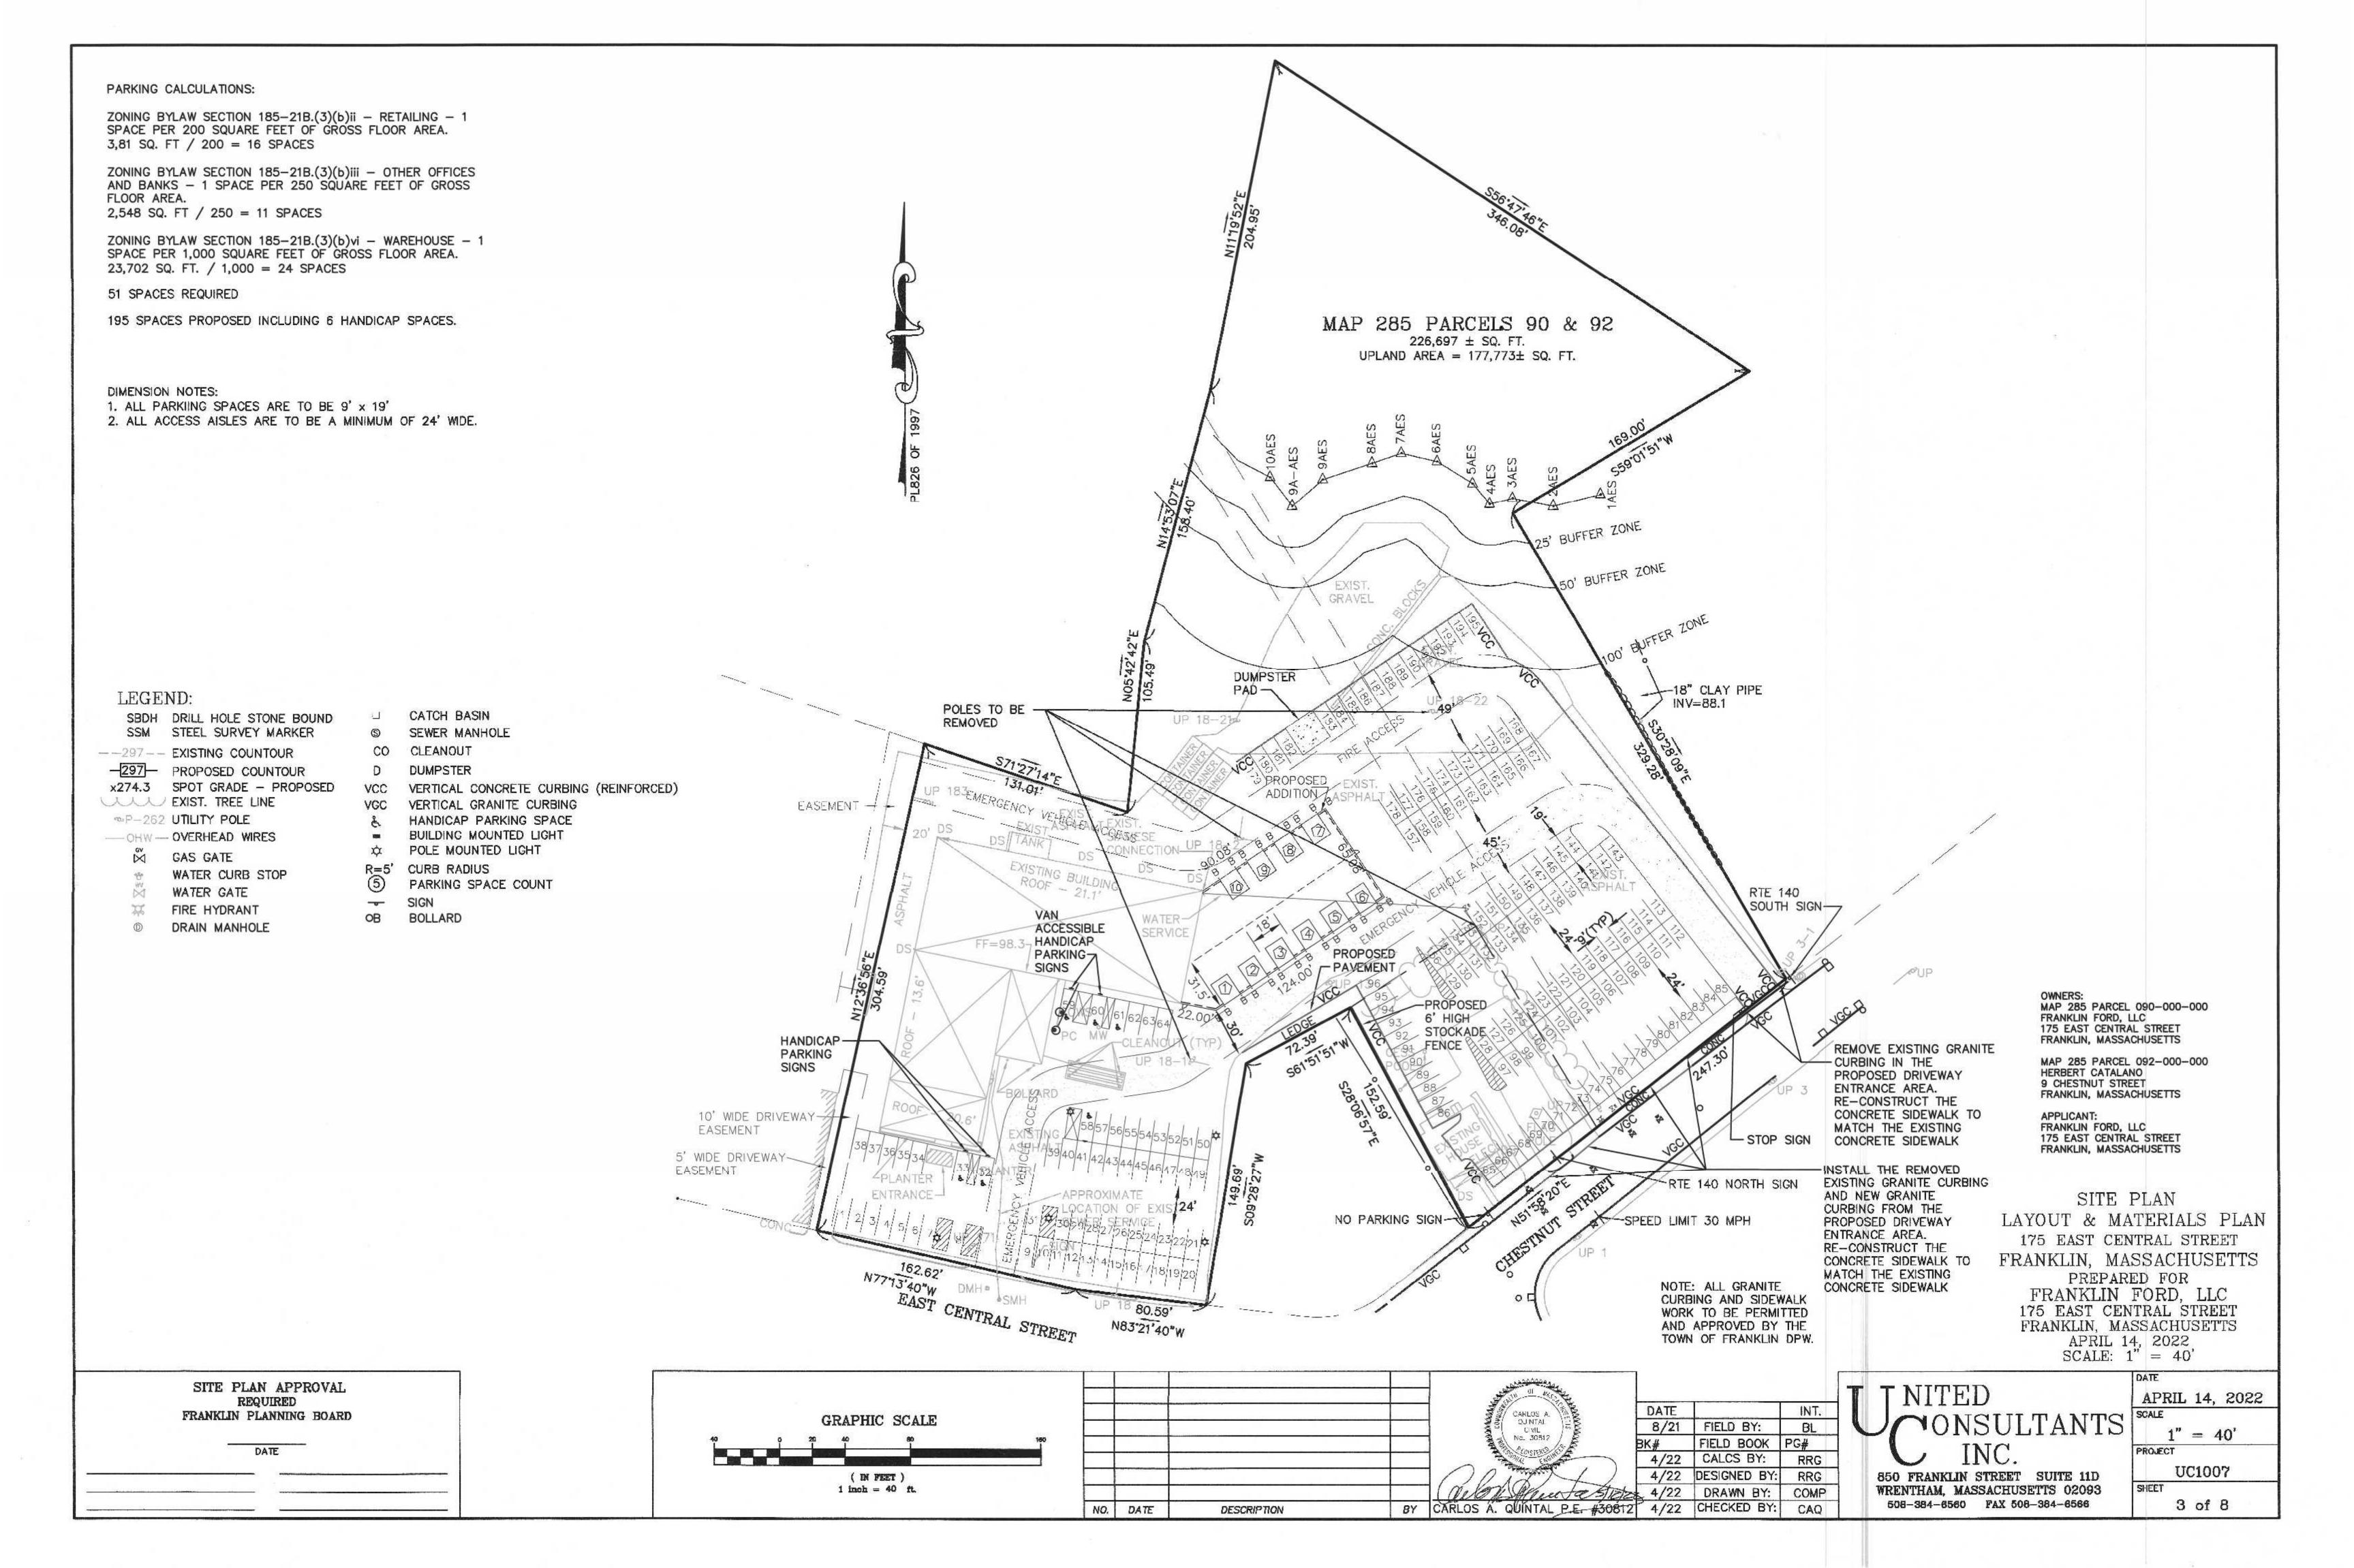

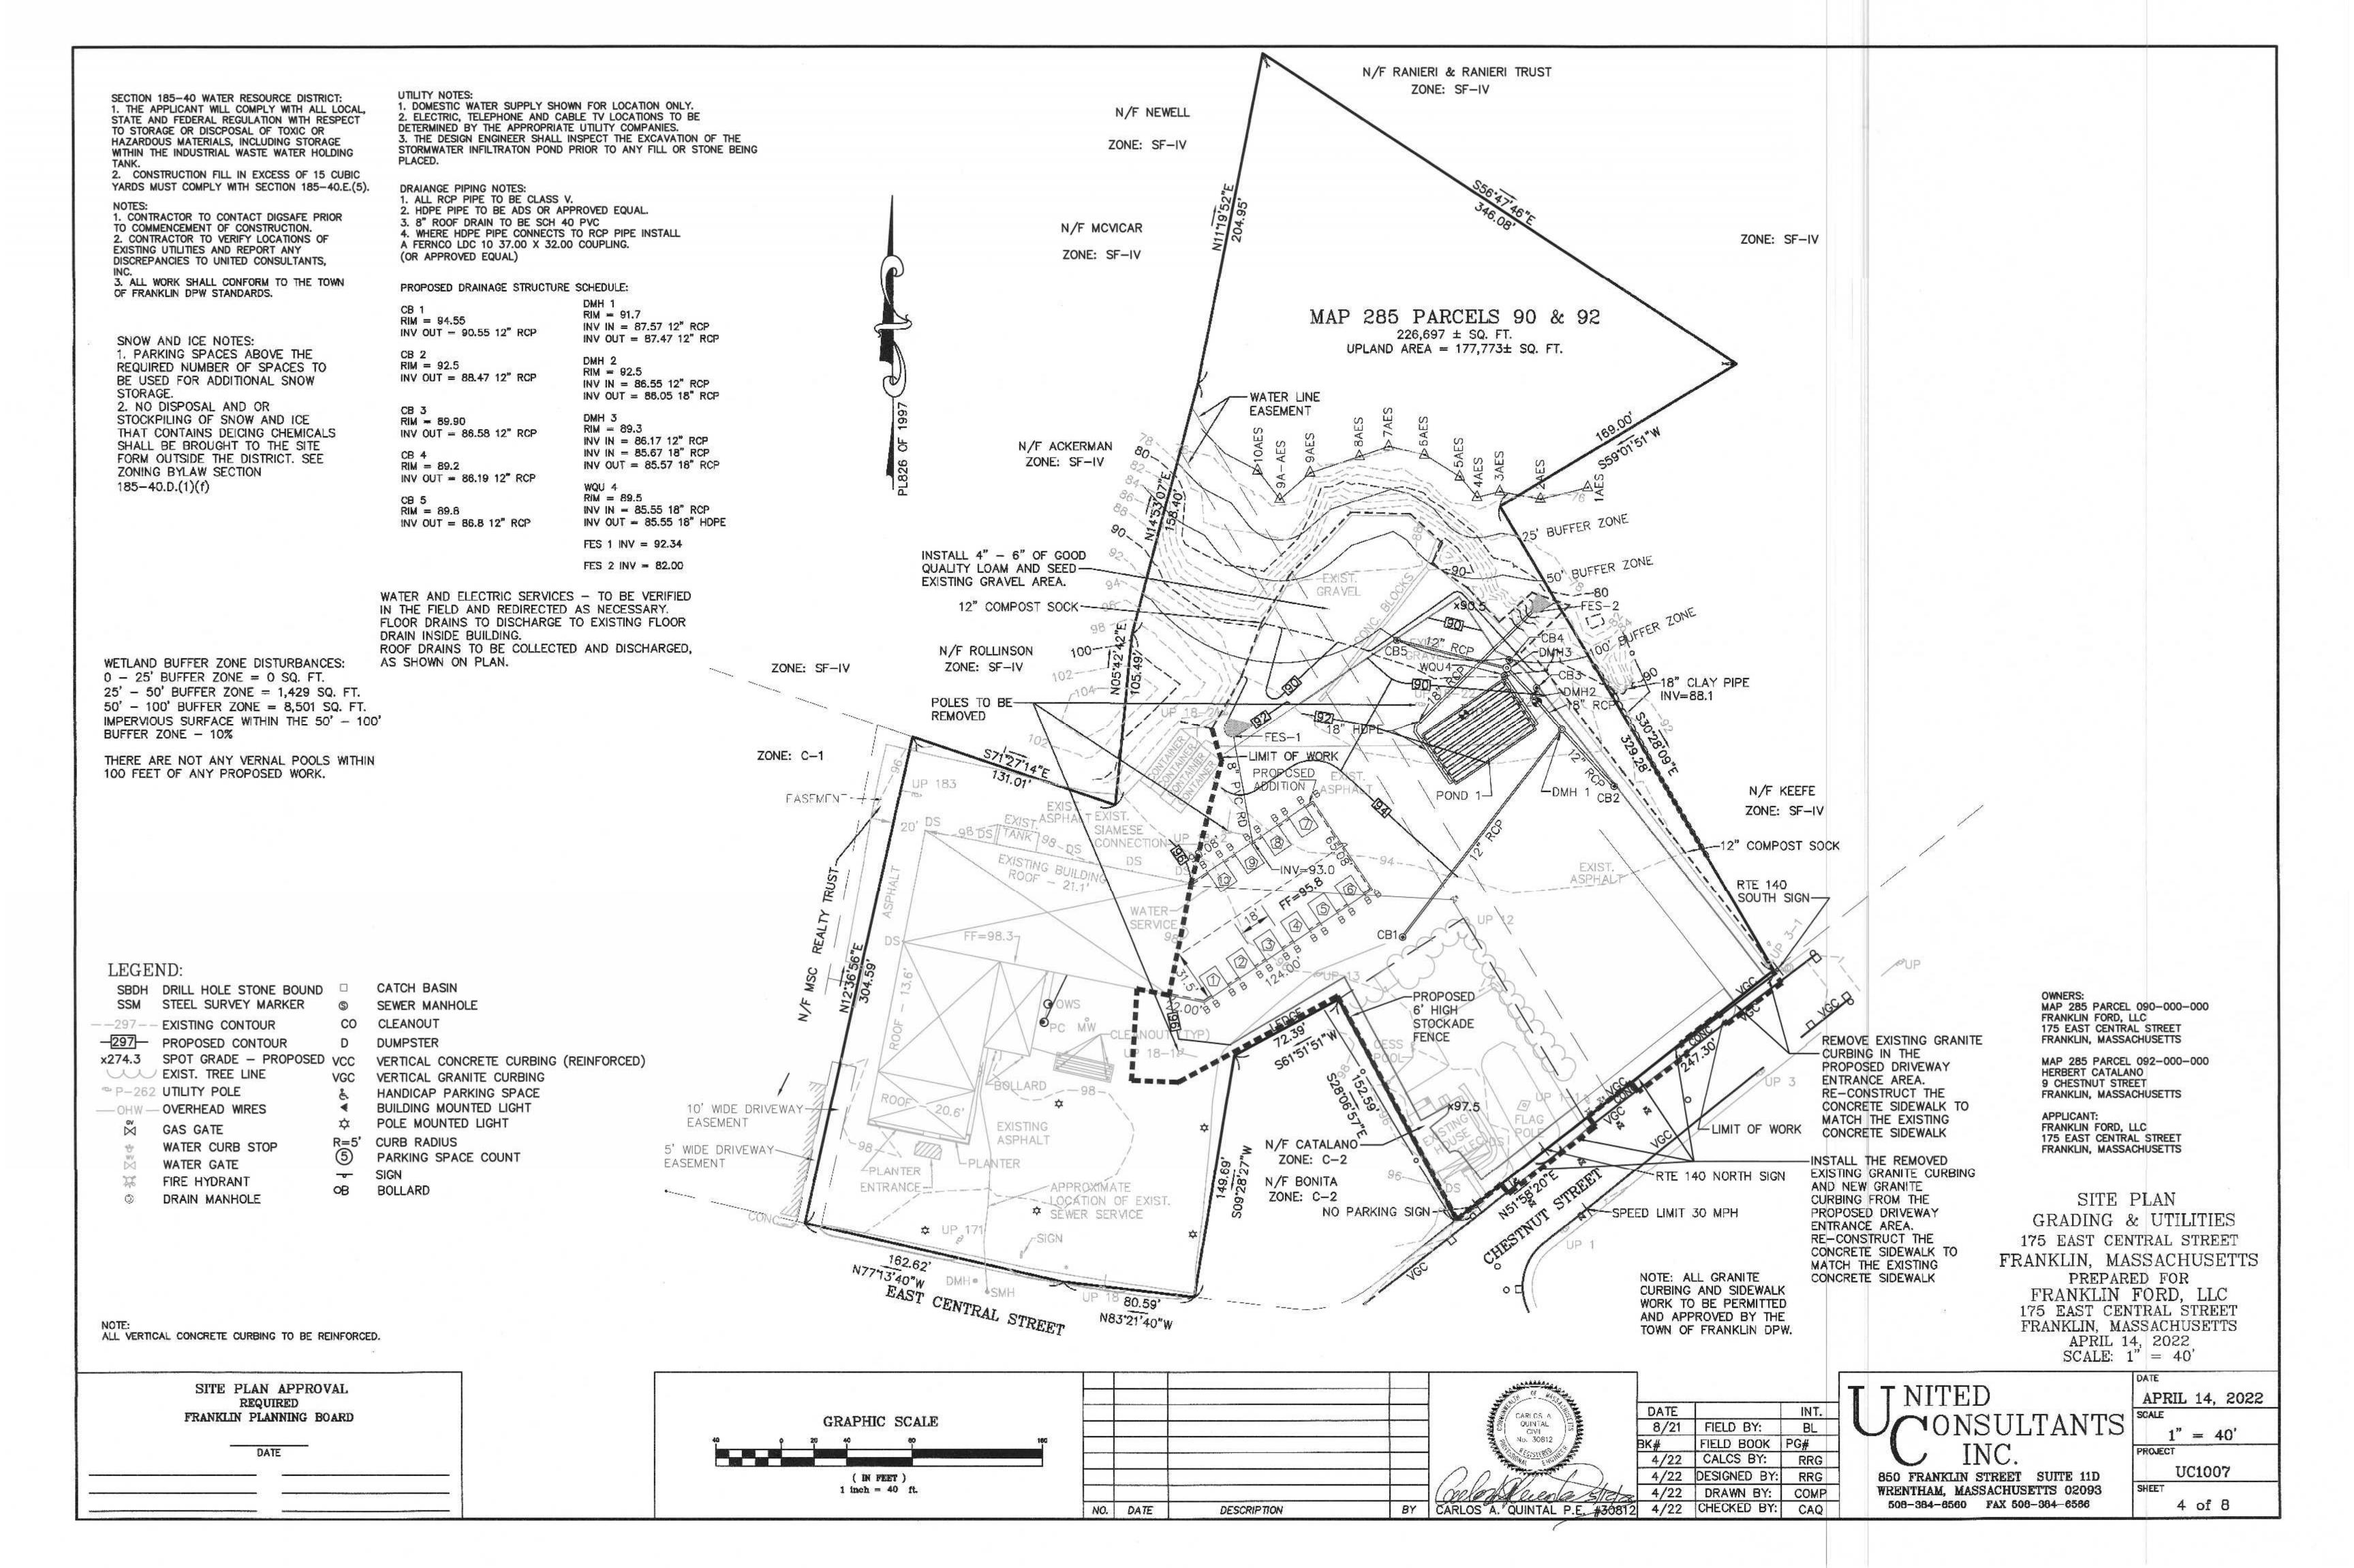

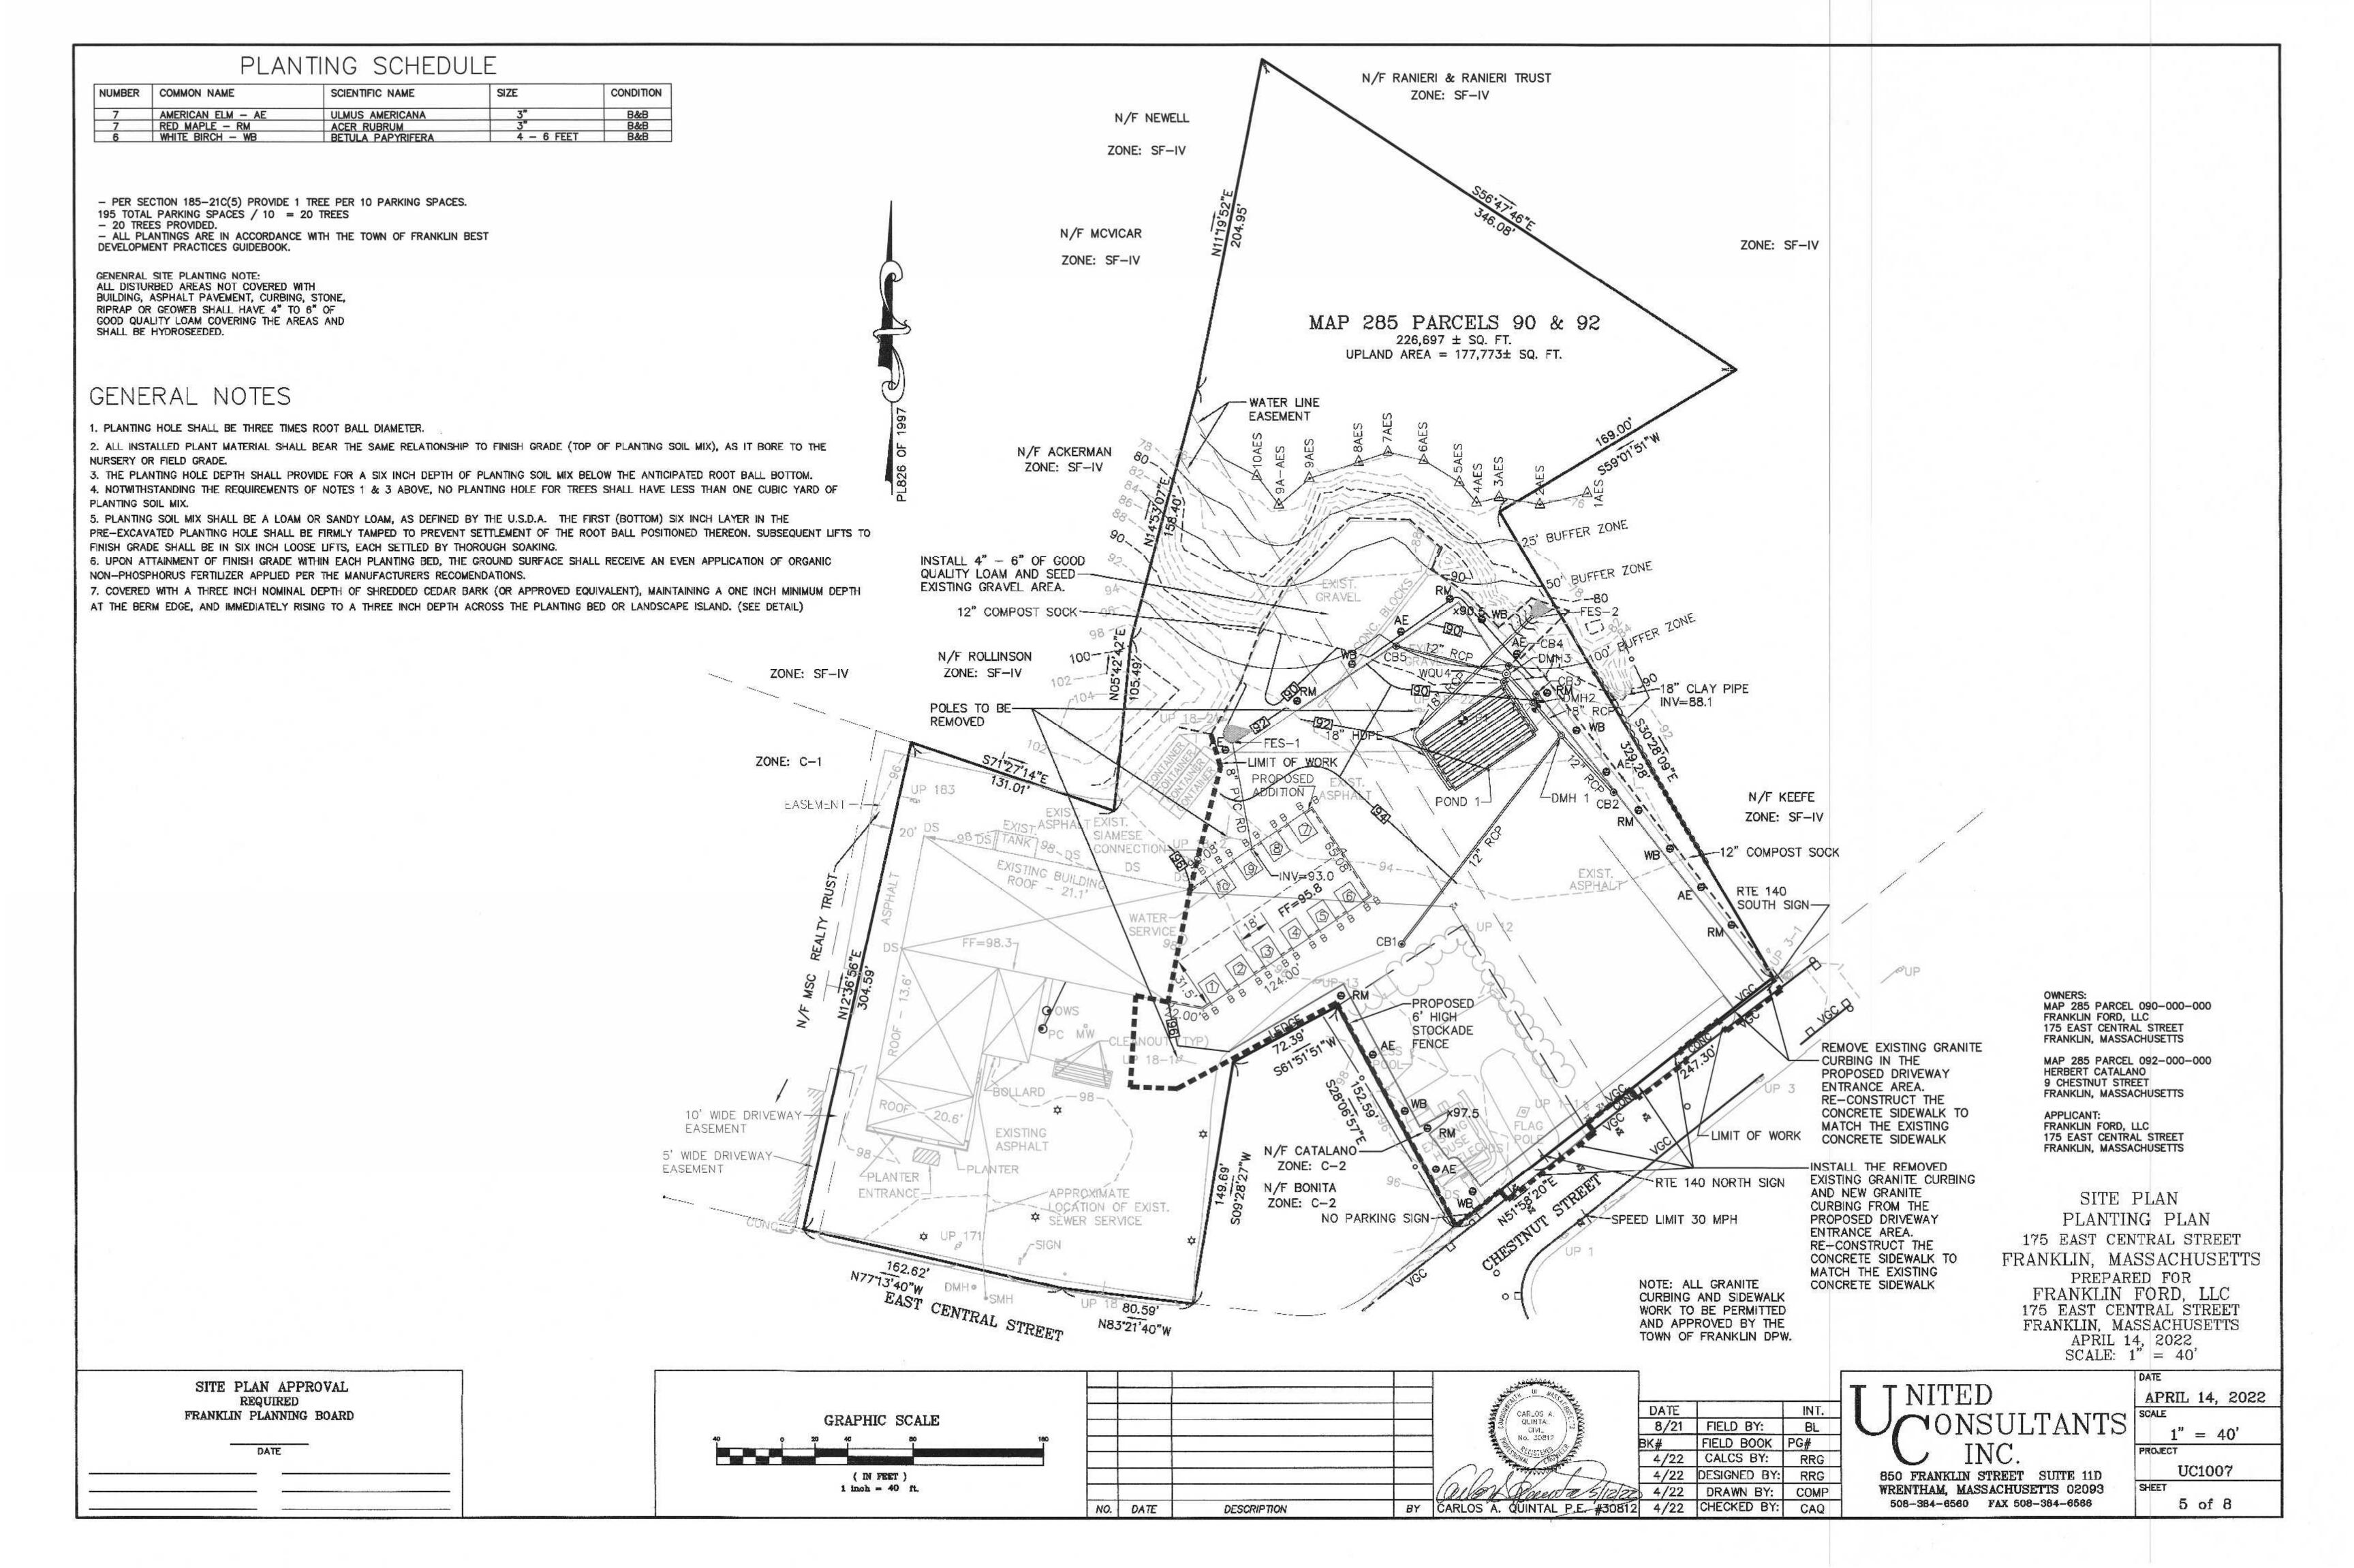

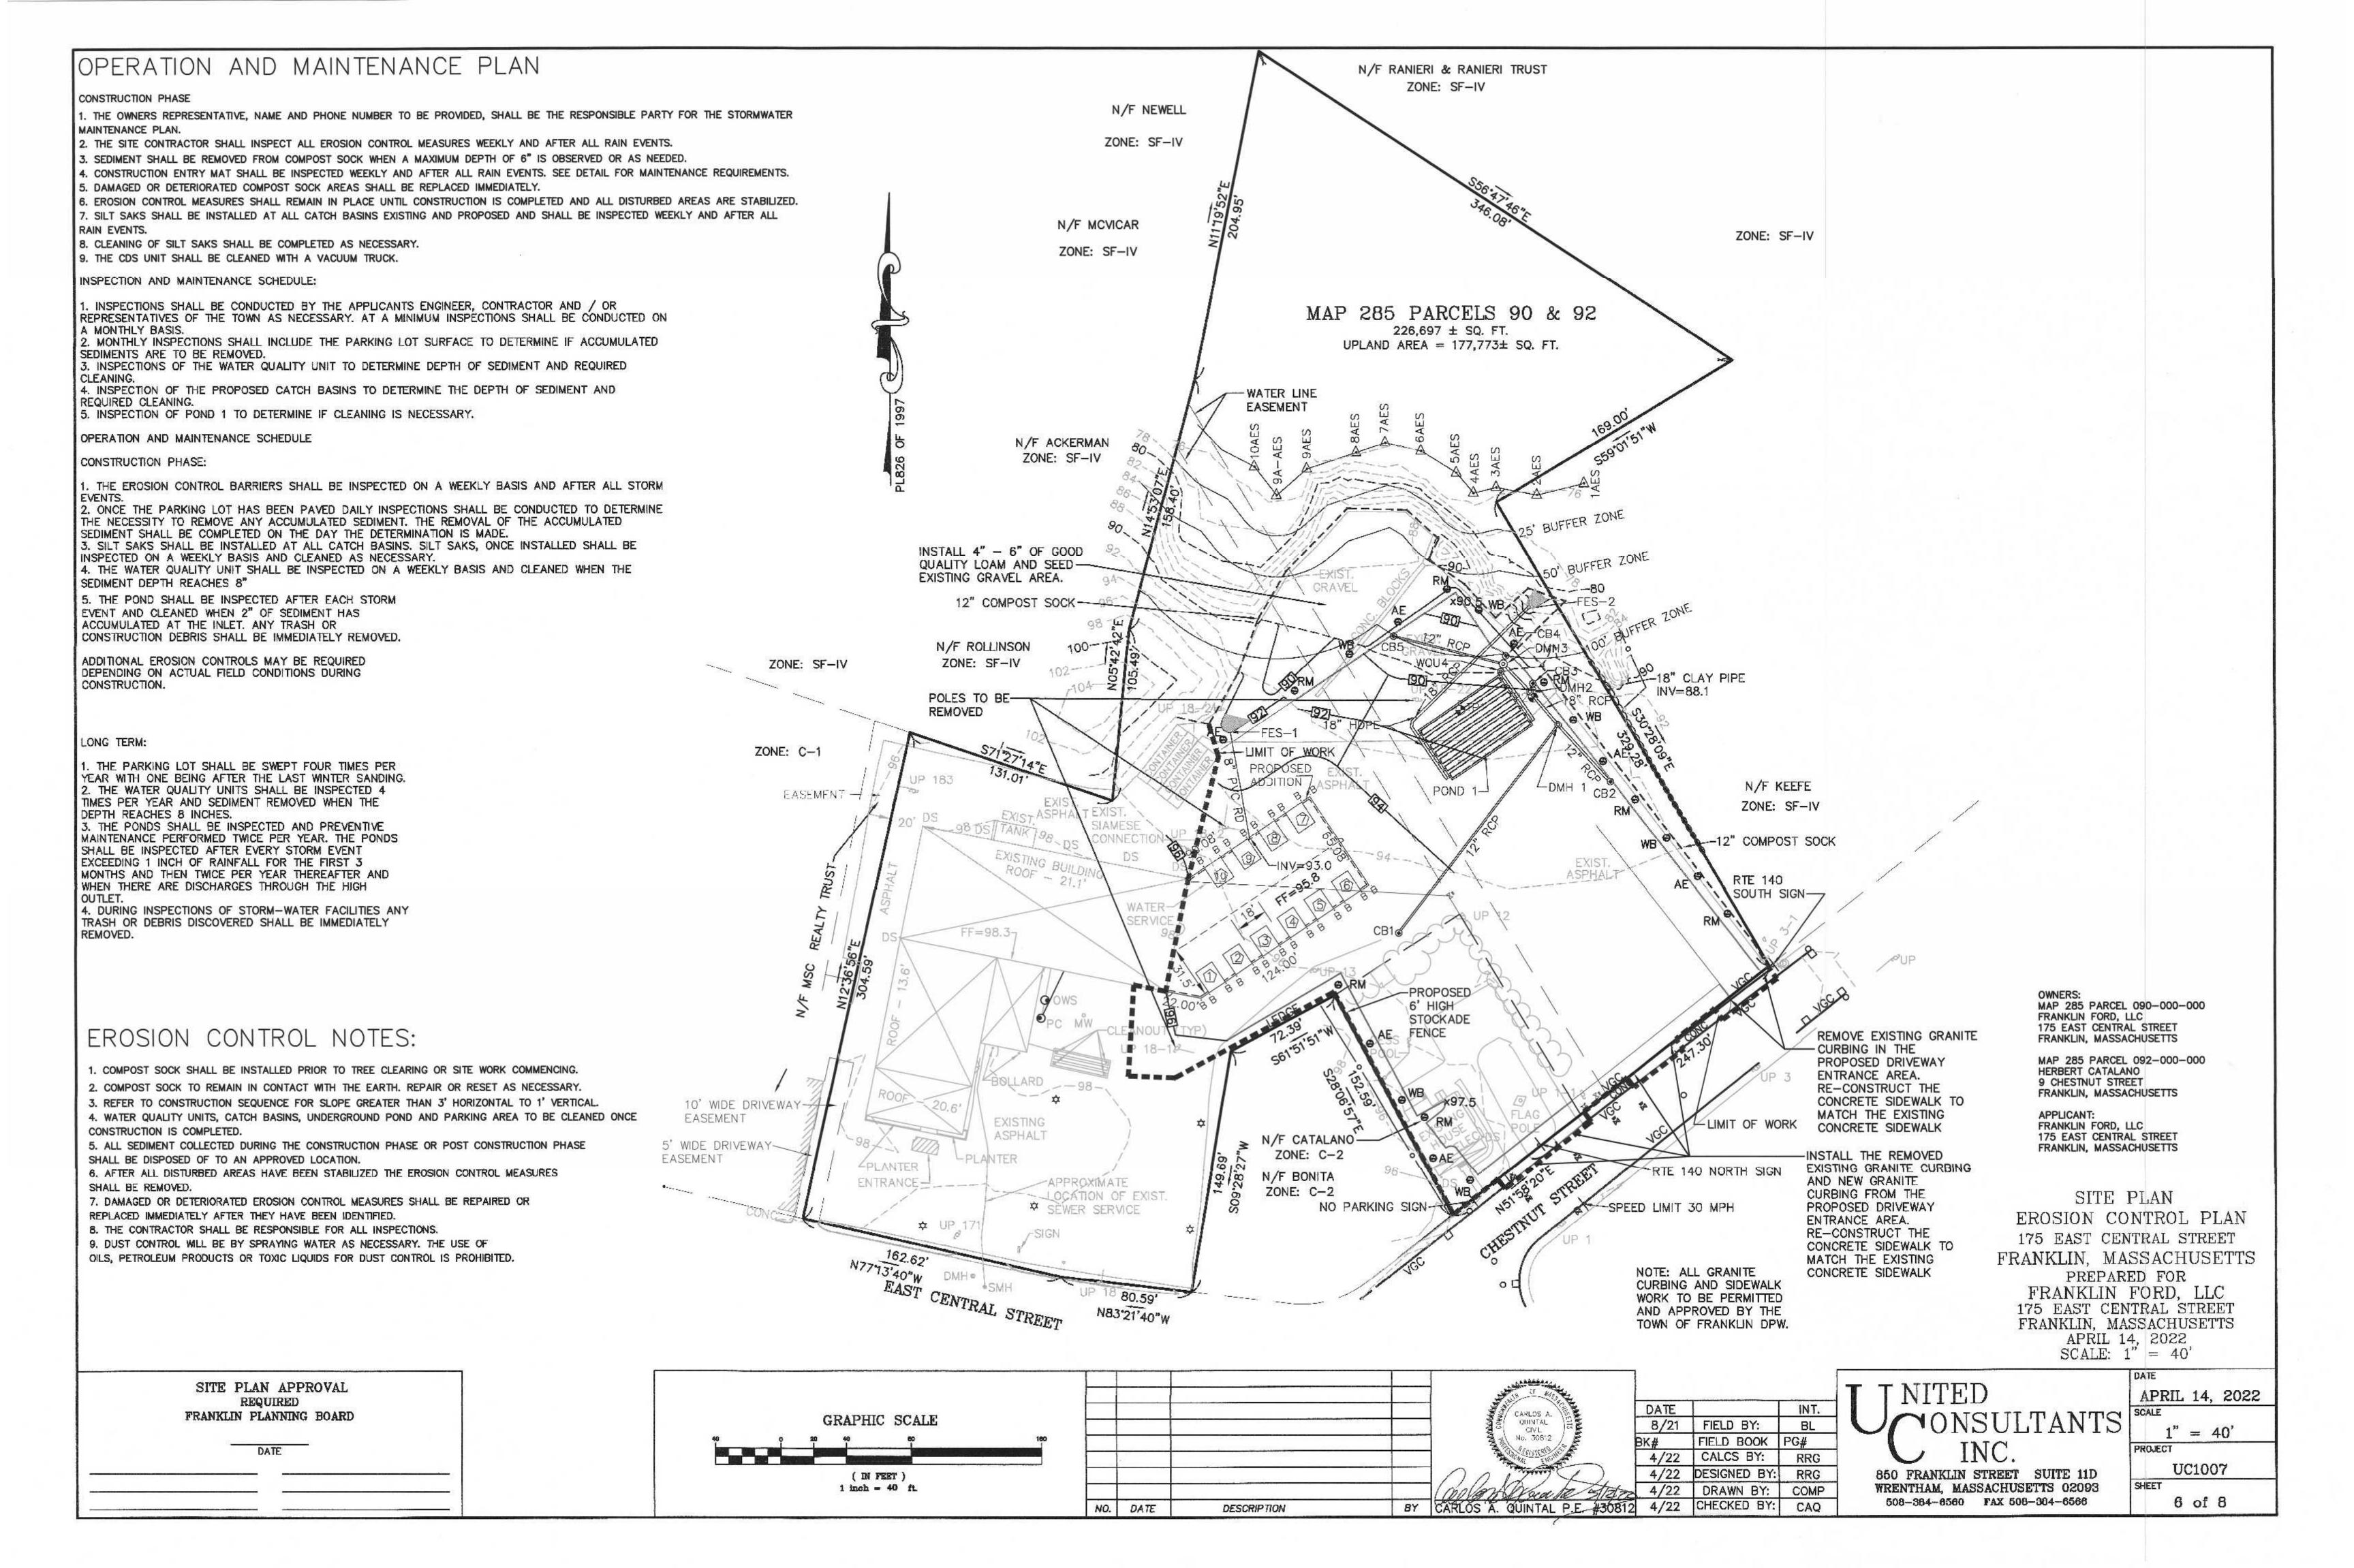

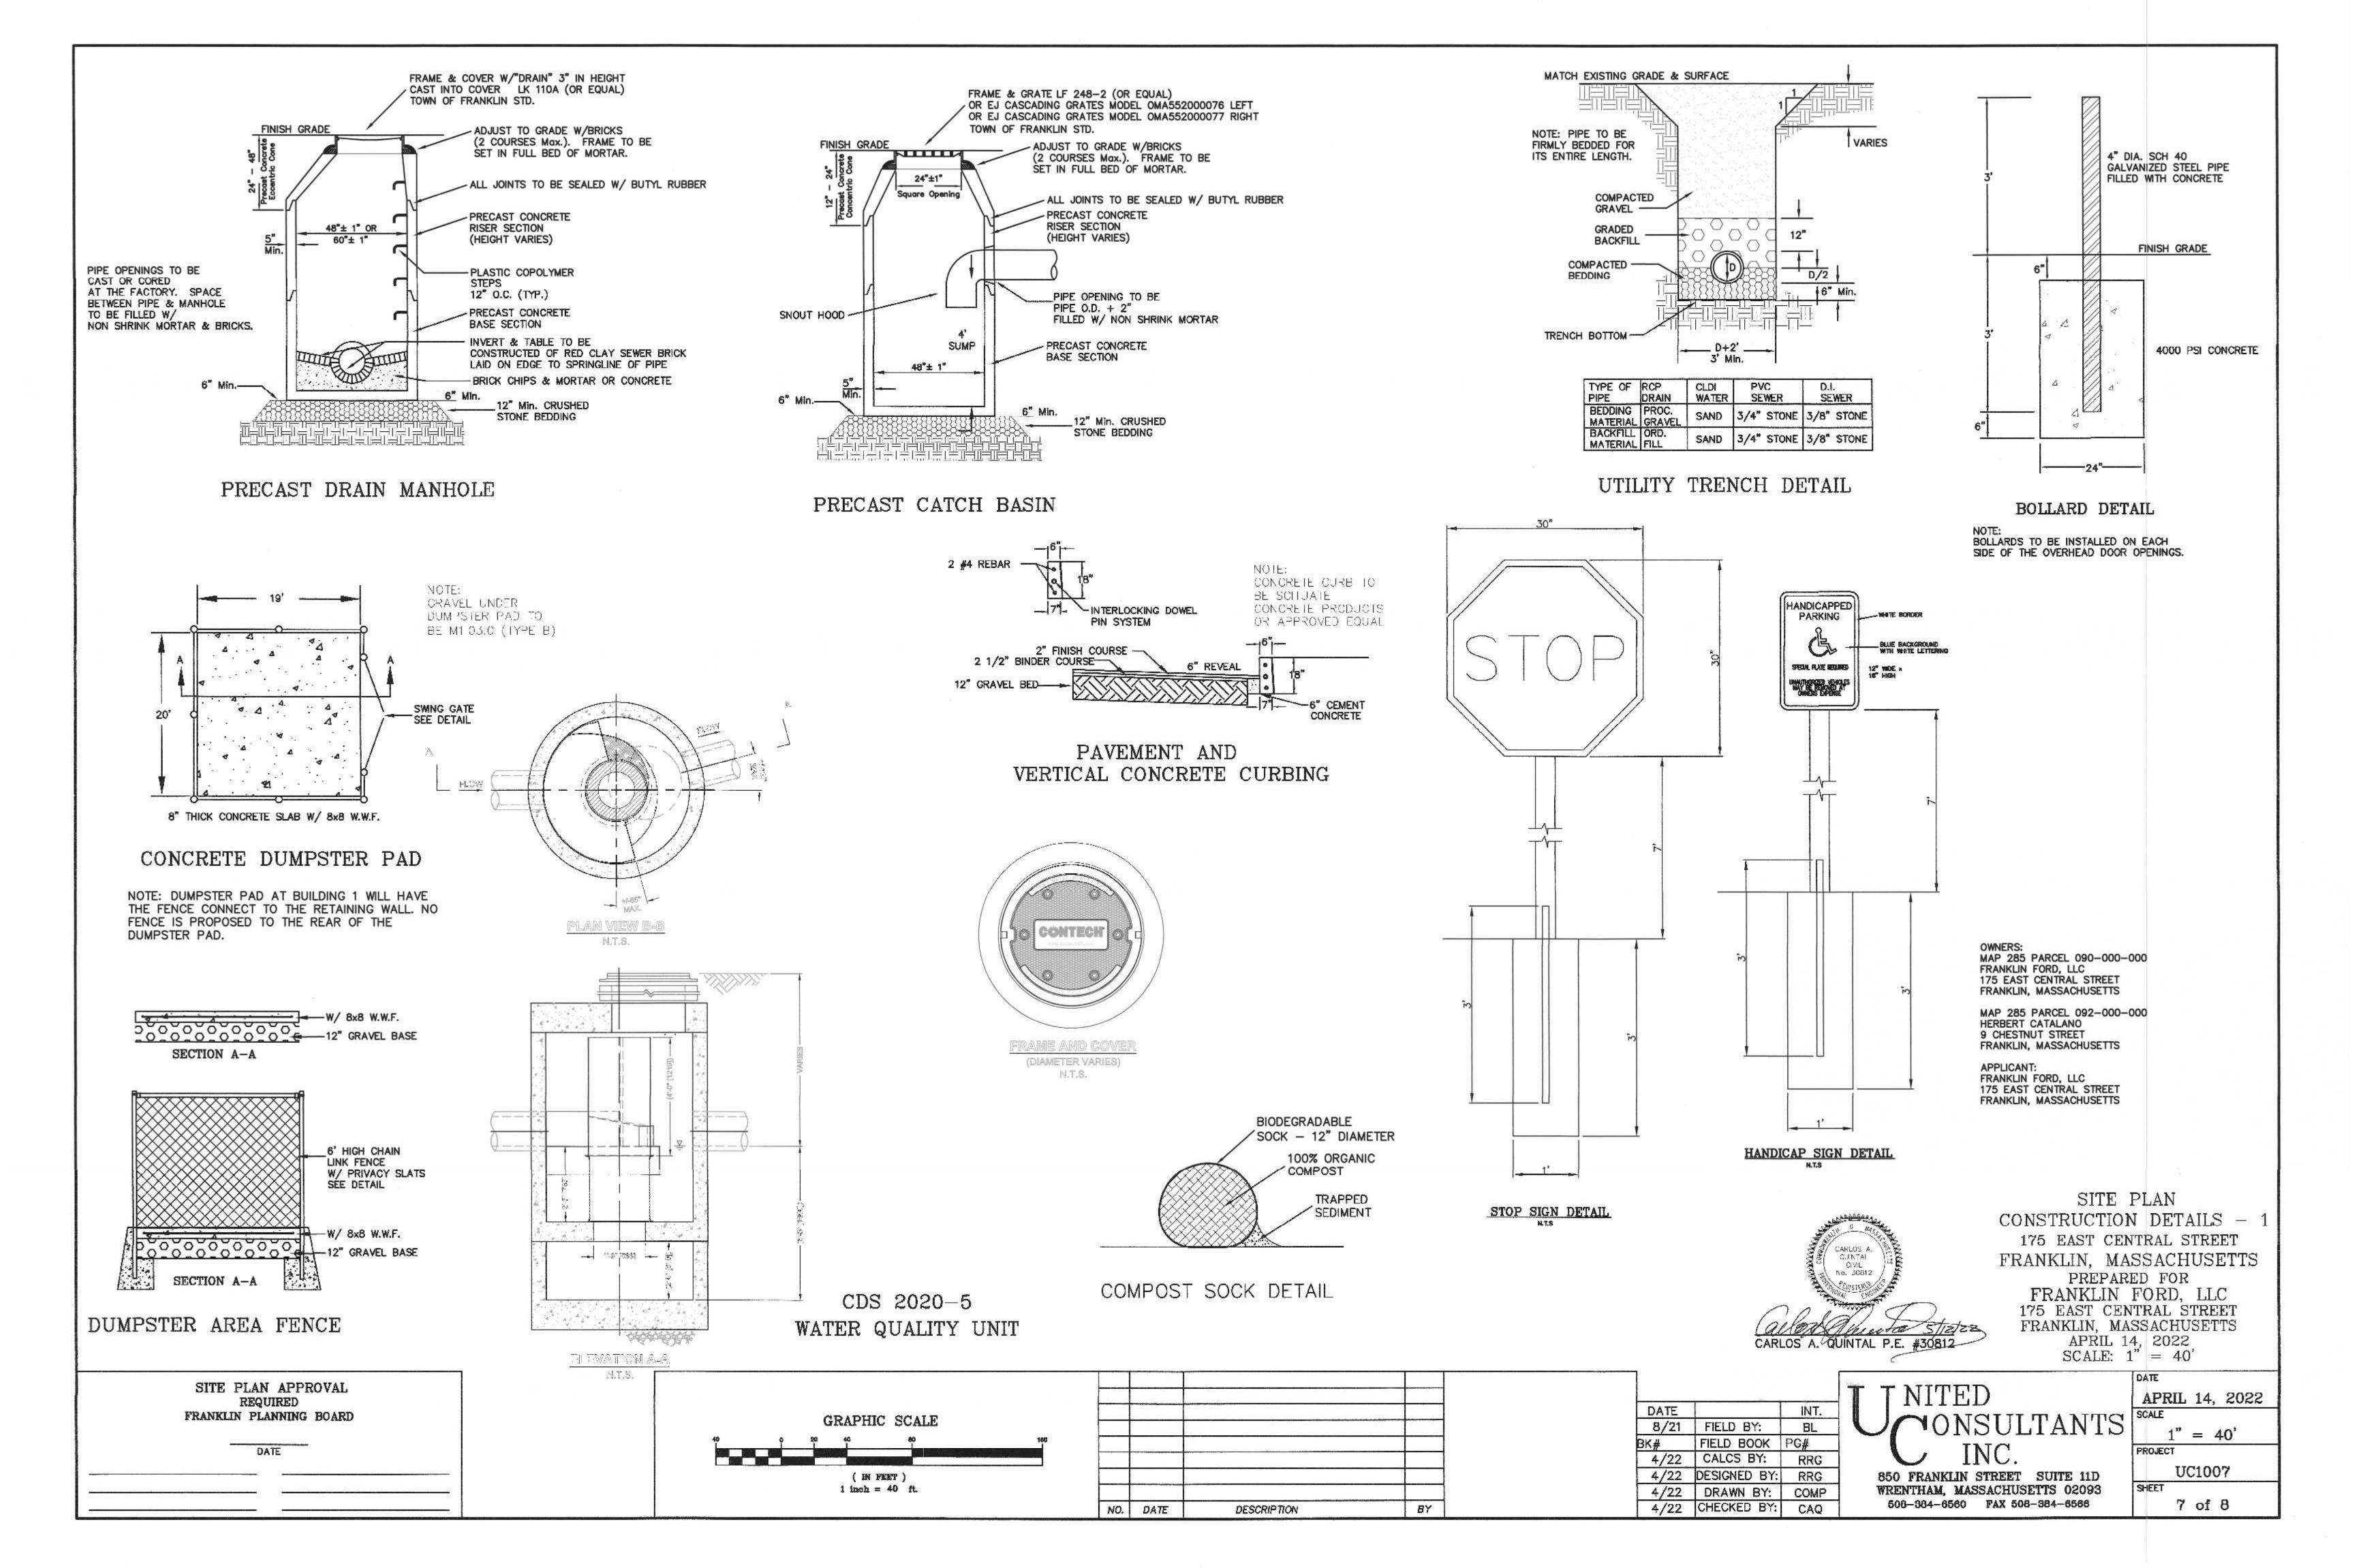

### **EXCAVATION AND FILL NOTES:**

SOIL REMOVAL AT INFITRATION SYSTEM: ALL EXISTING TOP (A HORIZON) AND SUB-SOIL (B HORIZON SOILS AND FILL SHALL BE REMOVED UNDER THE INFITRATION SYSTEMS AND FIVE FEET FROM THE OUTER EDGE OF THE STONE ENVELOPE.


Fill material for drainage systems constructed in fill shall consist of select on—site or imported soil material. The fill shall be comprised of clean granular sand, free from organic matter and deleterious substances. Mixtures and layers of different classes of soil shall not be used. The fill shall not contain any material larger than two inches. A sieve analysis, using a #4 sieve, shall be performed on a representative sample of the fill. Up to 45% by weight of the fill sample may be retained on the #4 sieve. Sieve analyses also shall be performed on the fraction of the fill sample passing the #4 sieve, such analyses must demonstrate that the material meets each of the following specifications:

SIEVE SIZE	EFFECTIVE PARTICLE SIZE	% THAT MUST PASS SIEVE
# 4	4.75 mm	100%
<b>#</b> 50	0.30 mm	10% - 100%
#100	0.15 mm	0% - 20%
#200	0.075 mm	0% - 2%


A minimum of two representative sample shall be taken from the in-place fill and tested for compliance with the grain size distribution specification. Where fill is required to replace unsuitable or impermeable soils, the excavation of the unsuitable material shall extend a minimum of five feet laterally in all directions beyond the outer perimeter of the soil drainage systems to the depth of naturally occurring pervious material and replaced with fill.

Prior to placement of the fill, the bottom surface of the excavation shall be scarified and relatively dry. Fill shall not be placed during rain or snow storms. If the water table elevation is above the elevation of the bottom of the excavation, the excavation shall be dewatered as necessary.


THE DESIGN ENGINEER SHALL INSPECT AND CERTIFY THE EXCAVATION OF THE SOIL INFILTRATION AREAS AND THE RAIN GARDEN AREA PRIOR TO ANY FILL BEING PLACED.

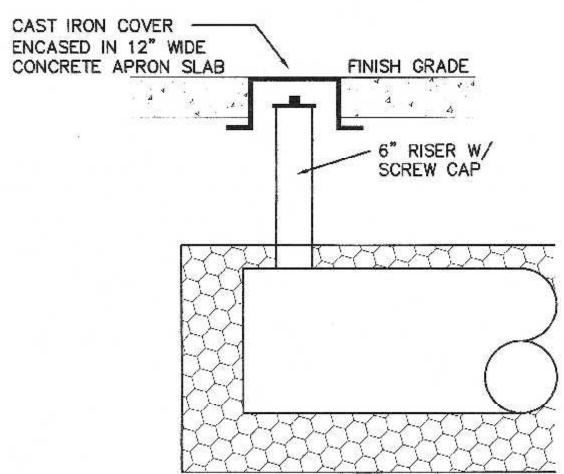


N.T.S.

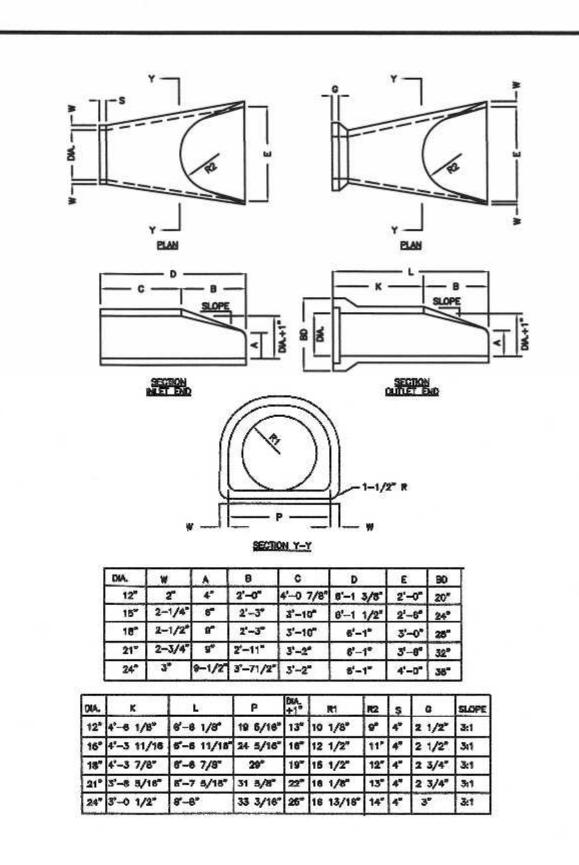

### REINFORCED CONCRETE PIPE FLARED END

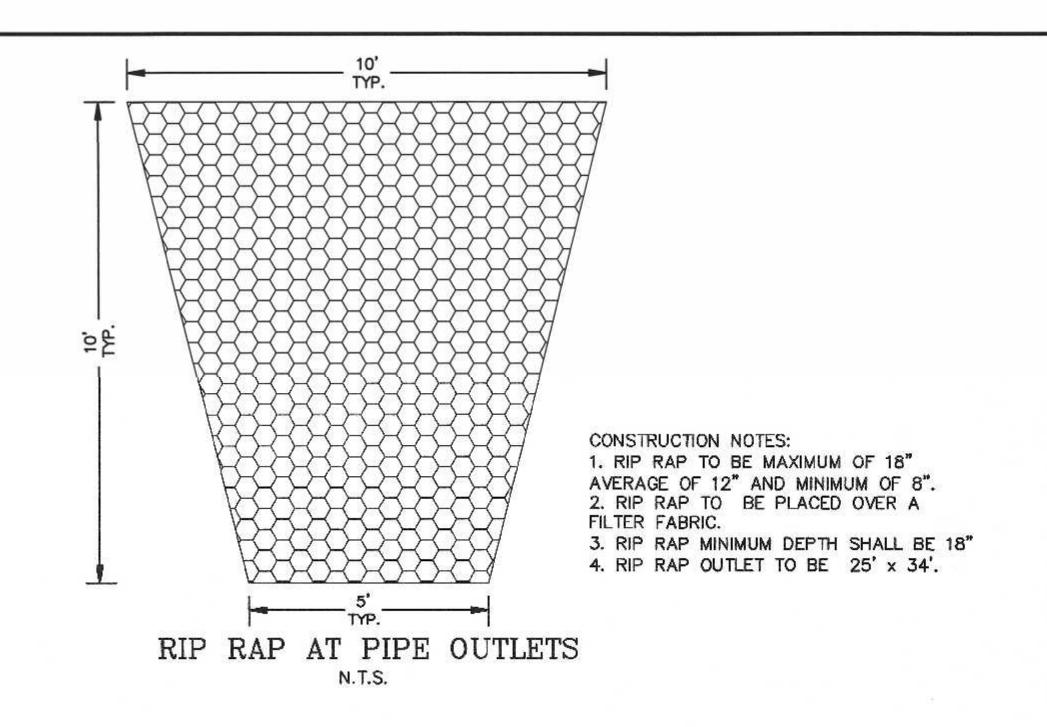

### INFILTRATION POND 1

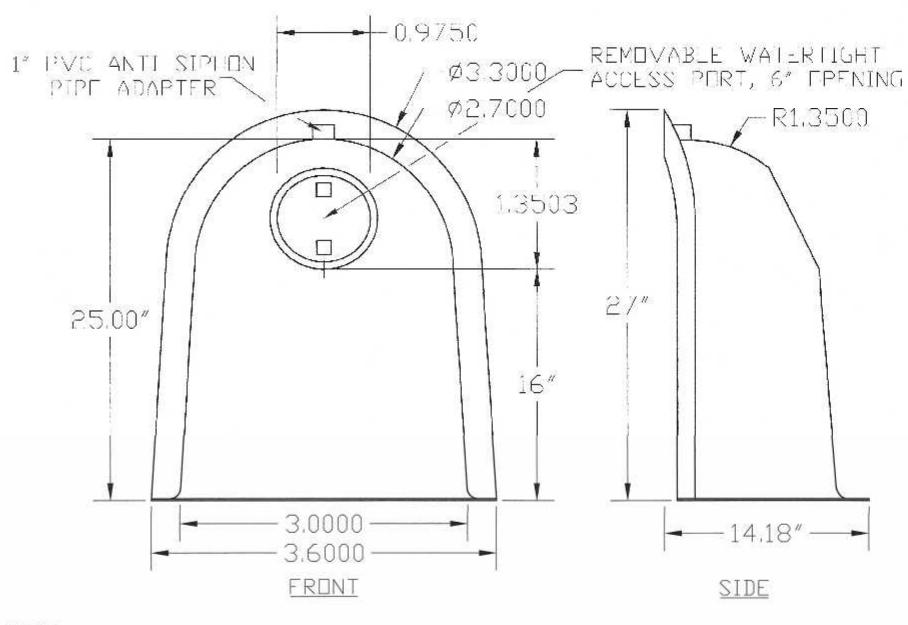

SNOUT DETAIL

53 MT. ARCHER ROAD, LYME, CT. 06371 (800) 504-8008 FAX: (860)434-3195 DESCRIPTION
18R SNOUT 09/06/99 NDNE DIL & DEBRIS DRAWING NUMBER STOP 18R

US PATENT # 6126817 ADDITIONAL PATENTS PENDING

R1.8000

OWNERS: MAP 285 PARCEL 090-000-000 FRANKLIN FORD, LLC 175 EAST CENTRAL STREET FRANKLIN, MASSACHUSETTS

Typical Siltsack® Construction - Type B

SILT SAK DETAIL NOT TO SCALE

DESIGNED TO FIT 48° SU" DIAM.

STRUCTURES

INSERT 1" REBAR FOR BAG REMOVAL FROM INLET

(REBAR NOT INCLUDED) -

OPTIONAL OVERFLO

DUMP LOOPS -

(REBAR NOT INCLUDED)

MAP 285 PARCEL 092-000-000 HERBERT CATALANO 9 CHESTNUT STREET FRANKLIN, MASSACHUSETTS

FRANKLIN FORD, LLC 175 EAST CENTRAL STREET FRANKLIN, MASSACHUSETTS

APPLICANT:

SITE PLAN CARLOS A. QUINTAL P.E. #30812 CONSTRUCTION DETAILS - 2

175 EAST CENTRAL STREET FRANKLIN, MASSACHUSETTS

PREPARED FOR FRANKLIN FORD, LLC 175 EAST CENTRAL STREET FRANKLIN, MASSACHUSETTS

APRIL 14, 2022 SCALE: 1'' = 40'

GRAPHIC SCALE ( IN FEET )

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NO.	DATE	DESCRIPTION	BY


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K#	FIELD BOOK	PG#
4/22	CALCS BY:	RRG
4/22	DESIGNED BY:	RRG
4/22	DRAWN BY:	COMF
4/22	CHECKED BY:	CAQ

## INITED ONSULTANTS SCALE

850 FRANKLIN STREET SUITE 11D WRENTHAM, MASSACHUSETTS 02093 508-384-6560 FAX 508-384-6566

APRIL 14, 2022 ' = 40'PROJECT UC1007 SHEET 8 of 8

### INSPECTION PORT DETAIL DRAINAGE INFILTRATION AREAS

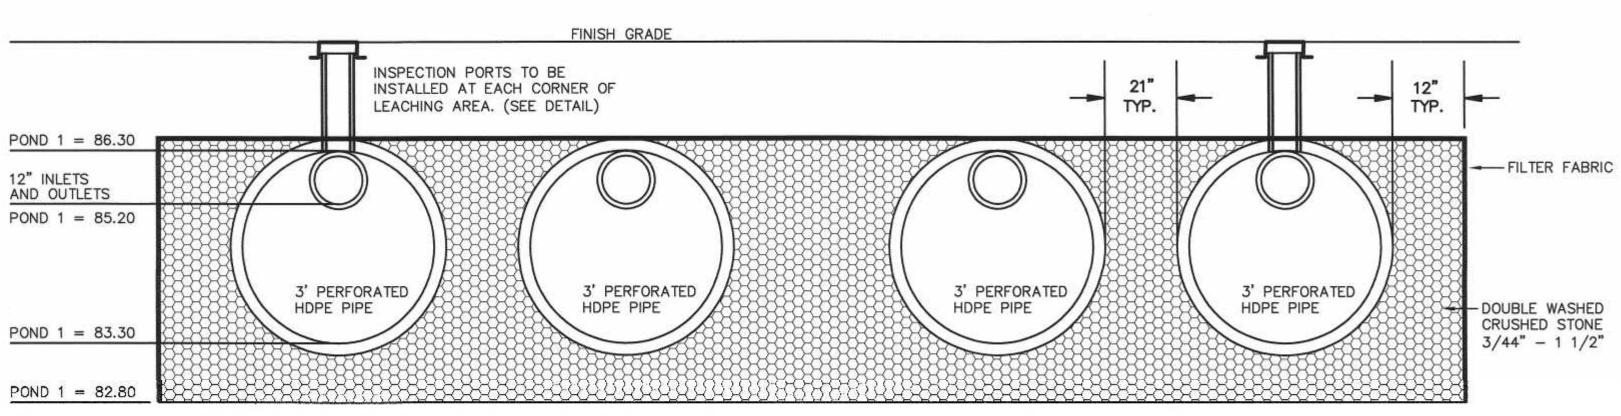

### INFILTRATION POND 1

1. INFILTRATION POND 1 CONSISTS OF 7 ROWS OF 3' DIAMETER PERFORATED HDPE PIPE 58' IN LENGTH. STONE ENVELOPE IS 37.22' x 60'

ESHGW - POND 1 = 78.68 BOTTOM TEST PIT 1

SITE PLAN APPROVAL REQUIRED FRANKLIN PLANNING BOARD DATE

1 inch = 40 ft.