GENERAL NOTES:

- 1. LOCATION OF EXISTING UNDERGROUND UTILITIES/OBSTRUCTIONS/SYSTEMS SHOWN HEREON ARE APPROXIMATE ONLY. ALL UTILITIES/OBSTRUCTIONS/SYSTEMS MAY NOT BE SHOWN. LOCATE AND PROTECT ALL UNDERGROUND UTILITIES/OBSTRUCTIONS/SYSTEMS, WHETHER OR NOT SHOWN HEREON.
- 2. INSTALL ALL NEW UTILITIES UNDERGROUND, UNLESS SPECIFICALLY INDICATED
- 3. BURIED UTILITIES SHALL BE INSTALLED IN ACCORDANCE WITH THEIR RESPECTIVE
- 4. CONSTRUCTION LAYOUT OF BUILDING AND/OR SITE IMPROVEMENTS SHALL BE PERFORMED BY A LICENSED LAND SURVEYOR. LOCATIONS OF EXISTING FEATURES OR PROPOSED IMPROVEMENTS DERIVED BY SCALING DRAWINGS MAY NOT BE ACCURATE. PROPERTY LINES SHOWN HEREON ARE APPROXIMATE. SEE PLAN
- 5. CONTRACTOR IS RESPONSIBLE FOR SAFETY MEASURES, CONSTRUCTION METHODS, AND CONTROL OF WORK.
- 6. CONTRACTOR SHALL BE RESPONSIBLE FOR REPAIRS AND/OR REPLACEMENT OF ANY EXISTING IMPROVEMENTS DAMAGED DURING CONSTRUCTIÓN THAT ARE NOT DESIGNATED FOR DEMOLITION AND/OR REMOVAL HEREON. DAMAGED UTILITIES OR STRUCTURES SHALL BE REPAIRED TO THE SATISFACTION OF THEIR RESPECTIVE
- 7. ANY INTENDED REVISION OF HORIZONTAL AND/OR VERTICAL LOCATION OF IMPROVEMENTS TO BE CONSTRUCTED AS SHOWN HEREON SHALL BE REVIEWED AND APPROVED BY THE ENGINEER PRIOR TO IMPLEMENTATION.
- 8. CONTRACTOR SHALL NOTIFY ENGINEER UPON COMMENCEMENT OF CONSTRUCTION IN ORDER TO ENSURE THAT REQUIRED INSPECTIONS ARE PERFORMED IN A TIMELY AND
- 9. CONTRACTOR SHALL PROMPTLY NOTIFY ENGINEER UPON DISCOVERY OF ANY UNFORESEEN SURFACE OR SUBSURFACE CONDITIONS THAT MAY IMPACT SITE
- 10.FINISH RIM ELEVATIONS SHOULD MATCH FINISH PAVEMENT, GRADING OR LANDSCAPING SURFACE, UNLESS SPECIFICALLY INDICATED OTHERWISE. CATCH BASIN RIMS TO BE SET AT BINDER ELEVATIONS.
- 11. WHERE EXISTING UTILITY LINES/STRUCTURES ARE TO BE CUT/BROKEN DOWN/ABANDONED, LINES/STRUCTURES SHALL BE PLUGGED/CAPPED/FILLED IN ACCORDANCE WITH UTILITY OWNER REQUIREMENTS.
- 12.EROSION CONTROL MEASURES SUCH AS SILT FENCE OR HAY BALES AS MAY BE SHOWN HEREON, SHALL BE INSTALLED BEFORE EARTH DISTURBANCE OCCURS WITHIN BUFFER ZONES, AND SHALL SERVE AS THE LIMIT OF WORK.
- 13.WHERE THE WORD "INSTALL" IS USED HEREIN, IT IS INTENDED TO DIRECT CONTRACTOR TO FURNISH, INSTALL AND PLACE IN OPERATION" THE COMPONENT
- 14.LIMIT OF WORK SHALL BE STAKED IN THE FIELD PRIOR TO COMMENCEMENT OF CONSTRUCTION.
- 15.WHERE SHOWN, CONSTRUCTION NOTES ARE INTENDED TO SUMMARIZE AND CLARIFY MAJOR ITEMS OF WORK. THESE NOTES SHOULD NOT BE CONSTRUED AS AN EXHAUSTIVE LISTING OF ALL WORK REQUIRED. CONTRACTOR SHOULD CONTACT ENGINEER WHEN FURTHER CLARIFICATION OF DEPICTED WORK IS DESIRED.
- 16.WHERE DIMENSIONS INVOLVE CURB, DIMENSIONS ARE TO FACE OF CURB. WHERE SLOPED GRANITE CURB OR CAPE COD BERM IS SPECIFIED, FACE OF CURB IS EDGE OF FINISH PAVEMENT AT TOE OF CURB.
- 17.NO DEBRIS, JUNK RUBBISH OR OTHER NON-BIODEGRADABLE MATERIALS, FILL CONTAINING HAZARDOUS MATERIALS OR WASTES, OR STUMPS SHALL BE BURIED ON ANY LAND ON THIS SITE, OR LEFT ON ANY LOT OR ON THE STREET RIGHT OF WAY.
- 18.ALL WATER IMPROVEMENTS MUST BE DONE IN ACCORDANCE WITH THE TOWN OF FRANKLIN DEPARTMENT OF PUBLIC WORKS STANDARDS FOR SEWER AND WATER MATERIALS AND INSTALLATION (TOWN STANDARDS). WHERE UTILITY DETAILS CONFLICT WITH TOWN STANDARDS, TOWN STANDARDS GOVERN.2
- 19.GRADE STAKES TO BE SET, PRIOR TO CONSTRUCTION, BY A MASSACHUSETTS REGISTERED PROFESSIONAL LAND SURVEYOR AT A MINIMUM OF ONE-HUNDRED-FOOT STATIONS FOR ROADWAY RIGHT-OF-WAY, CENTERLINE, SIDELINES. AND SIDEWALKS.
- 20.EXCESS FILL MATERIALS TO BE STOCKPILED FOR FUTURE PROJECT PHASES.
- 21. PROPOSED HOMES MAY REQUIRE INDIVIDUAL BOOSTER PUMPS. HOME BUILDER TO DETERMINE IF BOOSTER PUMPS ARE NECESSARY AT TIME OF BUILDING PERMIT.
- 22.CONTRACTOR SHALL EITHER INSTALL CURBING PRIOR TO THE PLACEMENT OF THE ASPHALT BINDER COURSE OR ALTERNATIVELY MAY INSTALL A TEMPORARY BERM ALONG THE EDGE OF PAVEMENT DURING PLACEMENT OF THE ASPHALT BINDER

- REGULATORY NOTES:


 1. CONTRACTOR SHALL CONTACT DIG-SAFE FOR UNDERGROUND UTILITY MARKING AT 888-344-7233 AT LEAST 72 HOURS PRIOR TO COMMENCEMENT OF ANY WORK. CONTRACTOR SHALL GIVE 24-HOUR NOTICE TO PERTINENT TOWN DEPARTMENTS BEFORE COMMENCING ANY WORK IN THE FIELD.
- 2. CONTRACTOR SHALL COORDINATE AND OBTAIN ALL CONSTRUCTION PERMITS REQUIRED BY REGULATORY AUTHORITIES.
- 3. CONTRACTOR SHALL BE AWARE OF ALL CONSTRUCTION REQUIREMENTS, CONDITIONS, AND LIMITATION IMPOSED BY PERMITS AND APPROVALS ISSUED BY REGULATORY AUTHORITIES PRIOR TO COMMENCEMENT OF ANY WORK.
- 4. COMPLETE ALL PIPING WORK THAT IS OUTSIDE OF BUILDING AND LESS THAN 10 FEET FROM THE INSIDE FACE OF BUILDING FOUNDATION IN CONFORMANCE WITH THE UNIFORM STATE PLUMBING CODE OF MASSACHUSETTS, 248 CMR 2.00.

WAIVER REQUEST


- 300-13.A.1 SIDEWALK REQUIRED ON BOTH SIDES OF THE ROAD. 300-10.D.5 - CUTS GREATER THAN FIVE FEET
- 300-11.A.7.A DISTANCE FROM MAXIMUM POND WATER SURFACE TO P AND STRUCTURE SHALL BE 20'
- 300-11.A.7.B DISTANCE FROM TOE OF POND BERM TO P SHALL BE MIN. 10' 300-11.B.2.A - THE DRAINAGE PIPE SHALL BE REINFORCED CONCRETE
- 300-10.E.4 DEAD-END STREETS SHALL BE NO LONGER THAN 600 FEET.

DEFINITIVE SUBDIVISION OLAM ESTATES

FRANKLIN, MASSACHUSETTS

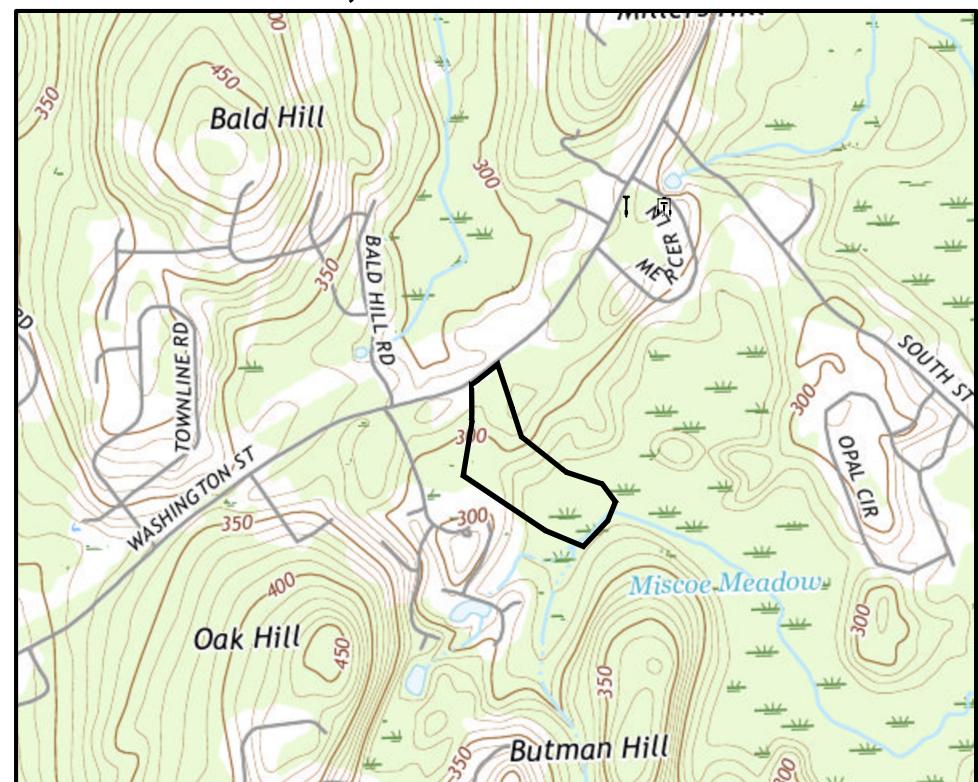

LOCUS MAP

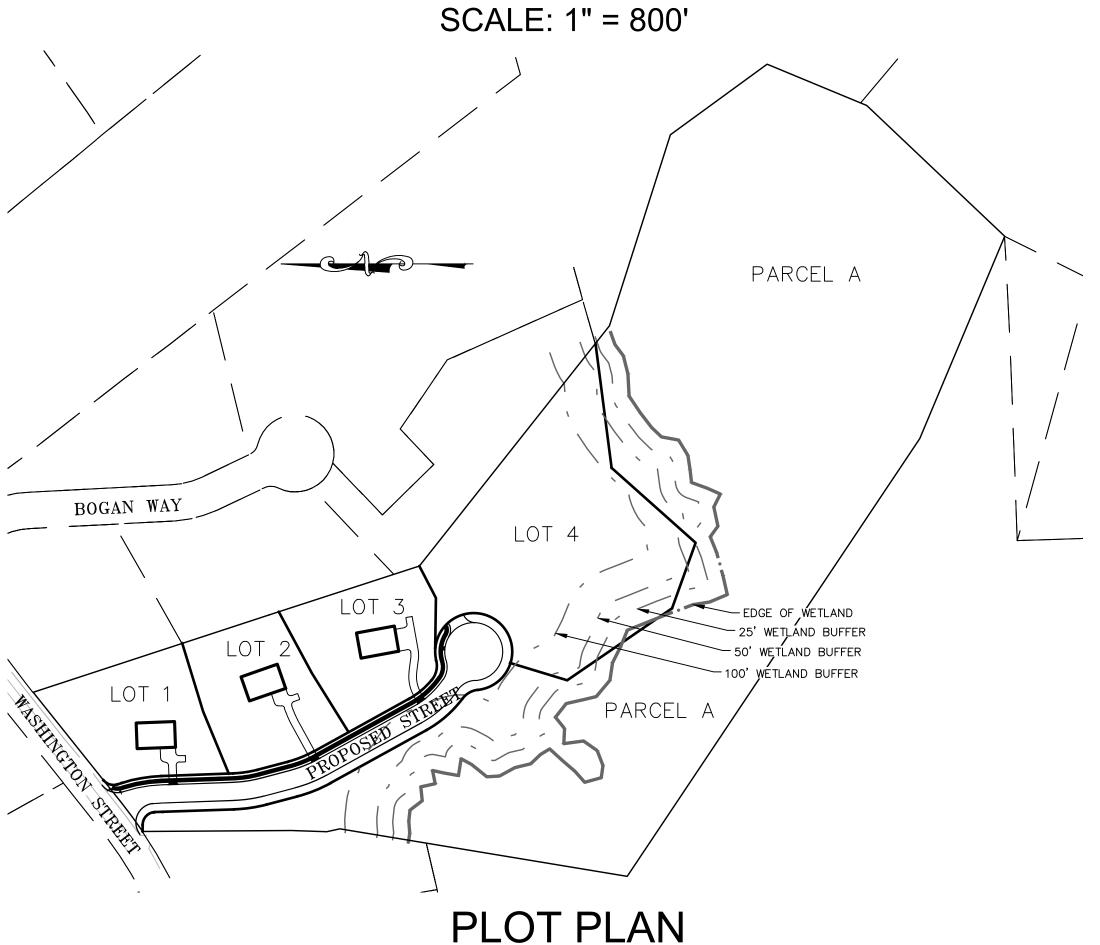

SCALE: 1" = 150'

NO.	TITLE
C1	COVER SHEET
C2	LEGEND
C3.1-C3.2	DEFINITIVE PLAN
C4.1-C4.2	EXISTING CONDITIONS PLAN
C5	LAYOUT AND MATERIALS PLAN
C6	GRADING, DRAINAGE & UTILITIES PLAN
C7	LANDSCAPING PLAN
C8	PLAN AND PROFILE
C9.1-C9.3	CONSTRUCTION DETAILS
C10.1-C10.2	EROSION AND SEDIMENT CONTROL PLAN

OWNER OF RECORD:

TEMPLE ETZ CHAIM 900 WASHINGTON STREET FRANKLIN, MA 02038

FRANKLIN ASSESSORS INFORMATION:

MAP 340, PARCEL 6 PARCEL AREA: 18.49± AC

DEED REFERENCES: 1. LAND COURT DOC #834093-1

PLAN REFERENCES: 1. LAND COURT PLAN 34857B

2. "SITE PLAN-TEMPLE ETZ CHAIM", PREPARED BY ANDREWS SURVEY & ENGINEERING, PREPARED FOR TEMPLE ETZ CHAIM, DATED OCTOBER 30, 2020

SUBDIVISION DIMENSIONAL REQUIREMENTS:

PER "TOWN OF FRANKLIN ZONING BYLAWS," ARTICLE IV, SECTION 300-10

ROAD CLASSIFICATION: MINOR STREET

	REQUIRED	PROVIDE
STREET INTERSECTION:	>70°00"	70°11"
CURB RADII @ STREET:	>30 FT	30 FT
₽ RADII:	MIN 150 FT	150 FT
Ų OFFSET FROM		
INTERSECTION ST:	200 FT	464 FT
DEAD END LENGTH:	600 FT	693 FT
RIGHT OF WAY WIDTH:	56 FT	56 FT
PAVEMENT WIDTH:	26 FT	28 FT
MINIMUM ROAD GRADE:	1.5%	1.5%
MAXIMUM ROAD GRADE:	8.0%	5.4%
CUL-DE-SAC ROW RADIUS:	60 FT	60 FT
CUL-DE-SAC		
PAVEMENT RADIUS:	45 FT	45 FT

DIMENSION REQUIREMENTS

PER "TOWN OF FRANKLIN ZONING BYLAWS," AMENDED APRIL 30, 1993 PER SECTION 185 ATTACHMENT 9

ZONE: RURAL RESIDENTIAL 1 (RR1)

MINIMUM AREA: MINIMUM FRONTAGE: DEPTH: WIDTH (CIRCLE Ø) FRONT SETBACK: SIDE SETBACK:	REQUIRED 40,000 SF 200 FT 200 FT 180 FT 40 FT 40 FT	LOT 1 PROVIDED 40,079 SF 200.0 FT 203 FT 180 FT 40 FT 40 FT	LOT 2 <u>PROVIDED</u> 40,088 SF 200.0 FT 227 FT 180 FT 40 FT 40 FT	LOT 3 PROVIDED 40,010 SF 206.5 FT 204 FT 226.5 FT 40 FT 40 FT	LOT 4 PROVIDED 112,396 SF 200.0 FT 217 FT 352 FT 40 FT 40 FT
REAR SETBACK:	40 FT	40 FT	40 FT	40 FT	40 FT



Andrews Survey & Engineering, Inc. Land Surveying - Civil Engineering - Site Planning

> P.O. Box 312, 104 Mendon Street Uxbridge, Massachusetts 01569 P: 508-278-3897 F: 508-278-2289

APPROVAL UNDER SUBDIVISION CONTROL LAW REQUIRED. FRANKLIN PLANNING BOARD

BEING A MAJORITY

THIS CERTIFIES THAT THE NOTICE OF APPROVAL OF THIS PLAN BY THE FRANKLIN PLANNING BOARD HAS BEEN RECEIVED AND RECORDED ON

AND NO APPEAL WAS RECEIVED DURING THE 20 DAYS NEXT AFTER SUCH RECEIPT OF SAID

FRANKLIN TOWN CLERK

JASON P. CLOUGH CIVIL No.48522

DRAWING ISSUED FOR: ■ PERMIT THIS PLAN IS INTENDED TO

SHOW CONSTRUCTABILITY AND MAY NOT SHOW ALL CONSTRUCTION DETAILS AND SPECIFICATIONS FOR THE PROPOSED IMPROVEMENTS. AND MAY NOT IDENTIFY ALL CONSTRUCTION ITEMS/AREAS OF CONTRACTOR JURISDICTION.

REVISIONS DESCRIPTION 1 9/3/21 CONSERVATION COMMISSION SUBMISSION 2 | 9/17/21 | PLANNING BOARD RESUBMISSION 11/12/21 PLANNING BOARD RESUBMISSION 12/2/21 PLANNING BOARD REVISION

COVER SHEET

SHEET TITLE

PROJECT:


OLAM ESTATES DEFINITIVE SUBDIVISION 900 WASHINGTON STREET FRANKLIN, MA 02038

OWNER/APPLICANT:

TEMPLE ETZ CHAIM 900 WASHINGTON STREET FRANKLIN, MA 02038

DES BY: SPB DATE: NOVEMBER 12, 2021

HK BY: JEG PROJECT NO. 3003-001

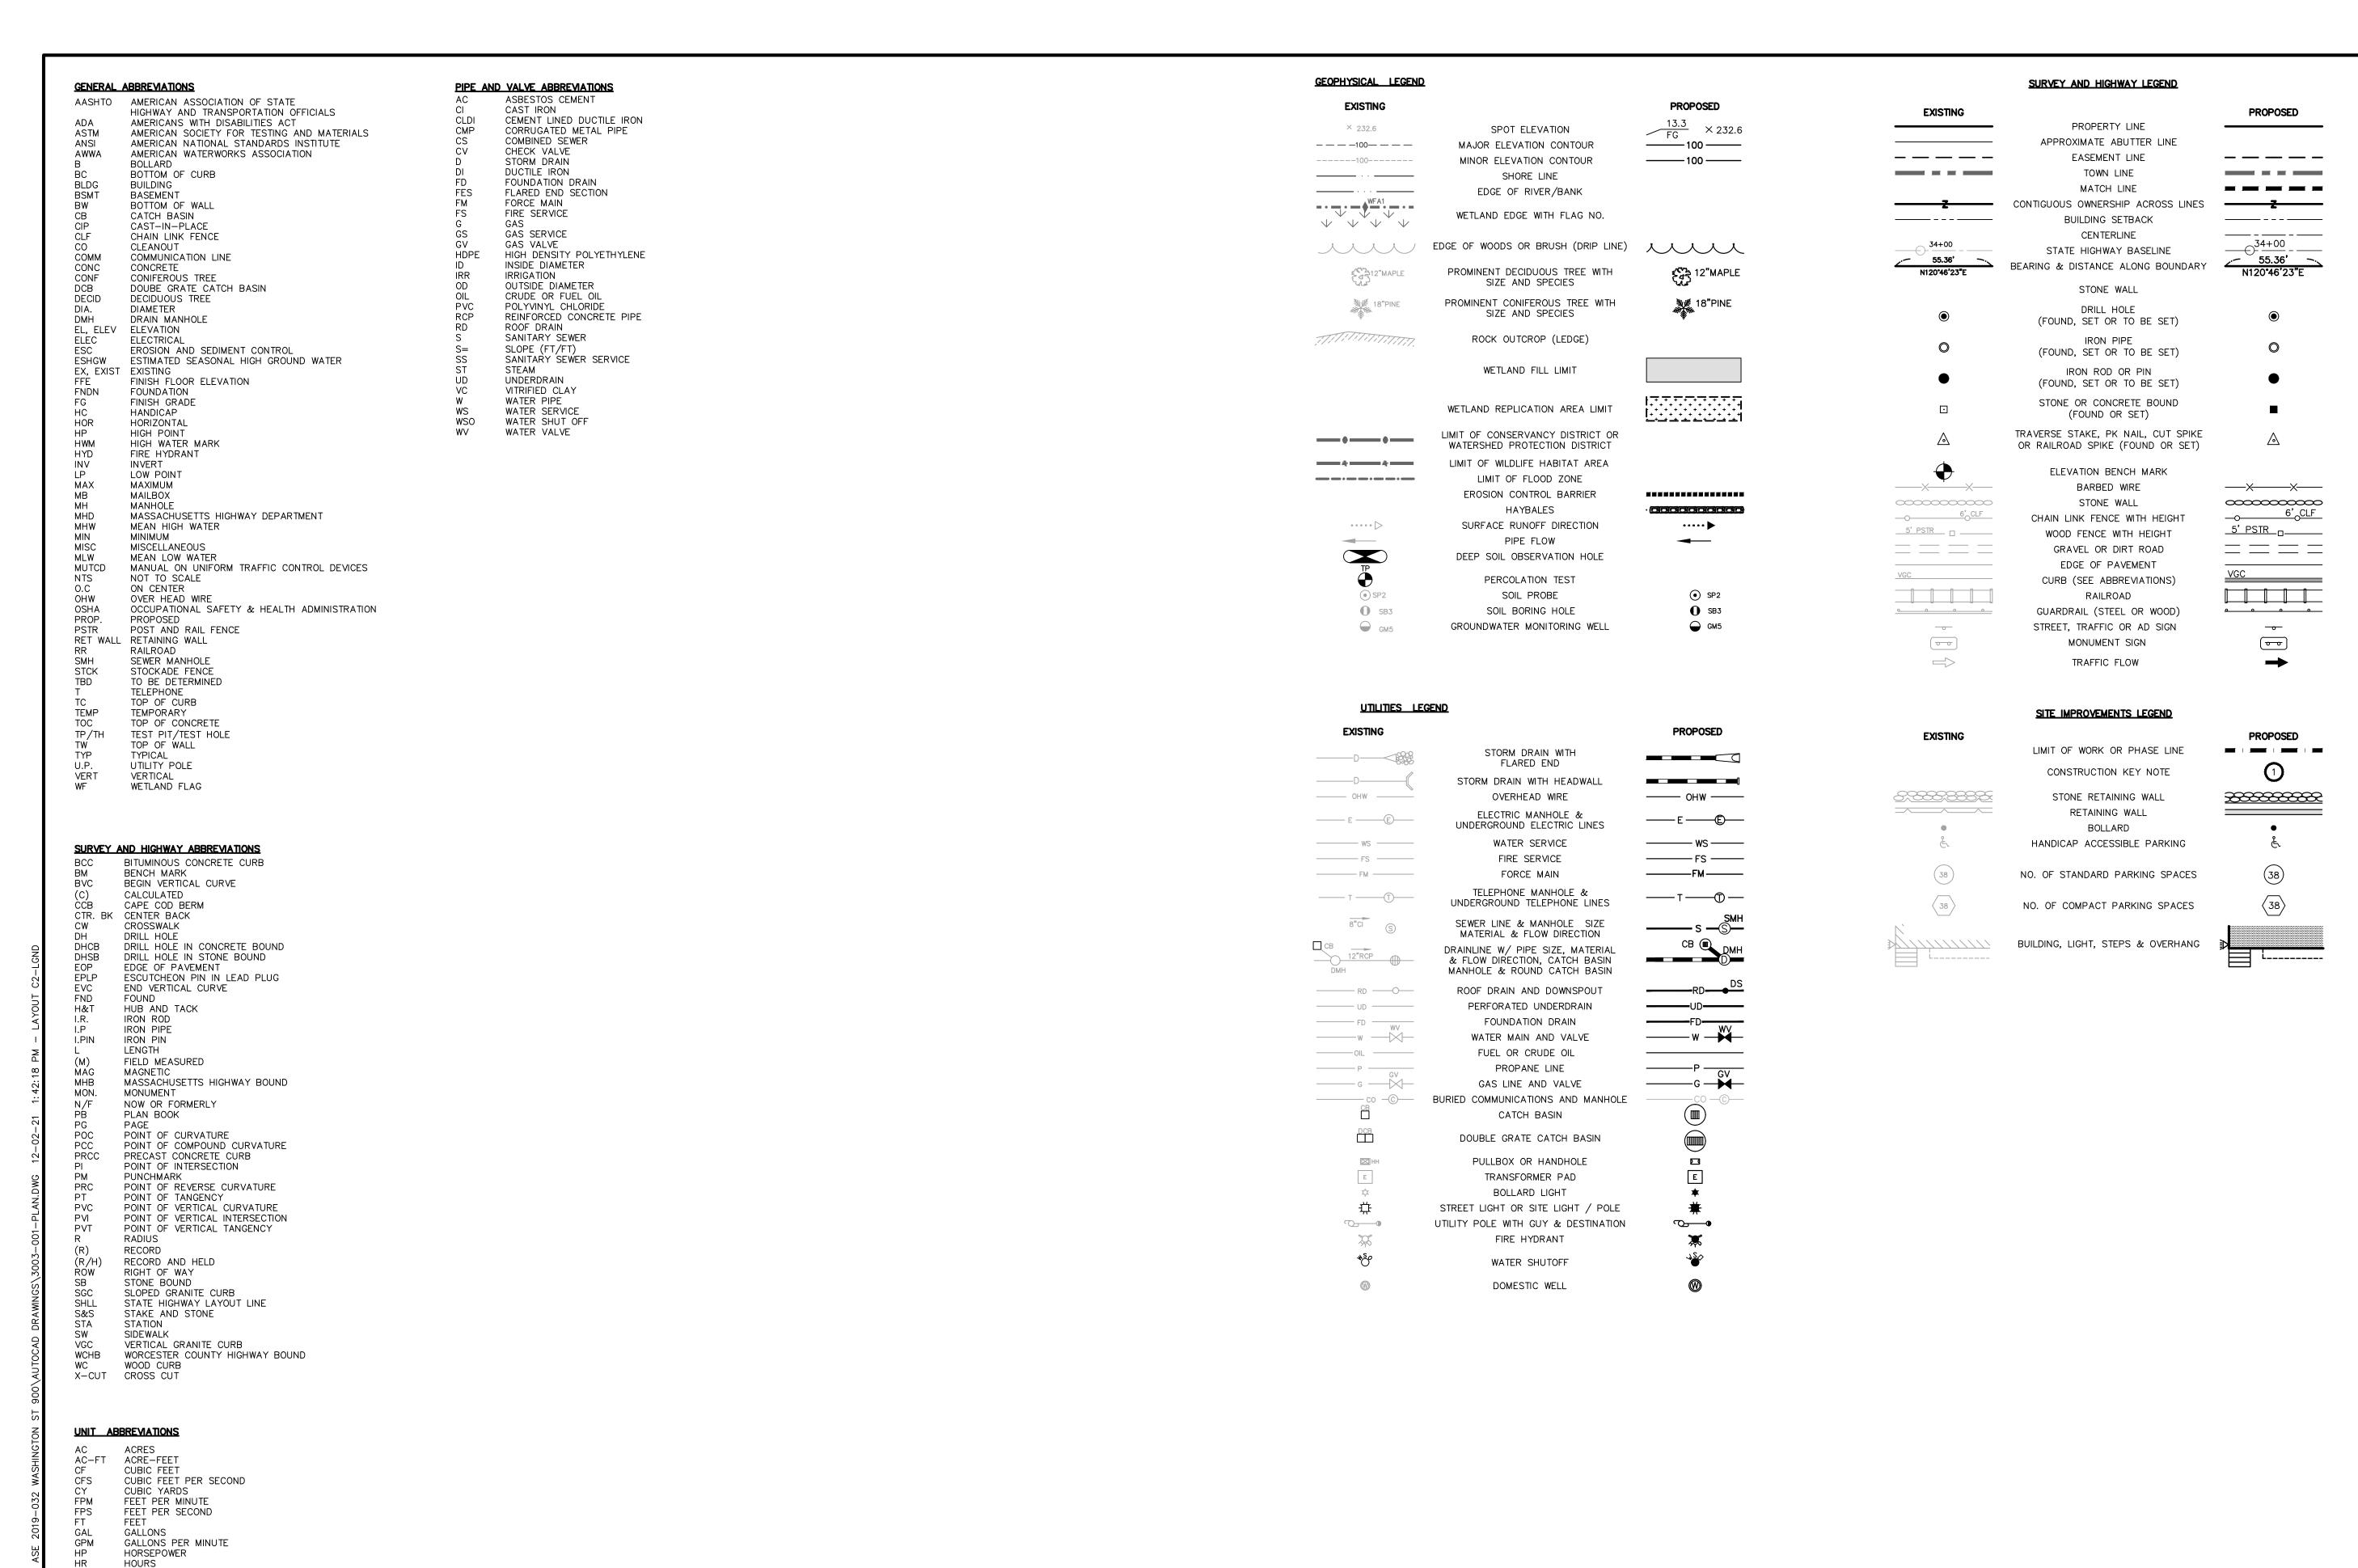

INCHES

POUNDS LINEAR FEET MILLION GALLONS

KWH

MGL

HILOWATT HOUR

MILES PER HOUR

SQUARE FEET

TONS VOLTS

WATTS

MILLION GALLONS PER DAY

POUNDS PER SQUARE INCH

MILLIGRAMS PER LITER

ASE

Andrews Survey & Engineering, Inc. Land Surveying - Civil Engineering - Site Planning

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APPROVAL UNDER SUBDIVISION CONTROL LAW REQUIRED. <u>FRANKLIN PLANNING BOARD</u>

BEING A MAJORITY

THIS CERTIFIES THAT THE NOTICE OF APPROVAL
OF THIS PLAN BY THE FRANKLIN PLANNING
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______ AT

AND NO APPEAL WAS RECEIVED DURING THE 20
DAYS NEXT AFTER SUCH RECEIPT OF SAID

FRANKLIN TOWN CLERK

NOTICE.

WN CLERK DATE

DATE:



THIS PLAN IS INTENDED TO SHOW CONSTRUCTABILITY AND MAY NOT SHOW ALL CONSTRUCTION DETAILS AND SPECIFICATIONS FOR THE PROPOSED IMPROVEMENTS, AND MAY NOT IDENTIFY ALL

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OF CONTRACTOR JURISDICTION.

DRAWING ISSUED FOR:

REVISIONS

NO. DATE DESCRIPTION

1 9/3/21 CONSERVATION COMMISSION SUBMISSION

2 9/17/21 PLANNING BOARD RESUBMISSION

3 11/12/21 PLANNING BOARD RESUBMISSION

4 12/2/21 PLANNING BOARD REVISION

LEGEND

SHEET TITLE

PROJECT:

OLAM ESTATES
DEFINITIVE SUBDIVISION
900 WASHINGTON STREET
FRANKLIN, MA 02038


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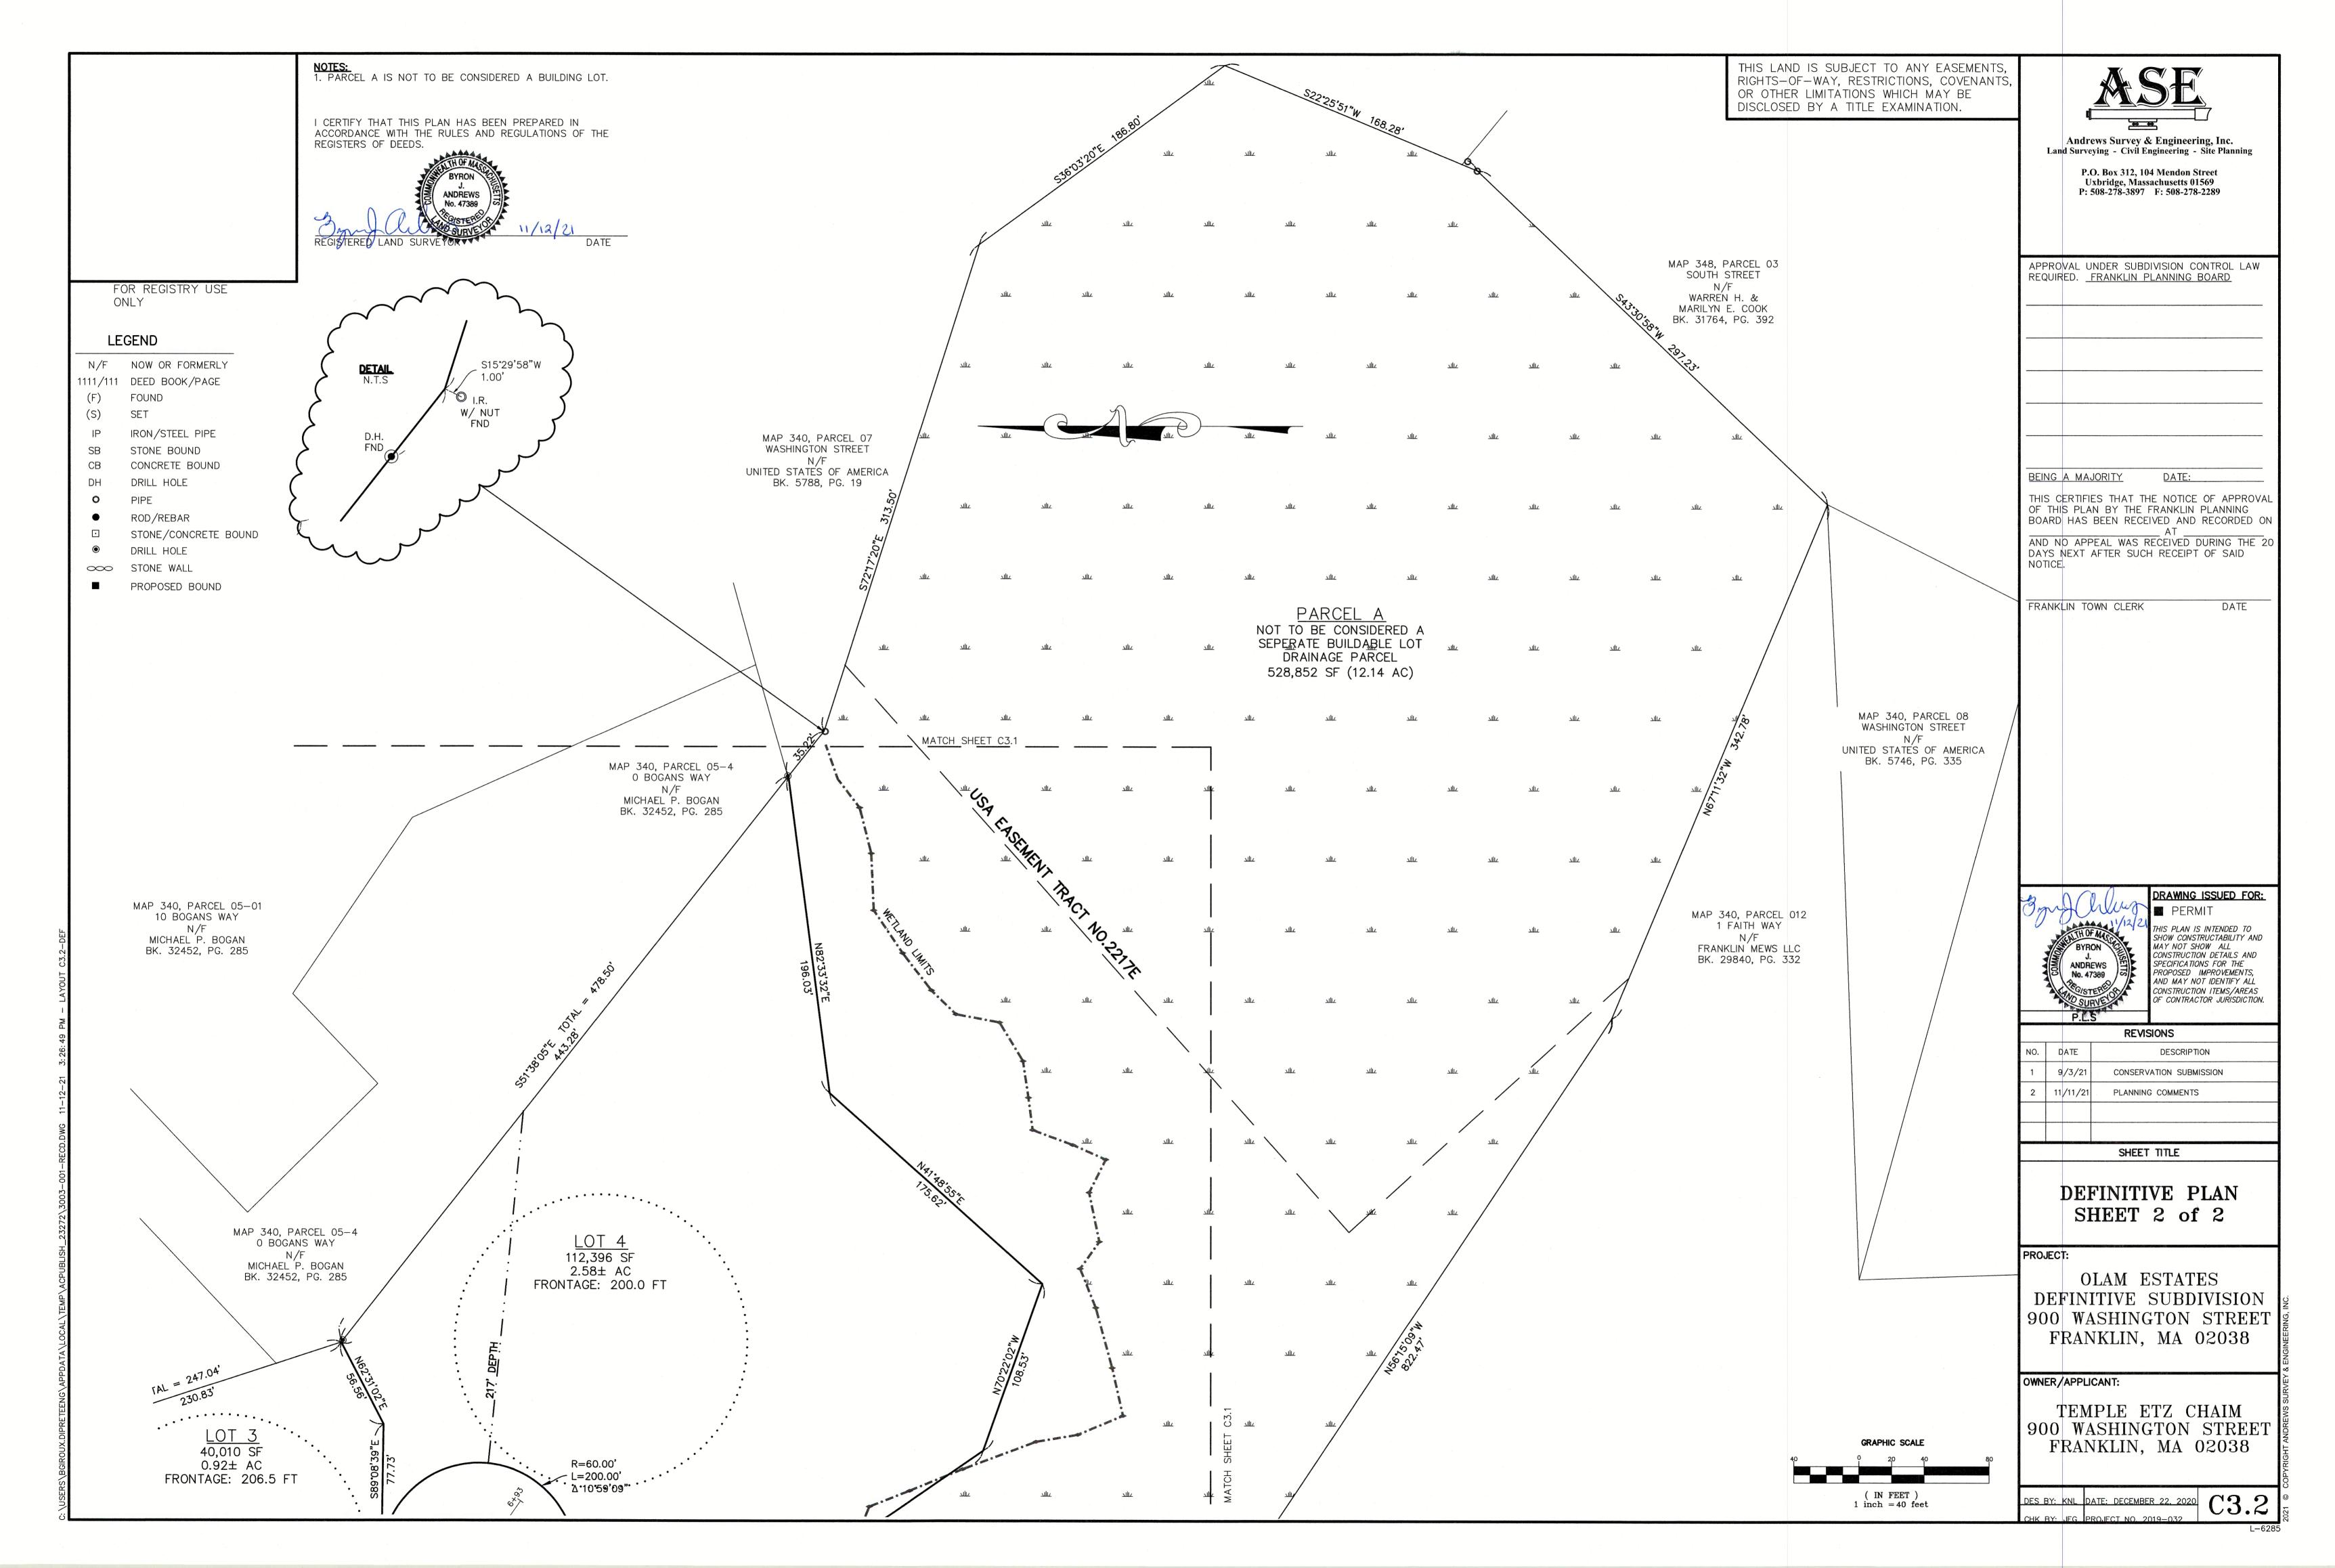
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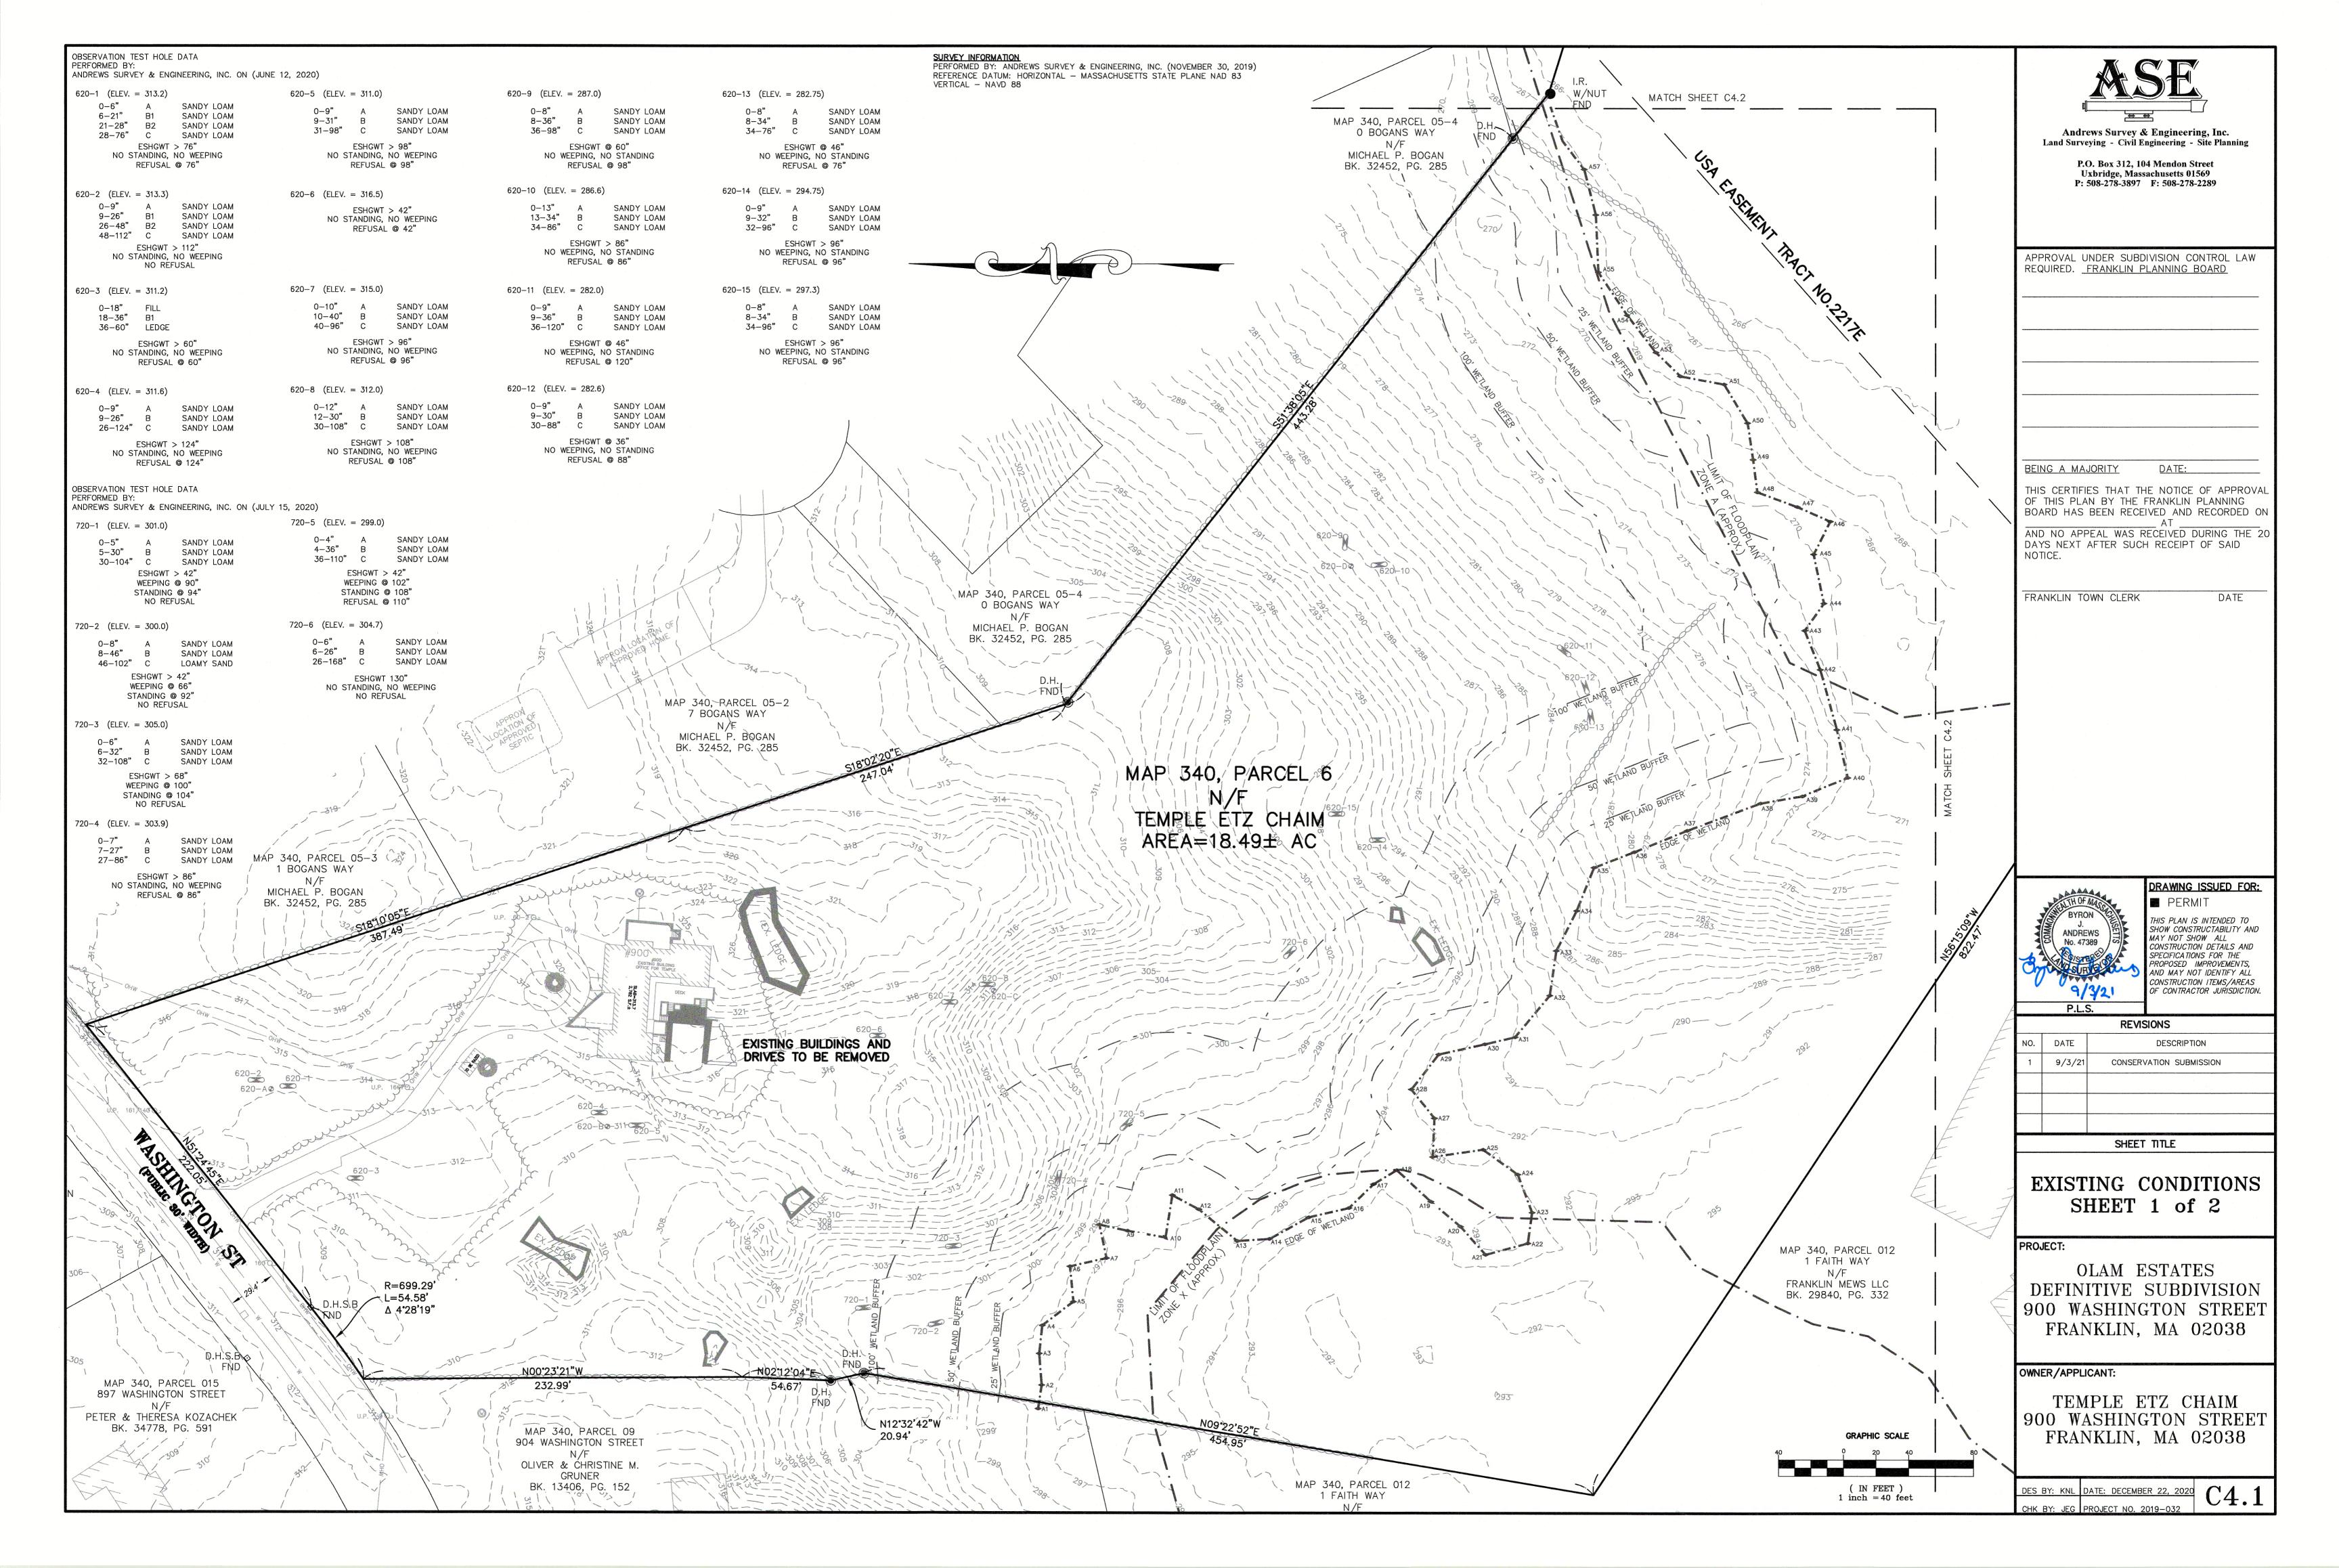
DES BY: SPB DATE: NOVEMBER 12, 2021
CHK BY: JEG PROJECT NO. 3003-001


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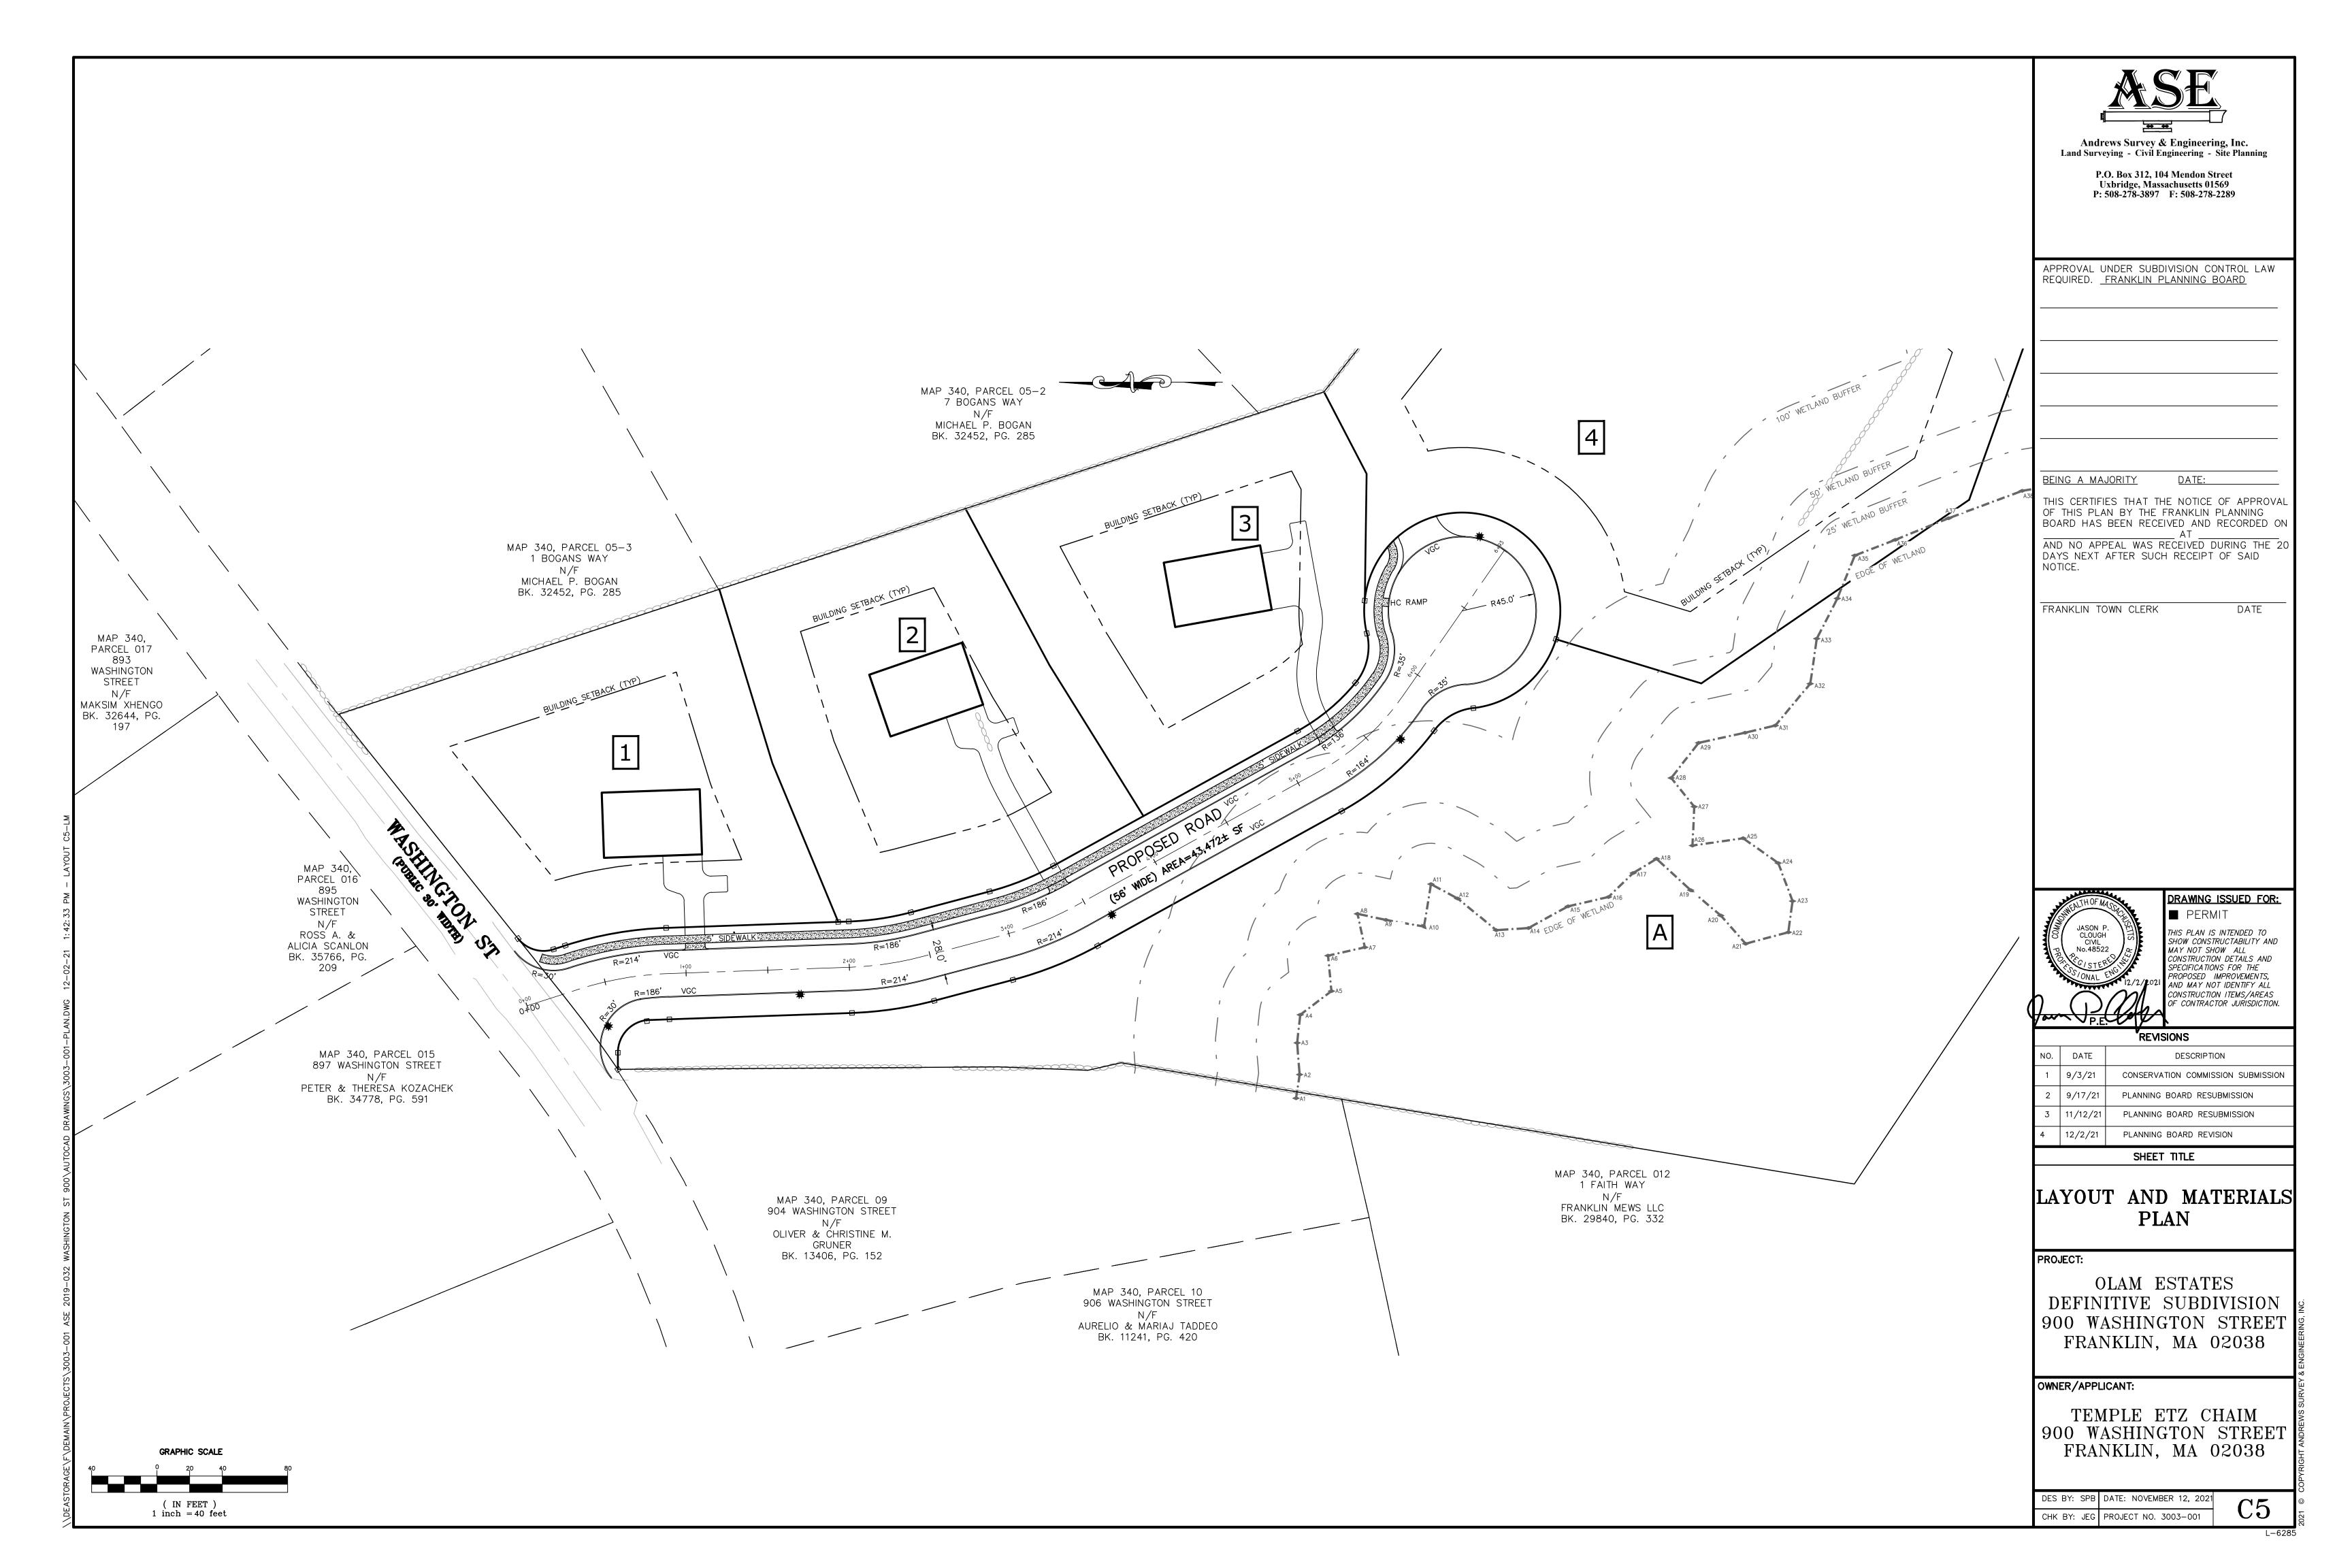
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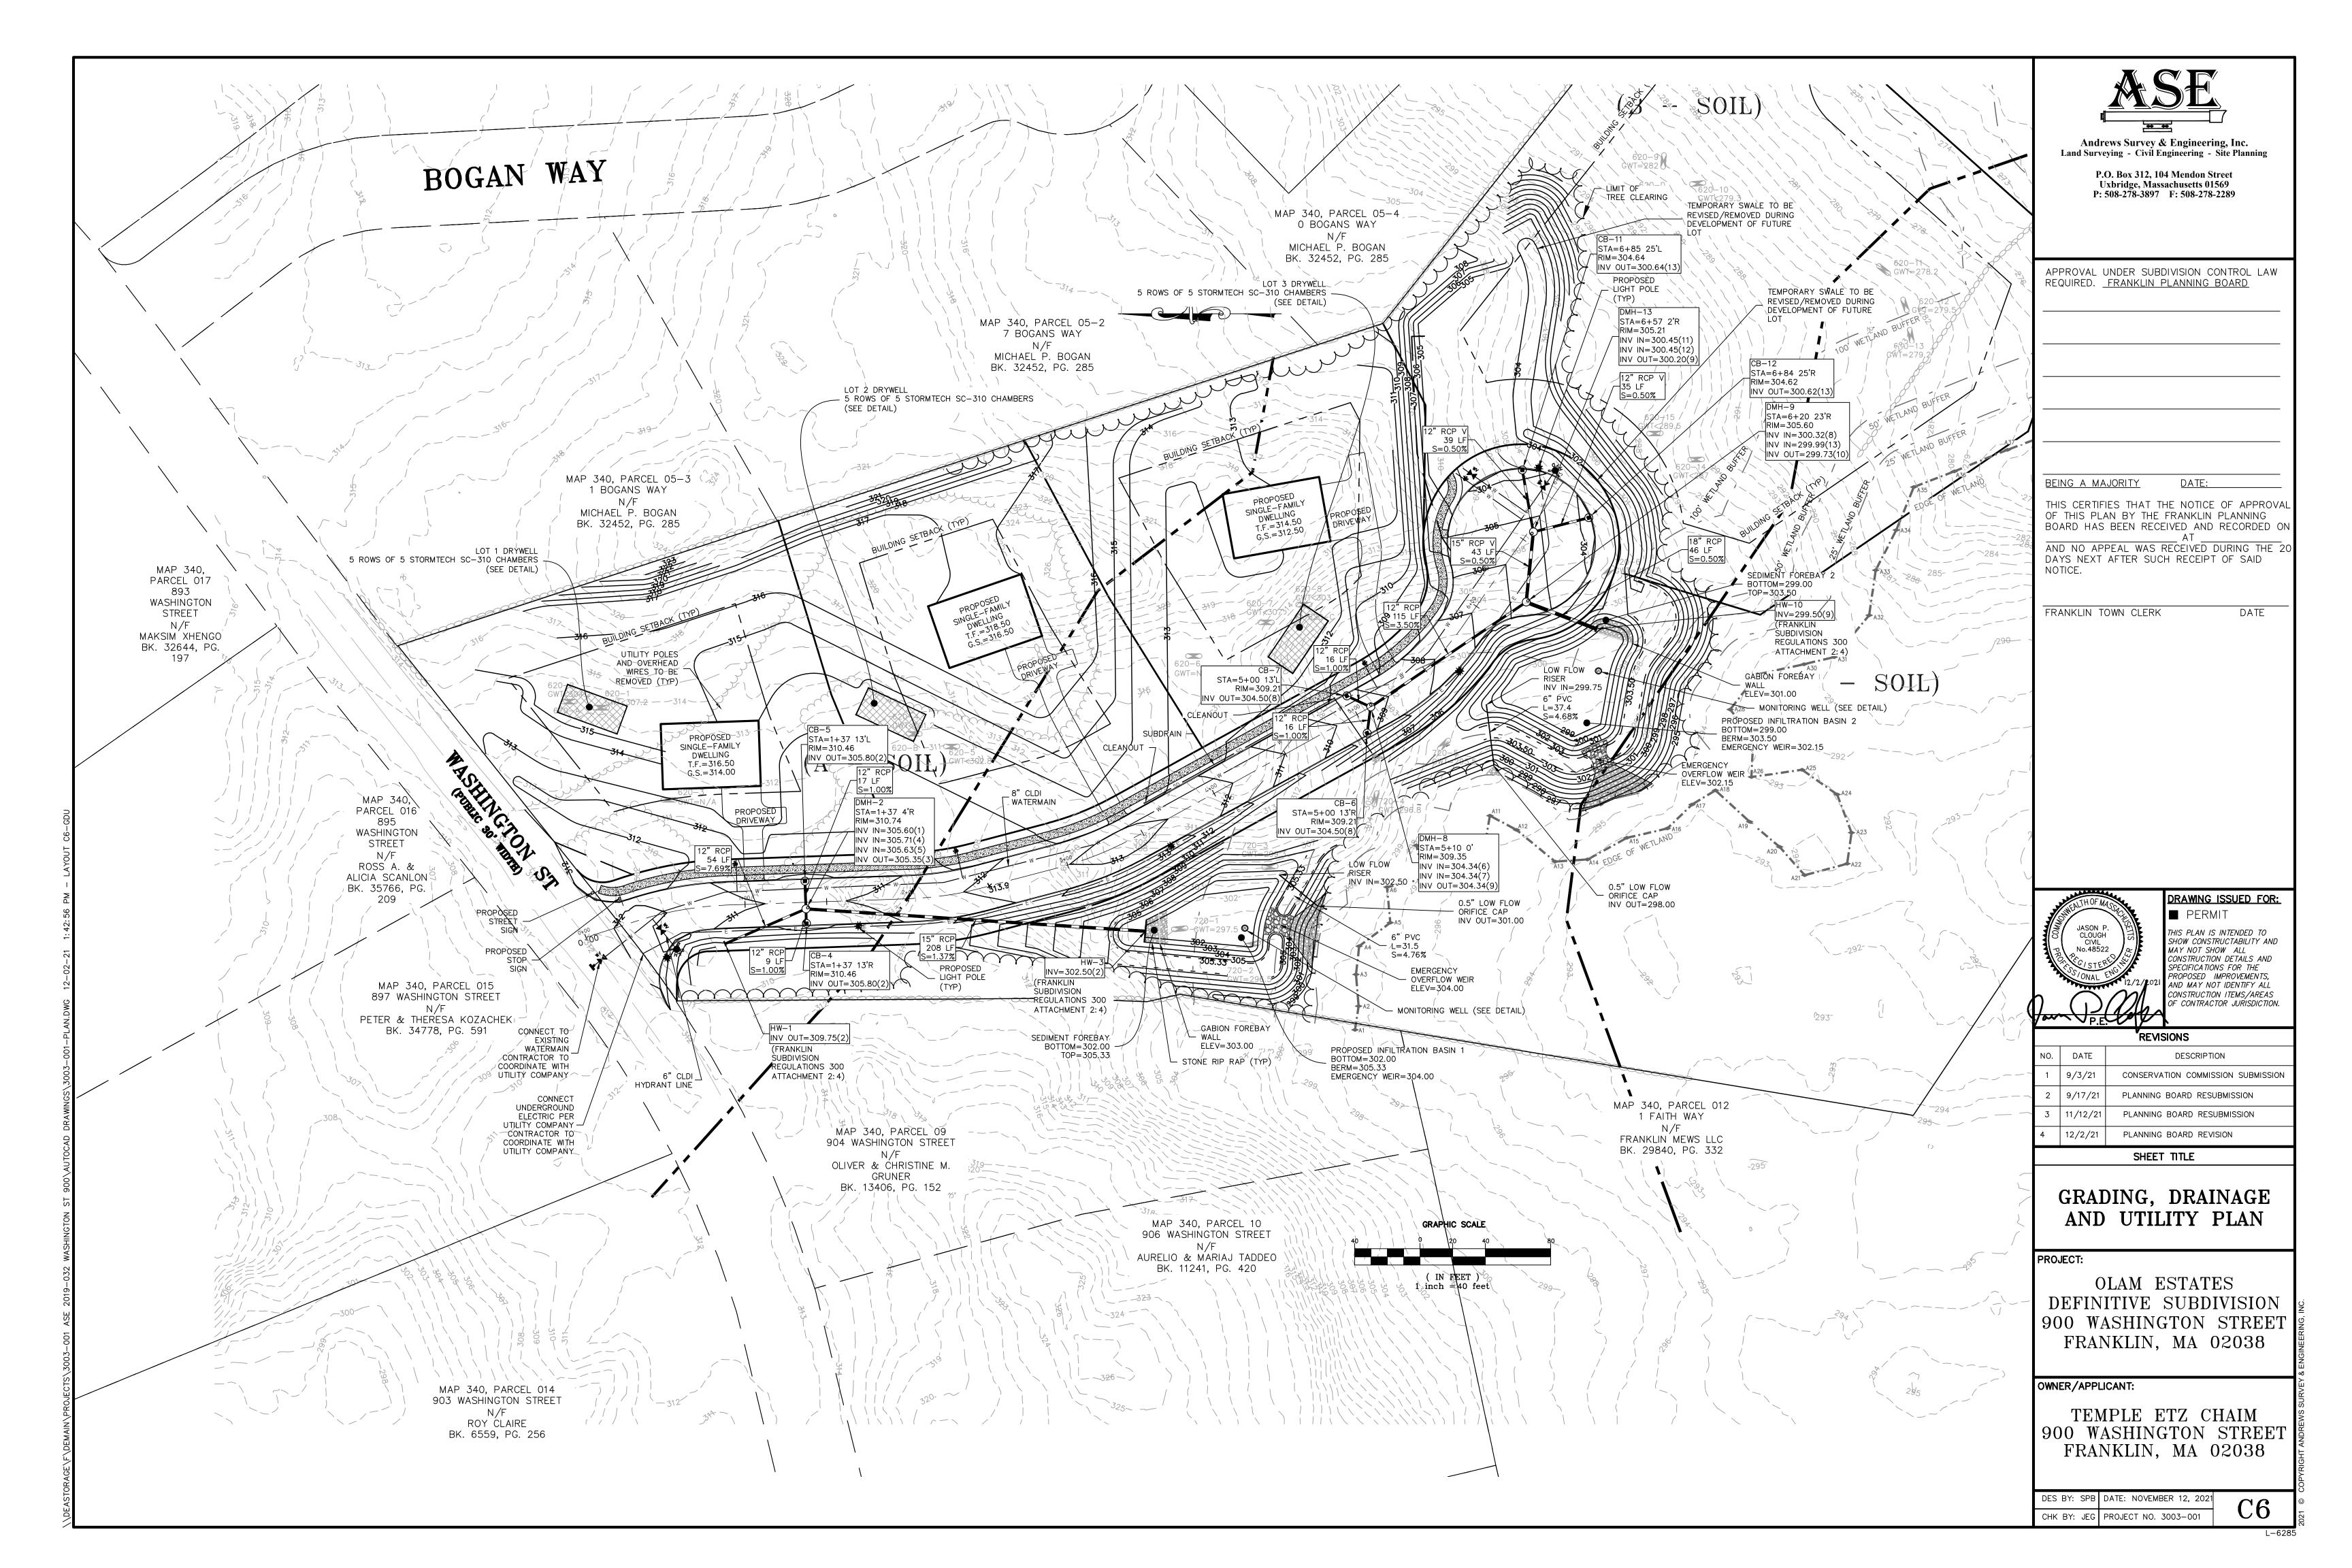











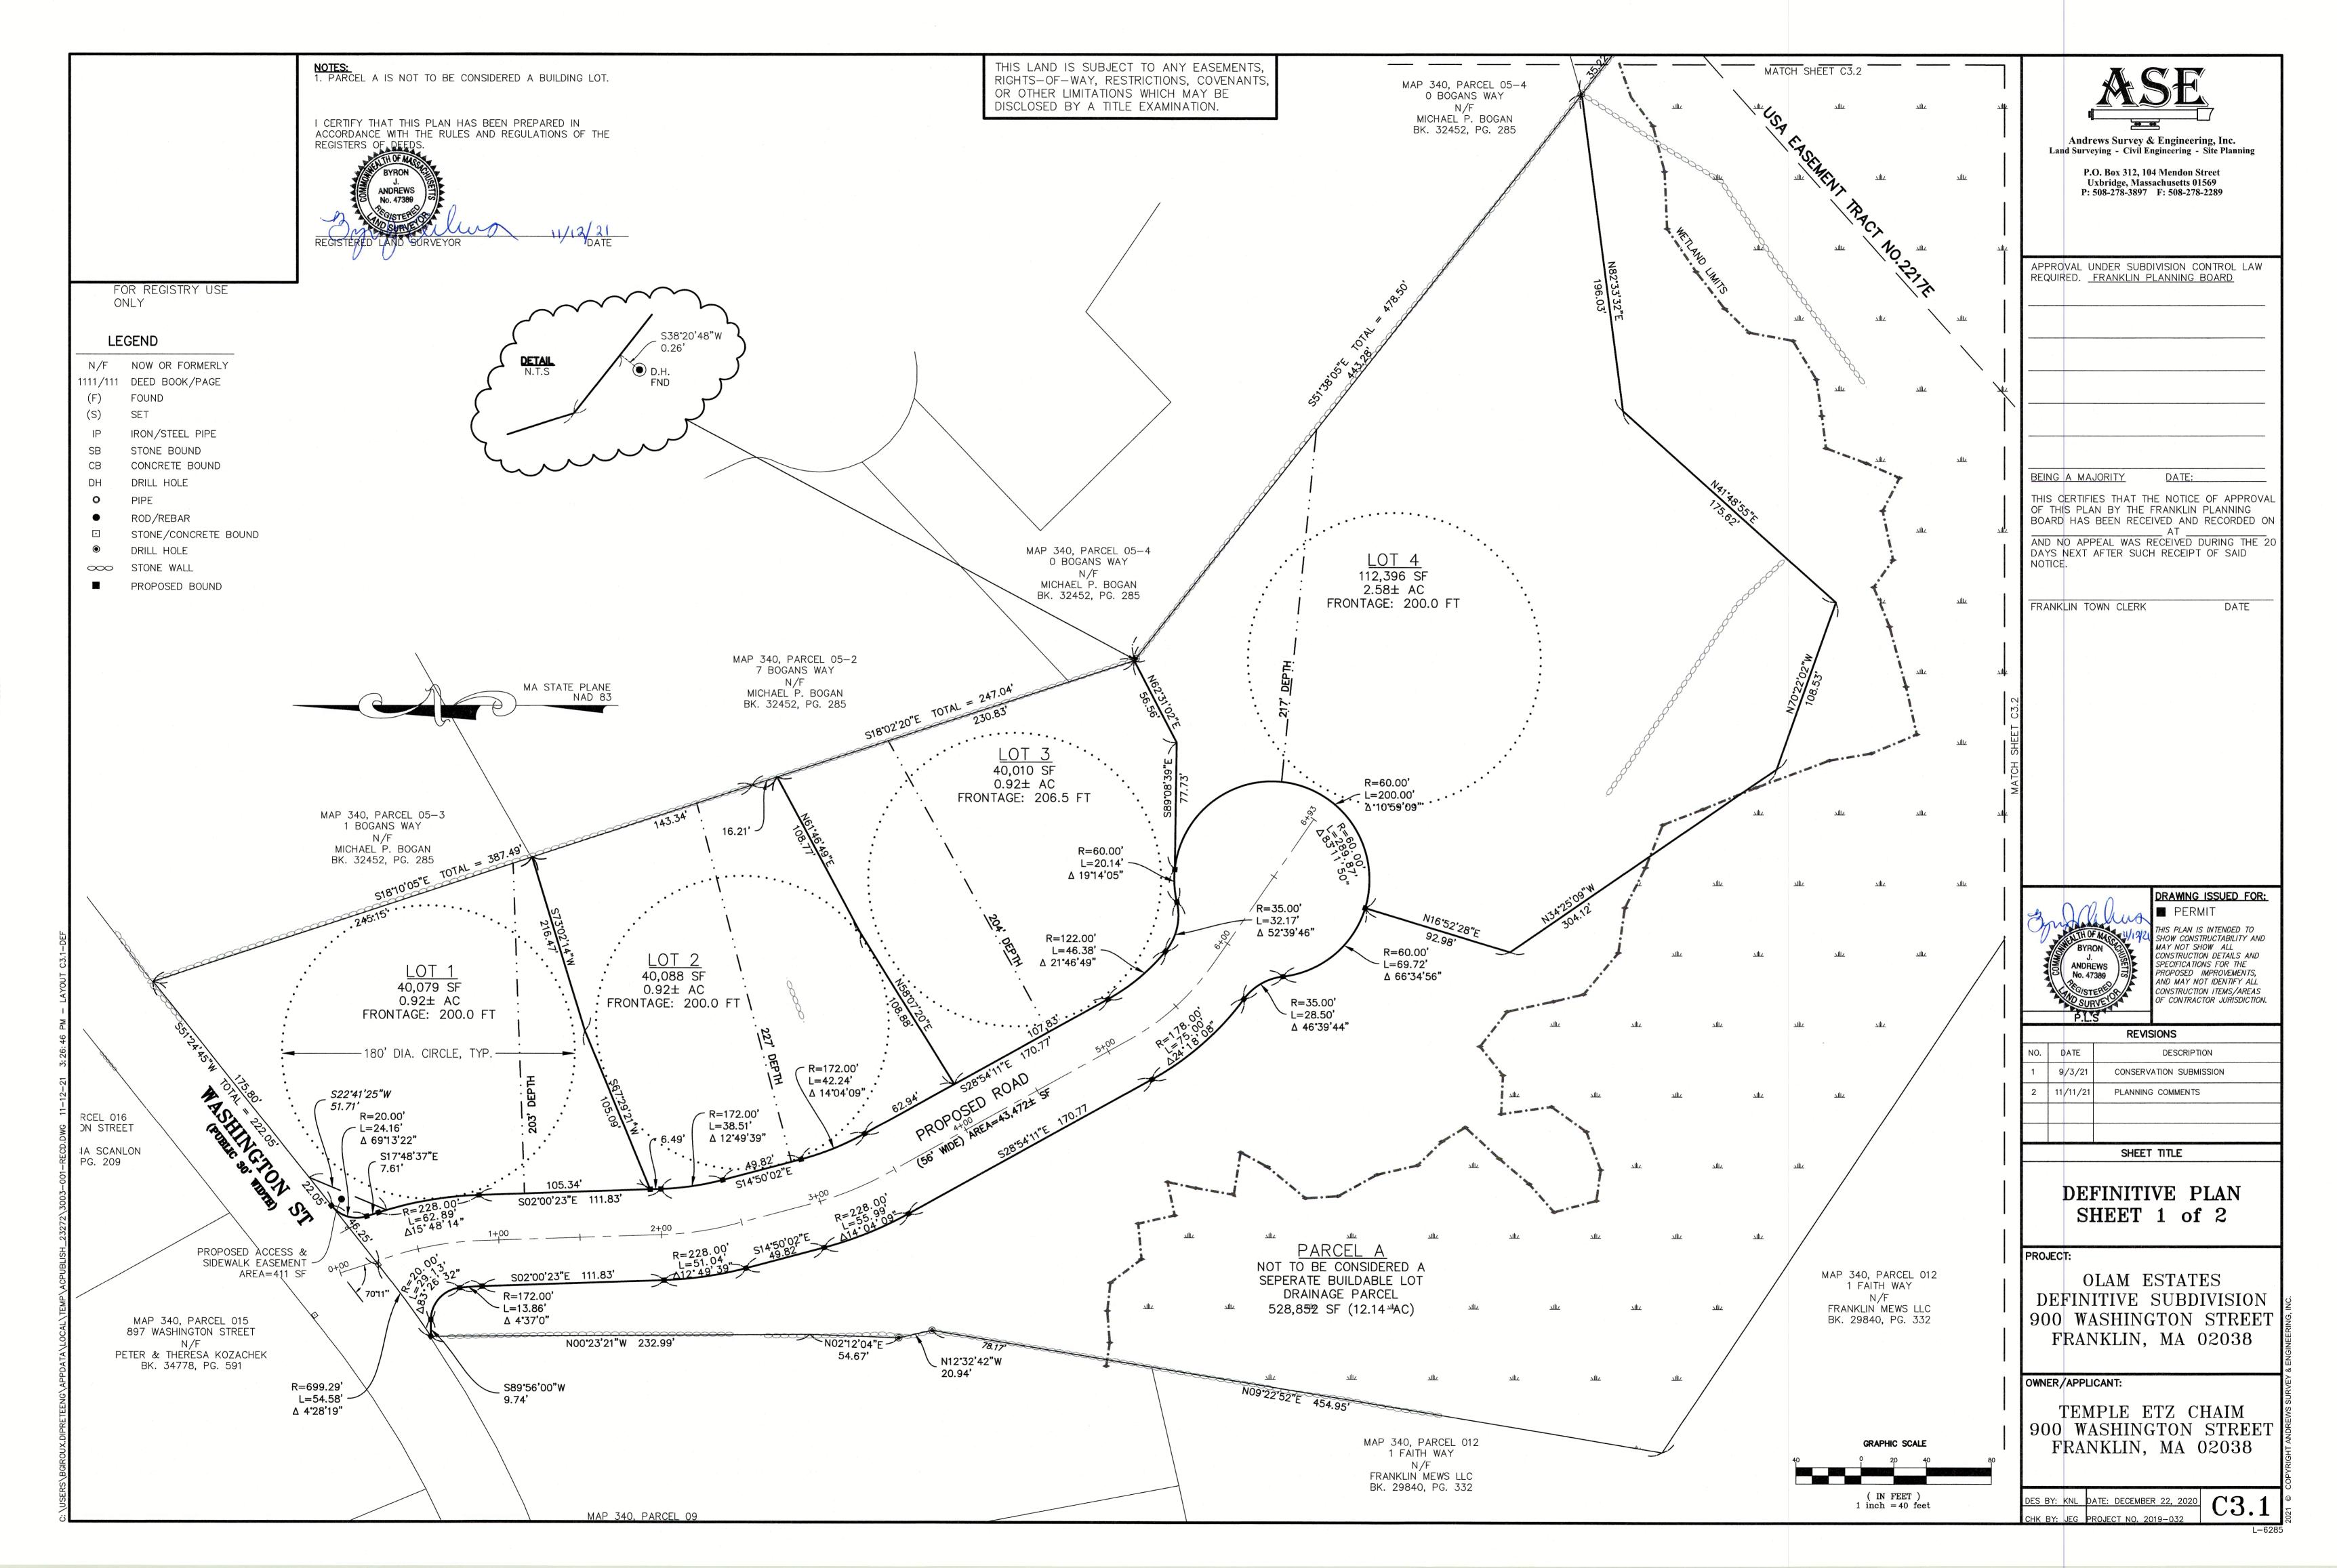


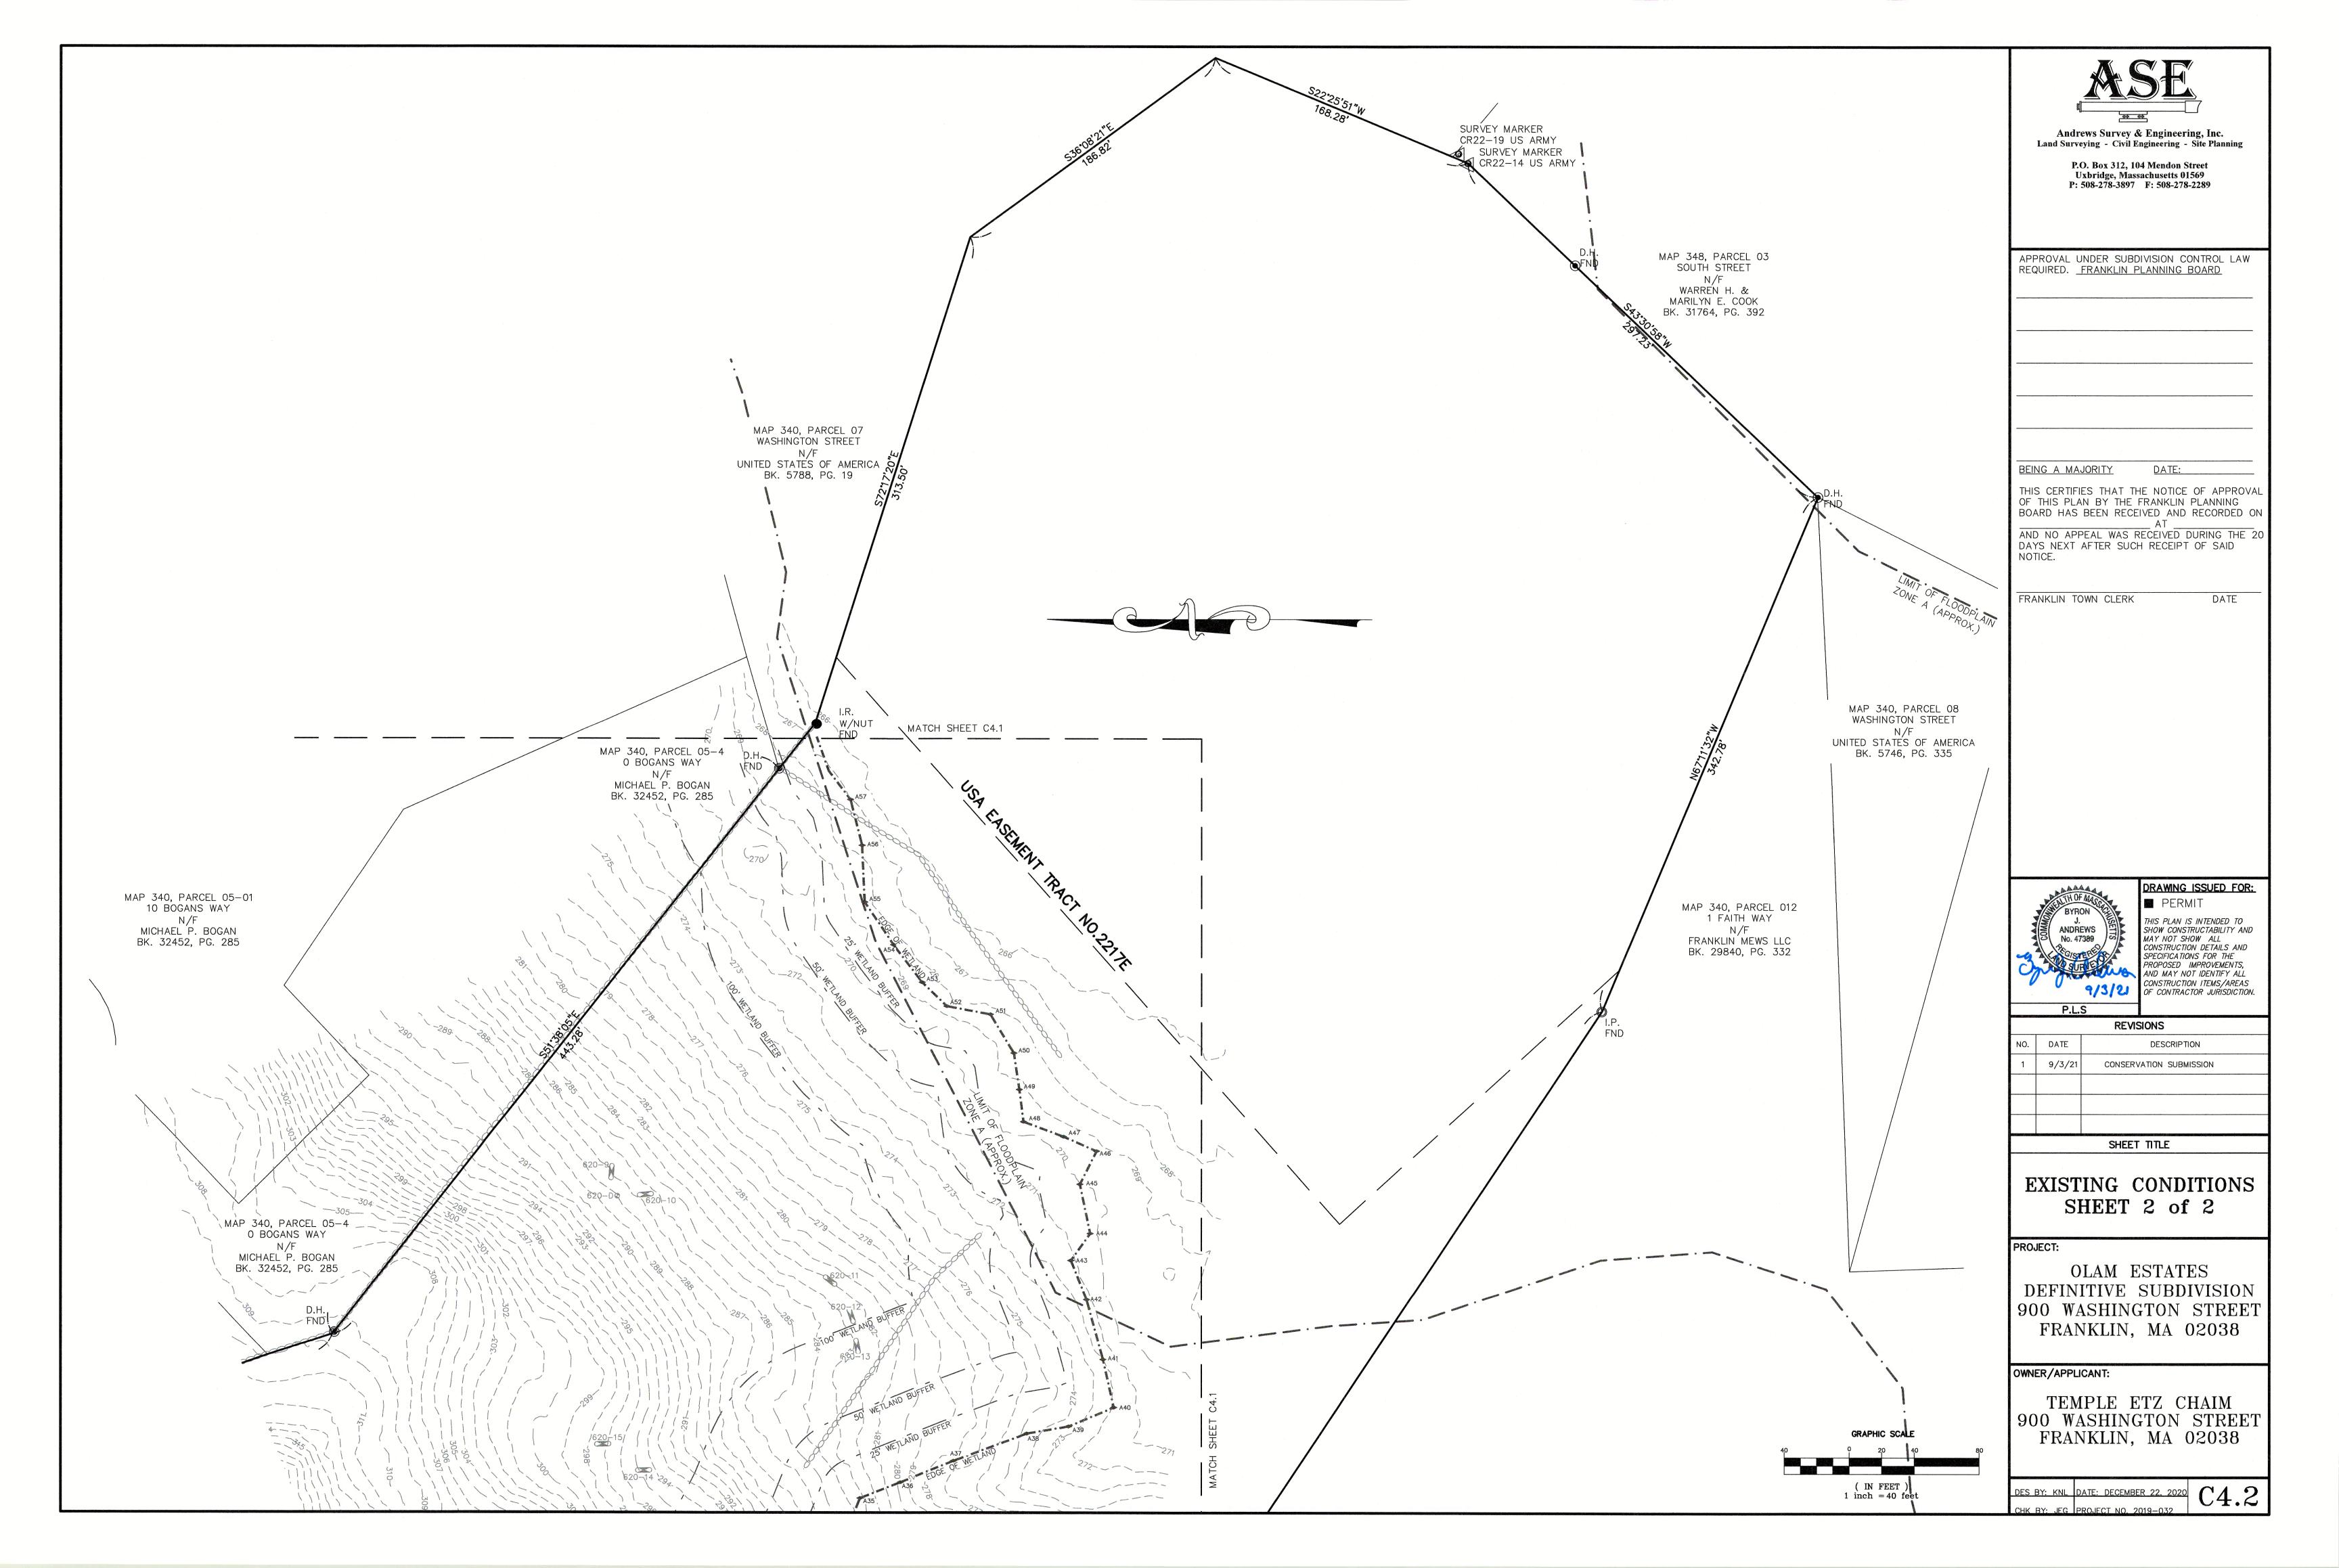

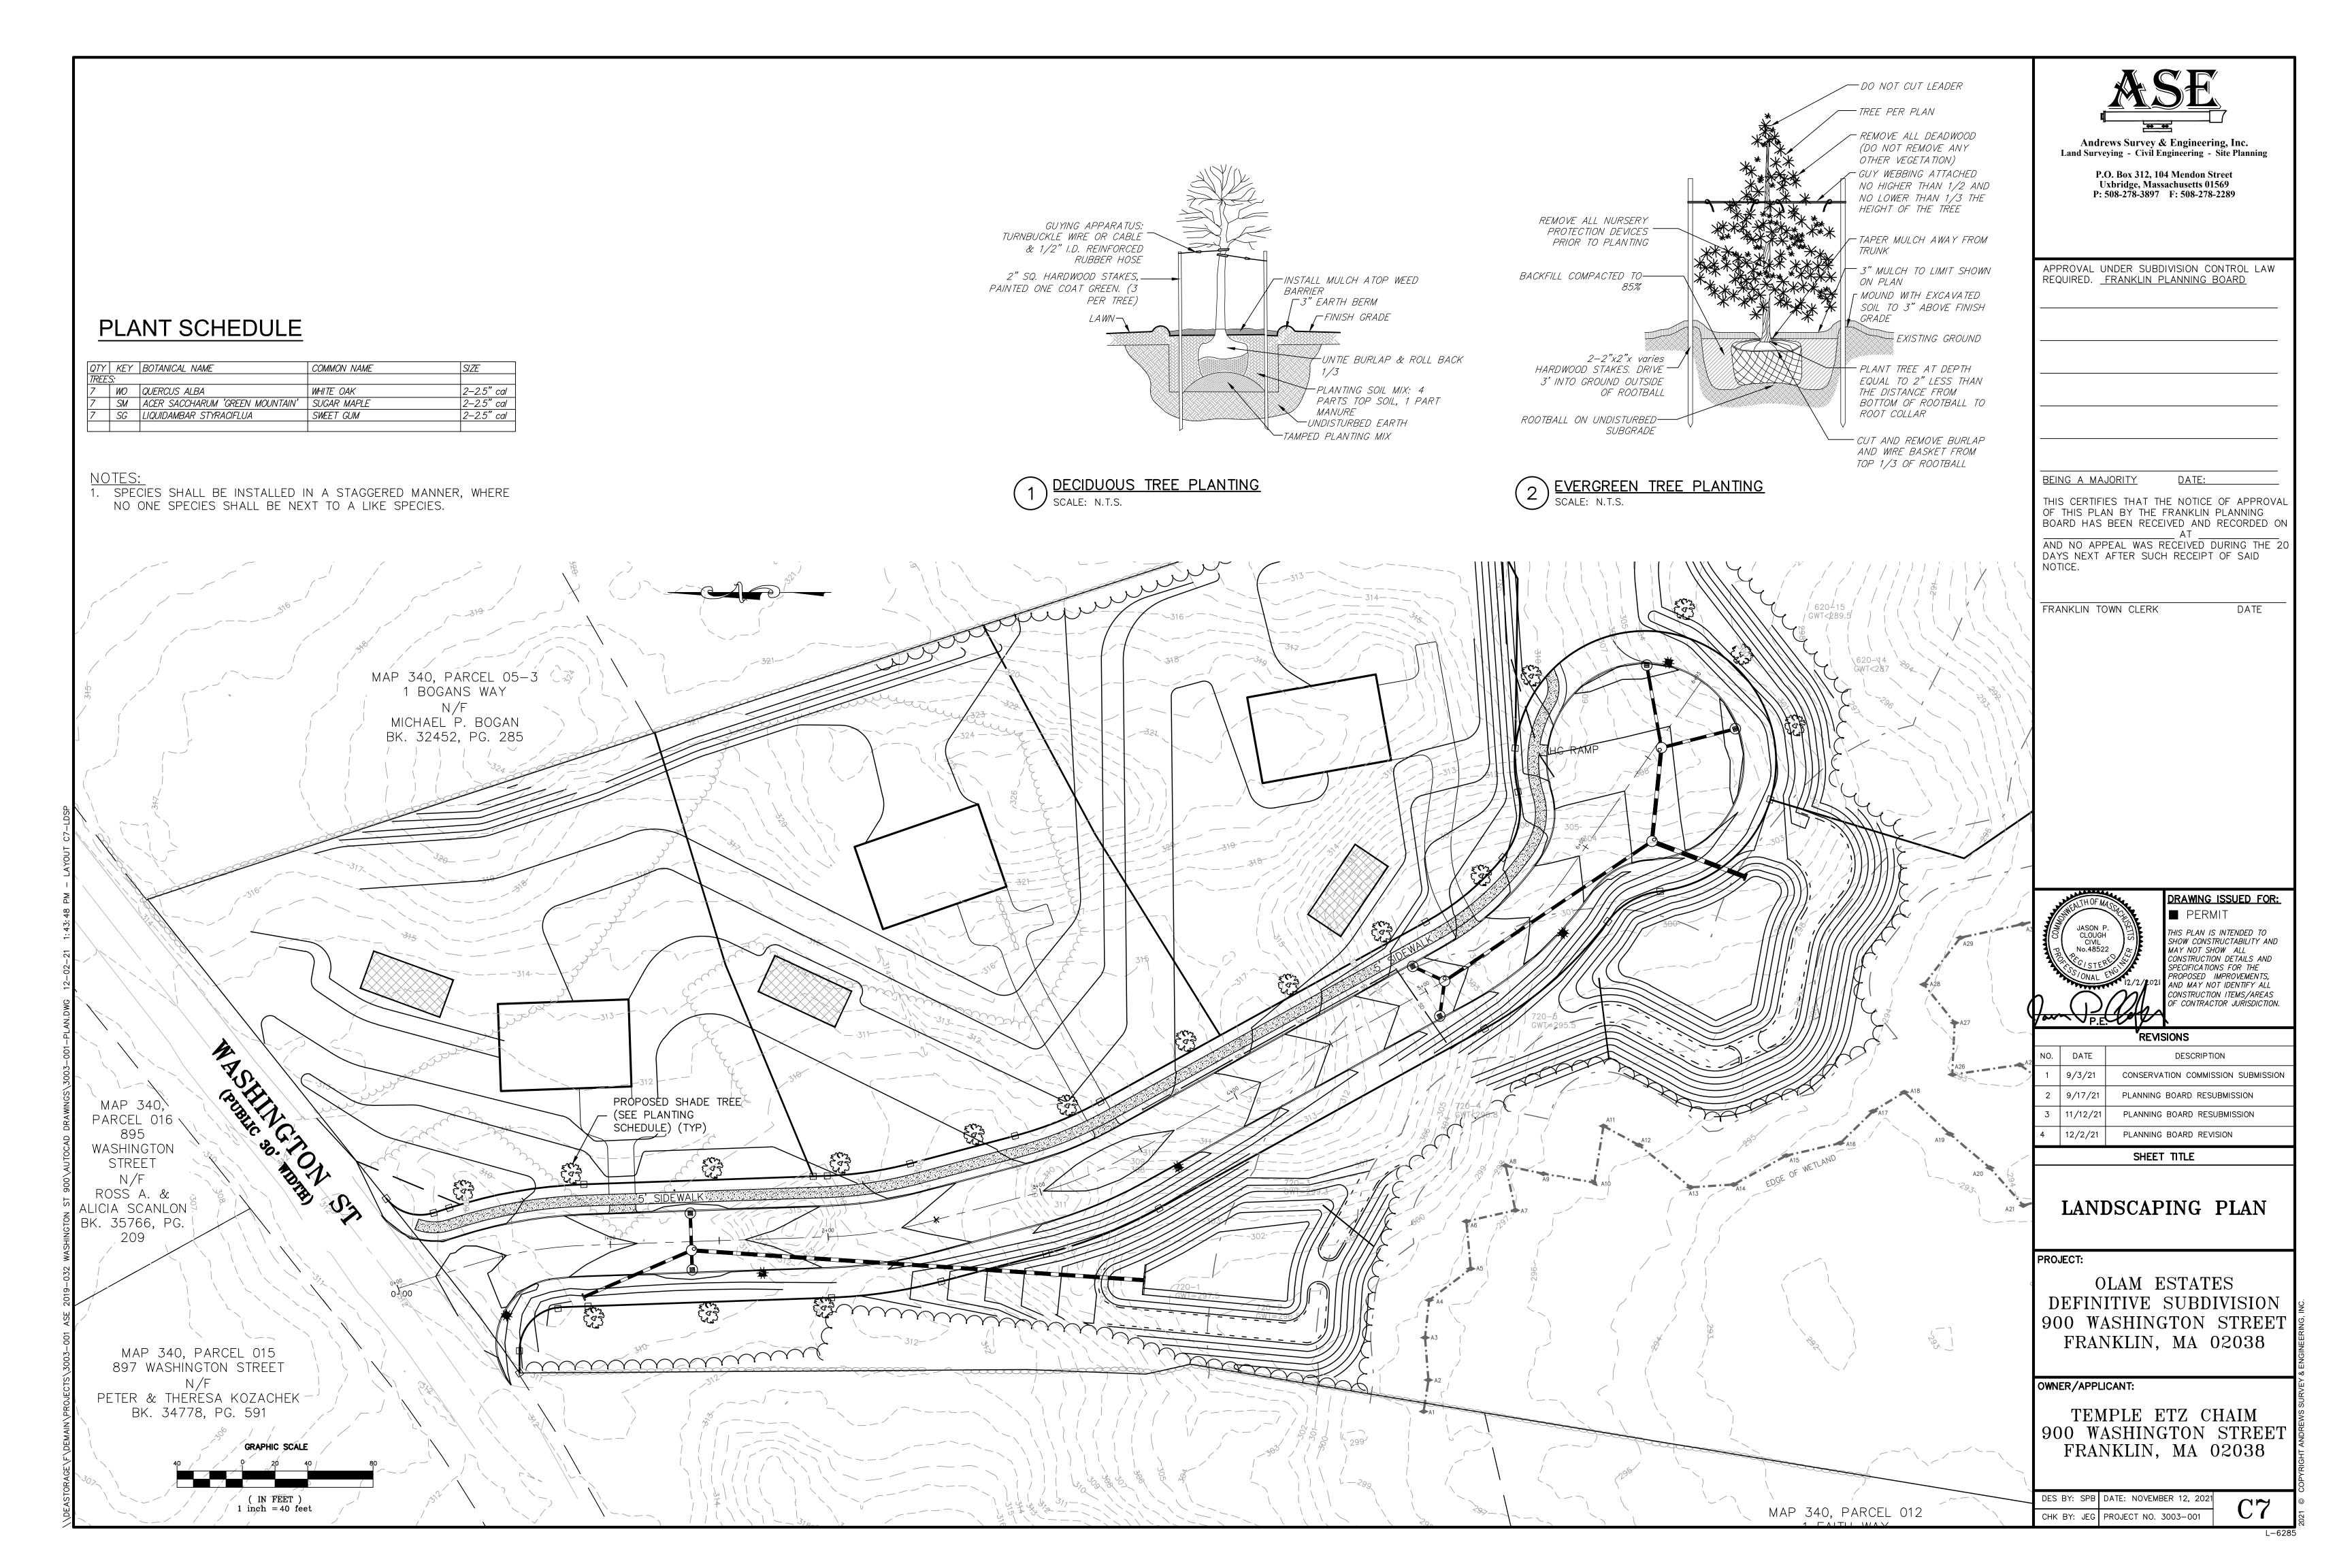

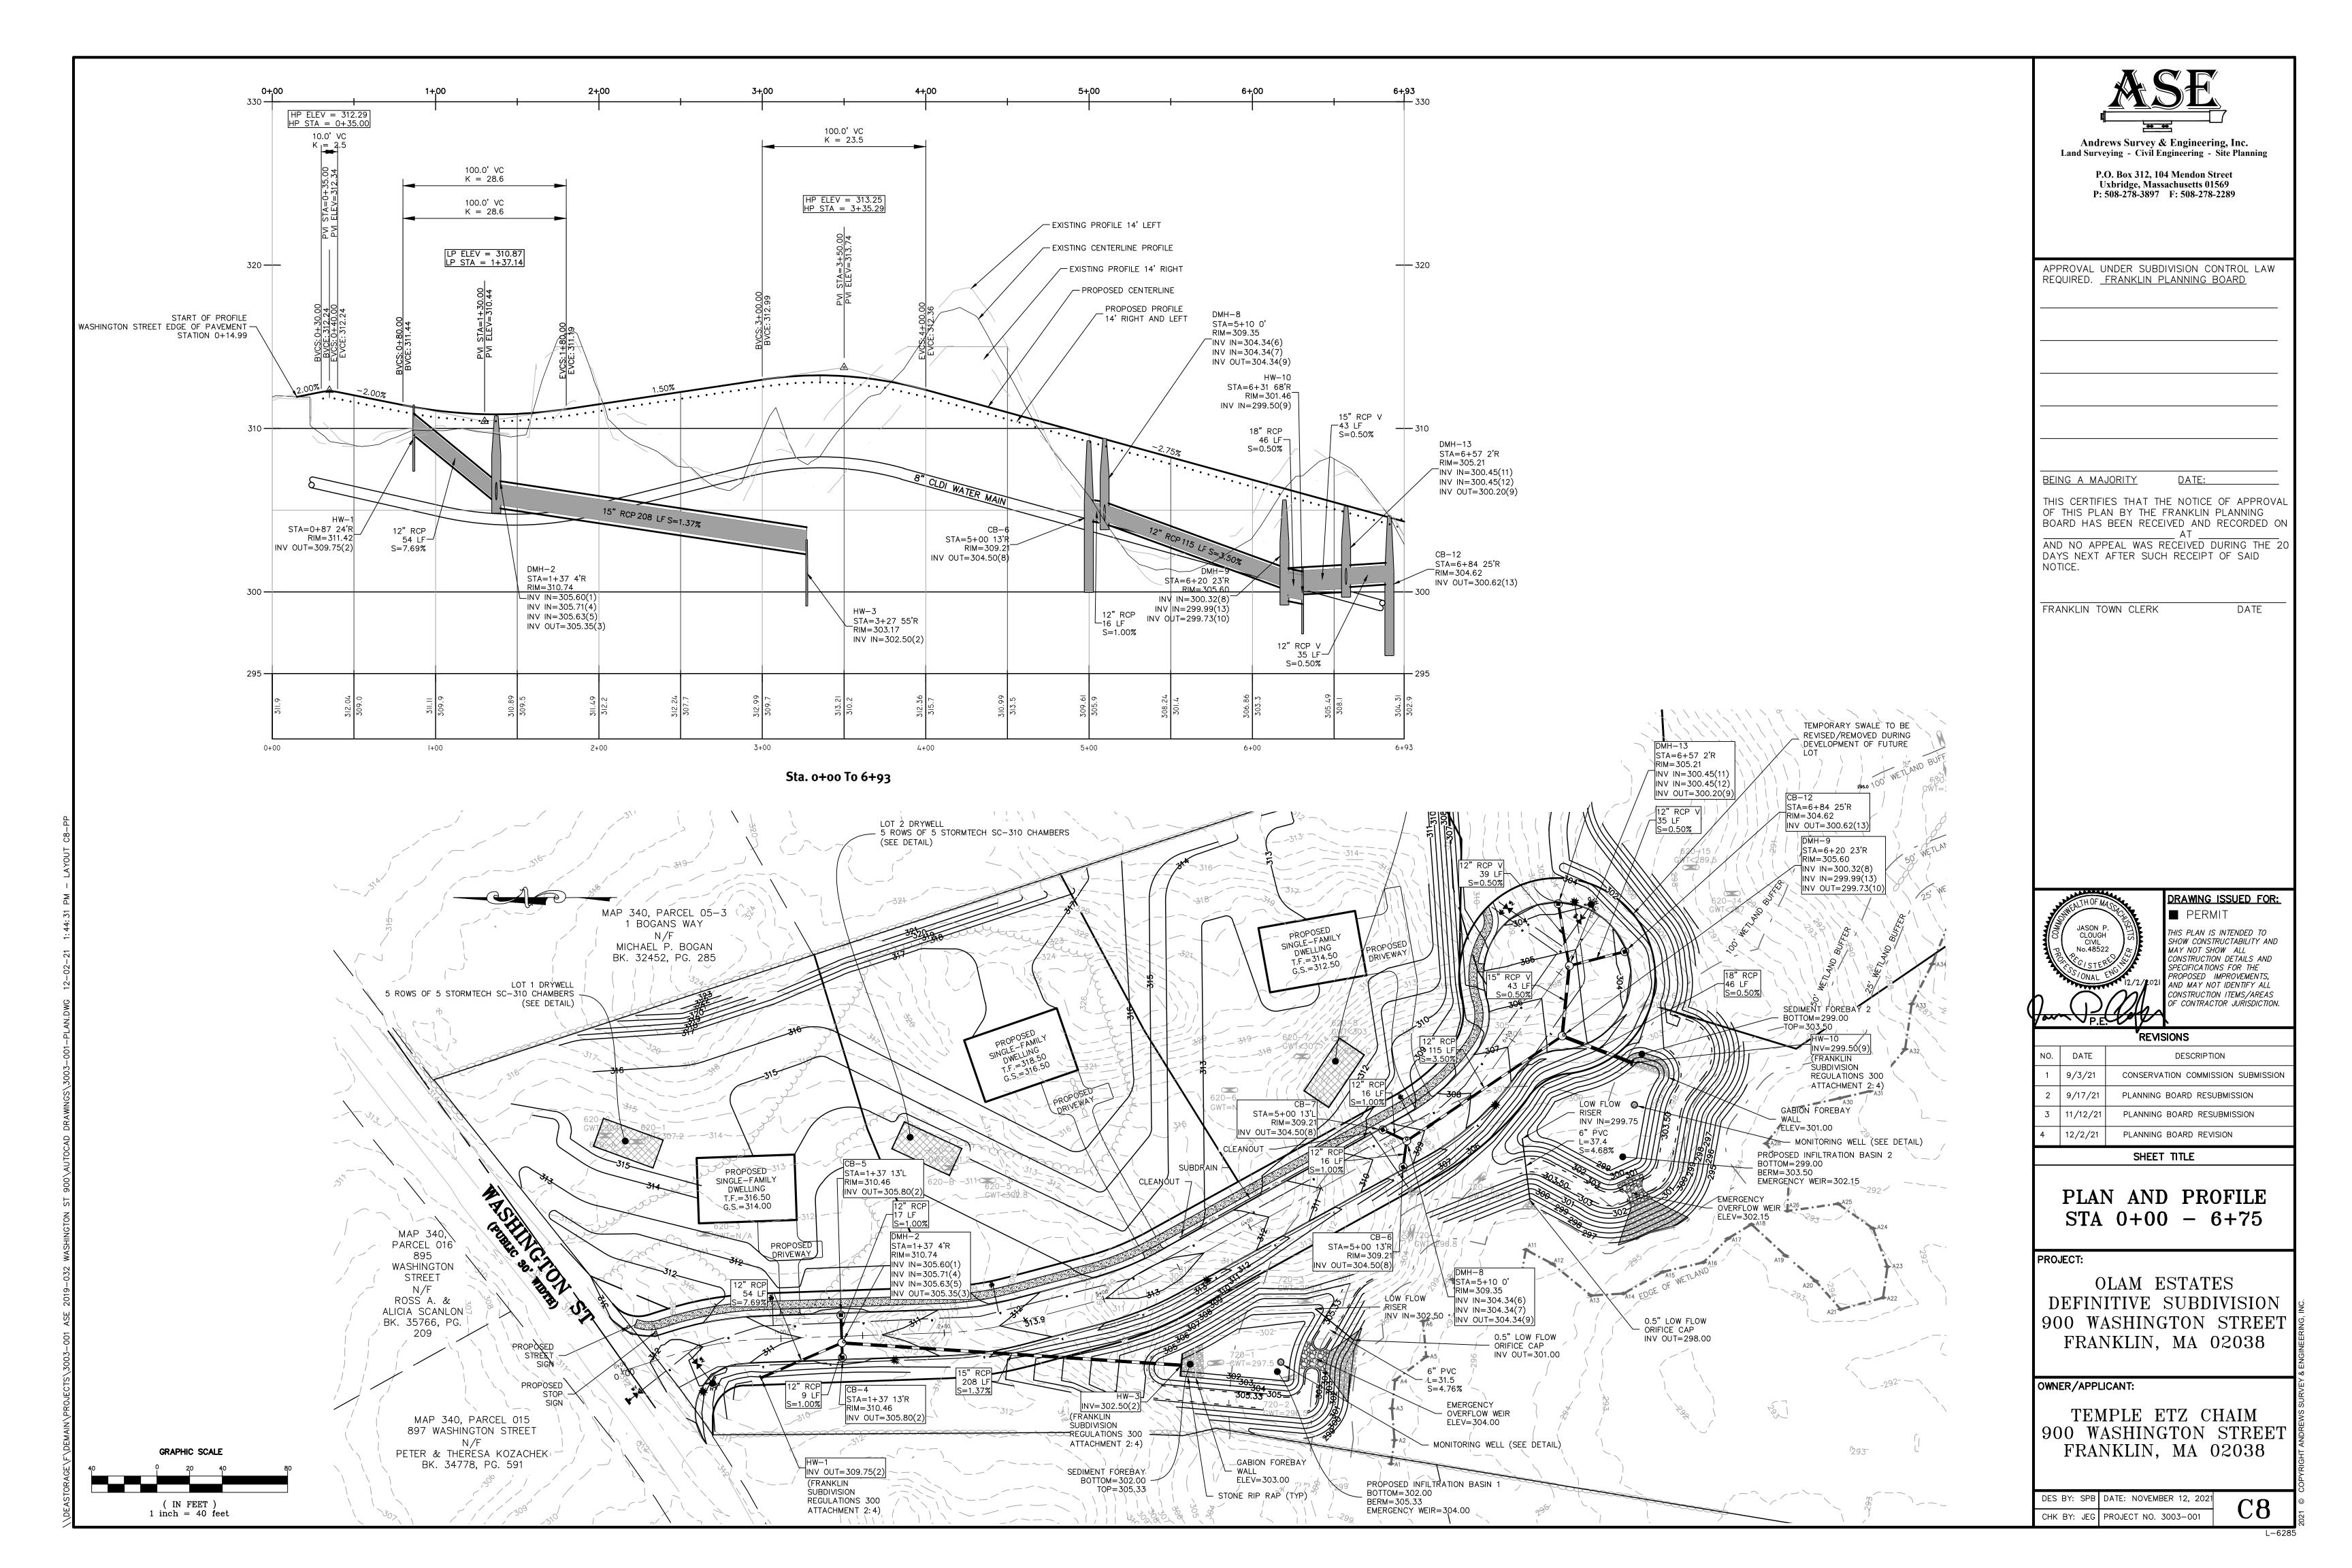

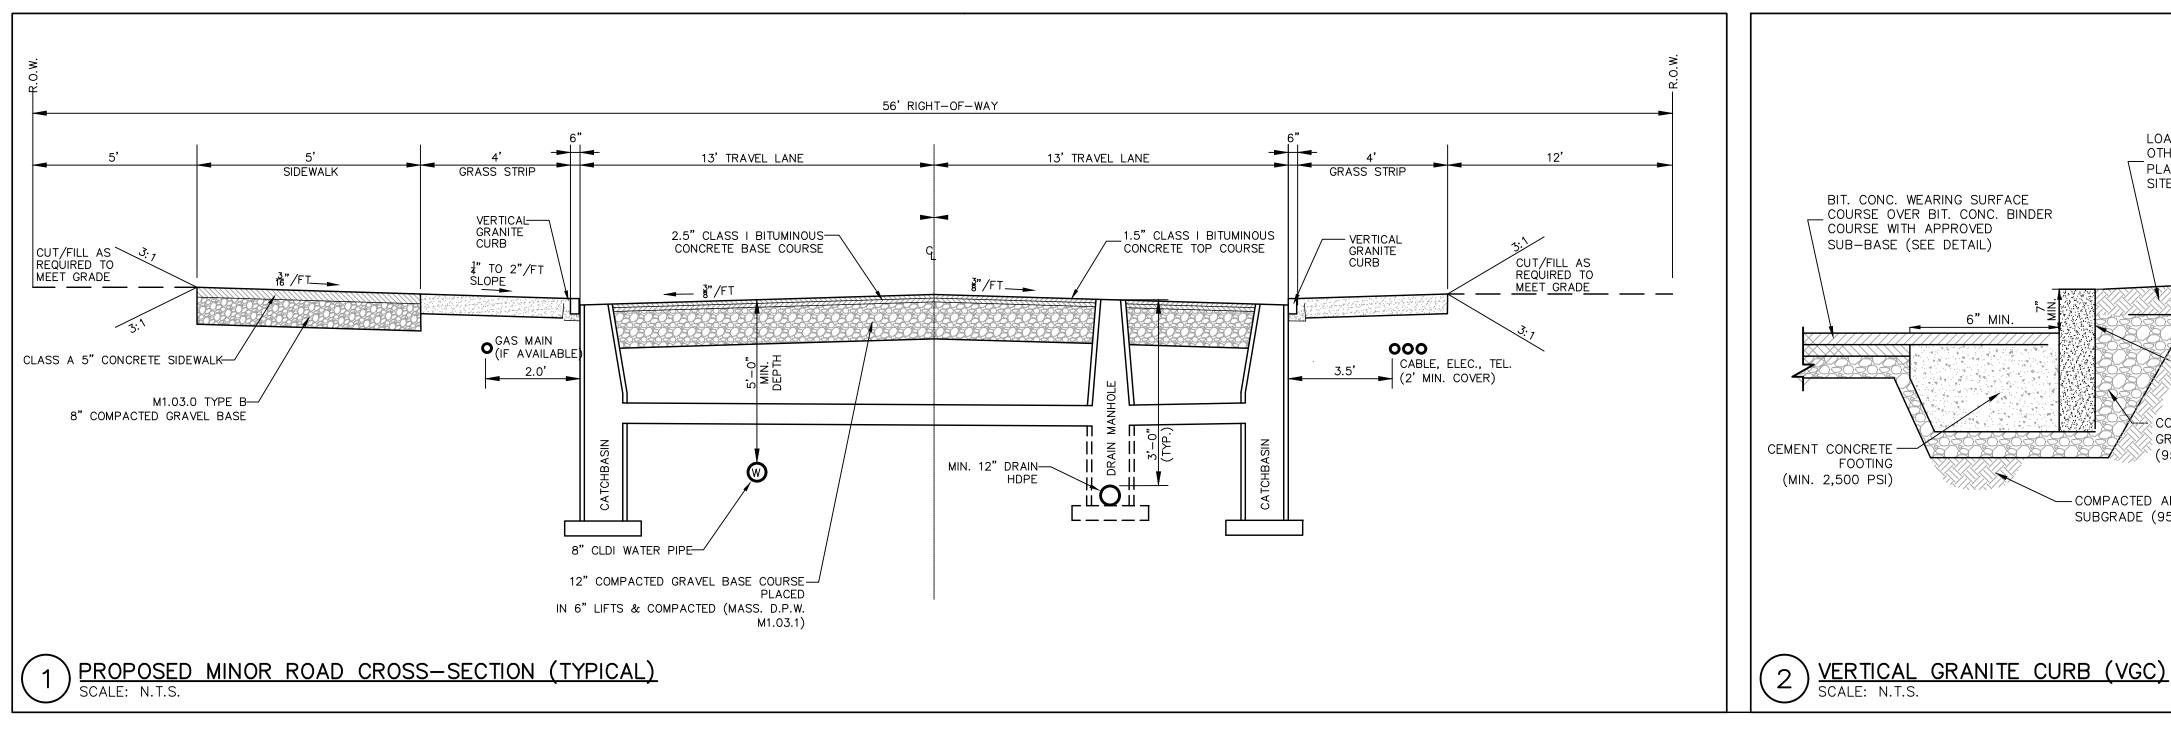

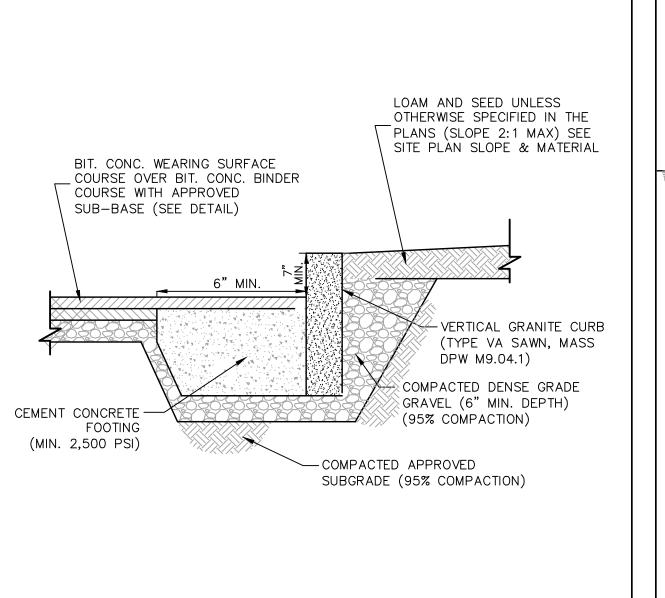

. REINFORCED STEEL CONFORMS TO LATEST A185 SPEC. 0.12 SQ. IN./LINEAL

3. MANHOLE DESIGN CONFORMS TO LATEST ASTM C478 SPEC. FOR "PRECAST

4. JOINT SEALANT SHALL BE SYNTHETIC RUBBER GASKET THAT COMPLIES W/

12" WIDE MANHOLE

_∲ STEPS-

SECTION

MIN. 0.12 SQ. IN. STEEL REINFORCEMENT

PER VERTICAL FOOT AND BASE BOTTOM

MANHOLE DIA. GIVEN ARE FOR STRAIGHT

THROUGH PIPE & MAY HAVE TO BE INCREASED WHERE PIPE INTERSECTS AT ANGLES. CONTRACTORS SHALL VERIFY

MORTARED PIPE CONN.

PRIOR TO ORDERING STRUCTURES.

🏲 RUBBER WATERTIGHT GASKET (TYP.)

COLLARS SET IN FULL MORTAR BED

(BOTH WAYS)

—9" MIN. DEPTH 3/4" CRUSHED STONE

(2 MIN. 5 MAX.) OR EQUIVALENT CONCRETE

C-443 OR C-361. 5. BASE SECTION SHALL BE ONE POUR MONOLITHIC.


FT. (0.15 SQ. IN. FOR 60" DIA) AND BASE BOTTOM.

2. CONCRETE COMPRESSIVE STRENGTH 4000 PSI MIN.

REINFORCED CONCRETE MANHOLE SECTIONS".

LEBARON LA246 MANHOLE FRAME AND

COVER TO BE LETTERED "DRAIN"

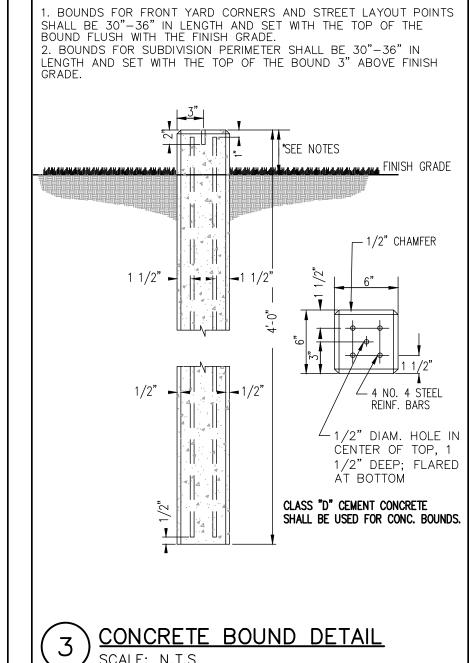

__ 24" DIA. __

SECTION FORCED FOR HS-20 LOADING)

ALTERNATE TOP SLAB



P.O. Box 312, 104 Mendon Street Uxbridge, Massachusetts 01569 P: 508-278-3897 F: 508-278-2289

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CONSTRUCTION DETAILS SHEET 1 of 3


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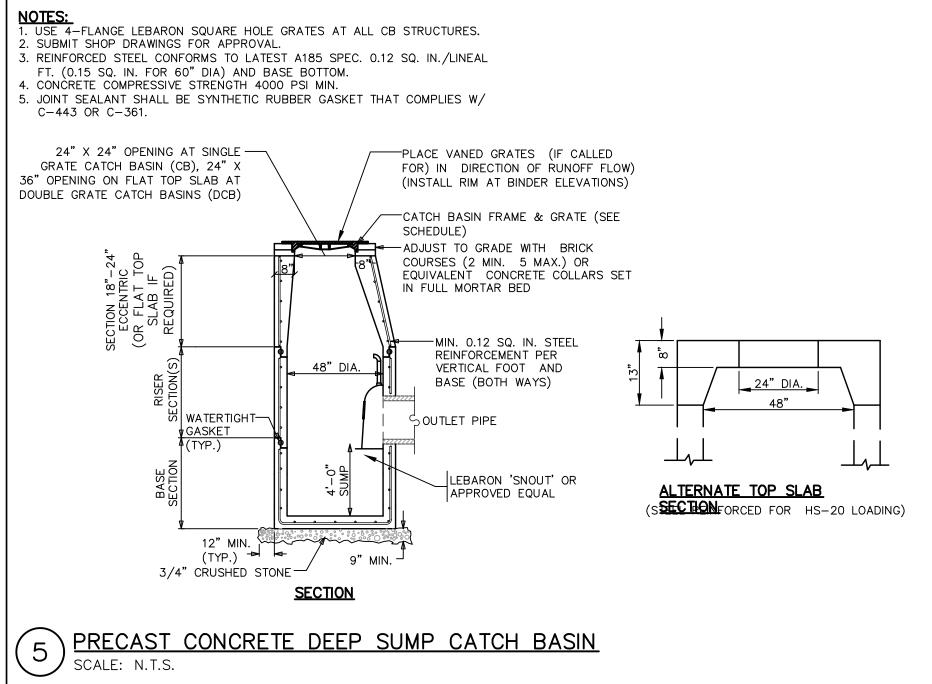
OLAM ESTATES DEFINITIVE SUBDIVISION 900 WASHINGTON STREET FRANKLIN, MA 02038


OWNER/APPLICANT:


TEMPLE ETZ CHAIM 900 WASHINGTON STREET FRANKLIN, MA 02038


DES BY: SPB DATE: NOVEMBER 12, 2021 CHK BY: JEG PROJECT NO. 3003-001




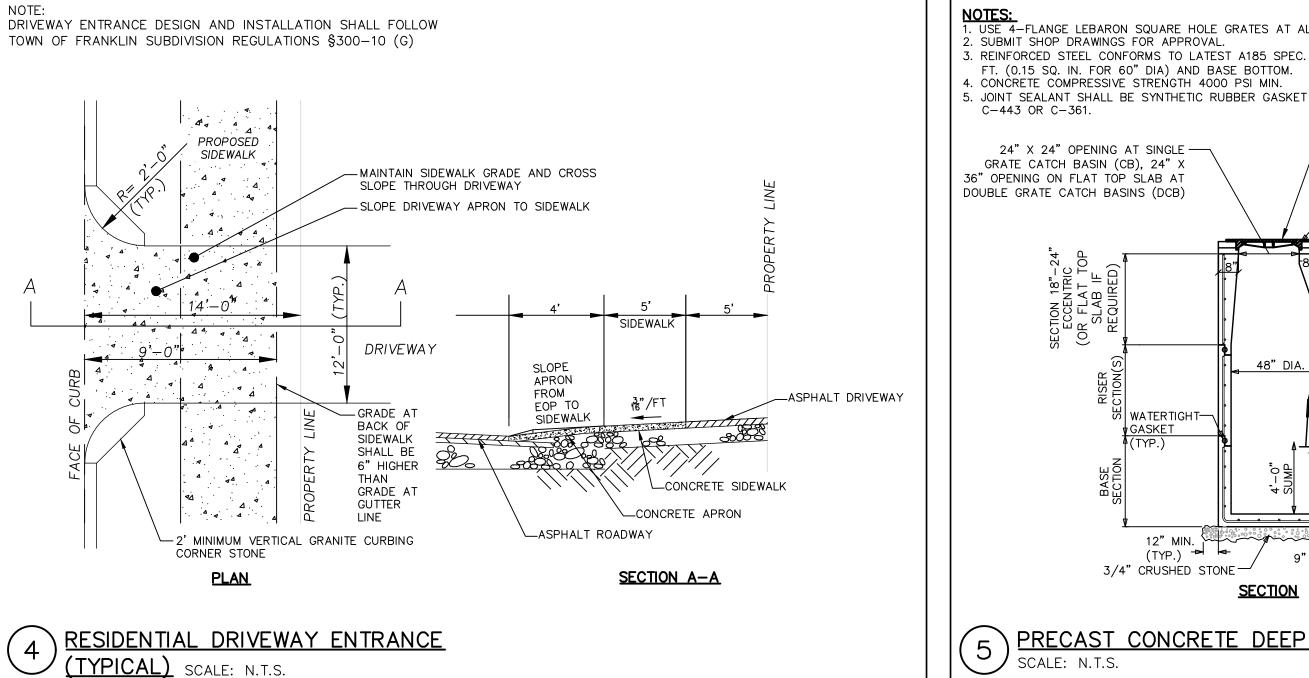


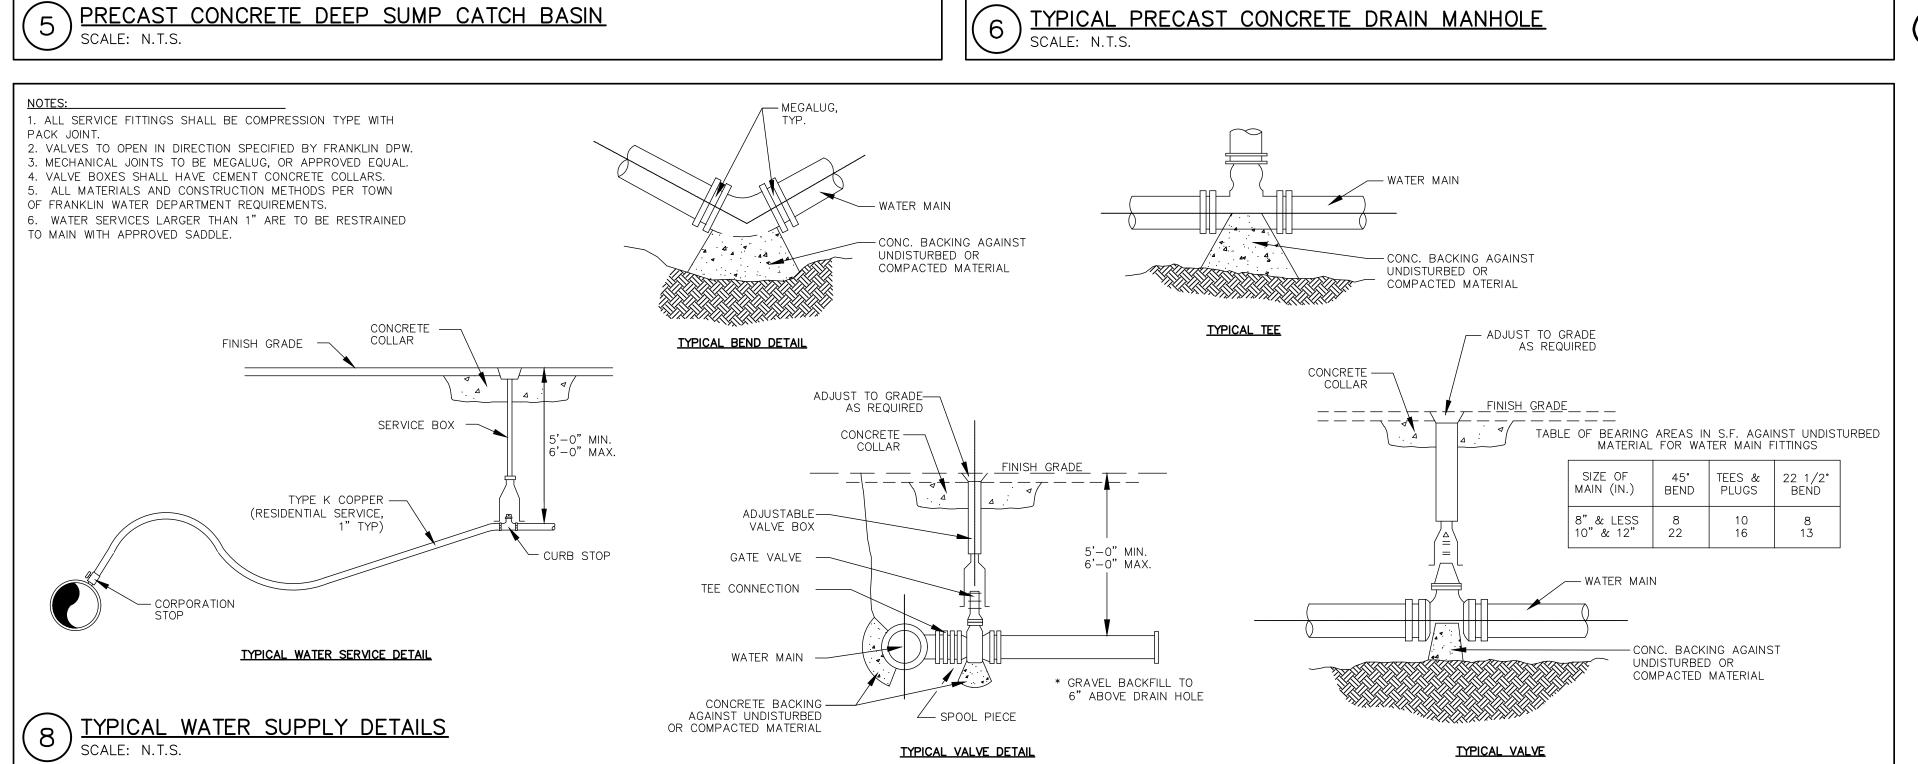

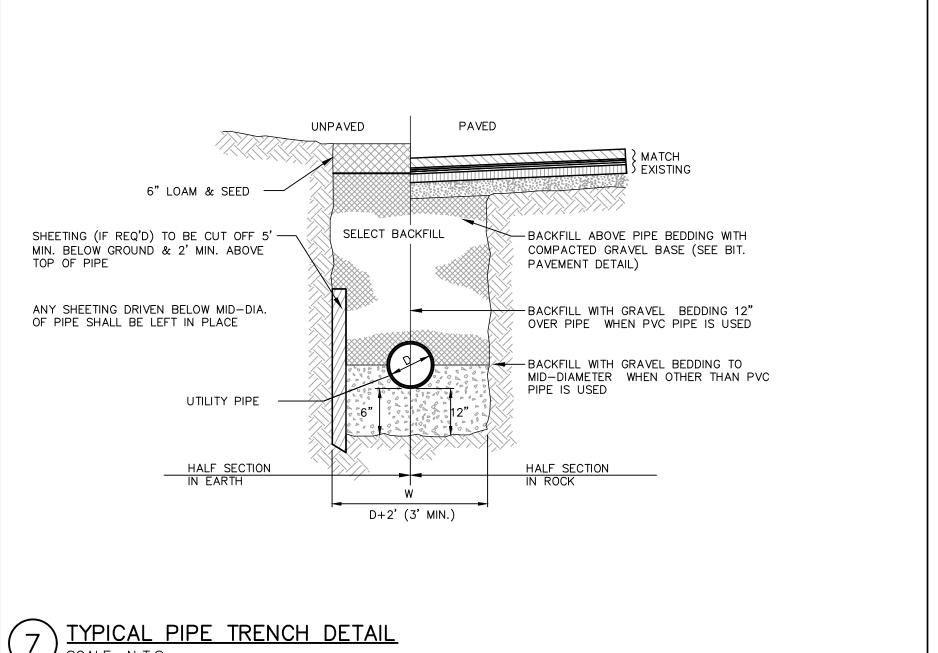


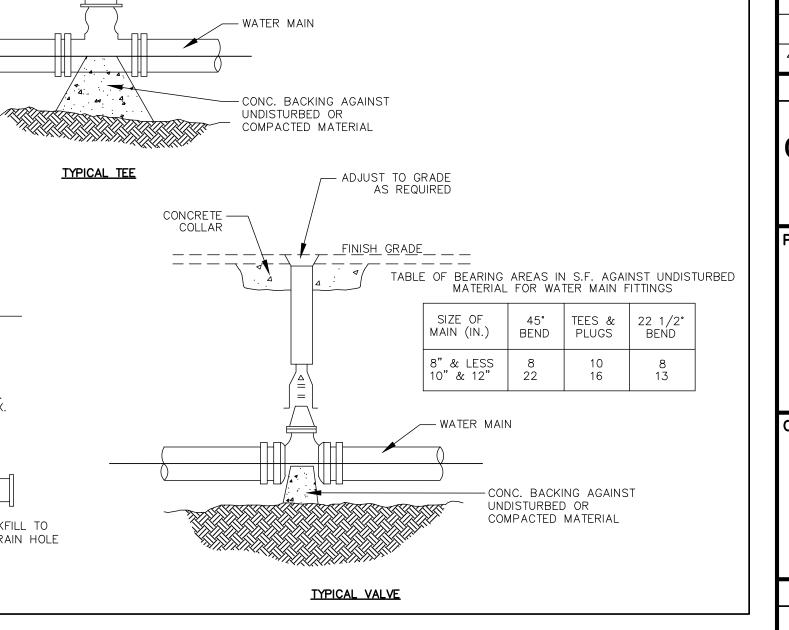


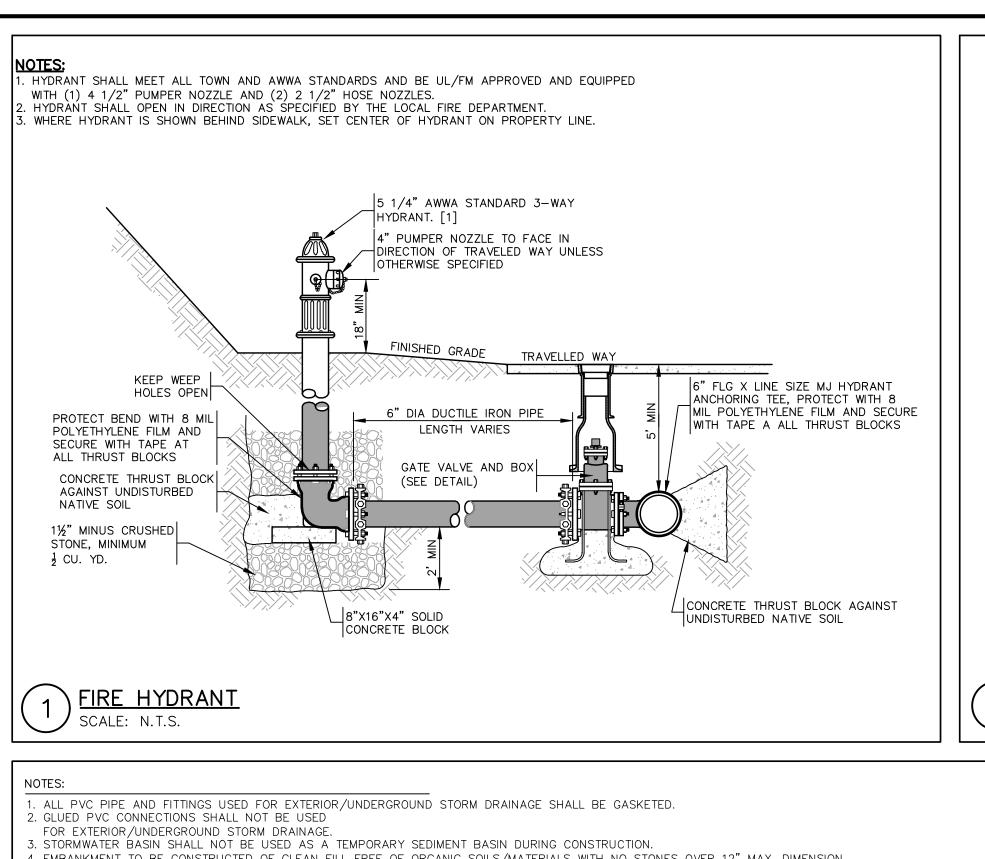


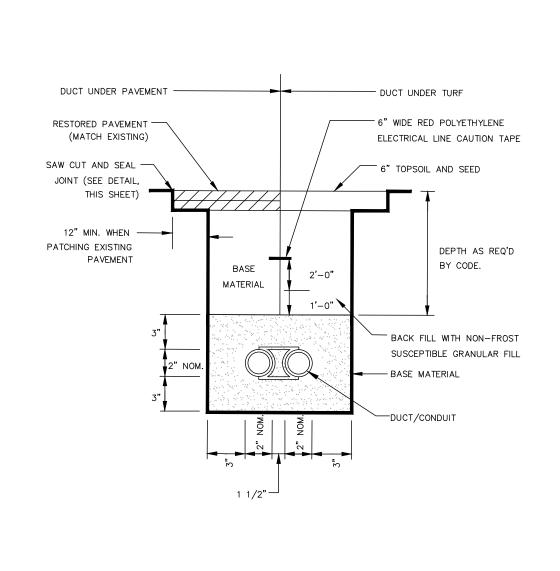


UNENCASED DUCT/CONDUIT DETAIL

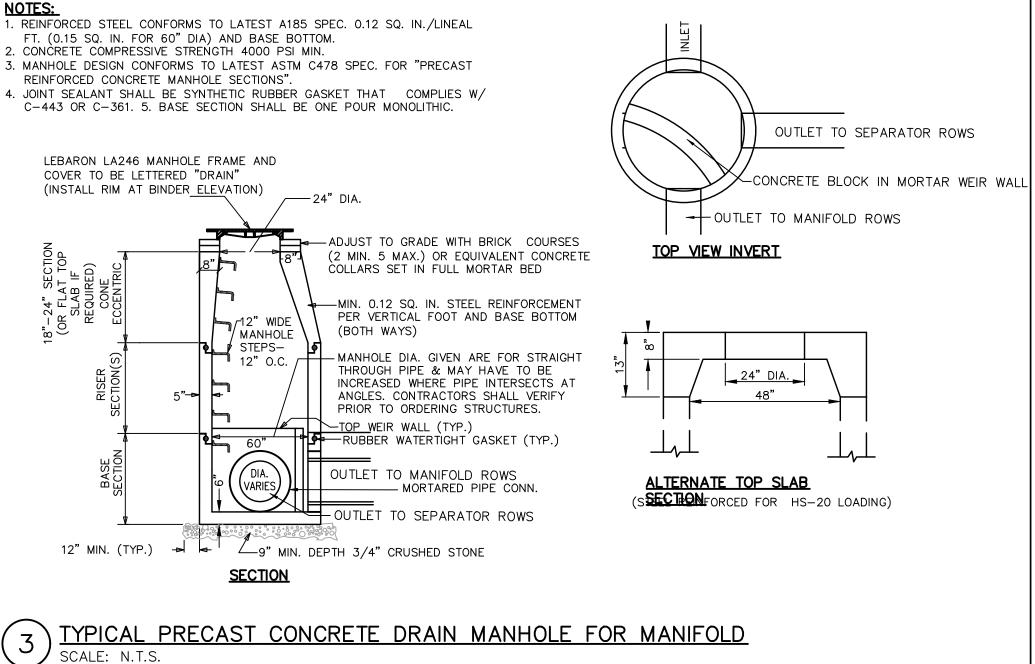

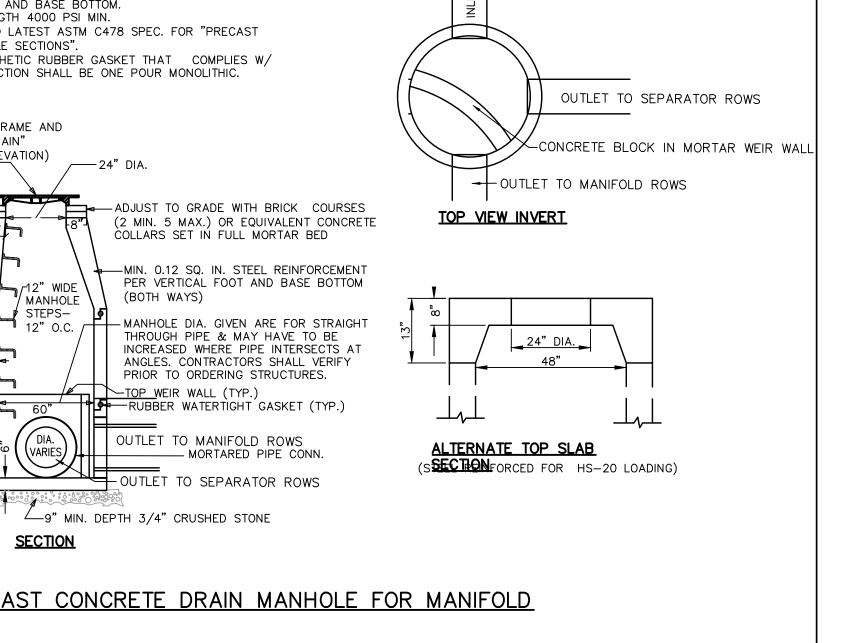

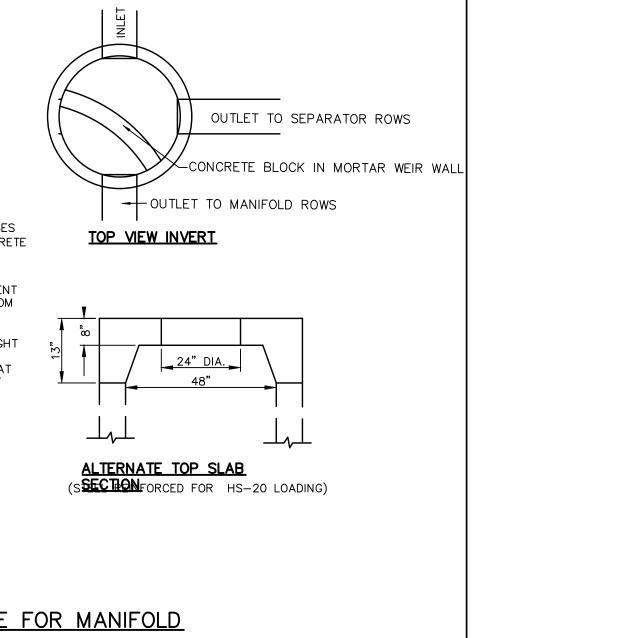

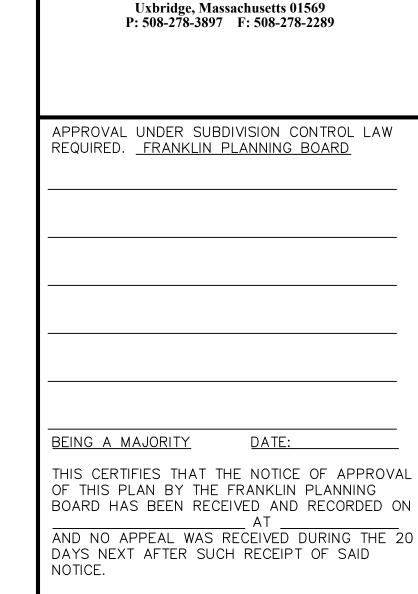



Andrews Survey & Engineering, Inc.


Land Surveying - Civil Engineering - Site Planning


P.O. Box 312, 104 Mendon Street

FRANKLIN TOWN CLERK DATE

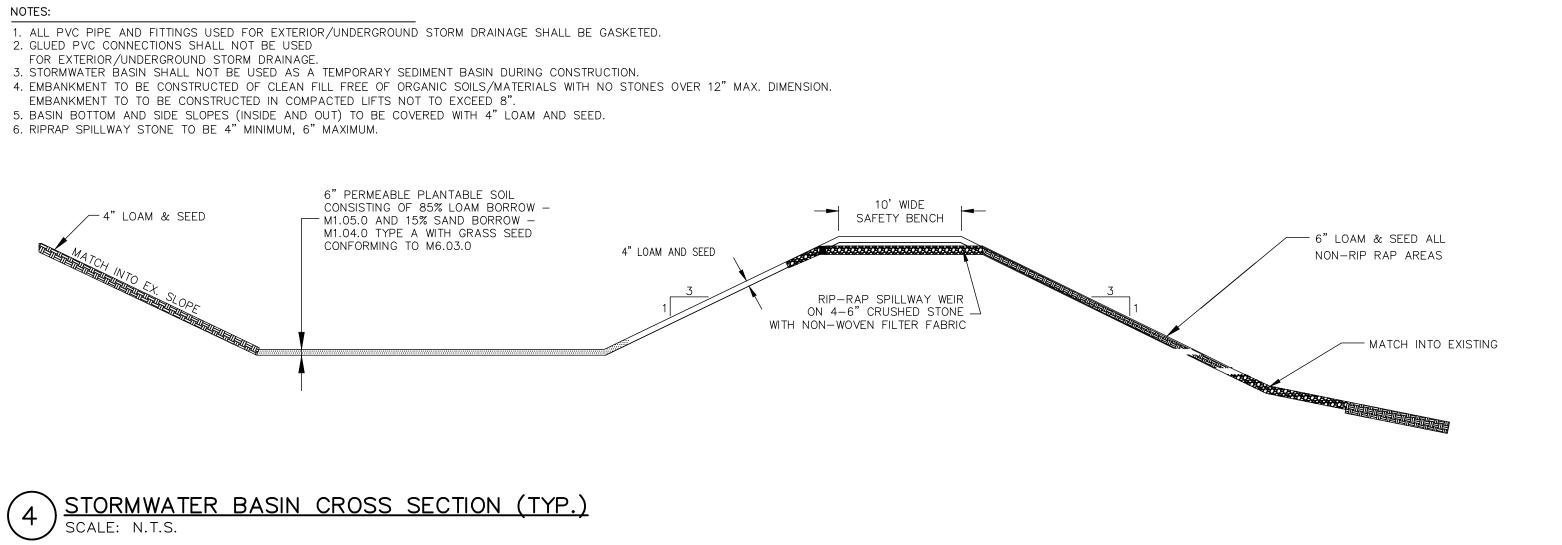

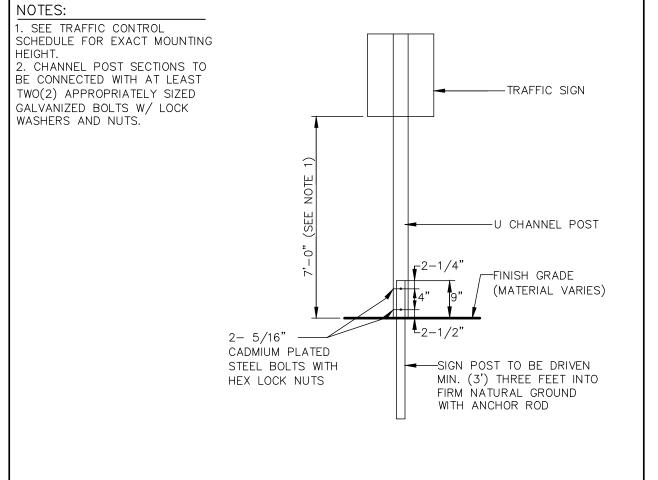

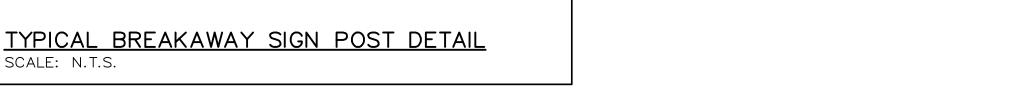

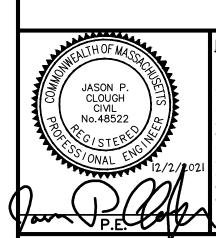

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SHEET TITLE				


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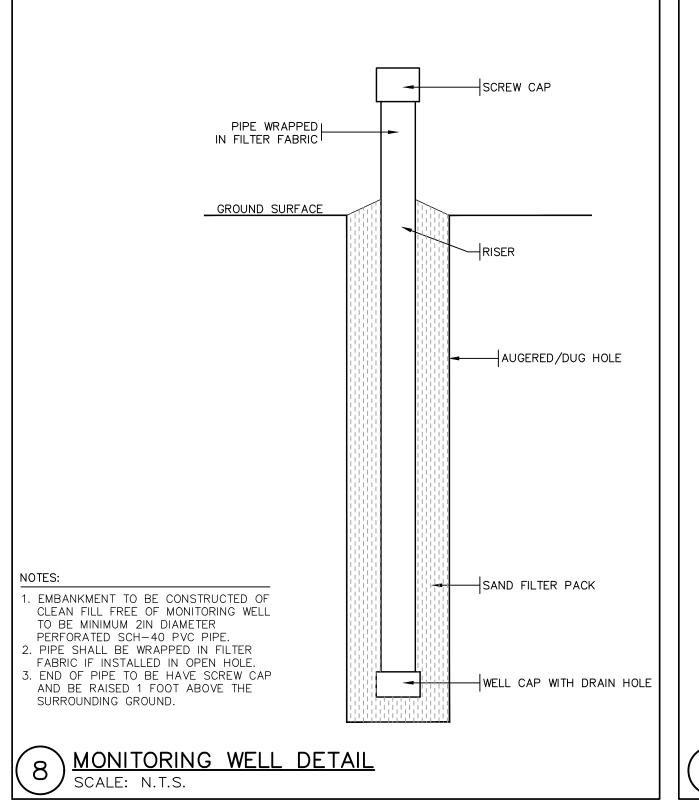
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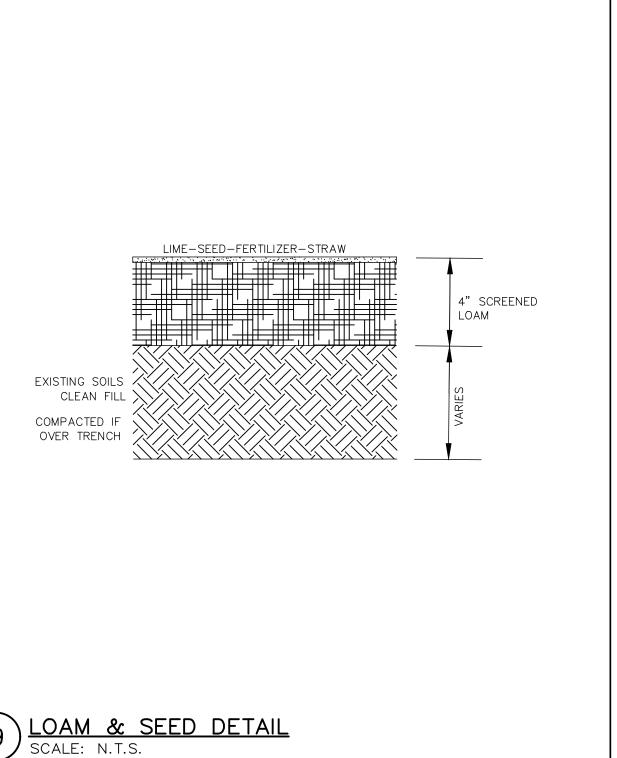
OWNER/APPLICANT:


TEMPLE ETZ CHAIM 900 WASHINGTON STREET FRANKLIN, MA 02038

DES BY: SPB DATE: NOVEMBER 12, 2021 CHK BY: JEG PROJECT NO. 3003-001





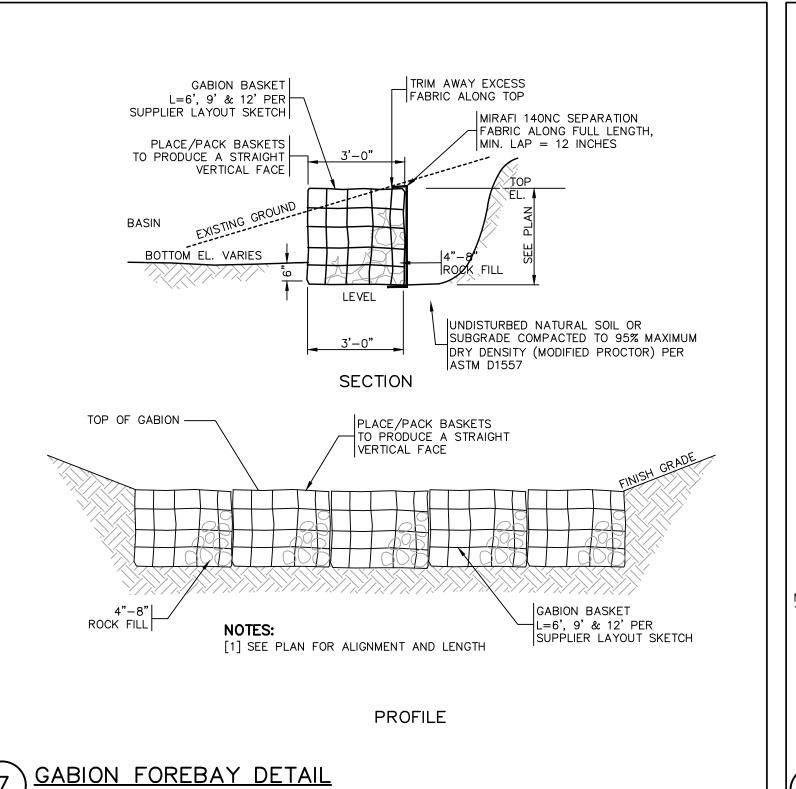

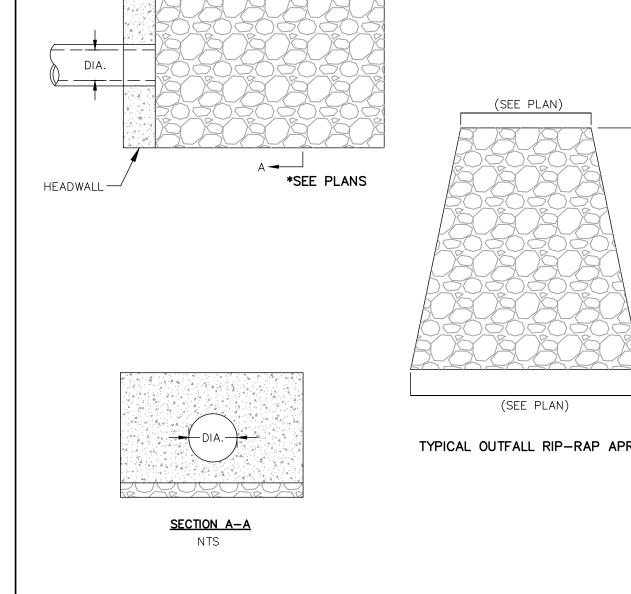


1. MINIMUM STONE DIAMETER: 6"


2. MINIMUM WEIGHT OF STONE: 50 LBS.
3. MAXIMUM WEIGHT OF STONE: 125 LBS.

AMOCO 4508 OR APPROVED EQUAL.

4. PLACE ALL RIP-RAP OVER FILTER FABRIC,

STONE RIP-RAP FOR PIPE ENDS
SCALE: N.T.S.

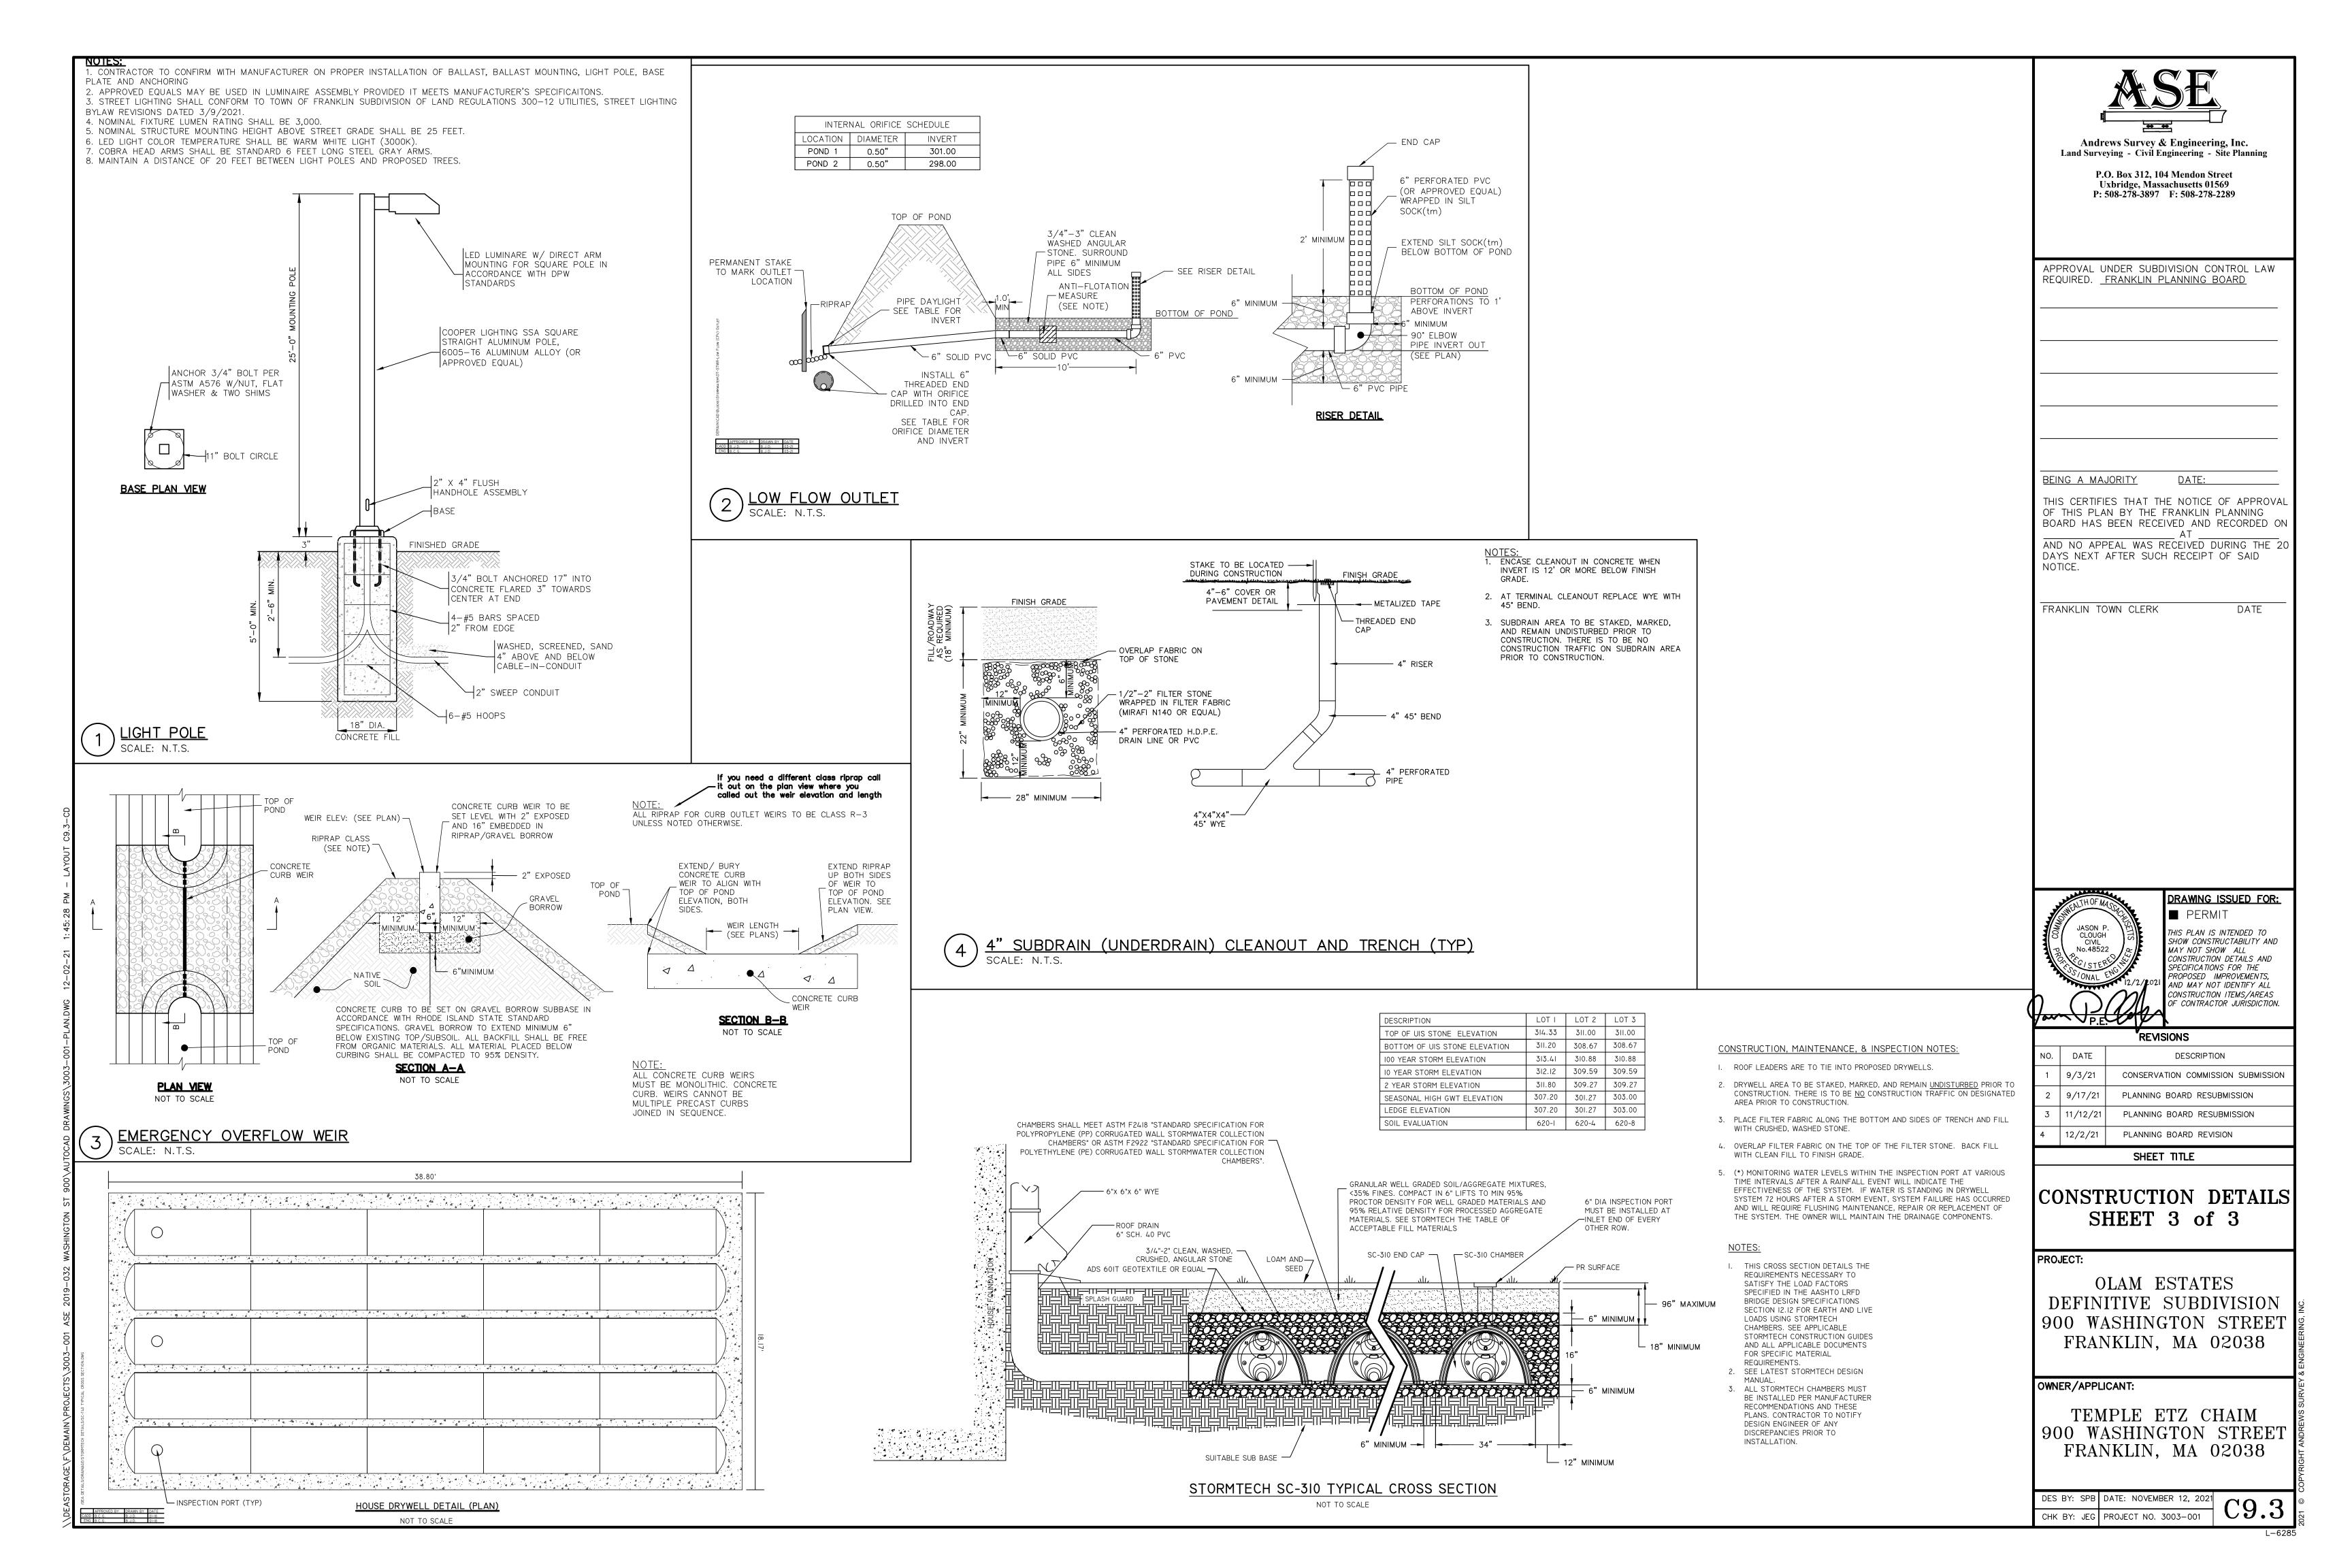

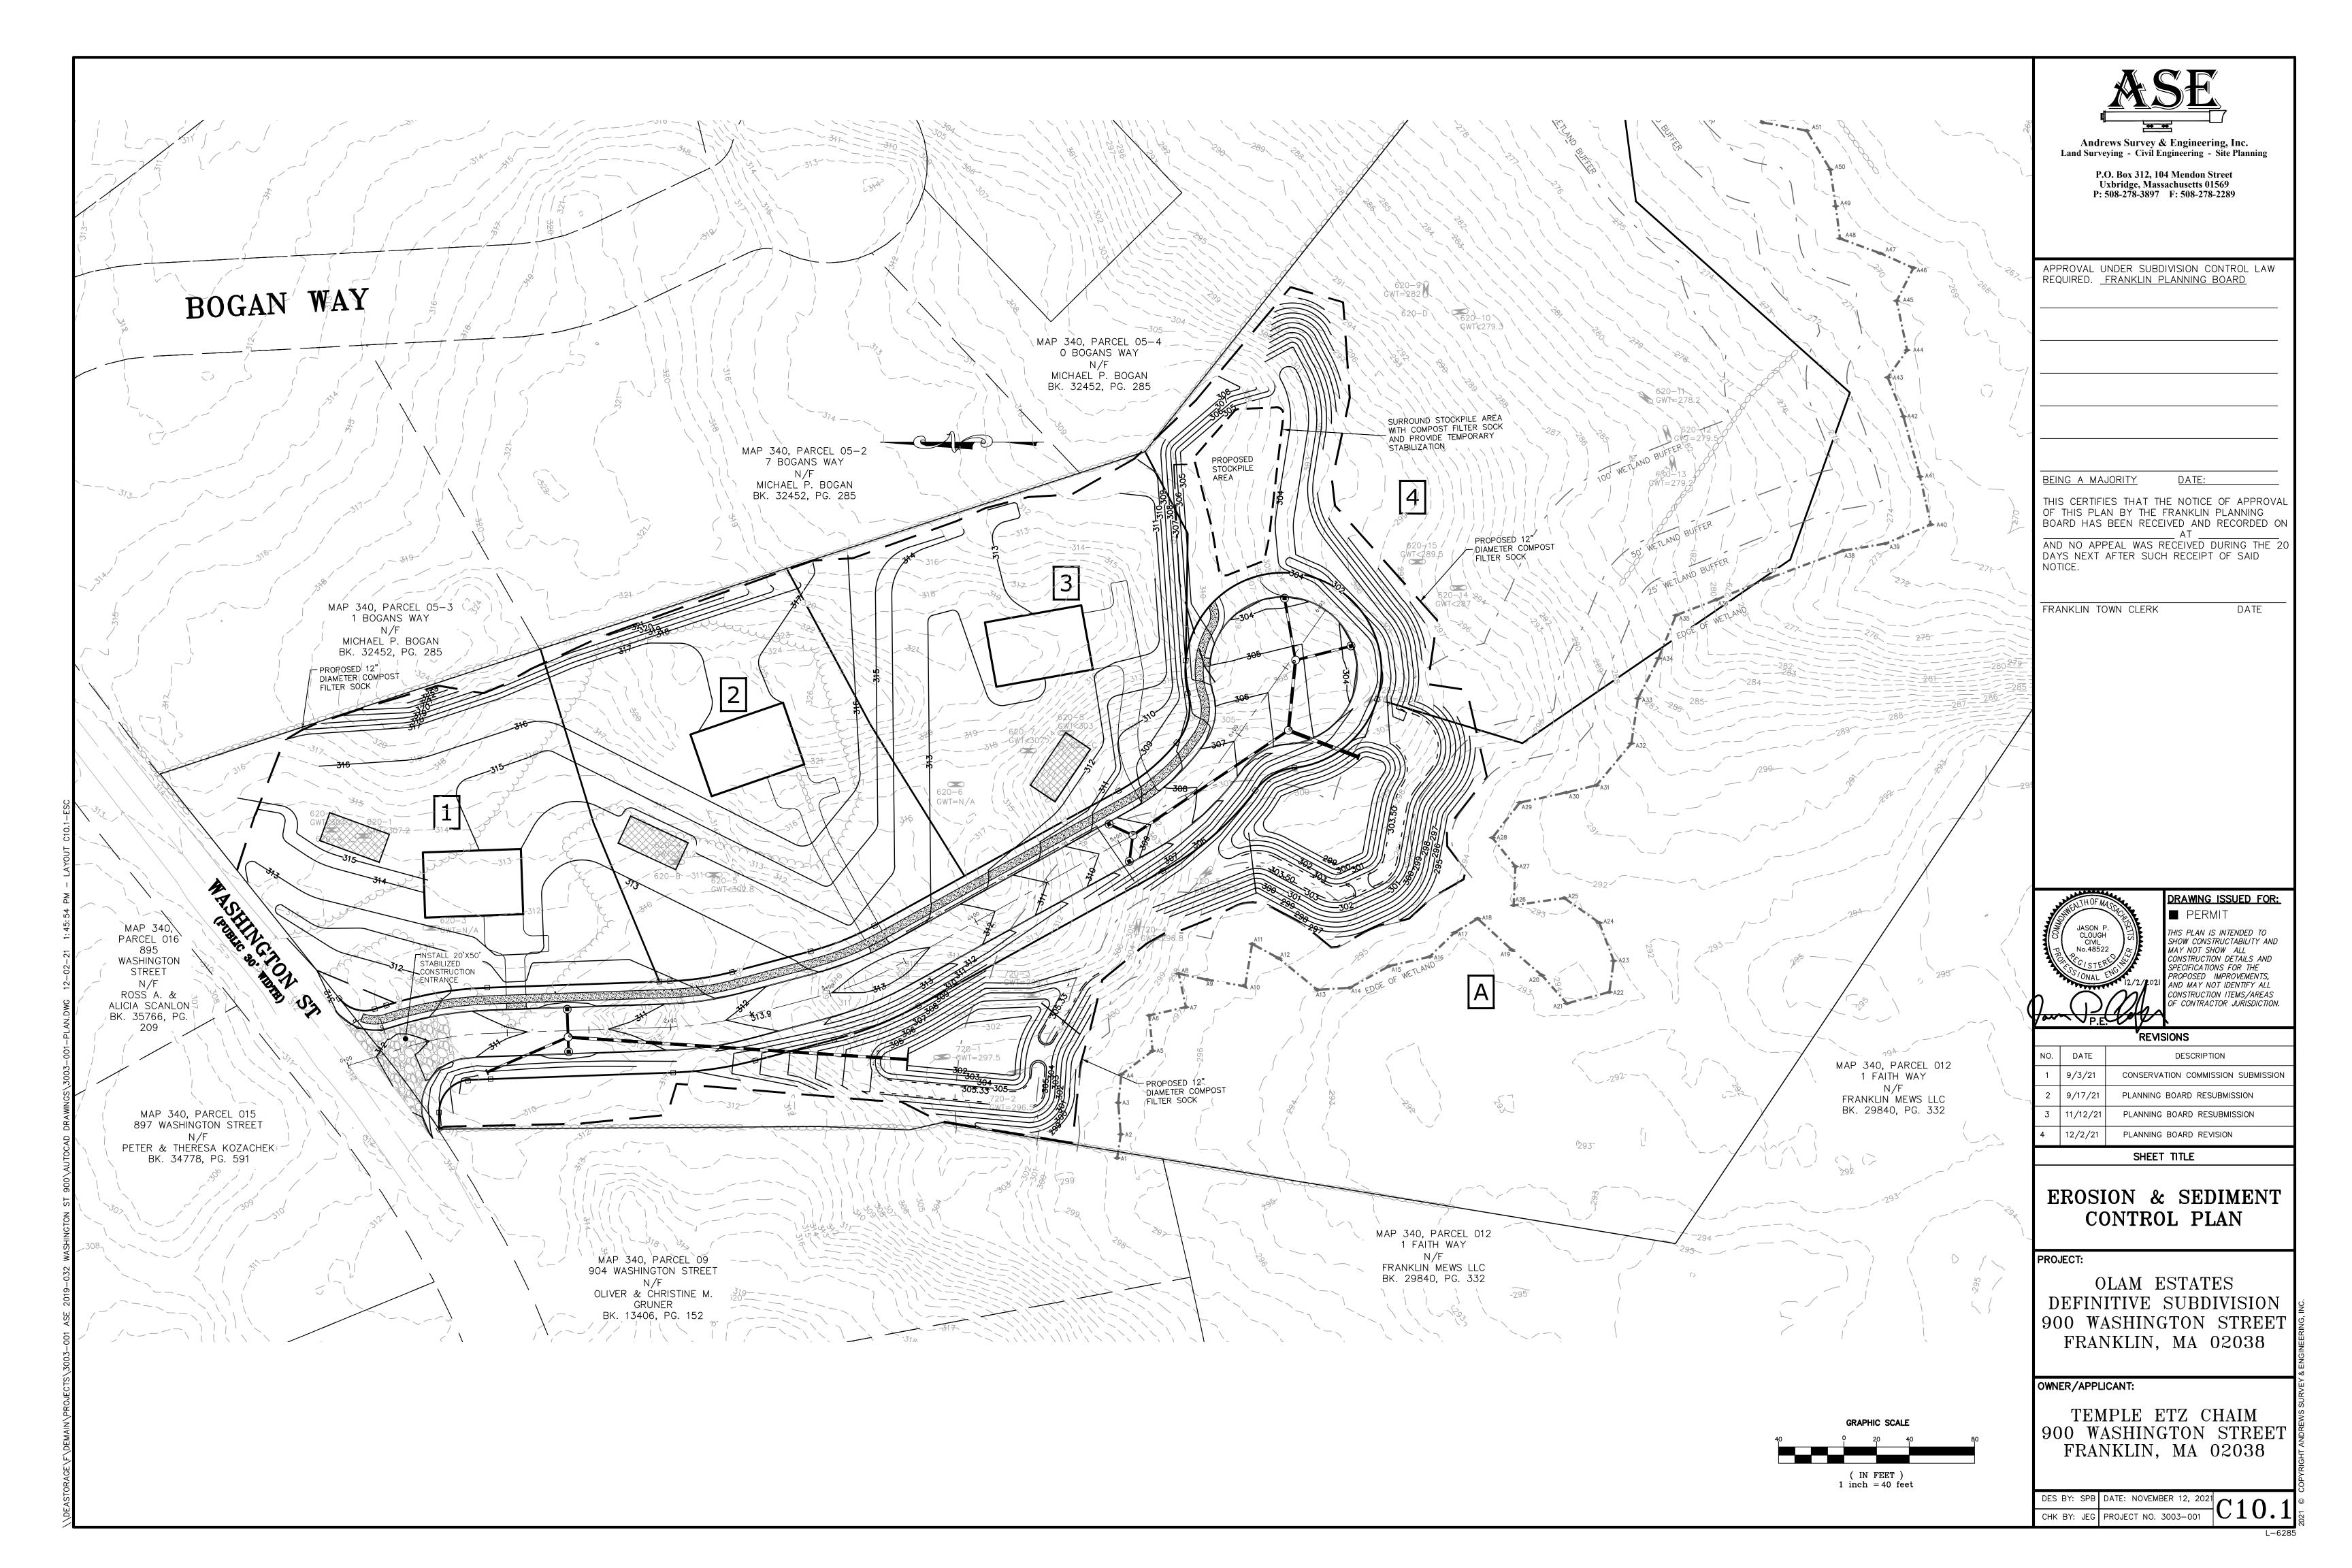

EROSION AND SEDIMENT CONTROL REQUIREMENTS

1.01 SUMMARY

A. FURNISH, INSTALL, AND MAINTAIN TEMPORARY AND PERMANENT EROSION AND SEDIMENT CONTROL MEASURES, SUCH AS, BUT NOT NECESSARILY LIMITED TO, STRAW BALE AND SILT FENCE BARRIERS, RIPRAP, VEHICLE TRACKING PADS, DIVERSION CHANNELS AND BERMS, CHECK DAMS, STRATEGICALLY LOCATED STOCKPILES, SEDIMENT BASINS, MULCH, AND SEED MIX (HEREINAFTER "CONTROL MEASURES") ADEQUATE TO PREVENT THE CONVEYANCE OF EROSION PRODUCTS (E.G. SOIL, MULCH, SOD) OFF SITE, OR INTO ENVIRONMENTALLY SENSITIVE AREAS, OR INTO AREAS WHERE WORK WILL BE ADVERSELY IMPACTED. ENVIRONMENTALLY SENSITIVE AREAS INCLUDE, BUT ARE NOT NECESSARILY LIMITED TO, WETLANDS, TRIBUTARIES TO WETLANDS, WETLAND BUFFER ZONES, INTERMITTENT AND PERENNIAL STREAMS / RIVERS, AND THEIR ATTENDANT

ALL METHODS AND MATERIALS USED FOR EROSION CONTROL SHALL CONFORM TO THE REQUIREMENTS SET FORTH IN "EROSION AND SEDIMENT CONTROL GUIDELINES FOR URBAN AND SUBURBAN AREAS A GUIDE FOR PLANNERS, DESIGNERS, AND MUNICIPAL OFFICIALS" AS PUBLISHED BY THE MASSACHUSETTS DEPARTMENT OF ENVIRONMENTAL PROTECTION, BUREAU OF RESOURCE PROTECTION, UNLESS OTHERWISE APPROVED IN

1. REFER TO DRAWINGS FOR LOCATION AND DETAILS OF LIMITS OF DISTURBANCE AND CONTROL MEASURES REQUIRED TO COMMENCE WORK. LIMITS OF DISTURBANCE SHALL BE MARKED WITH TAPE, SIGNS, OR ORANGE CONSTRUCTION FENCE PRIOR TO COMMENCING ANY LAND DISTURBANCE ACTIVITIES. CONTROL MEASURES WILL BE ADEQUATE ONLY FOR VEGETATION CLEARING. THE DRAWINGS ARE NOT INTENDED TO GRAPHICALLY DEPICT ALL CONTROL MEASURES THAT WILL BE REQUIRED TO MEET THE REQUIREMENTS DESCRIBED IN 1.01.A.

2. DEVISE AND EMPLOY CONTROL MEASURES THROUGHOUT THE DURATION OF PROJECT, OVER ALL AREAS DISTURBED OR UNDISTURBED BY CONSTRUCTION, AS NECESSARY TO MEET THE REQUIREMENTS DESCRIBED IN 1.01.A.

3. DEVISE AND EMPLOY TEMPORARY CONTROL MEASURES AS NECESSARY TO MEET THE REQUIREMENTS DESCRIBED IN 1.01.A, WHILE ALLOWING WORK TO PROCEED IN AN EFFICIENT, COST EFFECTIVE MANNER.

4. DEVISE, EMPLOY AND MAINTAIN CONTROL MEASURES UNTIL SUCH TIME AS THE ENTIRE SITE IS PERMANENTLY STABILIZED BY ESTABLISHED VEGETATION, FINISH LANDSCAPE MATERIALS, PAVED SURFACES, AND/OR ROOF AREA.

5. ONCE THE SITE IS PERMANENTLY STABILIZED AND CERTIFIED AS SUCH BY ENGINEER, REMOVE TEMPORARY CONTROL MEASURES WHILE PROTECTING STABILIZED SURFACES.

1.02 SUBMITTALS A. SUBMIT PRODUCT DATA, WARRANTY, AND TEST REPORTS AS INDICATED ON THE

DRAWINGS. B. SUBMIT SKETCH SHOWING LOCATIONS OF PROPOSED STOCKPILE AREAS, CONSTRUCTION ENTRANCES AND EROSION CONTROLS IF NOT SHOWN ON THE SITE PLAN

OR DIFFERENT FROM THOSE LOCATIONS SHOWN ON THE SITE PLAN.

C. A SITE SPECIFIC SEQUENCE OF CONSTRUCTION FOR EACH PORTION OF THE SITE. NO PORTION OF THE SITE SHALL EXCEED FIVE (5) ACRES.

1.03 QUALITY ASSURANCE

A. COMPLY WITH GOVERNING CODES AND REGULATIONS. PROVIDE PRODUCTS FROM ACCEPTABLE MANUFACTURERS. USE EXPERIENCED INSTALLERS. DELIVER, HANDLE, AND STORE MATERIALS IN ACCORDANCE WITH MANUFACTURER'S INSTRUCTIONS.

B. CONFORM TO CONDITIONS OF APPROVAL ISSUED BY REGULATORY AGENCIES INCLUDING, BUT NOT NECESSARILY LIMITED TO, LOCAL PLANNING BOARD, CONSERVATION COMMISSION, CITY COUNCIL, BOARD OF HEALTH, PUBLIC WORKS / HIGHWAY DEPARTMENT, STATE ENVIRONMENTAL PROTECTION DEPARTMENT, AND U.S. GOVERNMENT, ENVIRONMENTAL PROTECTION AGENCY. WHERE CONDITIONS OF REGULATORY APPROVAL DIFFER FROM REQUIREMENTS CONTAINED HEREIN OR ON THE DRAWINGS, COMPLY WITH THE MORE STRINGENT REQUIREMENT.

PART 2 - PRODUCTS

2.01 MATERIALS

A. STRAW BALES: WEED FREE DRY GRASS OR STRAW, MACHINE BOUND WITH JUTE OR WIRE, APPROXIMATE SIZE EACH BALE 42" X 16" X 16". EACH BALE SHALL BE STAKED WITH A MINIMUM OF TWO 24" LONG HARDWOOD STAKES. NOTE: HAY SHALL NOT BE

B. STRAW WATTLES: NORTH AMERICAN GREEN MODEL WS1210 OR APPROVED EQUAL

C. SILT FENCE: NON-WOVEN, UV-RESISTANT, POLYPROPYLENE FABRIC, FLOW RATED AT 10 GPM/SF MINIMUM, GRAB TENSILE RATED AT 124 POUNDS MINIMUM, WITH INTEGRAL STAKE LOOPS, AND HARDWOOD STAKES. USE NO. 2130 BY AMOCO FABRICS & FIBERS,

D. MULCH: ORGANICS INCLUDING STRAW, PROCESSED PINE / HEMLOCK TWIGS AND

E. SEED MIXES: SHALL MEET THE REQUIREMENTS OF MASSACHUSETTS HIGHWAY DEPARTMENT STANDARD SPECIFICATIONS FOR HIGHWAYS AND BRIDGES, LATEST EDITION SECTION 6.03.0 OR 6.03.1 AS APPROPRIATE.

F. EXCELSIOR BLANKET: CURLED WOOD FIBER ON PHOTODEGRADABLE EXTRUDED PLASTIC MATRIX, 80% OF FIBERS 6-INCHES LONG OR LONGER, WEIGHT 0.975 POUNDS / SY, CONTAINING NO CHEMICAL ADDITIVES. USE CURLEX I BLANKET BY AMERICAN EXCELSIOR COMPANY, OR APPROVED EQUAL.

G. ROCK RIPRAP: SOUND, ANGULAR, 6-INCH MINUS PROCESSED ROCK, BLAST ROCK.

H. CRUSHED STONE: SOUND, ANGULAR, 2-INCH MINUS PROCESSED CRUSHED STONE.

PART 3 - EXECUTION

3.01 THROUGHOUT CONSTRUCTION

A. DEVISE WORK SEQUENCE SO AS TO LIMIT DRAINAGE AREA THAT IS TRIBUTARY TO DISTURBED AREAS. DEVISE, EMPLOY, AND MAINTAIN CONTROL MEASURES SUCH AS DIVERSION CHANNELS AND BERMS, STRATEGICALLY LOCATED STOCKPILES. AND SEDIMENT BASINS TO SUBDIVIDE DRAINAGE AREAS INTO SMALL, MANAGEABLE SUBAREAS, THEREBY MINIMIZING RUNOFF AND THE POTENTIAL FOR EROSION.

B. MAINTAIN BARRIER AT LIMIT OF WORK AND PROTECT EXISTING VEGETATION / FACILITIES OUTSIDE OF LIMIT OF WORK.

C. MAINTAIN SPARE MATERIAL STOCKPILES FOR IMMEDIATE EMPLOYMENT / REPAIR / EXPANSION OF CONTROL MEASURES. AT A MINIMUM, SUCH MATERIALS SHALL INCLUDE HAY BALES, SILT FENCE AND STAKES, AND CRUSHED STONE.

D. INSPECT AND MAINTAIN EFFECTIVENESS OF CONTROL MEASURES BY REPAIRING AS NECESSARY TO ENSURE INTENDED FUNCTION; BY SUPPLEMENTING AS NECESSARY FOR ADEQUATE EXTENT; BY REMOVING TRAPPED PRODUCTS OF EROSION AS NECESSARY TO MAINTAIN EFFECTIVE TRAP VOLUME.

E. LIMIT EXTENT OF WORK AREA SO THAT ALL DISTURBED AREAS CAN BE STABILIZED WITH CONTROL MEASURES WITHIN A 24-HOUR PERIOD.

F. INSTALL CONTROL MEASURES AS SOON AS PRACTICABLE AFTER EACH MANAGEABLE PORTION OF EARTHWORK IS COMPLETE. EMPLOY TEMPORARY MEASURES AS NECESSARY TO STABILIZE DISTURBED AREAS, EVEN WHERE SUBSEQUENT CONSTRUCTION OPERATIONS MAY REQUIRE RE-DISTURBANCE.

PART 3 — CONTINUED

G. WHEN INTENSE RAINFALL IS EXPECTED, CONSIDER, DEVISE, AND EMPLOY REINFORCING CONTROL MEASURES PRIOR TO THE RAINFALL EVENT TO MEET THE REQUIREMENTS DESCRIBED IN 1.01.A. IF NECESSARY, EMPLOY TEMPORARY CONTROL MEASURES ON MATERIAL STOCKPILES TO COUNTERACT POTENTIAL SEDIMENT TRANSPORT DURING INTENSE RAINFALL.

H. WHEN VEHICLE REFUELING IS REQUIRED ON SITE, CONDUCT REFUELING OPERATIONS OUTSIDE OF ENVIRONMENTALLY SENSITIVE AREAS.

I. PROPERLY DISPOSE OF DEBRIS, SOLID WASTE, TRASH, AND CONSTRUCTION WASTE / BYPRODUCTS OFF SITE.

J. SWEEP ON-SITE PAVED AREAS AND OFF-SITE STREETS AS NECESSARY TO PREVENT SILT AND DEBRIS ORIGINATING ON SITE FROM ENTERING CLOSED DRAINAGE SYSTEMS AND / OR ENVIRONMENTALLY SENSITIVE AREAS. WHEN NECESSARY UTILIZE WATER SPRAYING, SURFACE ROUGHENING AND/OR APPLY POLYMERS, SPRAY-ON TACKIFIERS, CHLORIDES AND BARRIERS FOR DUST CONTROL.

K. INSPECT EROSION CONTROLS DAILY THROUGHOUT CONSTRUCTION REPAIR DAMAGED

3.02 SITE PREPARATION AND ACCESS

A. WALK SITE AND IDENTIFY LOCATIONS OF LIMIT OF WORK AND ENVIRONMENTALLY SENSITIVE AREAS. ESTABLISH CONSTRUCTION STAGING AREA, LOCATED BEYOND ENVIRONMENTALLY SENSITIVE AREAS.

B. INSTALL CONTROL MEASURES AS SHOWN ON THE DRAWINGS, INCLUDING THOSE DEFINING THE LIMIT OF WORK.

C. LIMIT VEHICULAR TRAFFIC TO AND FROM SITE TO MINIMIZE TRANSPORT OF SEDIMENT. 3.03 CLEARING, GRUBBING, AND STRIPPING

A. SCHEDULE GRUBBING AND STRIPPING TO OCCUR IMMEDIATELY PRIOR TO EARTH DISTURBANCE. DEPENDING ON SITE AREA, CONSIDER MULTIPLE GRUBBING PHASES, SEQUENCED TO TAKE ADVANTAGE OF THE EROSION PREVENTION POTENTIAL OF EXISTING VEGETATIVE COVER.

B. MINIMIZE THE AREA OF EXISTING VEGETATION REMOVED WHEREVER POSSIBLE. NO GREATER THAN FIVE (5) ACRES SHALL BE UNSTABLE AT ANY TIME.

C. LOCATE AND SIZE STOCKPILES TO MINIMIZE EROSION POTENTIAL, TAKING ADVANTAGE OF TERRAIN SLOPE AND ASPECT, WHERE APPROPRIATE.

D. PROTECT VEGETATION, INCLUDING ROOT SYSTEMS, BEYOND LIMIT OF CLEARING.

E. PROCESS TIMBER, STUMPS, SLASH, AND BRUSH SO AS TO PROTECT ENVIRONMENTALLY SENSITIVE AREAS AND INSTALLED CONTROL MEASURES. PROPERLY DISPOSE OF EXCESS OFF SITE. BURIAL OF STUMPS ON SITE IS PROHIBITED.

3.04 EXCAVATION FOR BUILDING FOUNDATIONS AND UTILITIES

DISCHARGE AND AREAS DOWNSTREAM.

3.05 SITE GRADING

A. DEVISE AND INSTALL CONTROL MEASURES ADEQUATE TO HANDLE DISCHARGES AND TRAP SEDIMENT FROM FOOTING SUMP AND WELL POINT PUMPS PRIOR TO EXCAVATION. B. ARMOR SUMP PUMP DISCHARGE LOCATIONS TO PREVENT EROSION AT POINT OF

C. IF FOUNDATION EXCAVATIONS GRADE TO DAYLIGHT ON THE LOW SIDE, DEVISE AND INSTALL CONTROL MEASURES TO HANDLE SURFACE AND GROUNDWATER FLOW FROM EXCAVATION LOW POINT.

D. STOCKPILE EXCAVATED MATERIALS TO BAFFLE OVERLAND RUNOFF, AVOIDING THE CREATION OF LENGTHY PATHS OF CONCENTRATED RUNOFF. STOCKPILE SLOPES SHALL

E. BACKFILL UTILITY TRENCHES AS SOON AS PRACTICABLE TO PREVENT FLOODING, SLOUGHING, POTENTIAL OVERFLOW, AND REPETITIVE EARTH DISTURBANCE.

A. WHERE APPLICABLE, FOLLOW EXCAVATION AND FILL PRACTICES SHOWN ON DRAWINGS TO LOCALIZE AND MINIMIZE EROSION.

B. MONITOR SEDIMENT VOLUME IN TEMPORARY SEDIMENT BASINS AND AT DIVERSION BERMS AND CHECK DAMS. IN ALL AREAS EXCEPT THOSE THAT DO NOT PRESENT POTENTIAL PROBLEMS WITH REGARD TO FUTURE SOIL STABILITY, DRAINAGE, OR BEARING CAPACITY, REMOVE AND PROPERLY DISPOSE OF TRAPPED SEDIMENT BEFORE BRINGING SITE TO FINAL SUBGRADE.

C. EXPOSED SOILS SHALL BE PERMANENTLY STABILIZED WITHIN FIVE (5) BUSINESS DAYS OF COMPLETION OF CONSTRUCTION OF A GIVEN AREA. EXPOSED AREAS WHERE NO WORK HAS OCCURRED FOR FOURTEEN (14) DAYS SHALL BE TEMPORARILY STABILIZED WITH HYDROSEED OR OTHER APPROVED METHOD.

D. SLOPES STEEPER THAN 3:1 SHALL BE STABILIZED IMMEDIATELY AFTER COMPLETION. 3.06 LANDSCAPING

A. COMPLETE LANDSCAPING AS SOON AS POSSIBLE AFTER COMPLETION OF FINAL


SUBGRADE. B. IMMEDIATELY AFTER PLACEMENT OF TOPSOIL, STABILIZE WITH CONTROL MEASURES

C. PERMANENT SEEDING MAY BE PERFORMED IN THE SPRING PRIOR TO JULY 1 AND IN BETWEEN AUGUST 1 AND OCTOBER 15. PERMANENT SEEDING AT OTHER TIMES SHALL BE APPROVED AND SHALL ONLY BE ALLOWED WITH AN APPROVED MULCHING AND

INCLUDING, BUT NOT NECESSARILY LIMITED TO, SEED MIX, MULCH, AND / OR BLANKET.

GENERAL SEQUENCE OF CONSTRUCTION

- PLACE LIMIT OF WORK BARRIERS, FENCES, CONSTRUCTION ENTRANCES AND REQUIRED FENCING & SIGNS. CONSTRUCT SEDIMENT TRAPS & BARRIERS AND PLACE OTHER CONTROLS,
- DIVERSION TRENCHES, PERIMETER DIKES, WATER BARS & OUTLET PROTECTION. ESTABLISH STOCKPILE AND STAGING AREAS.
- 4. CUT TREES AND SHRUBS AND REMOVE FROM SITE OR STOCKPILE AND PROTECT STOCKPILE(S) BY APPROVED METHODS. EXCAVATE STUMPS AND REMOVE FROM SITE OR STOCKPILE AND PROTECT
- STOCKPILE(S) BY APPROVED METHODS. 6. INSTALL DRAINAGE SYSTEM BEGINNING WITH INFILTRATION AREA. INSTALL, STABILIZE AND PROTECT INFILTRATION AREAS AND OTHER AREAS DISTURBED FOR COMPONENTS OF DRAINAGE SYSTEM. CLEAR, ROUGH GRADE & STABILIZE SLOPES
- OF ROADWAY FROM STATION 0+00 TO END BETWEEN JULY 1ST AND SEPTEMBER BEGIN EARTHWORKS, ESTABLISH, STABILIZE AND PROTECT CUT AND FILL SLOPES. BEGIN INSTALLATION OF OTHER UTILITIES. ESTABLISH COVER, STABILIZE AND
- PROTECT AREAS DISTURBED FOR UTILITY INSTALLATION. BEGIN EXCAVATION FOR STRUCTURES. STOCKPILE AND PROTECT EXCAVATED MATERIALS
- 10. BACKFILL FOUNDATIONS STABILIZE ALL DISTURBED AREAS AND REMOVE EXCESS SOIL FROM SITE. PERFORM SITE WORK IN ACCORDANCE WITH "EROSION AND SEDIMENT CONTROL
- REQUIREMENTS, PART 3 EXECUTION". 12. VERIFY ALL AREAS HAVE BEEN STABILIZED, RE-SEED EXPOSED SOILS. 13. CLEAN INFILTRATION AREA, CLEAN CATCH BASINS AND STORM DRAINS. REMOVE
- SOILS FROM SITE. 14. REMOVE ALL EROSION CONTROLS, LIMIT OF WORK BARRIERS, FENCES. CONSTRUCTION ENTRANCES, SIGNS AND SWEEP PAVED AREAS.

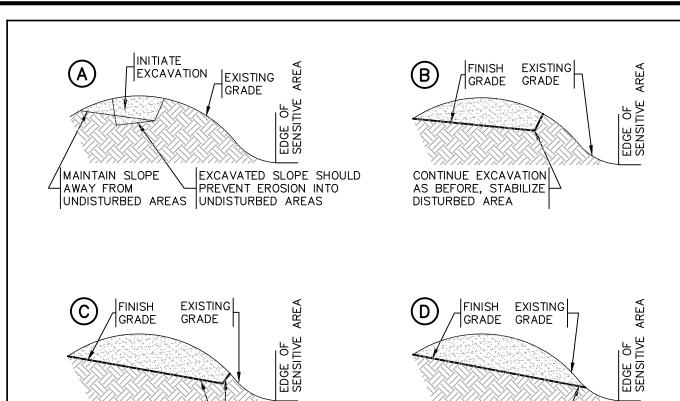

REMOVE BERM AND

STABILIZE AREA


EXCAVATION PROCEDURE

LEAVE 2'

CONTINUE EXCAVATION

IN DISTURBED AREA


ESTABLISH GRASS COVER

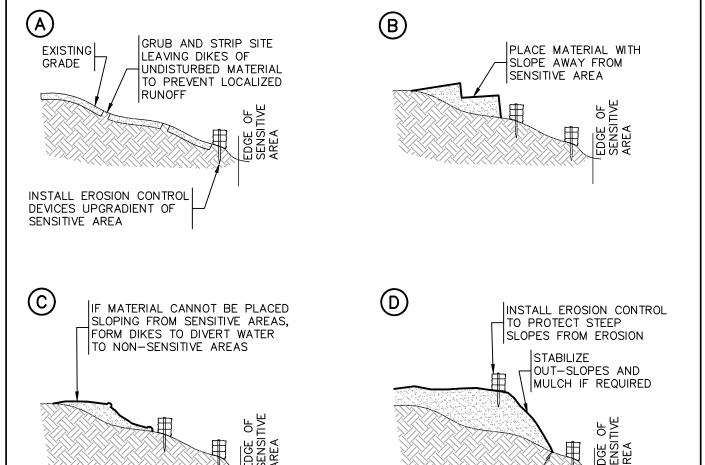


STABILIZE LOWER PORTION OF SLOPE IMMEDIATELY UPON

PLACEMENT

3) FILL PROCEDURE

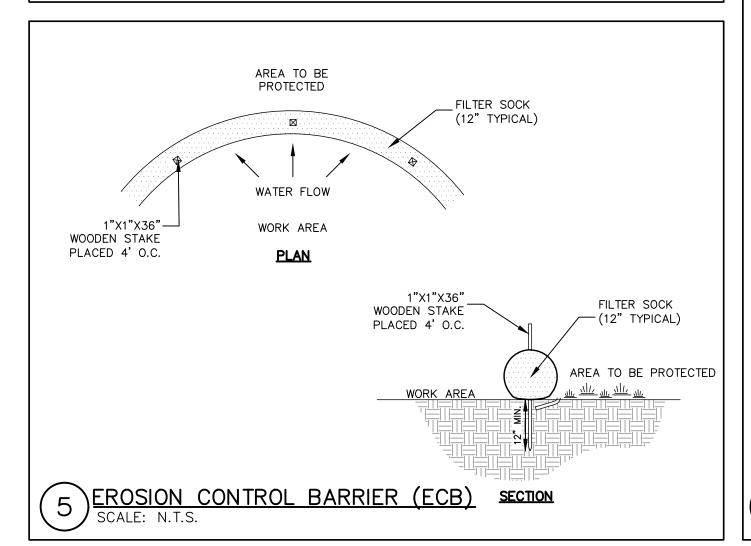

LONG AXIS OF STOCKPILE TO BE PERPENDICULAR TO CONTOUR STOCKPILE TO BE LOCATED IN AN AREA WHICH PROVIDES MAXIMUM PROTECTION AGAINST EROSION TOWARDS SENSITIVE AREAS CONTINUOUS STAKED STRAW BALE DIKE PLACED DOWNGRADIENT OF STOCKPILE TEMPORARY STOCKPILE

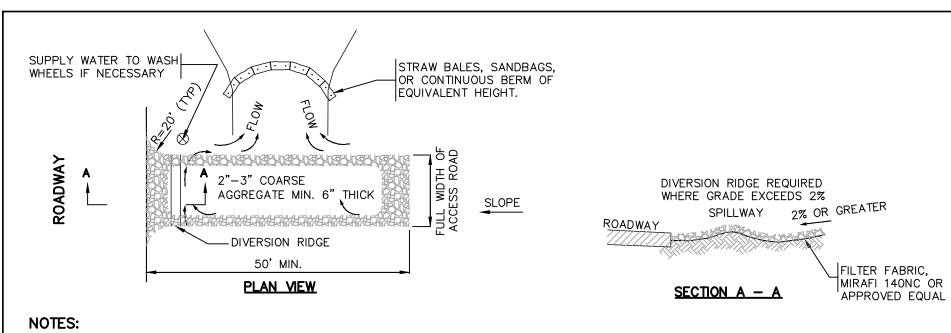


DURING ALL PHASES OF


[1] THE ENTRANCE SHALL BE MAINTAINED IN A CONDITION THAT WILL PREVENT TRACKING OR FLOWING OF SEDIMENT ONTO PUBLIC RIGHT-OF-WAYS. THIS MAY REQUIRE TOP DRESSING,

- REPAIR AND/OR CLEANOUT OF ANY MEASURES USED TO TRAP SEDIMENT. [2] WHEN NECESSARY, WHEELS SHALL BE CLEANED PRIOR TO ENTRANCE ONTO PUBLIC
- RIGHT-OF-WAY. [3] WHEN WASHING IS REQUIRED, IT SHALL BE DONE ON AREA STABILIZED WITH CRUSHED
- STONE THAT DRAINS INTO AN APPROVED SEDIMENT TRAP OR SEDIMENT BASIN. [4] USE SANDBAGS, STRAW BALES OR OTHER APPROVED METHODS TO CHANNELIZE RUNOFF TO BASIN AS REQUIRED.


CONSTRUCTION ENTRANCE

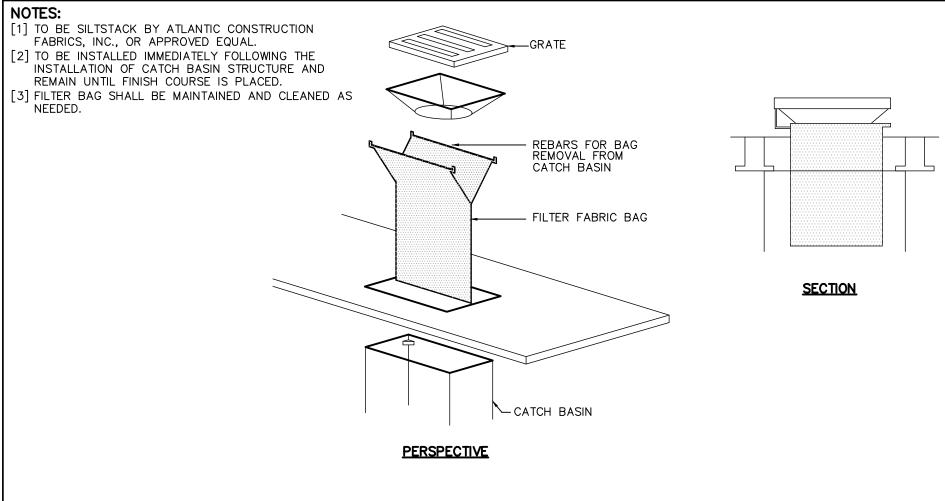

<u>\TYPICAL CATCH BASIN FILTER BAG DETAIL</u>

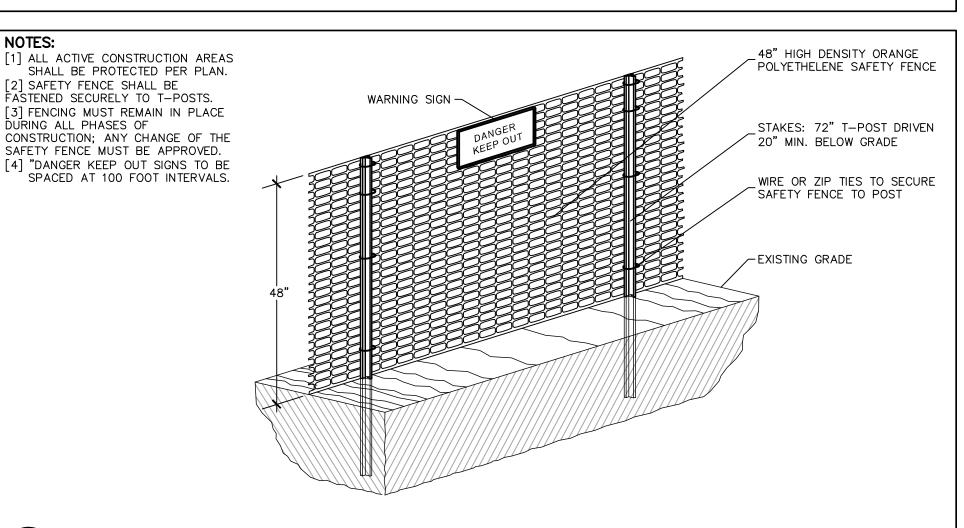

CONSTRUCTION SAFETY FENCE

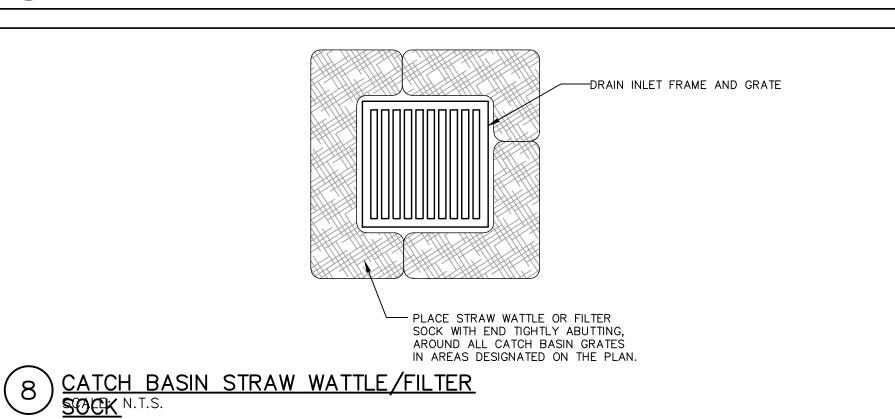

Andrews Survey & Engineering, Inc. Land Surveying - Civil Engineering - Site Planning

P.O. Box 312, 104 Mendon Street

Uxbridge, Massachusetts 01569

P: 508-278-3897 F: 508-278-2289


APPROVAL UNDER SUBDIVISION CONTROL LAW REQUIRED. FRANKLIN PLANNING BOARD

<u>BEING A MAJORITY</u>

THIS CERTIFIES THAT THE NOTICE OF APPROVAL OF THIS PLAN BY THE FRANKLIN PLANNING BOARD HAS BEEN RECEIVED AND RECORDED ON

AND NO APPEAL WAS RECEIVED DURING THE 20 DAYS NEXT AFTER SUCH RECEIPT OF SAID

FRANKLIN TOWN CLERK

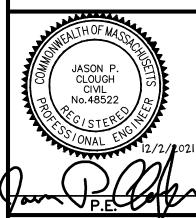

REVISIONS DESCRIPTION DATE 9/3/21 CONSERVATION COMMISSION SUBMISSION 2 9/17/21 PLANNING BOARD RESUBMISSION 11/12/21 PLANNING BOARD RESUBMISSION 12/2/21 PLANNING BOARD REVISION

DRAWING ISSUED FOR:

THIS PLAN IS INTENDED TO

MAY NOT SHOW ALL

SHOW CONSTRUCTABILITY AND

CONSTRUCTION DETAILS AND

SPECIFICATIONS FOR THE

PROPOSED IMPROVEMENTS.

AND MAY NOT IDENTIFY ALL

CONSTRUCTION ITEMS/AREAS

OF CONTRACTOR JURISDICTION.

■ PERMIT

EROSION & SEDIMENT CONTROL NOTES AND **DETAILS**

SHEET TITLE

PROJECT:

OLAM ESTATES DEFINITIVE SUBDIVISION 900 WASHINGTON STREET FRANKLIN, MA 02038

OWNER/APPLICANT:

TEMPLE ETZ CHAIM 900 WASHINGTON STREET FRANKLIN, MA 02038

DES BY: SPB DATE: NOVEMBER 12. 2021 CHK BY: JEG PROJECT NO. 3003-001